0(8) ===== ~^v^v^v^v^v^v

GENERAL MEP NOTE:

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TO ANY DISCREPANCY. SHOULD THE PRIME CONTRACTOR NOT SO NOTIFY

THE ENGINEER, THE CONTRACTORS SHALL FULLY COMPLY WITHOUT CLAIM FOR EXTRA COSTS. REFER TO DRAWINGS FOR GOVERNING BUILDING CODES.

STATE, COUNTY, CITY BUILDING REGULATIONS AND CODES AS WELL AS

INDUSTRY STANDARD PRACTICE. THESE REQUIREMENTS ARE CONSIDERED PART OF THE PLANS AND SPECIFICATIONS AND SHALL PREVAIL SHOULD

THEY DIFFER FROM THE PLANS AND SPECIFICATIONS, PRIOR TO BID

LOWER LEVEL DEMOLITION PLUMBING SANITARY PLAN

(NEC 2008 EDITION - WITH INDIANA AMENDMENTS)

(IBC 2012 EDITION - WITH INDIANA AMENDMENTS)

(IFC 2012 EDITION - WITH INDIANA AMENDMENTS)

(IPC 2006 EDITION - WITH INDIANA AMENDMENTS)

(IMC 2012 EDITION - WITH INDIANA AMENDMENTS)

GOVERNING CODES

2014 INDIANA BUILDING CODE

2012 INDIANA PLUMBING CODE

2014 INDIANA MECHANICAL CODE

2014 INDIANA FIRE CODE

2010 INDIANA ENERGY CONSERVATION CODE (ANSI/ASHRAE 90.1 - 2007 EDITION - WITH INDIANA AMENDMENTS)

2009 INDIANA ELECTRICAL CODE

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REVIEW ALL DRAWINGS FOR WORK PERFORMED BY THAT CONTRACTOR.

MICHAEL R. WALDBIESER ENGINEERING & CONSULTING, INC.

2. ALL WALLS INDICATED ON THE ARCHITECTURAL PLANS AS FIRE RATED SHALL BE PROPERLY FIRE CAULKED FOR ALL PENETRATIONS.

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PROJECT: 18-20 FILE: Plum #F

WITHOUT THE WRITTEN CONSENT OF MICHAEL R. WALDBIESER

_____ COLD WATER LINE ---- HOT WATER LINE --- SANITARY VENT LINE ——— SANITARY DRAIN LINE — GAS — GAS LINE GENERAL NOTES: 1. ALL CONTRACTORS AND SUB-CONTRACTORS SHALL

REFER TO CONSTRUCTION PHASING DRAWINGS #PH1, #PH2, AND #PH3 FOR THE CONSTRUCTION SEQUENCE OF THE PROJECT.

CONSTRUCTION PHASING NOTE

(10) EXISTING LAUNDRY TUB REMAINS NO WORK.

9 EXISTING CLOTHS WASHING MACHINE REMAINS NO WORK.

7) EXISTING RESTROOM URINALS REMAIN NO WORK

1) EXISTING KITCHEN SINK REMAINS NO WORK

NUMBERED NOTES:

4) EXISTING WATER HEATER REMAINS NO WORK

3) EXISTING WATER SOFTENER REMAINS NO WORK

(5) EXISTING RESTROOM SINK AND WATER HEATER REMAINS


2) EXISTING KITCHEN HAND WASH SINK REMAINS NO WORK

6) EXISTING RESTROOM WATER CLOSETS REMAIN NO WORK

8) APPROXIMATE LOCATION OF 4" DIAMETER VERTICAL WASTE STACK IN RESTROOM CHASE. CONFIRM LOCATION AND SIZE PRIOR TO ROUGH-IN.

WABASH VALLEY HEALTH CENTE 1436 LOCUST STREET TERRE HAUTE, INDIANA 47807

DATE REVISIONS

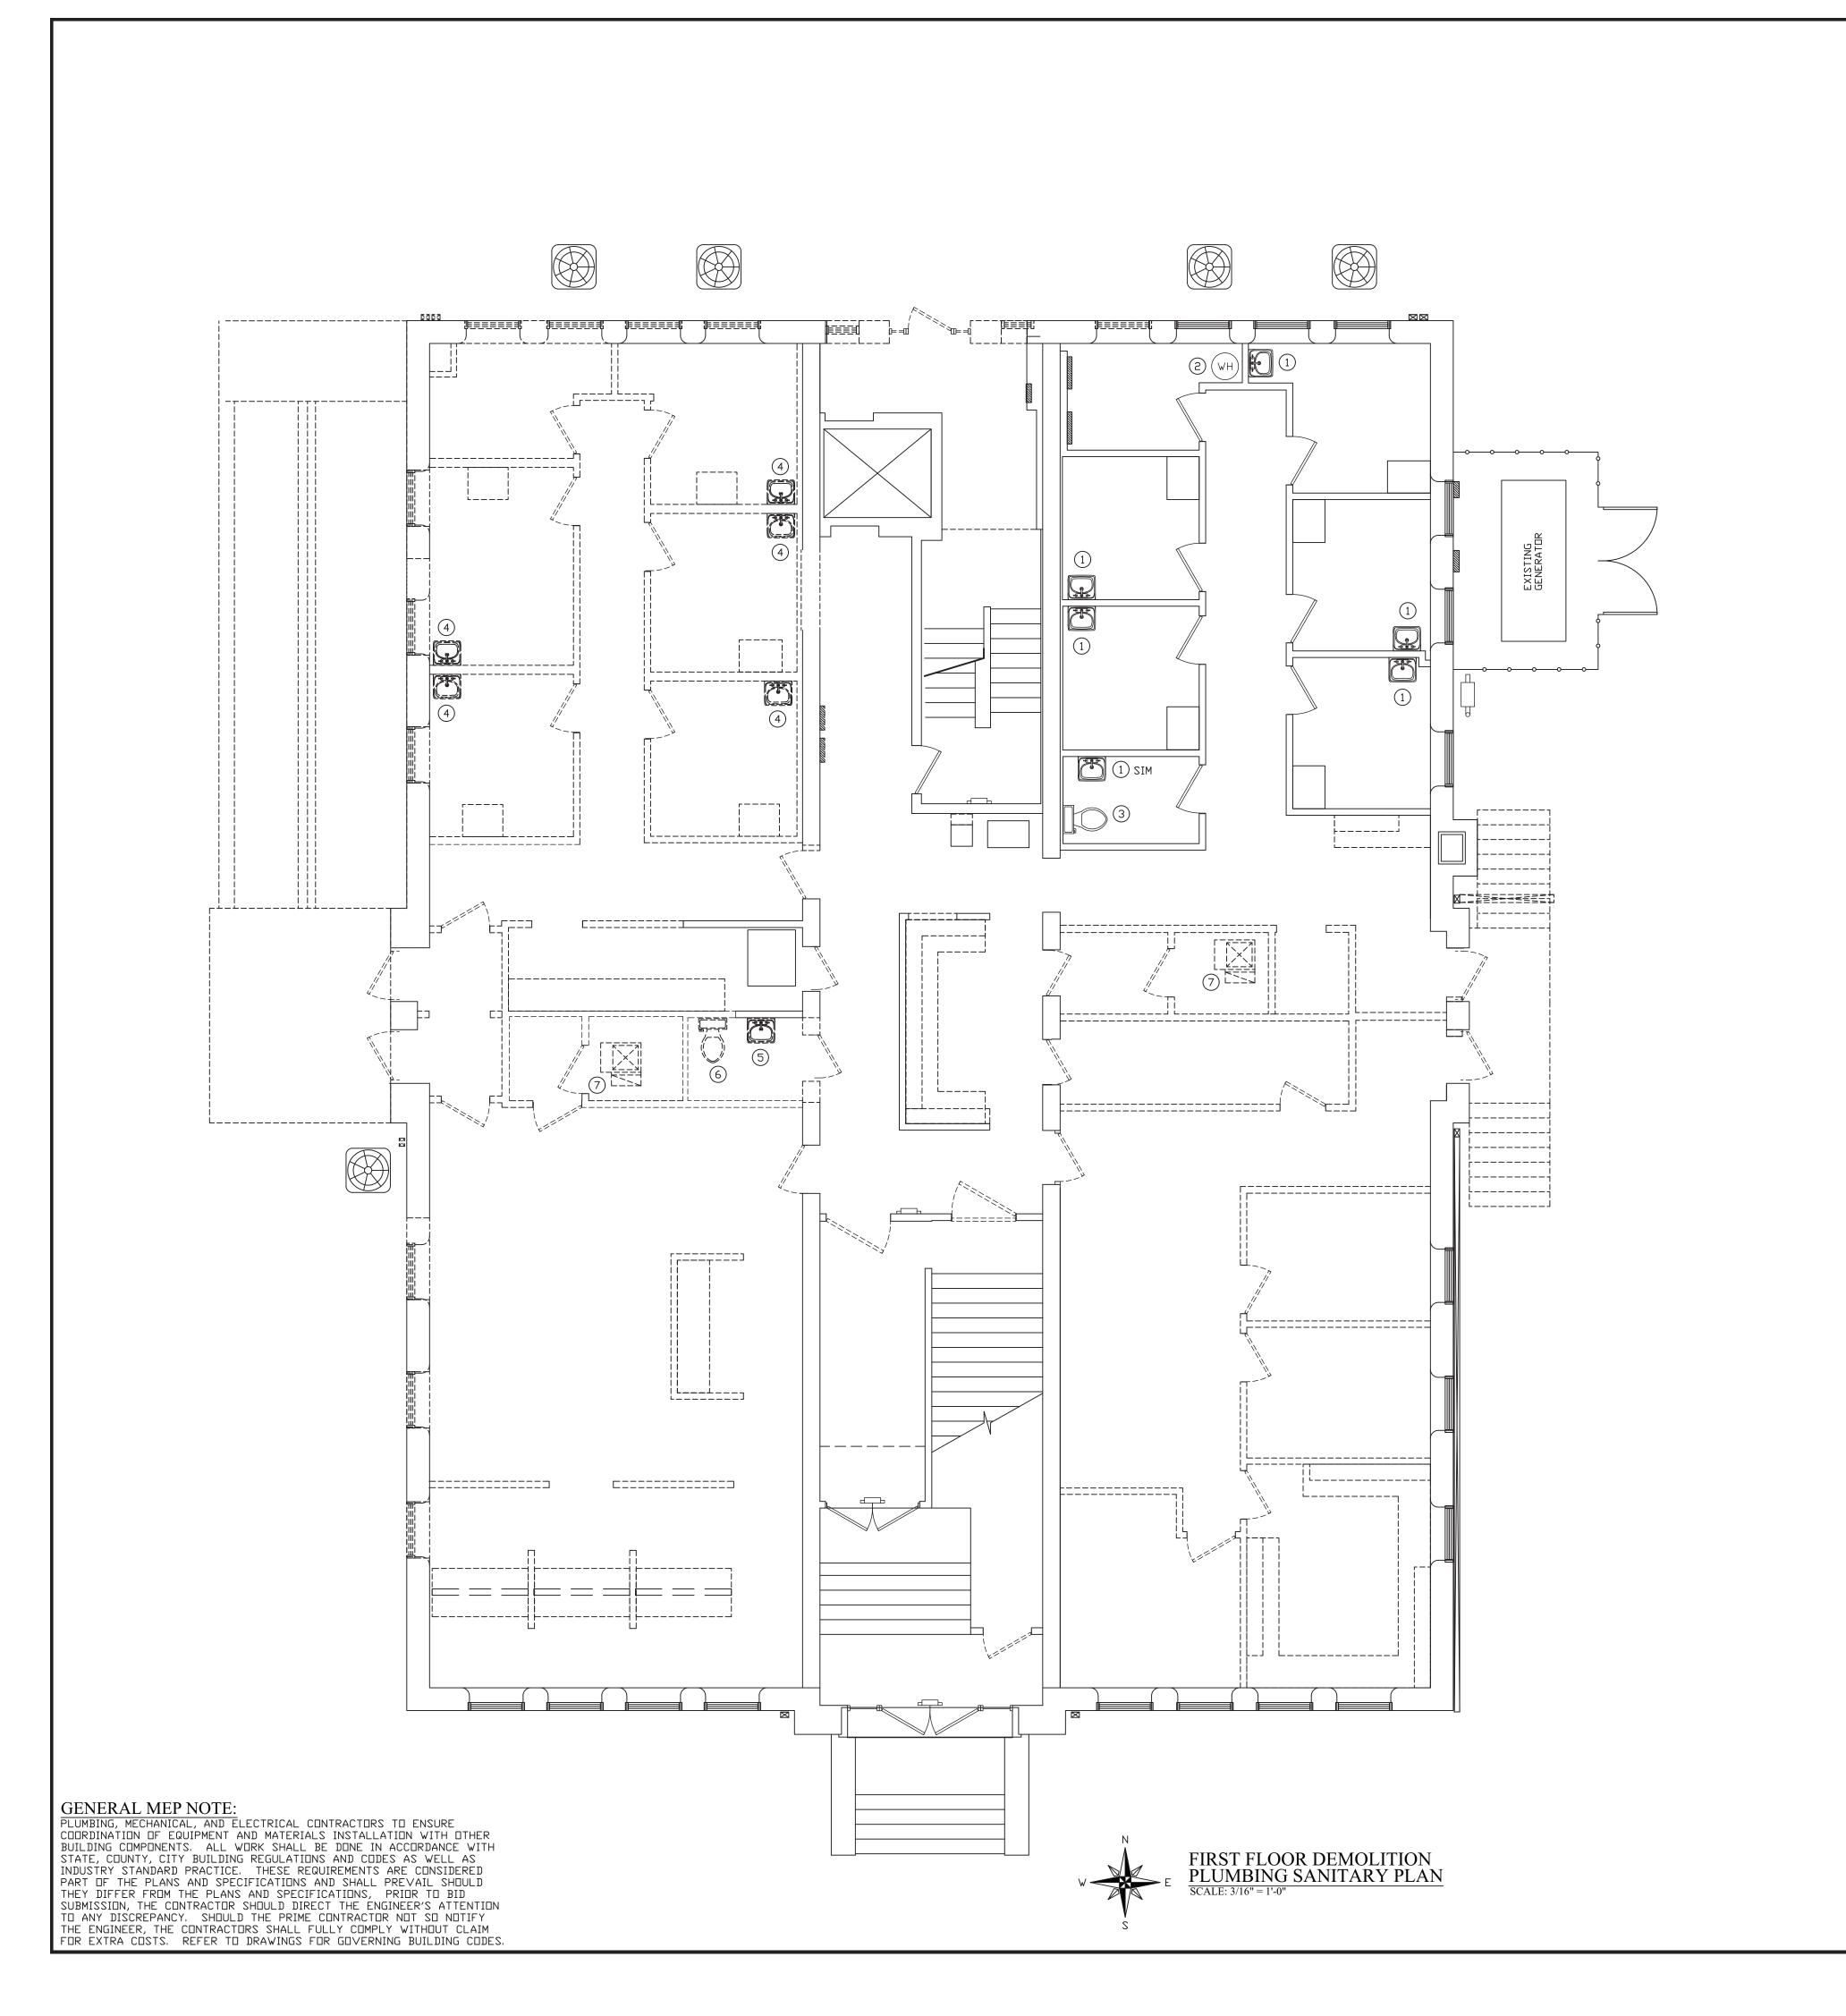

NUMBERED NOTES:

AND WALLS

REMOVE ALL WATER SUPPLY PIPING THRU THE FLOOR AND WALLS.

------ COLD WATER LINE

---- HOT WATER LINE

— GAS — GAS LINE

ENGINEERING & CONSULTING, INC

GENERAL NOTES:

--- SANITARY VENT LINE

——— SANITARY DRAIN LINE

ALL CONTRACTORS AND SUB-CONTRACTORS SHALL REVIEW ALL DRAWINGS FOR WORK PERFORMED BY THAT CONTRACTOR.

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CONSULTING, INC. (DESIGN PROFESSIONAL) AS INSTRUMENTS OF

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INCLUDING THE COPYRIGHT THERETO. THIS STATEMENT SHALL

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WALDBIESER ENGINEERING & CONSULTING, INC. MICHAEL R.

DATA, NOTES, AND OTHER DOCUMENTS AND INSTRUMENTS PREPARED BY MICHAEL R. WALDBIESER ENGINEERING &

SERVICE SHALL REMAIN THE PROPERTY OF MICHAEL R.

COMPLETE.. REMOVE ALL WASTE PIPING THRU THE FLOOR REMOVE ALL WATER SUPPLY PIPING THRU THE FLOOR AND WALLS.

1) EXISTING EXAM ROOM SINK. NO WORK

EXISTING WATER HEATER REMAINS. WILL BE RE-USED FOR ADDITIONAL SINKS.

3) EXISTING WATER CLOSET REMAINS. NO WORK.

REMOVE EXISTING EXAM ROOM SINK COMPLETE. REMOVE ALL WASTE PIPING THRU THE FLOOR REMOVE ALL WATER SUPPLY PIPING THRU THE FLOOR AND WALLS.

REMOVE EXISTING RESTROOM SINK COMPLETE.
REMOVE ALL WASTE PIPING THRU THE FLOOR
AND WALLS.

REMOVE EXISTING RESTROOM WATER CLOSET


7) CAP EXISTING CONDENSATE LINE FOR REMOVED GAS FURNACE.

DATE REVISIONS

WABASH VALLEY HEALTH CENTE 1436 LOCUST STREET TERRE HAUTE, INDIANA 47807

09-11-19 APPROVED BY: DRAWN BY: DATE:

PROJECT: 18-20 FILE: Plum #F

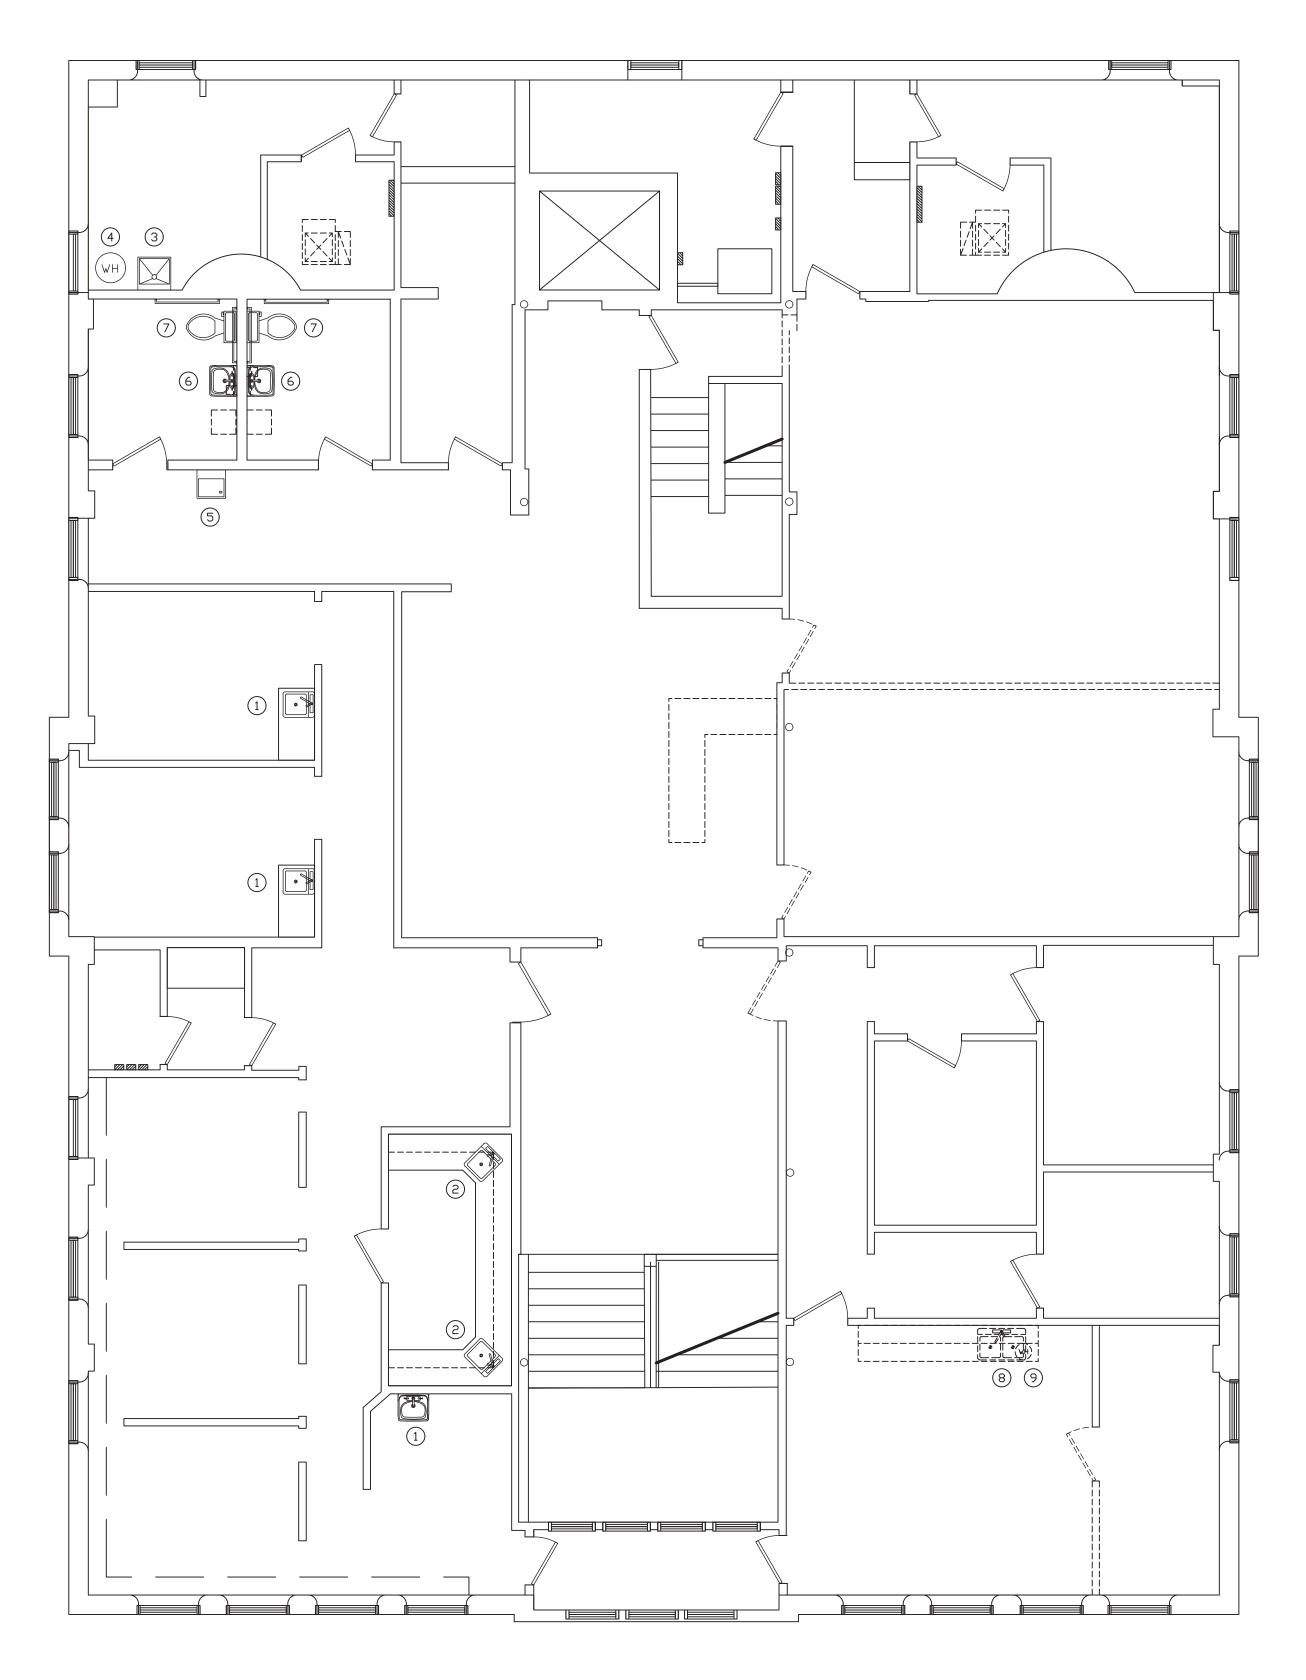

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- 1) EXISTING EXAM ROOM SINK REMAINS NO WORK
- 2) EXISTING DENTAL BAR SINKS REMAIN. NO WORK.
- 3) EXISTING LAUNDRY TUB REMAINS. NO WORK.
- 4) EXISTING WATER HEATER REMAINS. WILL BE RE-USED FOR ADDITIONAL SINKS.
- (5) EXISTING WALL HUNG WATER COOLER REMAINS NO WORK
- 6 EXISTING RESTROOM WALL HUNG LAVATORY REMAINS NO WORK
- 7) EXISTING RESTROOM WATER CLOSET TO REMAIN. NO WORK.
- (8) REMOVE EXISTING DOUBLE BOWL SINK COMPLETE. REMOVE ALL WASTE PIPING THRU THE FLOOR AND WALLS. REMOVE ALL WATER SUPPLY PIPING THRU THE FLOOR AND WALLS.
- REMOVE EXISTING 6 GALLON ELECTRIC WATER HEATER COMPLETE.



DATE REVISIONS

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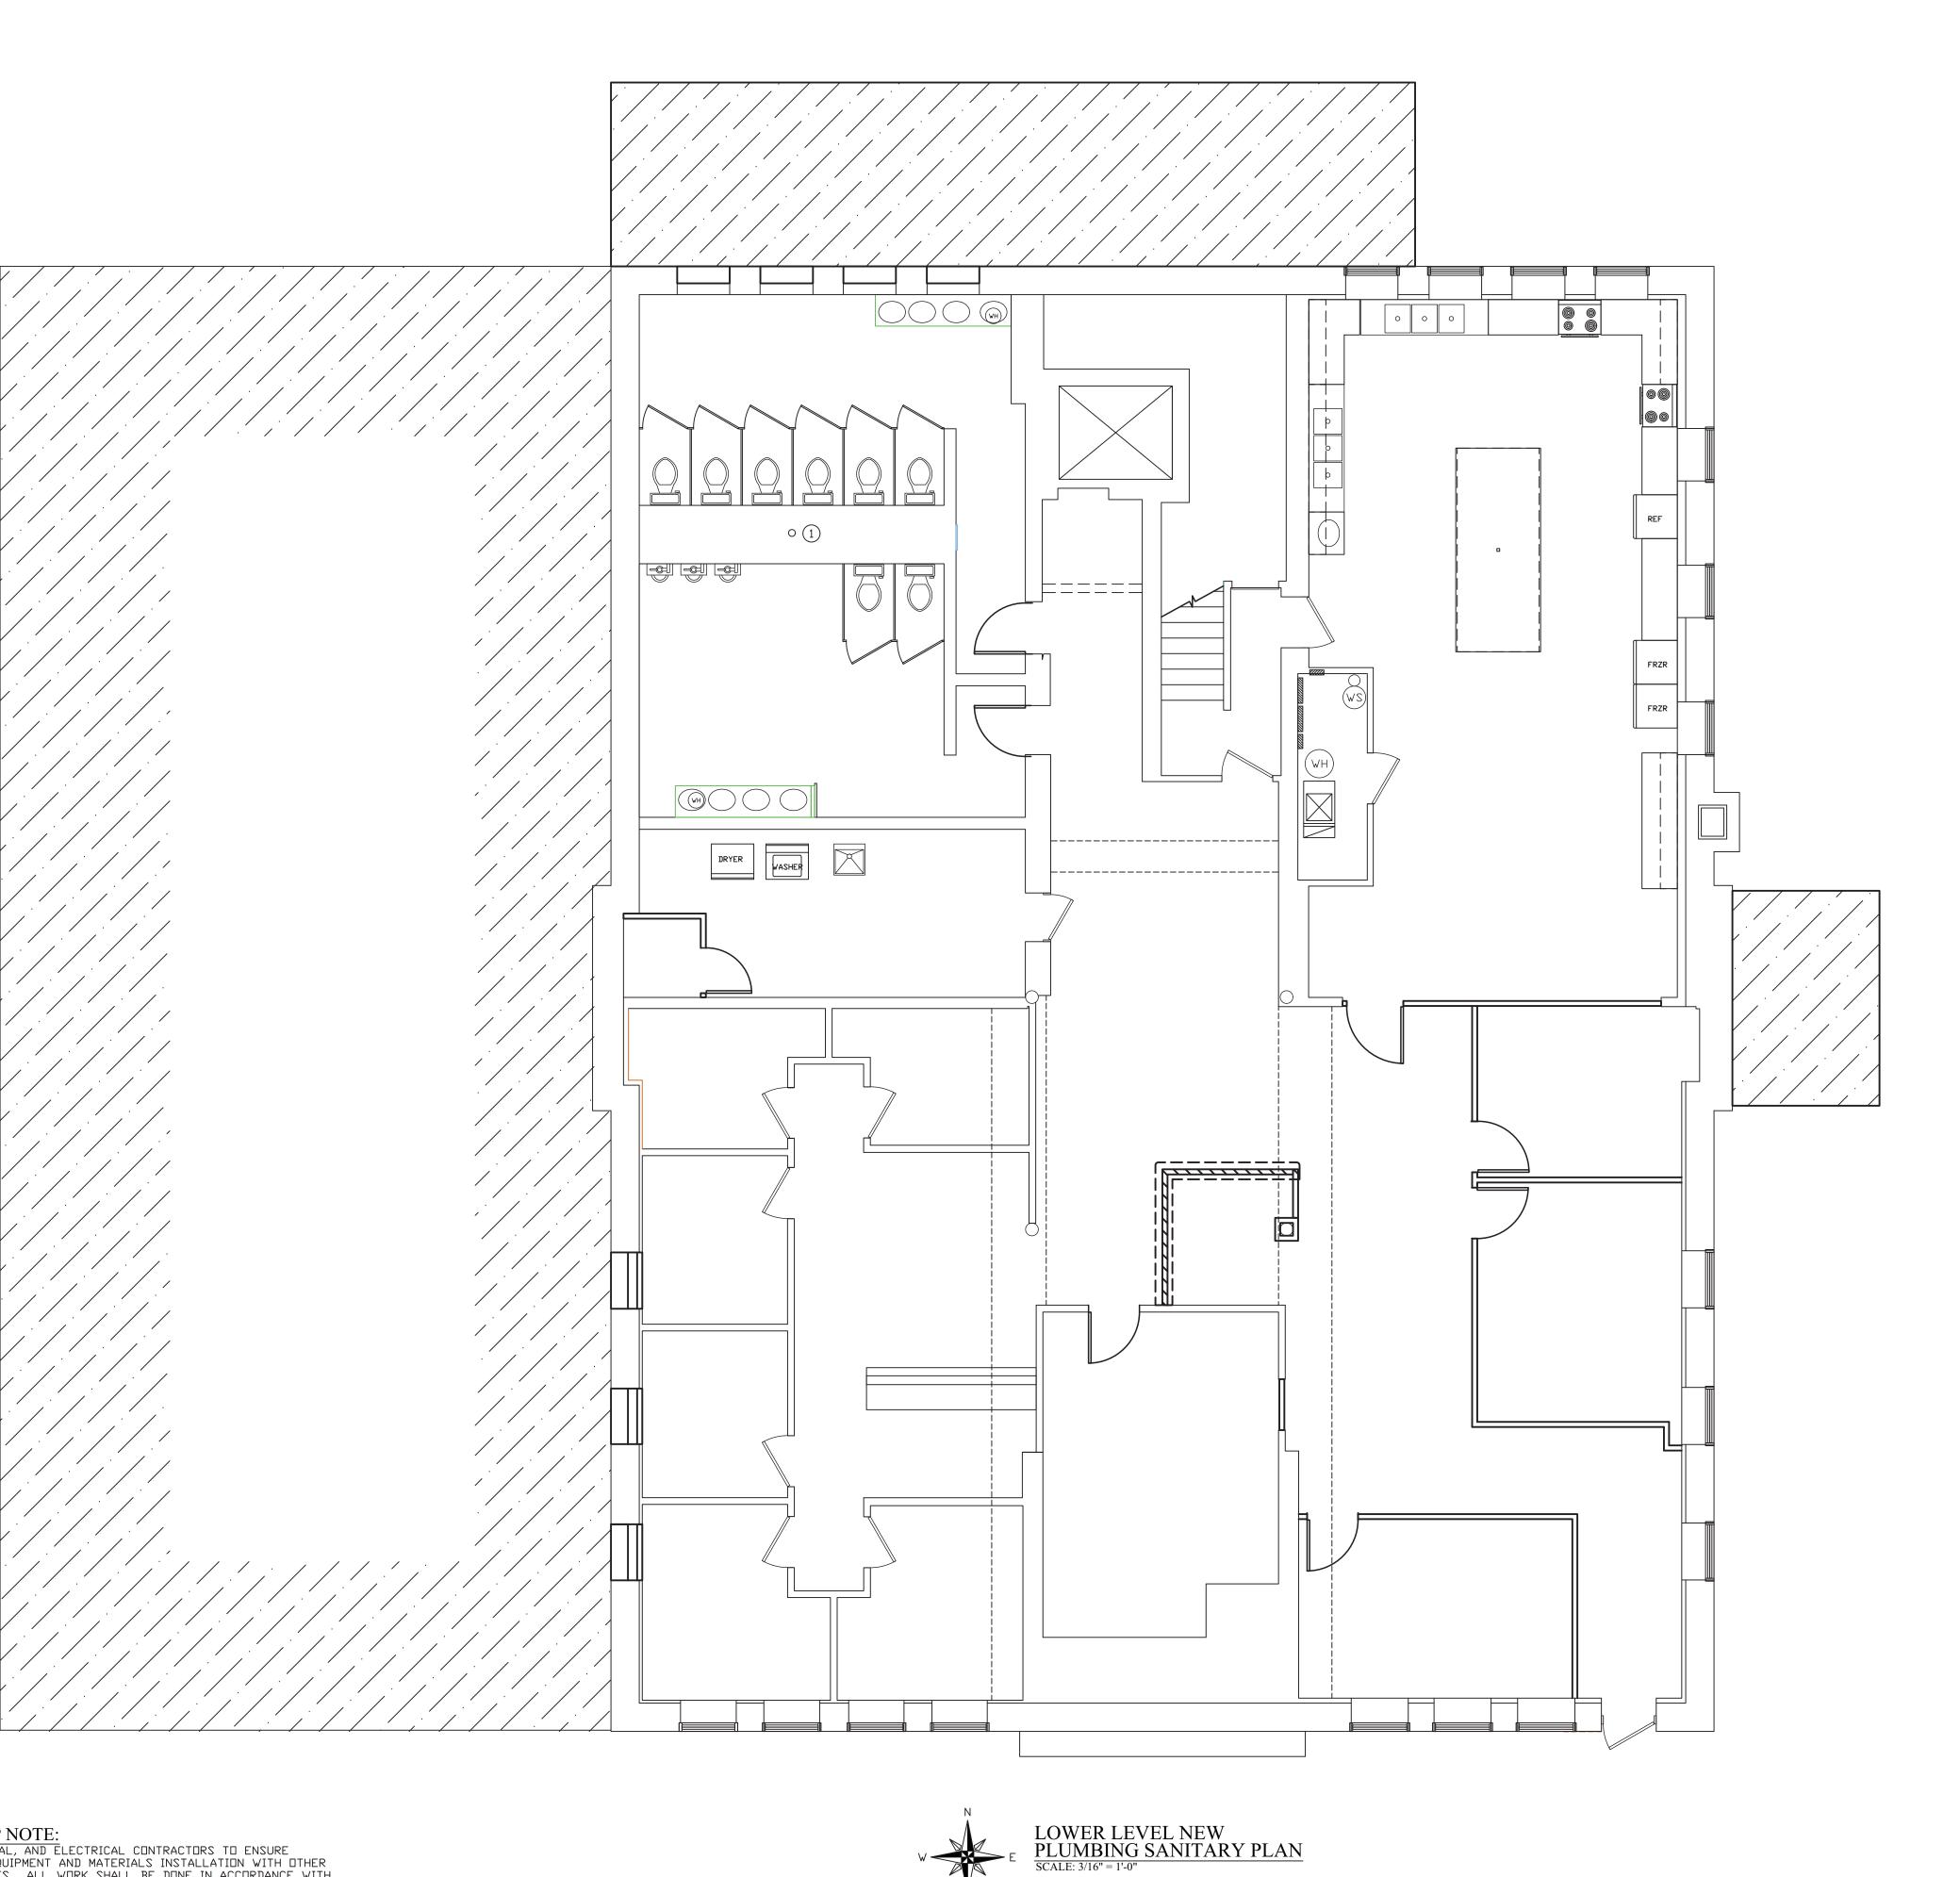
---- HOT WATER LINE --- SANITARY VENT LINE


> —————— SANITARY DRAIN LINE — GAS — GAS LINE

GENERAL NOTES:

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DATE REVISIONS

NUMBERED NOTES:

APPROXIMATE LOCATION OF 4" DIAMETER VERTICAL WASTE STACK IN RESTROOM CHASE. CONFIRM LOCATION AND SIZE PRIOR TO ROUGH-IN.

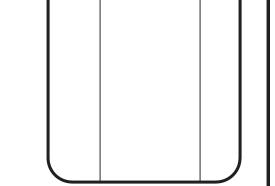

WABASH VALLEY HEALTH CE 1436 LOCUST STREET TERRE HAUTE, INDIANA 47807

DATE:

PROJECT: 18-20 FILE: Plum #F

---- HOT WATER LINE

--- SANITARY VENT LINE


— GAS — GAS LINE


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WABASH VALLEY HEALTH CENTER, 1436 LOCUST STREET TERRE HAUTE, INDIANA 47807 BUILDING ADDITIONS & RENOVATION

APPROVED BY:


DATE:

PROJECT: 18-20

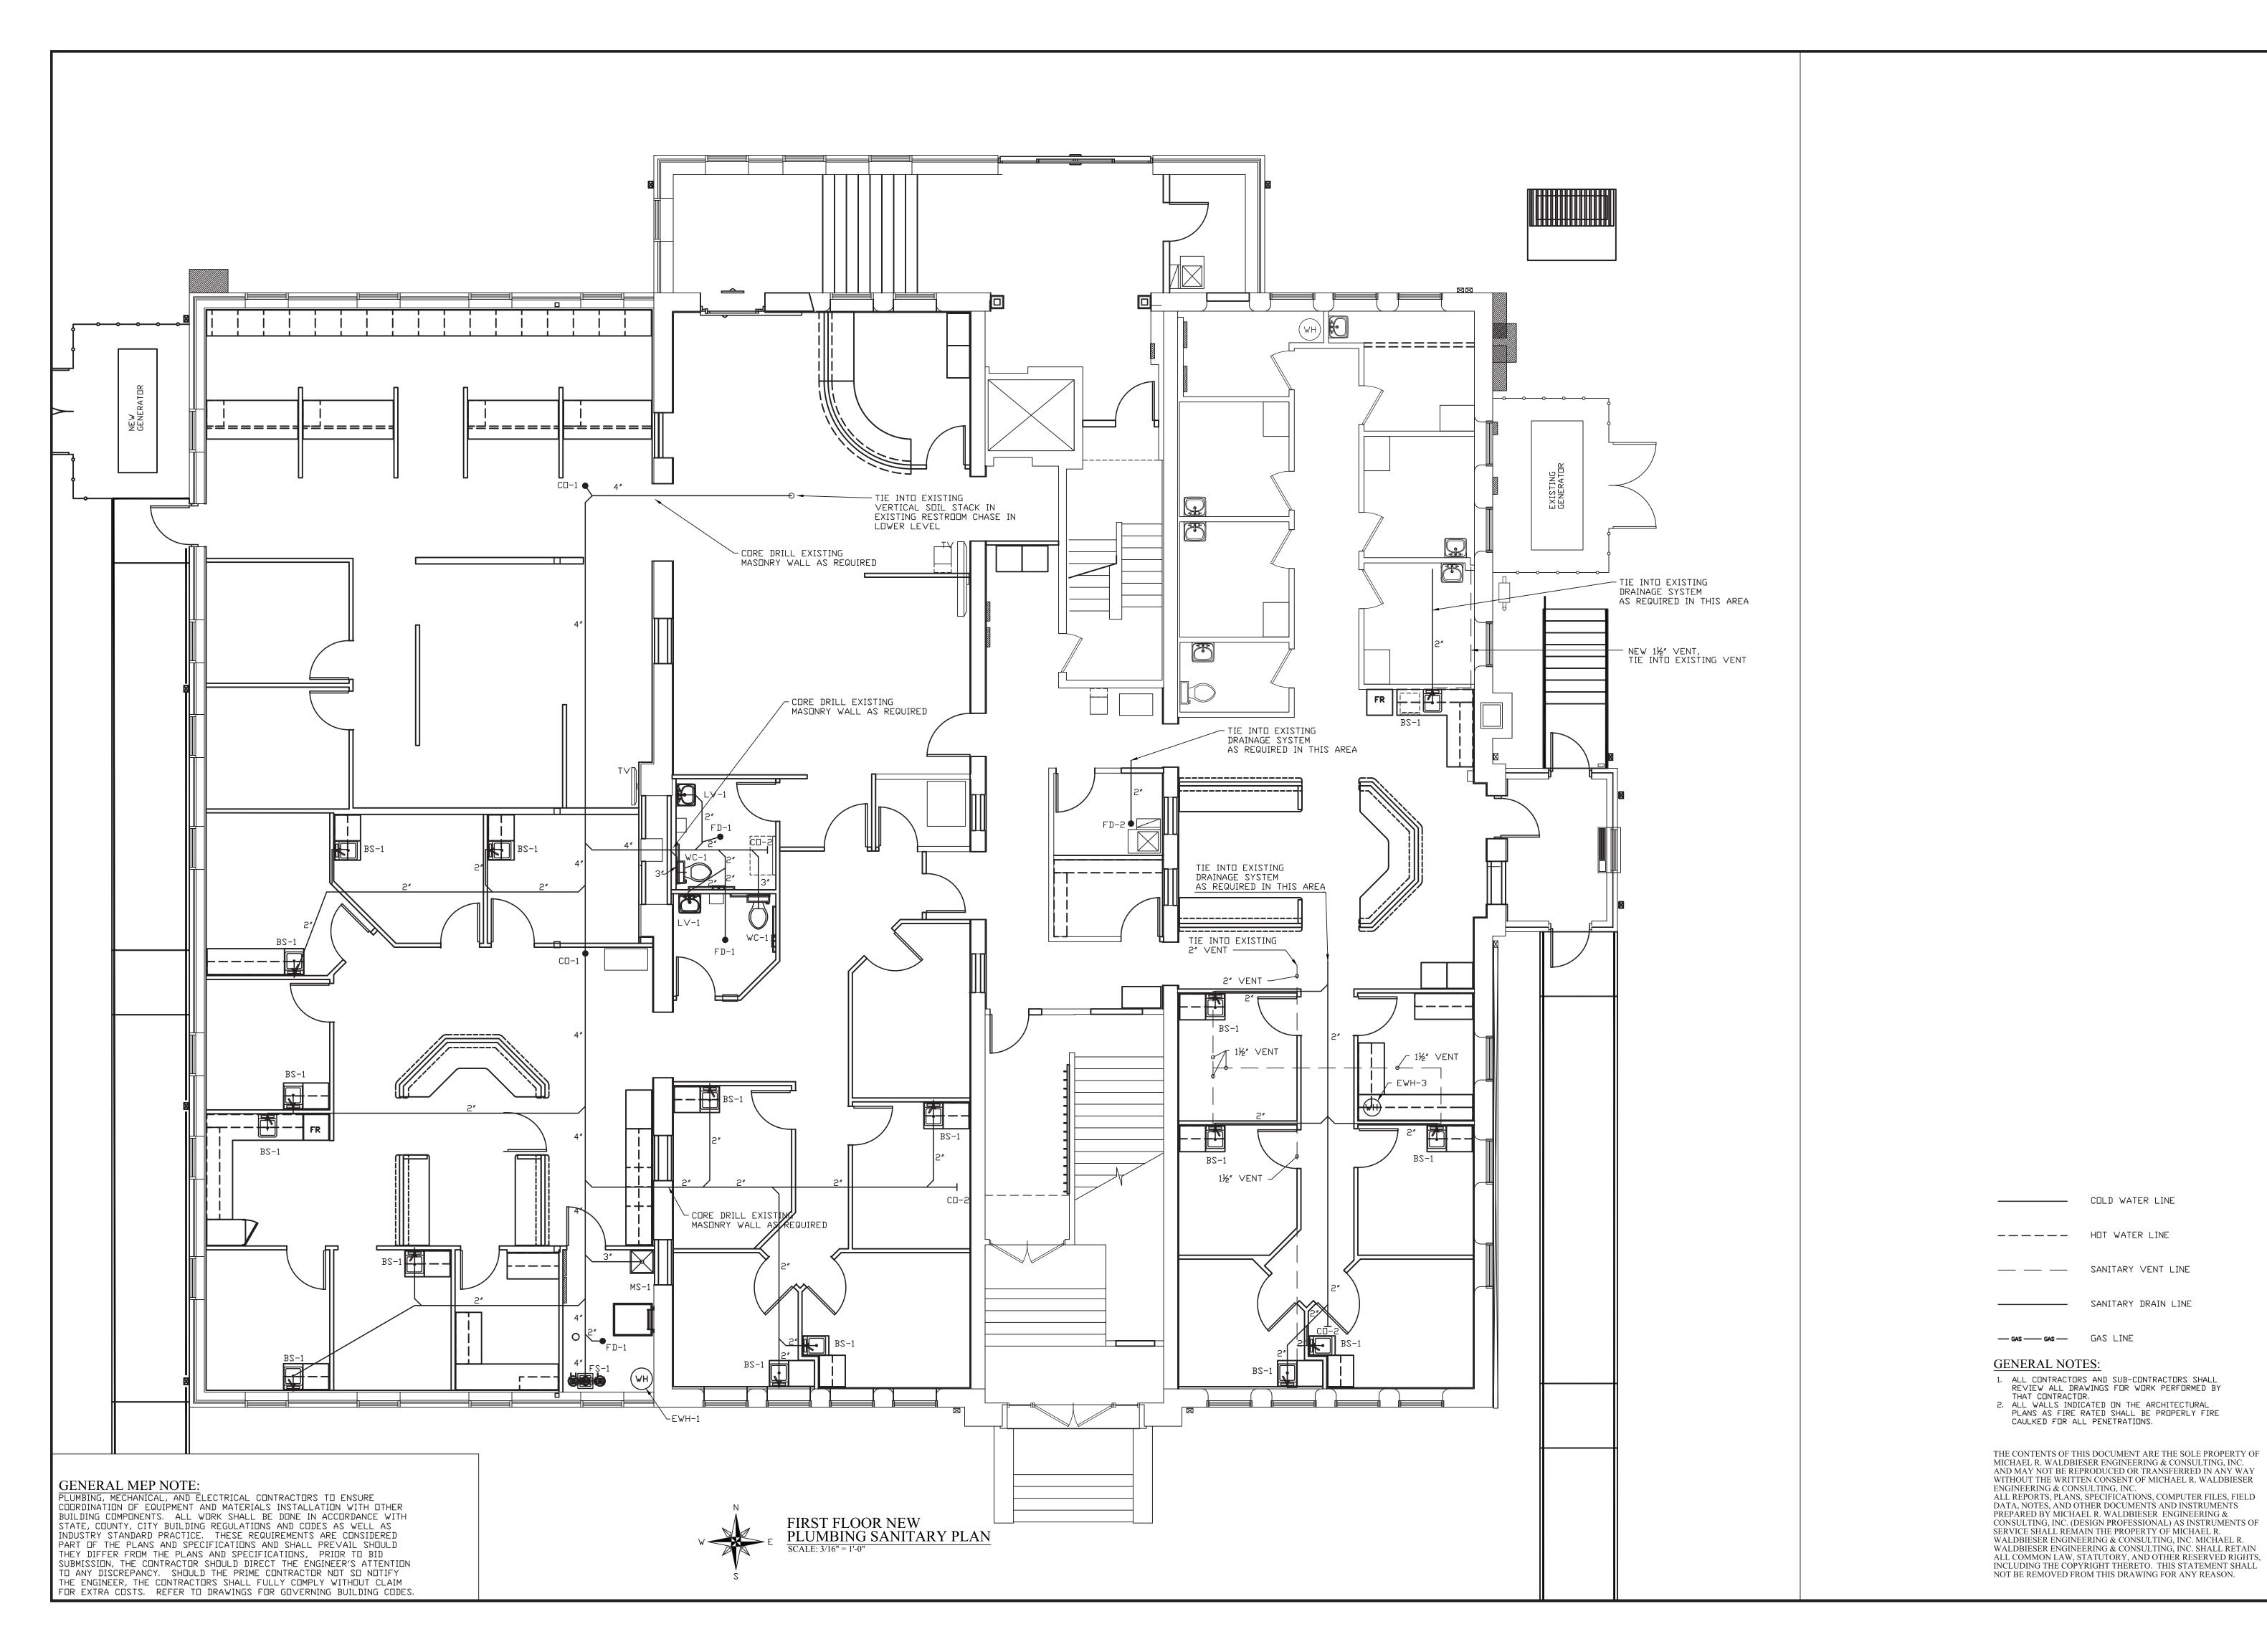FILE: Plum #F

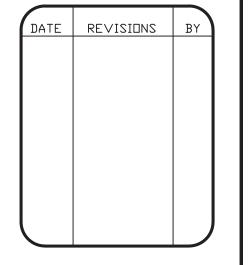PLAN NOTES:

1) PROVIDE AND INSTALL ADA COMPLIANT UNDER SINK WATER SUPPLY AND DRAIN COVERS

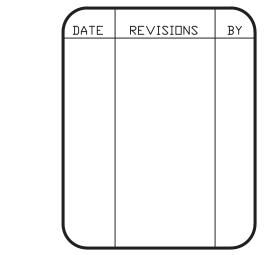



WABASH VALLEY HEALTH CENT 1436 LOCUST STREET TERRE HAUTE, INDIANA 47807

DATE: PROJECT: 18-20 FILE: Plum #F

— GAS — GAS LINE GENERAL NOTES:

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 ALL WALLS INDICATED ON THE ARCHITECTURAL PLANS AS FIRE RATED SHALL BE PROPERLY FIRE CAULKED FOR ALL PENETRATIONS.

---- HOT WATER LINE

--- SANITARY VENT LINE

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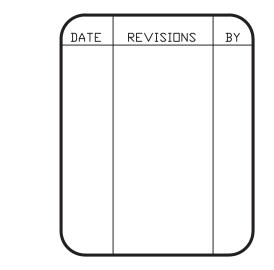
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PLAN NOTES:

(1) CORE DRILL EXISTING MASONRY WALL AS REQUIRED.





WABASH VALLEY HEALTH CENTE 1436 LOCUST STREET TERRE HAUTE, INDIANA 47807

09-11-19 DRAWN BY:

---- HOT WATER LINE

--- SANITARY VENT LINE

————— SANITARY DRAIN LINE

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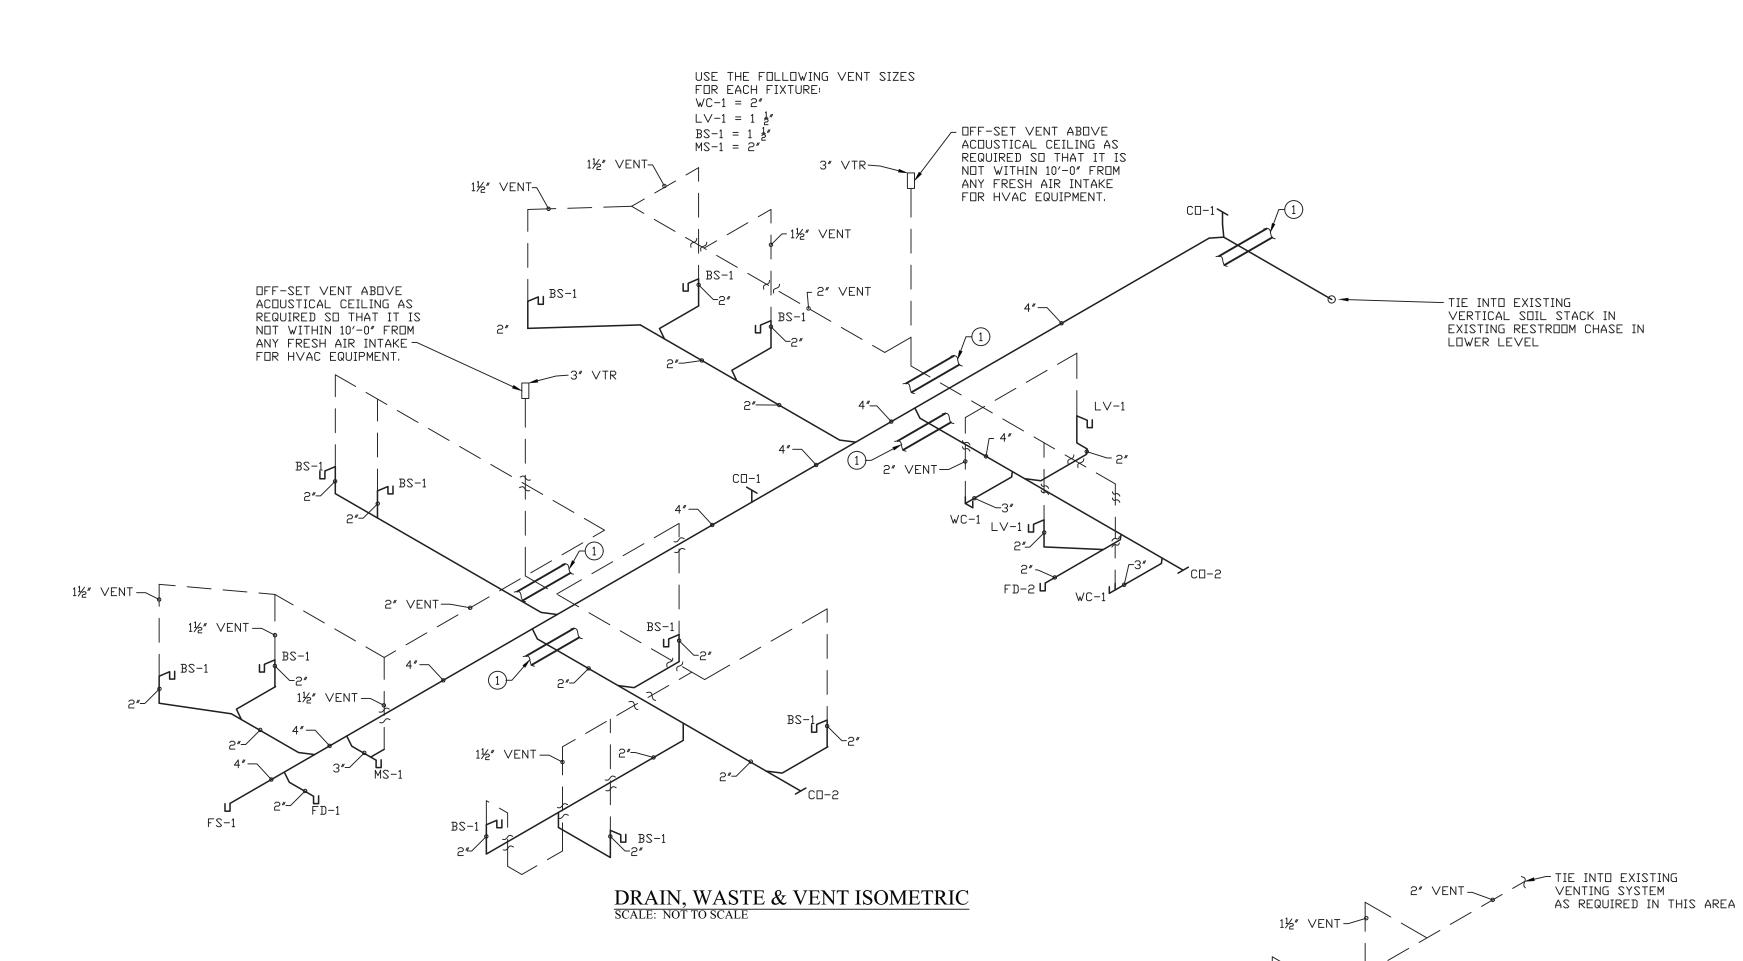
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— GAS — GAS LINE

ENGINEERING & CONSULTING, INC.

GENERAL NOTES:

DATE: PROJECT: 18-20 FILE: Plum #F



DRAIN, WASTE & VENT ISOMETRIC SCALE: NOT TO SCALE

1½″ VENT


∕TIE INTO EXISTING DRAINAGE SYSTEM AS REQUIRED IN THIS AREA

1½″ VENT

1½″ VENT —

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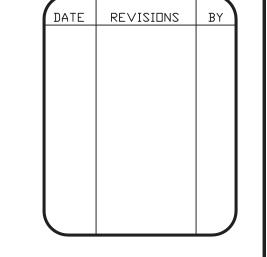


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NUMBERED NOTES:

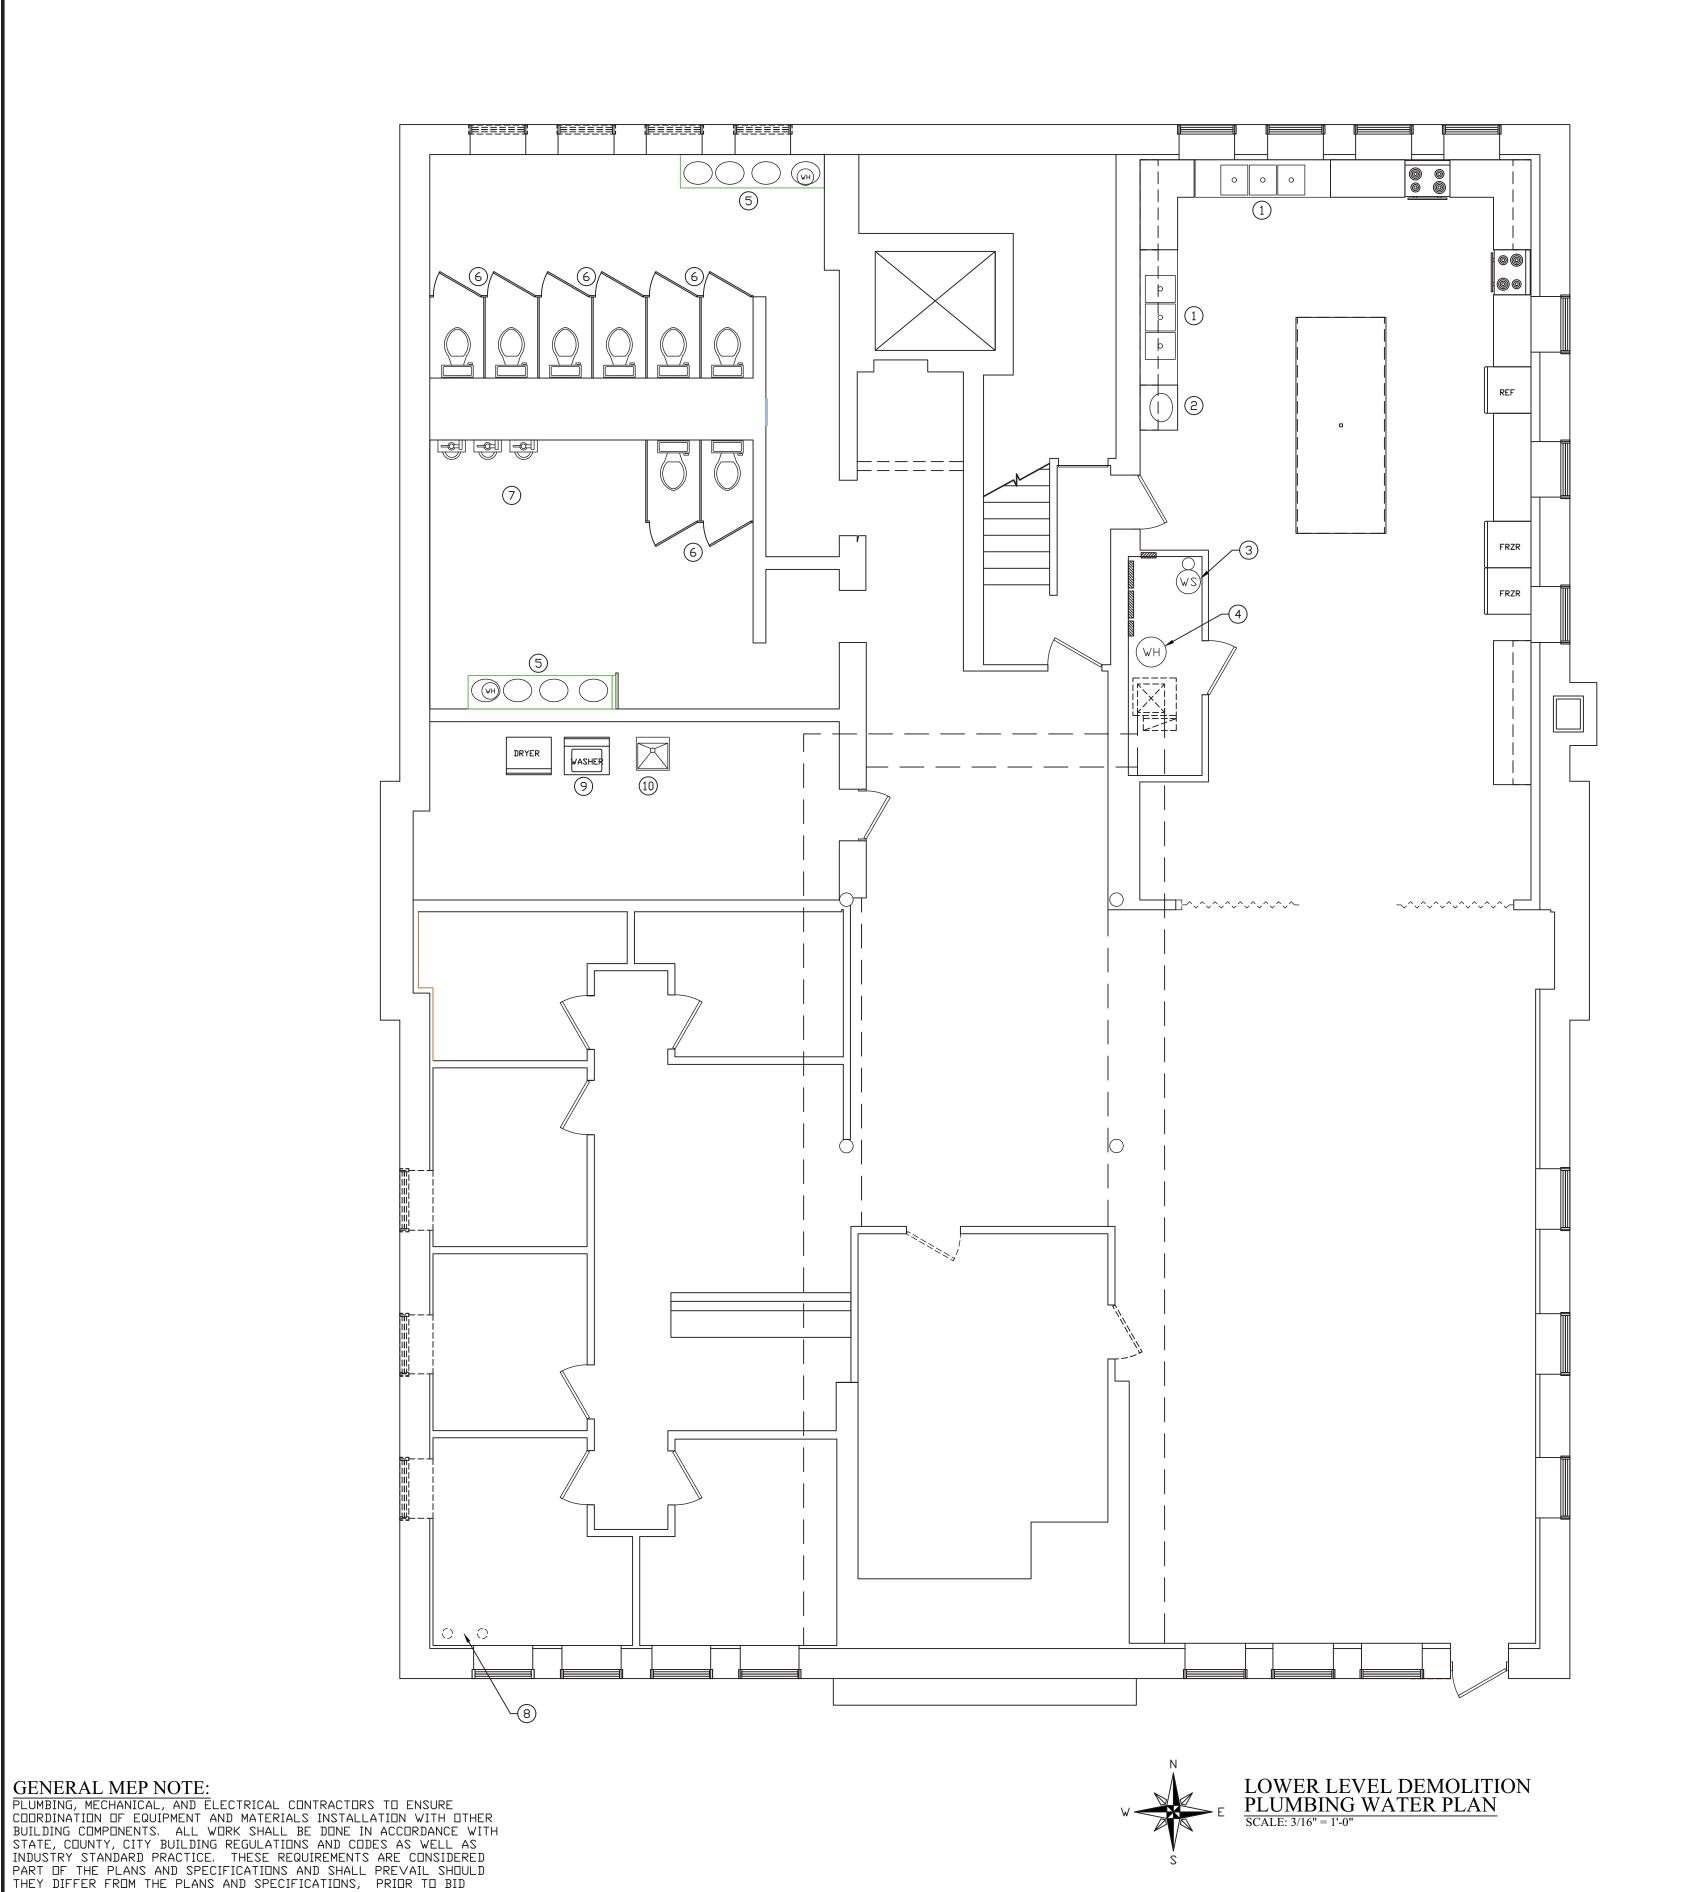1) EXISTING KITCHEN SINK REMAINS NO WORK

- 2) EXISTING KITCHEN HAND WASH SINK REMAINS NO WORK
- 3) EXISTING WATER SOFTENER REMAINS NO WORK
- 4) EXISTING WATER HEATER REMAINS NO WORK
- (5) EXISTING RESTROOM SINK AND WATER HEATER REMAINS NO WORK
- 6 EXISTING RESTROOM WATER CLOSETS REMAIN NO WORK
- 7) EXISTING RESTROOM URINALS REMAIN NO WORK
- 8 LOCATION OF EXISTING UNDER FLOOR DOMESTIC WATER SERVICE.
 THIS SERVICE WILL BE REMOVED AND ABANDONED.
 PLUMBING CONTRACTOR TO CAP EXISTING LINE
 BELOW FINISH FLOOR.
 CONCRETE REMOVAL AND REPLACEMENT BY GENERAL
 CONTRACTOR.
- 9 EXISTING CLOTHS WASHING MACHINE REMAINS NO WORK
- (10) EXISTING LAUNDRY TUB REMAINS NO WORK



WABASH VALLEY HEALTH CENTE 1436 LOCUST STREET TERRE HAUTE, INDIANA 47807

09-11-19 APPROVED BY: DRAWN BY: DATE:

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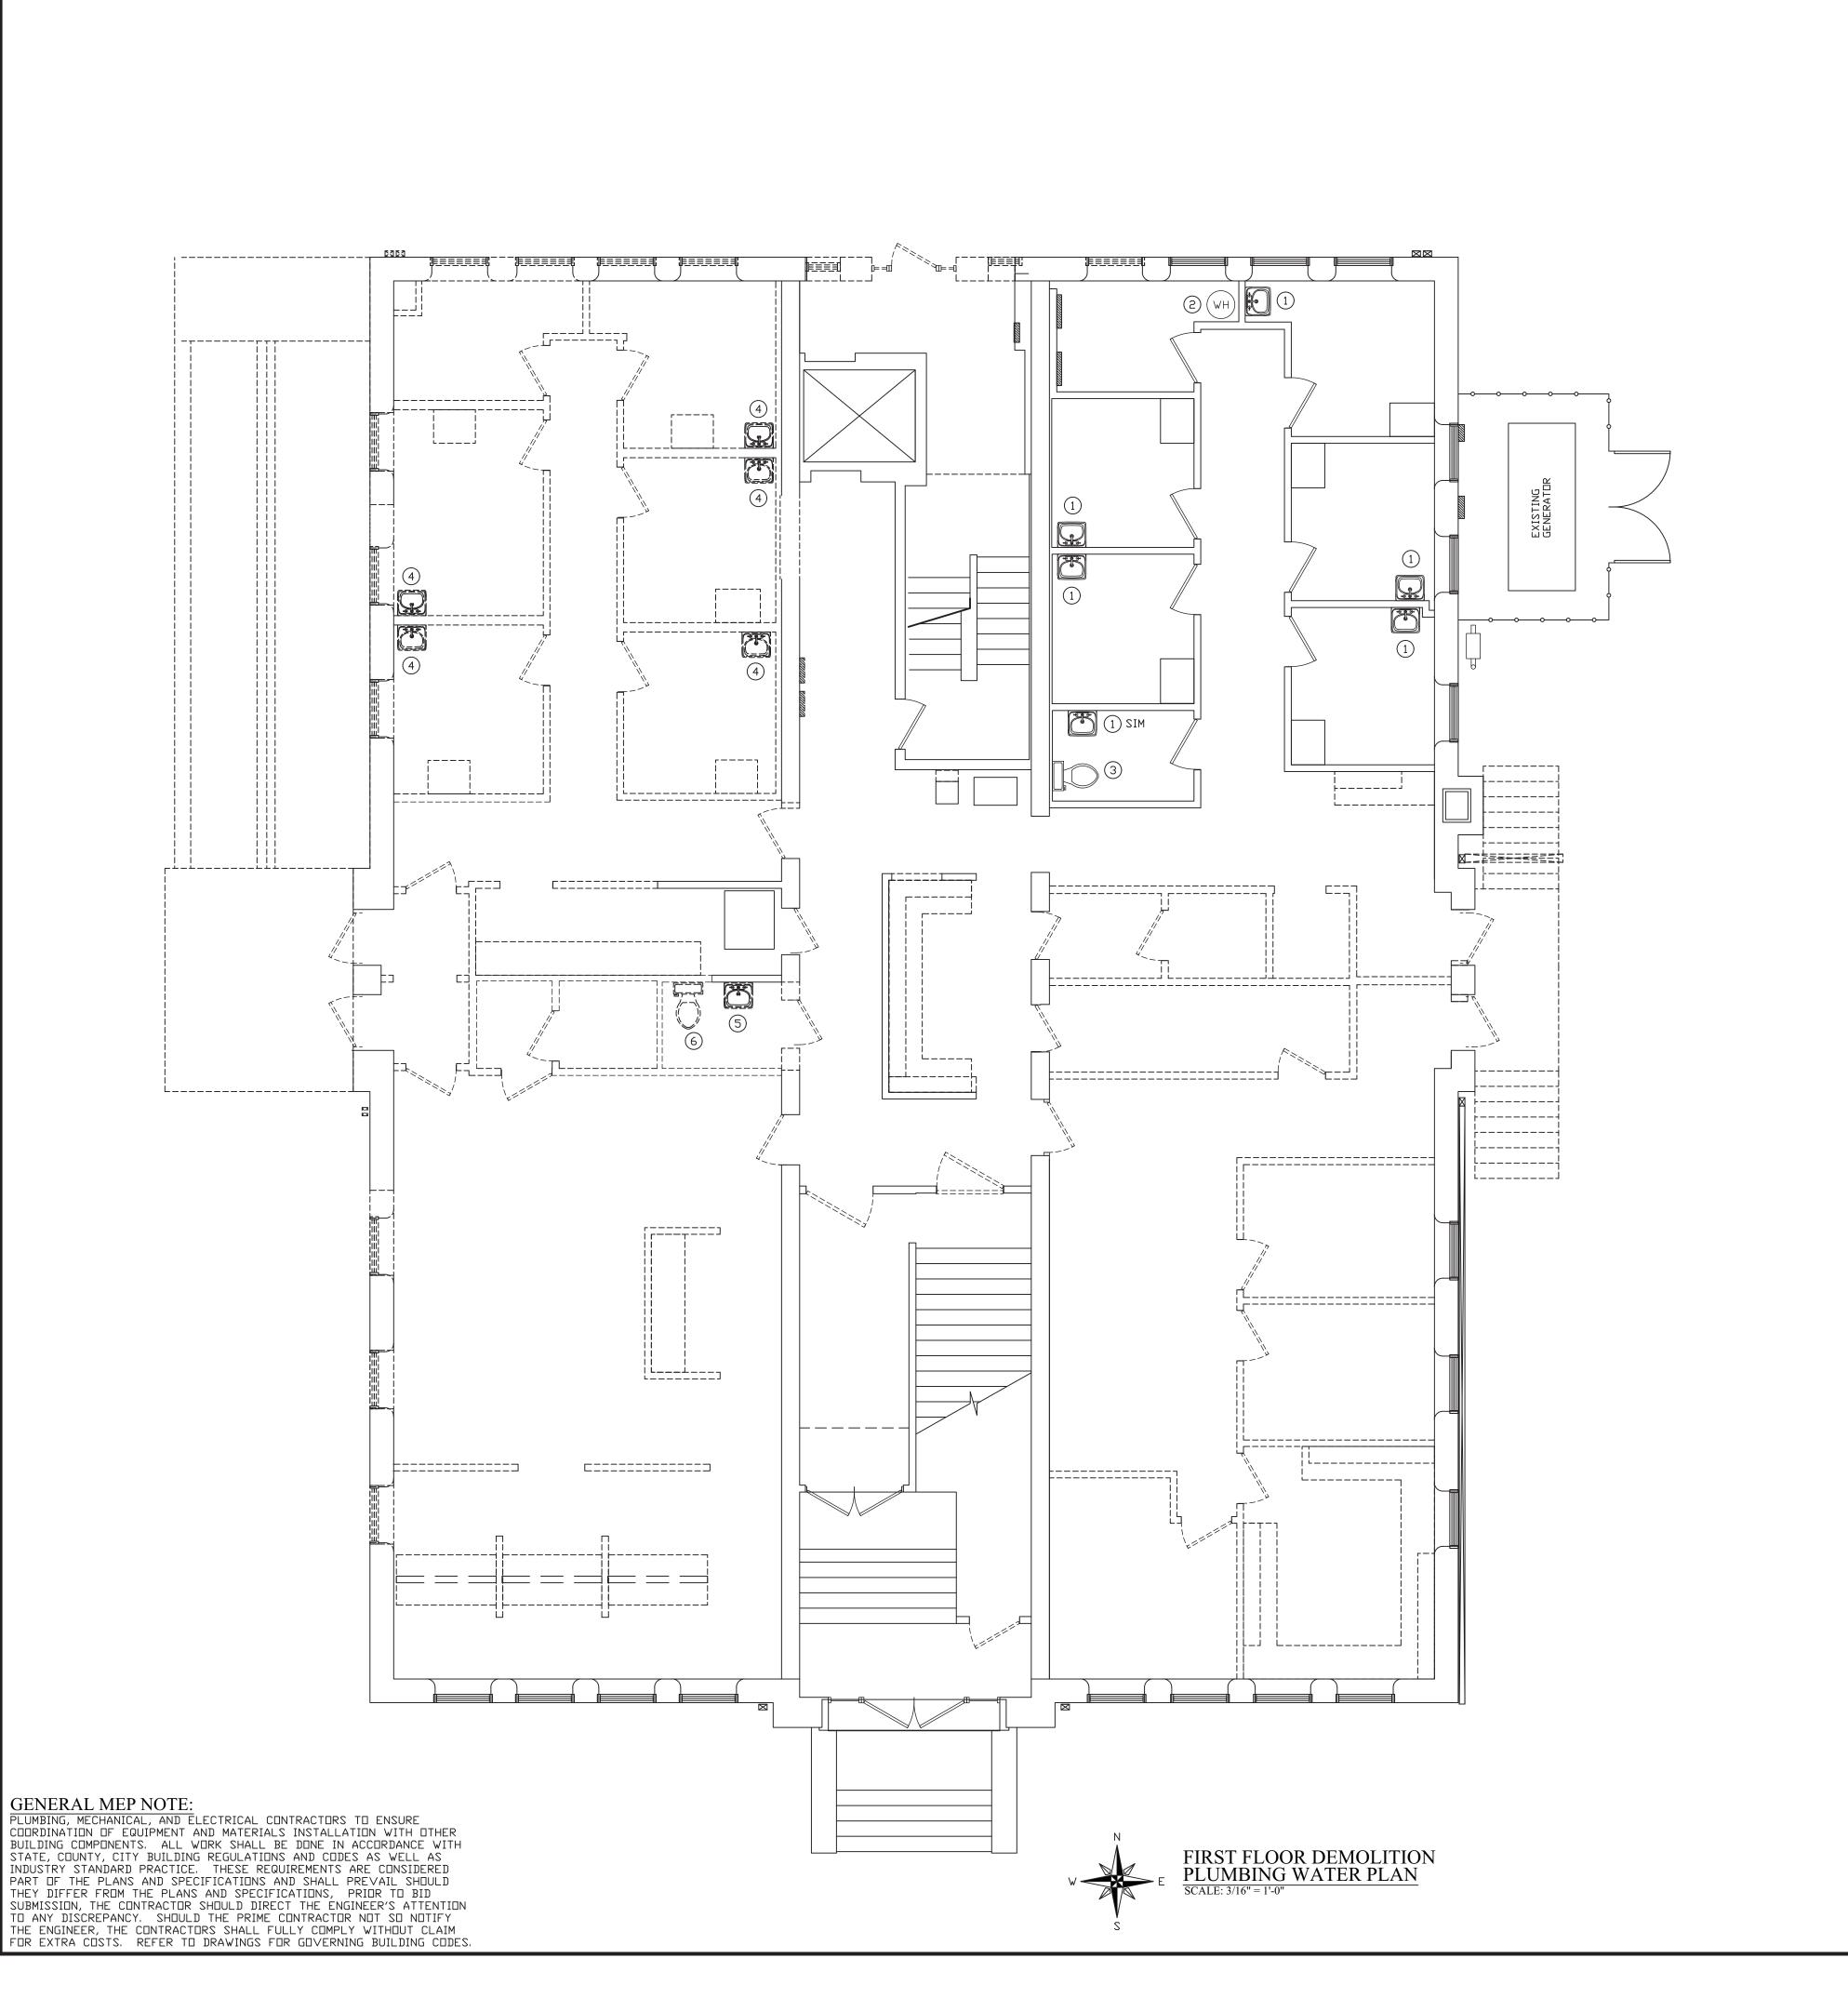
---- HOT WATER LINE --- SANITARY VENT LINE


— GAS — GAS LINE

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NUMBERED NOTES:

- 1) EXISTING EXAM ROOM SINK. NO WORK
- EXISTING WATER HEATER REMAINS. WILL BE RE-USED FOR ADDITIONAL SINKS.
- 3 EXISTING WATER CLOSET REMAINS. NO WORK.
- AREMOVE EXISTING EXAM ROOM SINK COMPLETE. REMOVE ALL WASTE PIPING THRU THE FLOOR AND WALLS.

 REMOVE ALL WATER SUPPLY PIPING THRU THE FLOOR AND WALLS.
- REMOVE EXISTING RESTROOM SINK COMPLETE.
 REMOVE ALL WASTE PIPING THRU THE FLOOR
 AND WALLS.
 REMOVE ALL WATER SUPPLY PIPING THRU THE
 FLOOR AND WALLS.
- 6 REMOVE EXISTING RESTROOM WATER CLOSET COMPLETE.. REMOVE ALL WASTE PIPING THRU THE FLOOR REMOVE ALL WATER SUPPLY PIPING THRU THE FLOOR AND WALLS.

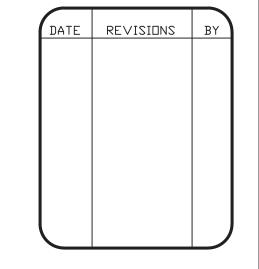

WABASH VALLEY HEALTH CENTER, INC. 1436 LOCUST STREET TERRE HAUTE, INDIANA 47807

NESIGN TE

LIES, WYALIOBELES SINEERING & CONSULTING, INC.

WITCHEAN ELL ENGINEER
STRUCTURAL, PLUI

6" = 1'-0"

11-19

Y: MRW

DBY: MRW

SCALE: 3/16" = 1'-0"

DATE: 09-11-19

DRAWN BY: MRW

APPROVED BY: MRW

PROJECT: 18-20 FILE: Plum #F

P2.1

_____ COLD WATER LINE

---- HOT WATER LINE

--- SANITARY VENT LINE


SANITARY DRAIN LINE

— GAS — GAS LINE

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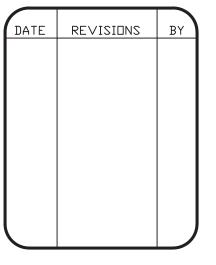
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- 1) EXISTING EXAM ROOM SINK REMAINS NO WORK
- 2) EXISTING DENTAL BAR SINKS REMAIN. NO WORK.
- 3) EXISTING LAUNDRY TUB REMAINS, NO WORK,
- 4) EXISTING WATER HEATER REMAINS. WILL BE RE-USED FOR ADDITIONAL SINKS.
- 5) EXISTING WALL HUNG WATER COOLER REMAINS NO WORK
- 6 EXISTING RESTROOM WALL HUNG LAVATORY REMAINS NO WORK
- 7) EXISTING RESTROOM WATER CLOSET TO REMAIN NO WORK
- 8 REMOVE EXISTING DOUBLE BOWL SINK COMPLETE. REMOVE ALL WASTE PIPING THRU THE FLOOR AND WALLS. REMOVE ALL WATER SUPPLY PIPING THRU THE FLOOR AND WALLS.
- 9 REMOVE EXISTING 6 GALLON ELECTRIC WATER HEATER COMPLETE.



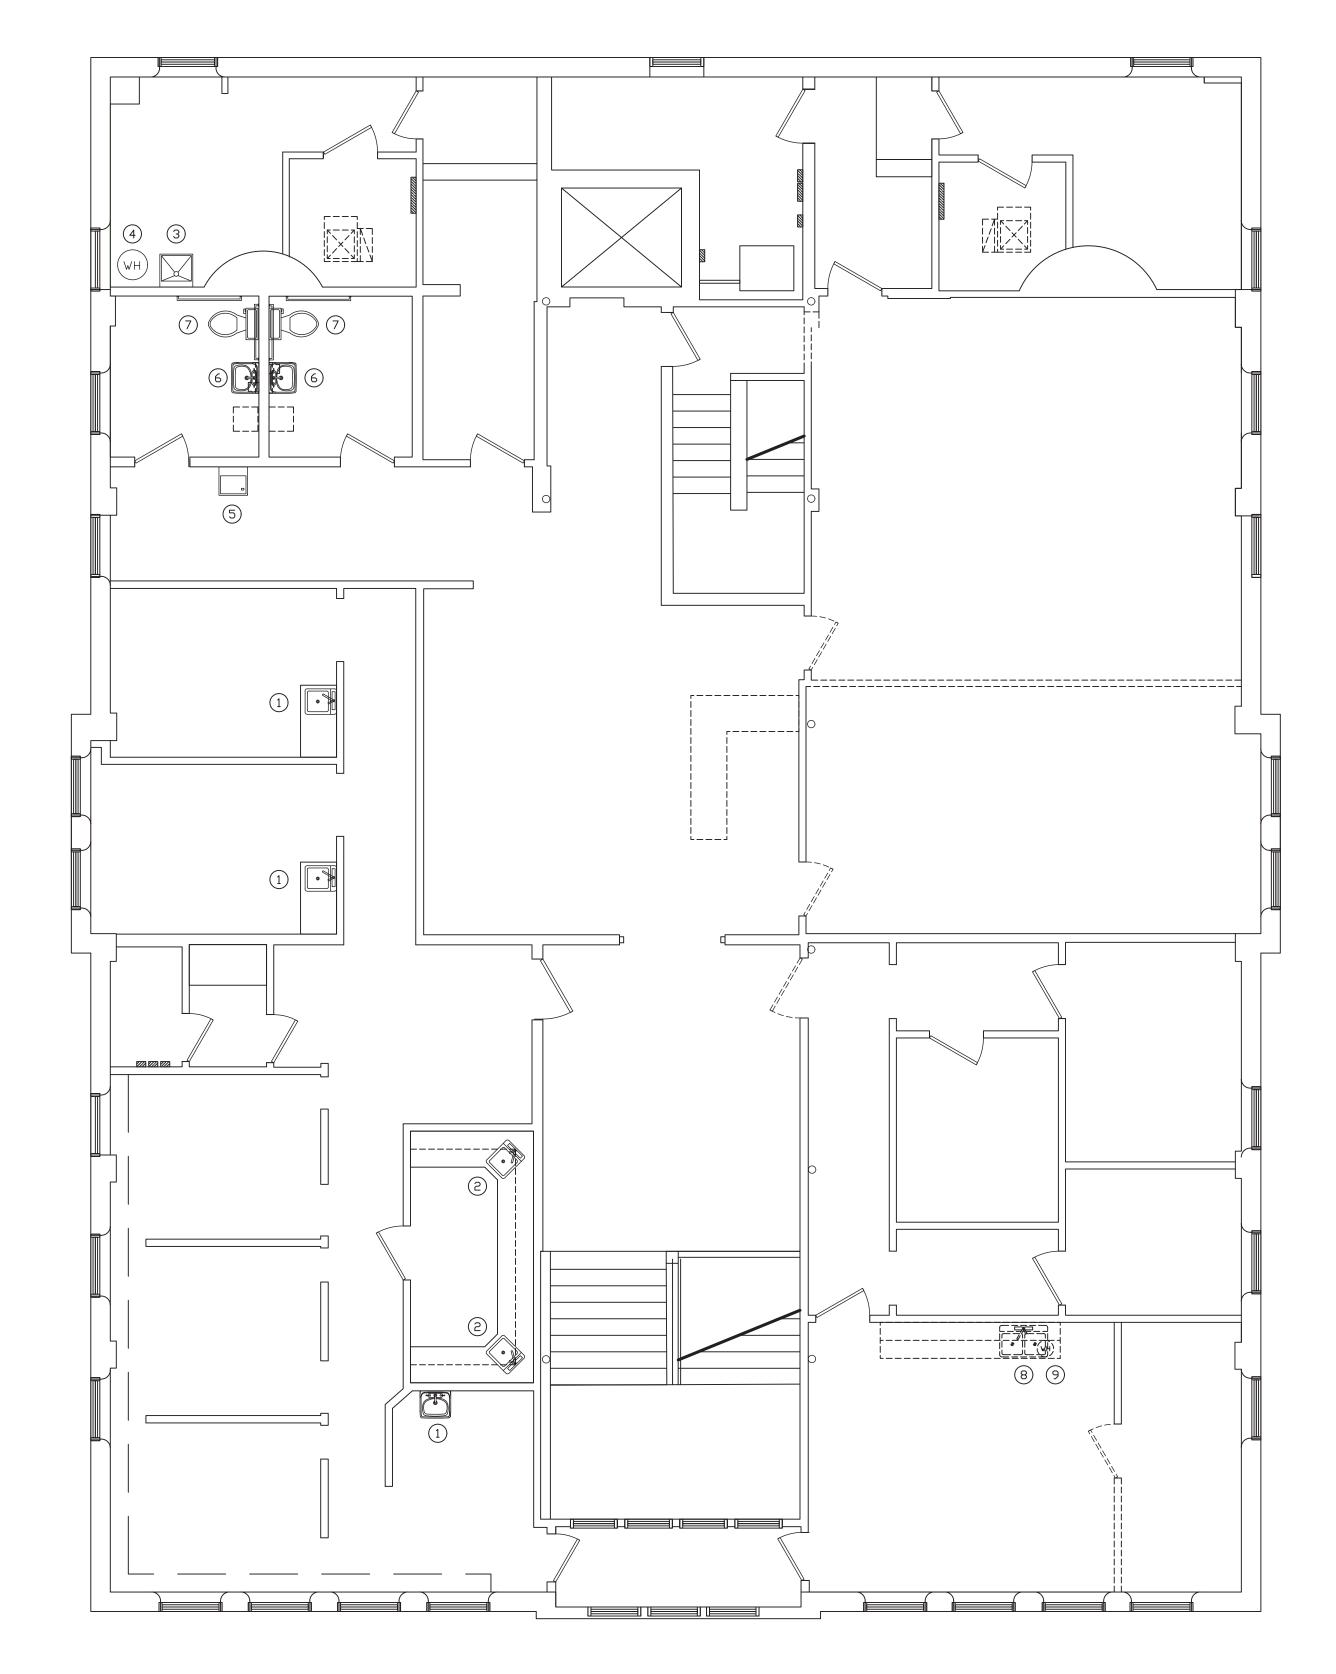

WABASH VALLEY HEALTH CENTE 1436 LOCUST STREET TERRE HAUTE, INDIANA 47807

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PROJECT: 18-20 FILE: Plum #F

---- HOT WATER LINE --- SANITARY VENT LINE —————— SANITARY DRAIN LINE


— GAS — GAS LINE


GENERAL NOTES:

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DATE:

PROJECT: 18-20 FILE: Plum #F

---- HOT WATER LINE

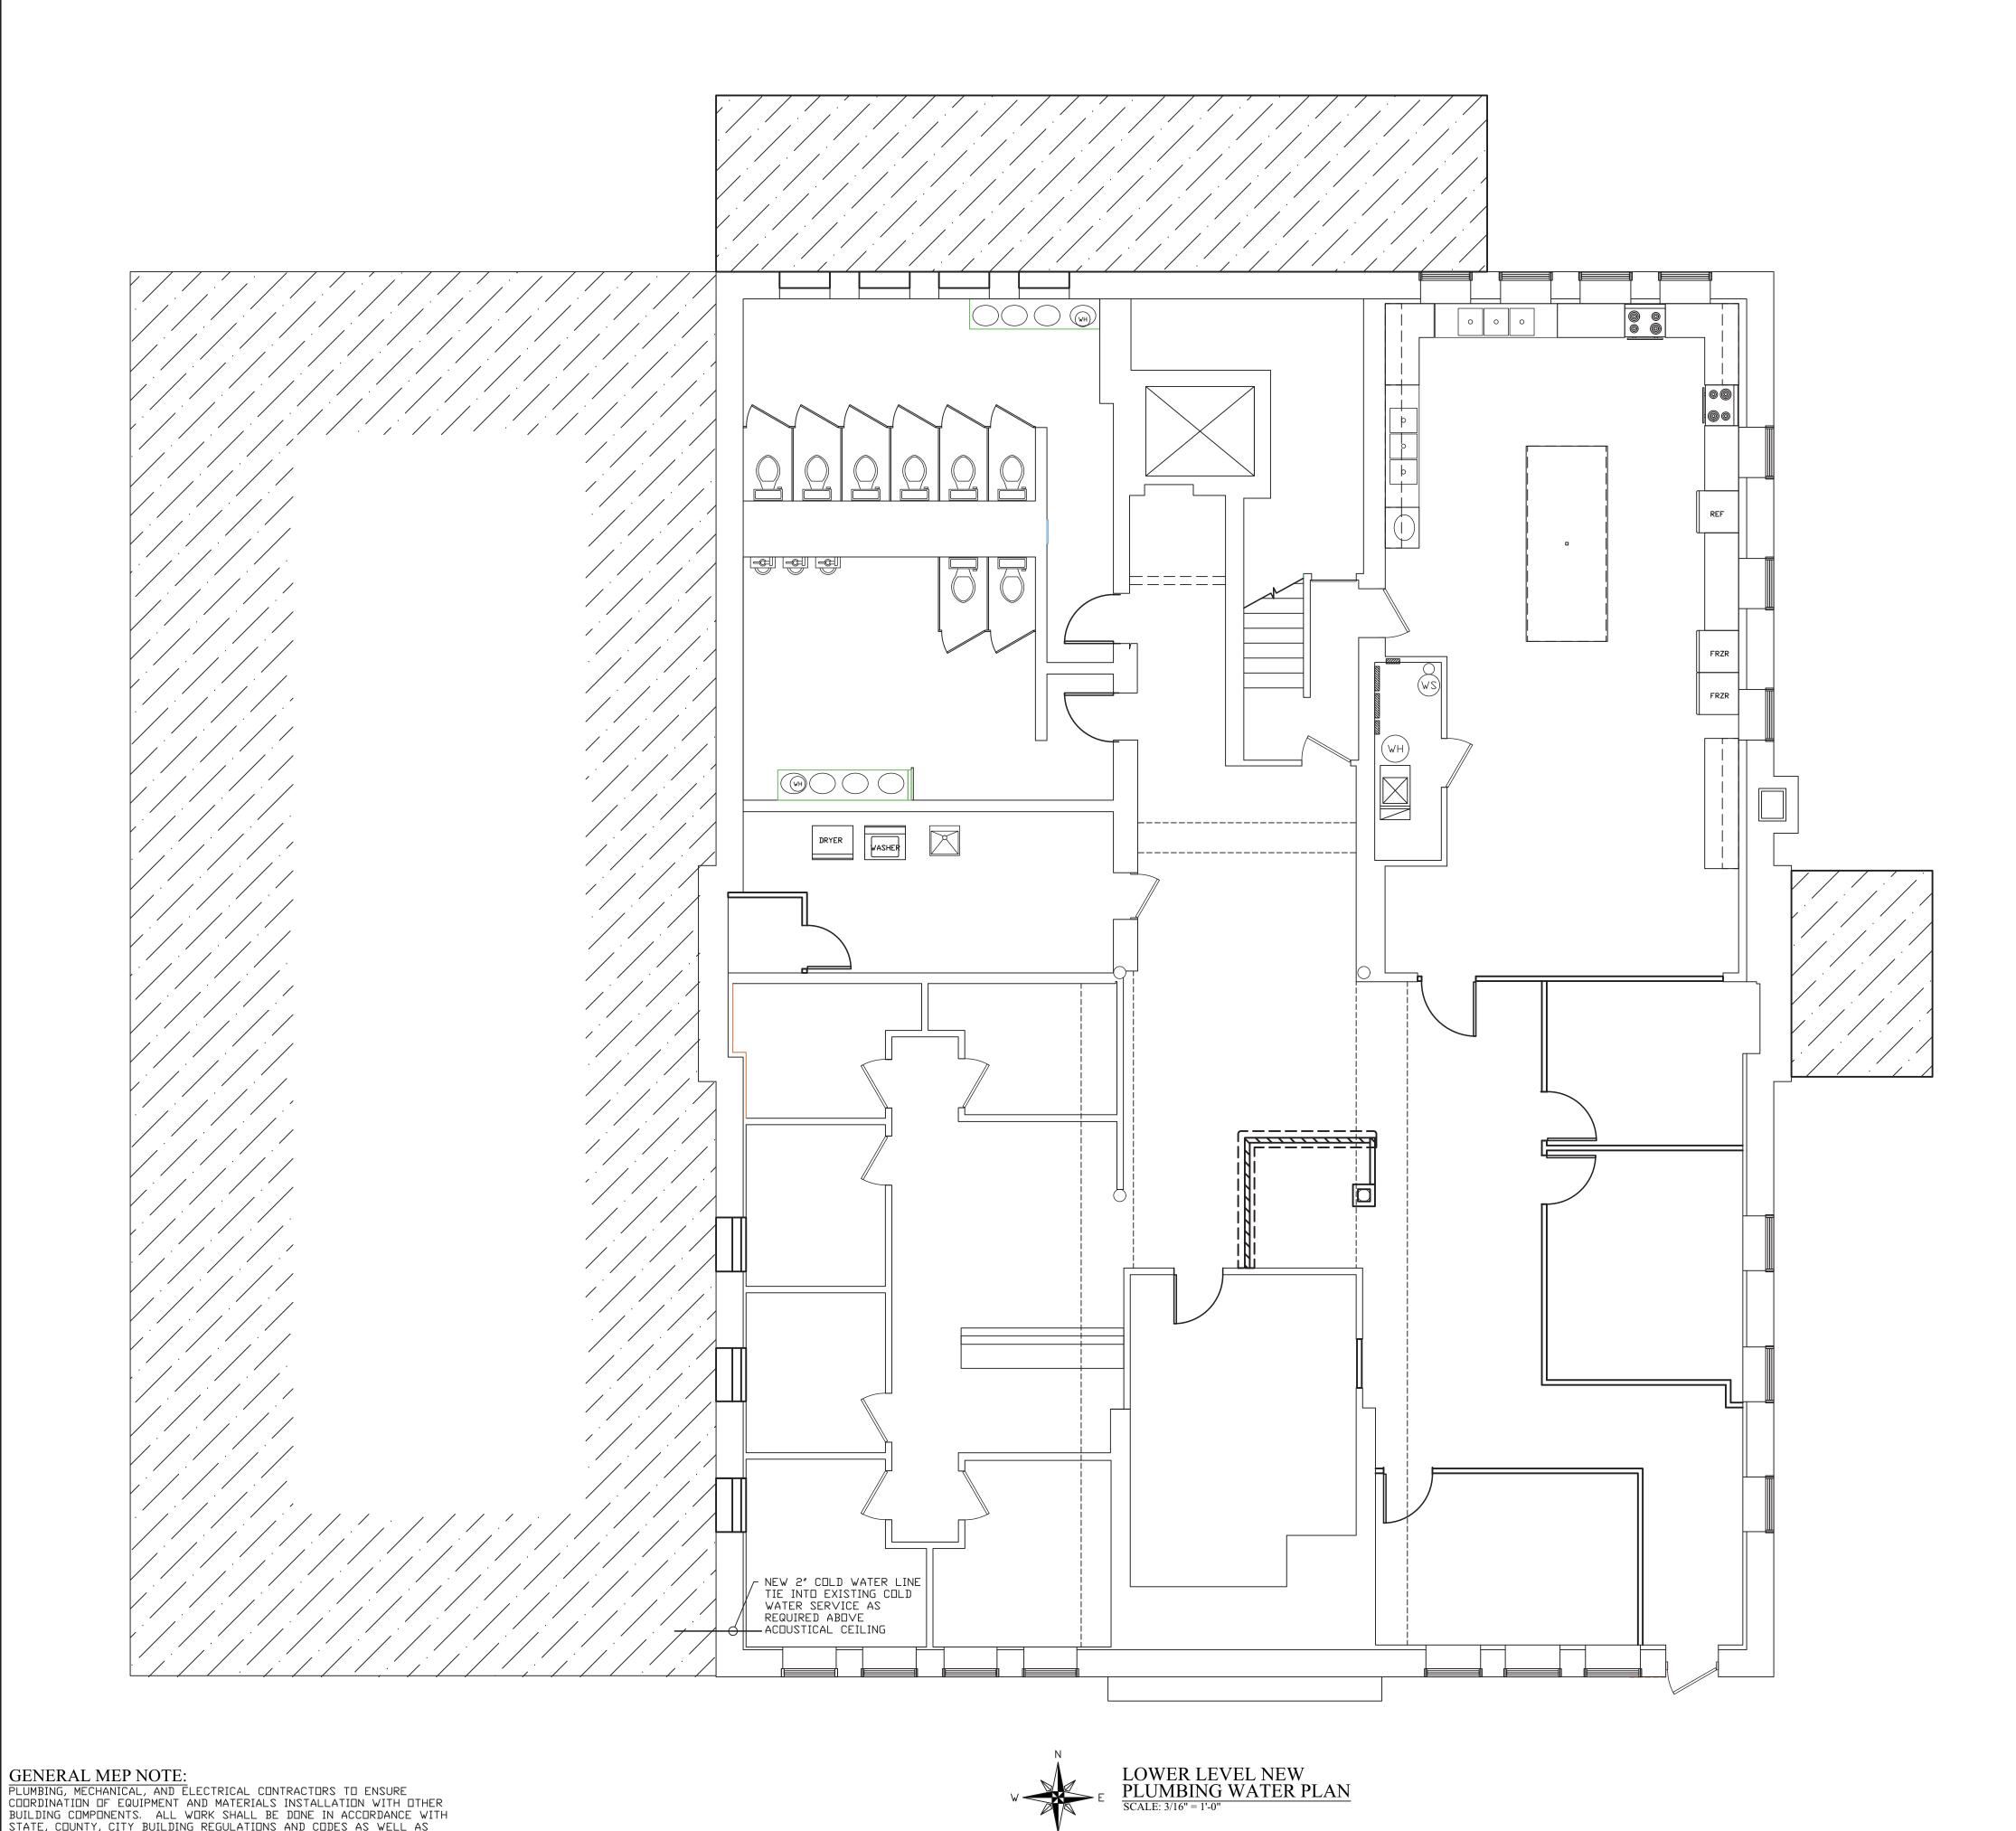--- SANITARY VENT LINE

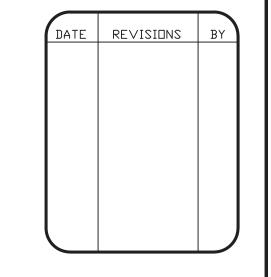— GAS — GAS LINE

GENERAL NOTES:


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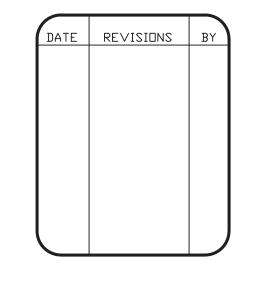
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WABASH VALLEY HEALTH CENTER, INC. 1436 LOCUST STREET
TERRE HAUTE, INDIANA 47807

ENGINEERING & CONSULTING, INC.

STRUCTURAL, PLUMBING, MECHANICAL, & ELECTRICAL DESIGN

TLDING

SYCAMORE BUILDING

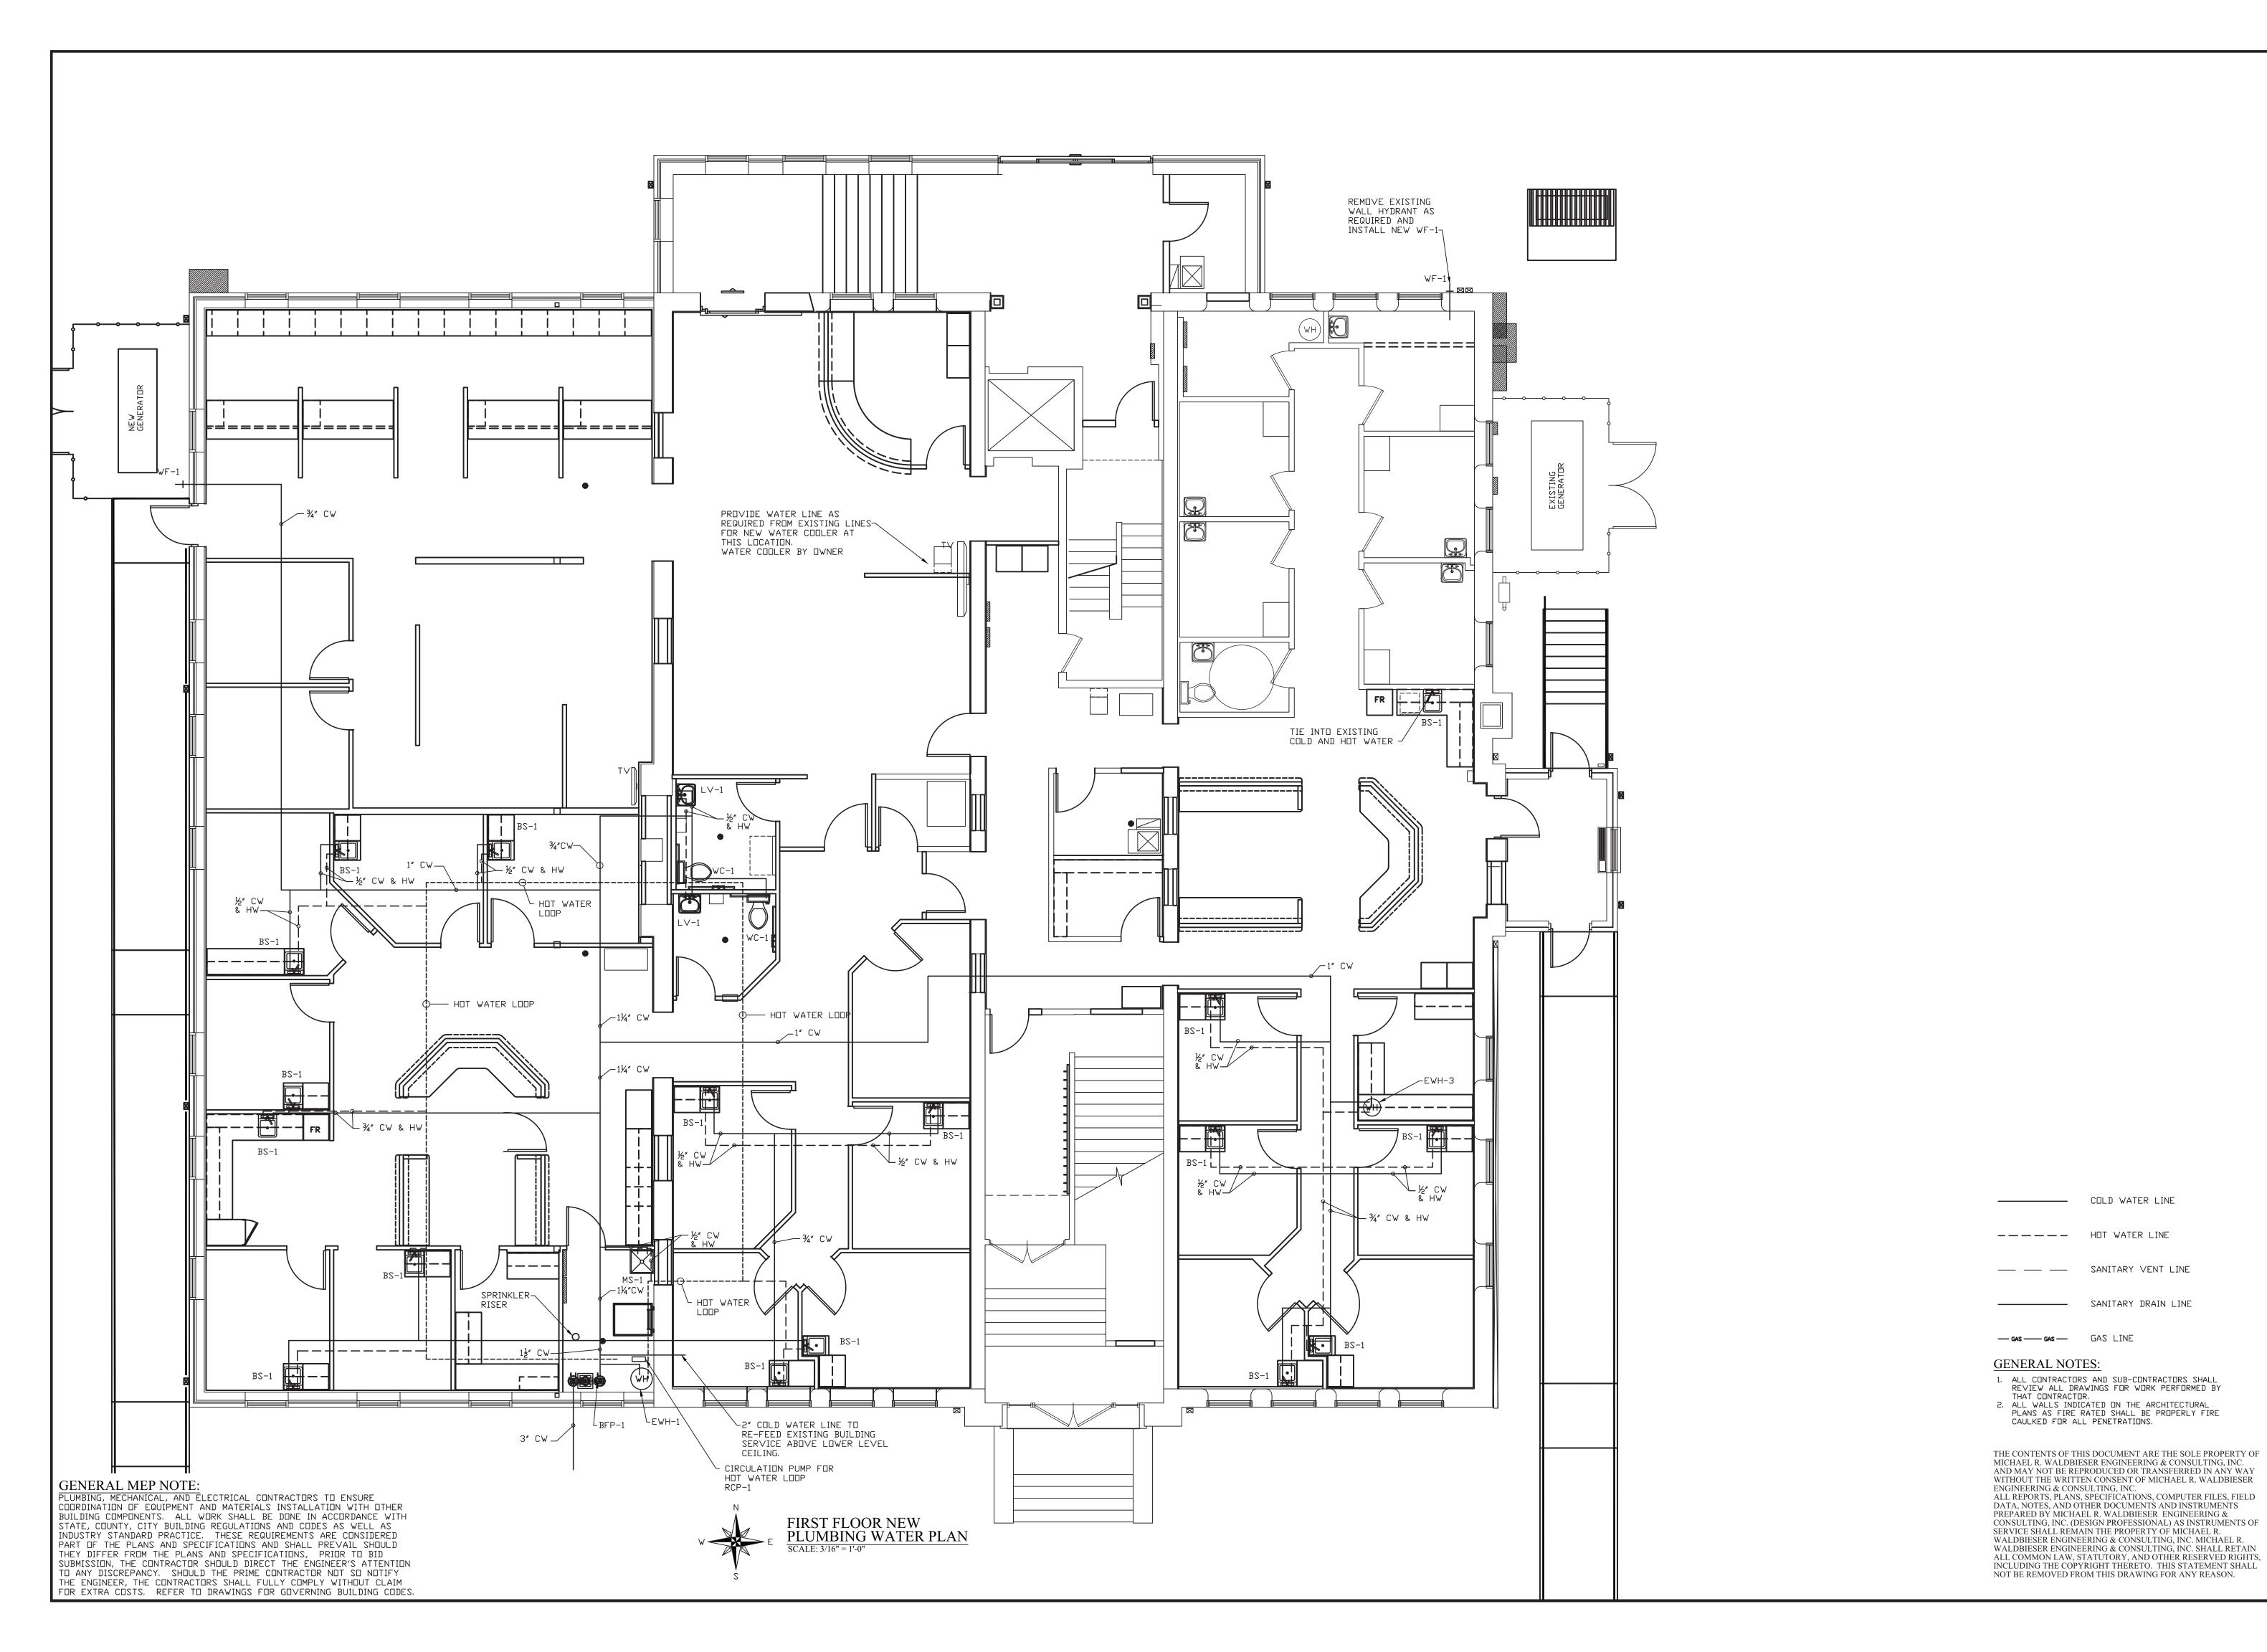SYCHORE BUILDING

SYCHORE BUILDING

19 SOUTH 6th STREET, SUITE 804

SCALE: 3/16" = 1'-0"


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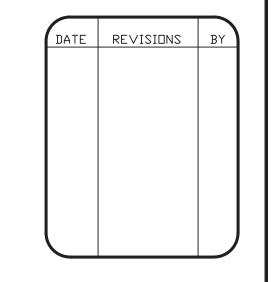
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APPROVED BY: MRW

PROJECT: 18-20 FILE: Plum #F

P2.4





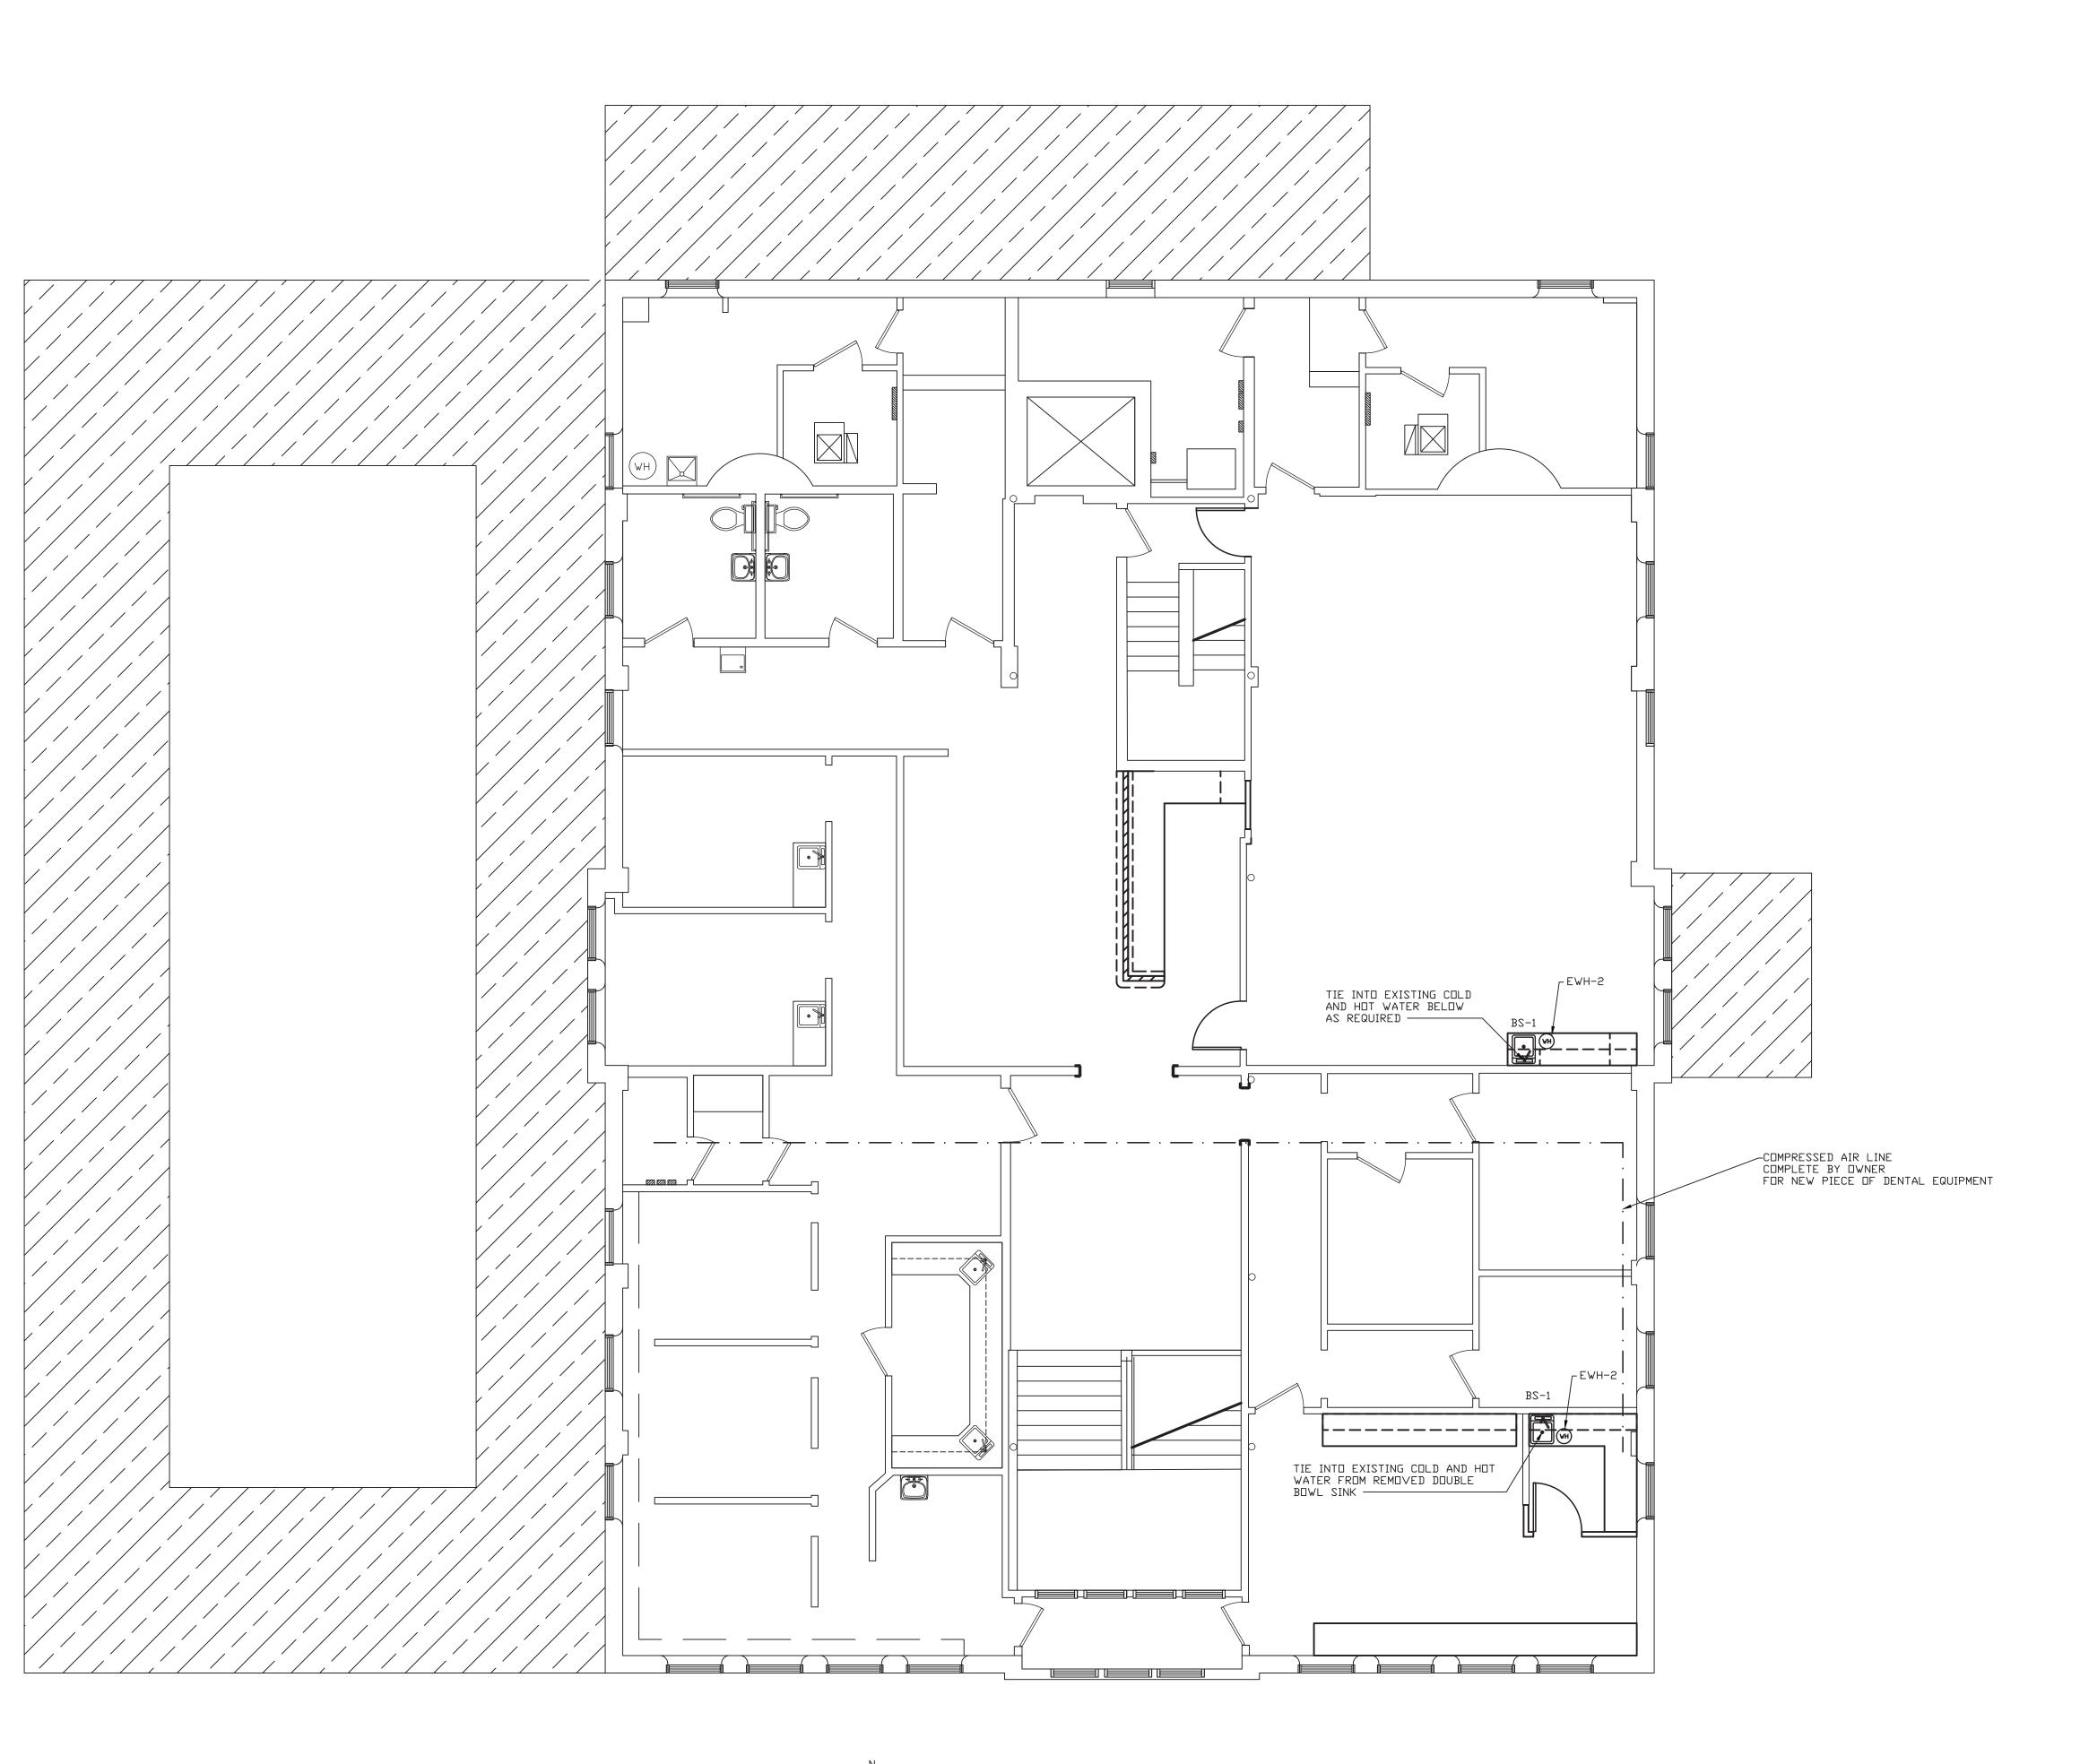

DATE:

— GAS — GAS LINE GENERAL NOTES:

---- HOT WATER LINE

--- SANITARY VENT LINE

—————— SANITARY DRAIN LINE

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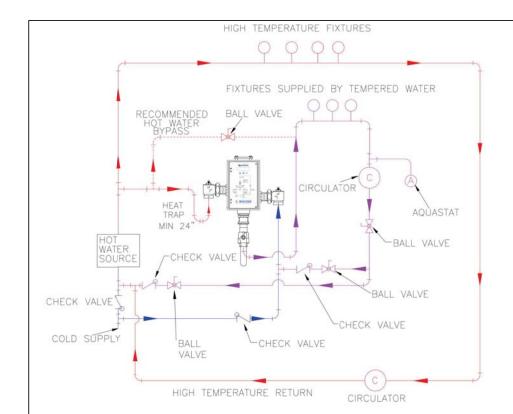
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	RP - RECIRCULATION PUMP SCHEDULE												
MARK	MFG.	MODEL	PRESSURE MAX. WORKING	NOZZL DISCHARGE	E SIZES SUCTION	POWER	VOLTAGE	OPTIONS					
RCP-1	GRUNDFOS	ALPHA2-15-55SF	150 psi	1 1/2"	1 1/2"	5 TO 45 WATTS	115 VOLT / 1 PHASE	1, 2, 3					


WATER PUMP OPTIONS:

- PROVIDE AND INSTALL DI-ELECTRIC UNIONS ON SUPPLY AND RETURN.
 PROVIDE AND INSTALL AQUASTAT FOR CONTROL OF HOT WATER DURING OPERATION. SET TO 115F.



MIXING VALVE PIPING DIAGRAM SCALE: NONE

- HIGH TEMPERATURE LINE WILL NOT BE USED.
 COMBINE THIS DETAIL WITH THE WATER HEATER AND RECALCULATING PUMP DETAIL ON THIS DRAWING.
 INSTALL BOILER DRAIN/HOSE BIBB TO DISCHARGE SIDE OF RECIRCULATION PUMP FOR BLEEDING THE AIR FROM THE RECIRCULATION LINE.

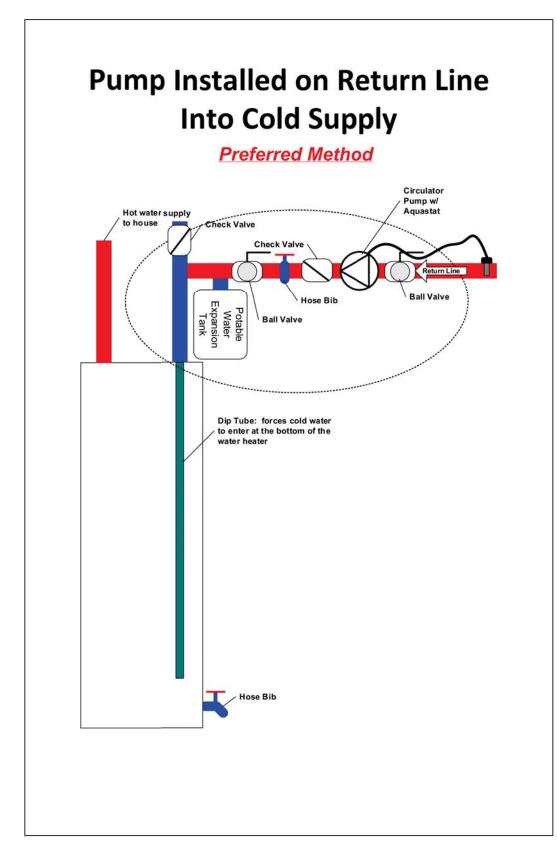

WATER HEATER PIPING DIAGRAM SCALE: NONE

— GAS — GAS LINE

ENGINEERING & CONSULTING, INC.

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MICHAEL R. WALDBIESER ENGINEERING & CONSULTING, INC.

WITHOUT THE WRITTEN CONSENT OF MICHAEL R. WALDBIESER

ALL REPORTS, PLANS, SPECIFICATIONS, COMPUTER FILES, FIELD

CONSULTING, INC. (DESIGN PROFESSIONAL) AS INSTRUMENTS OF

WALDBIESER ENGINEERING & CONSULTING, INC. MICHAEL R.

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GENERAL NOTES:



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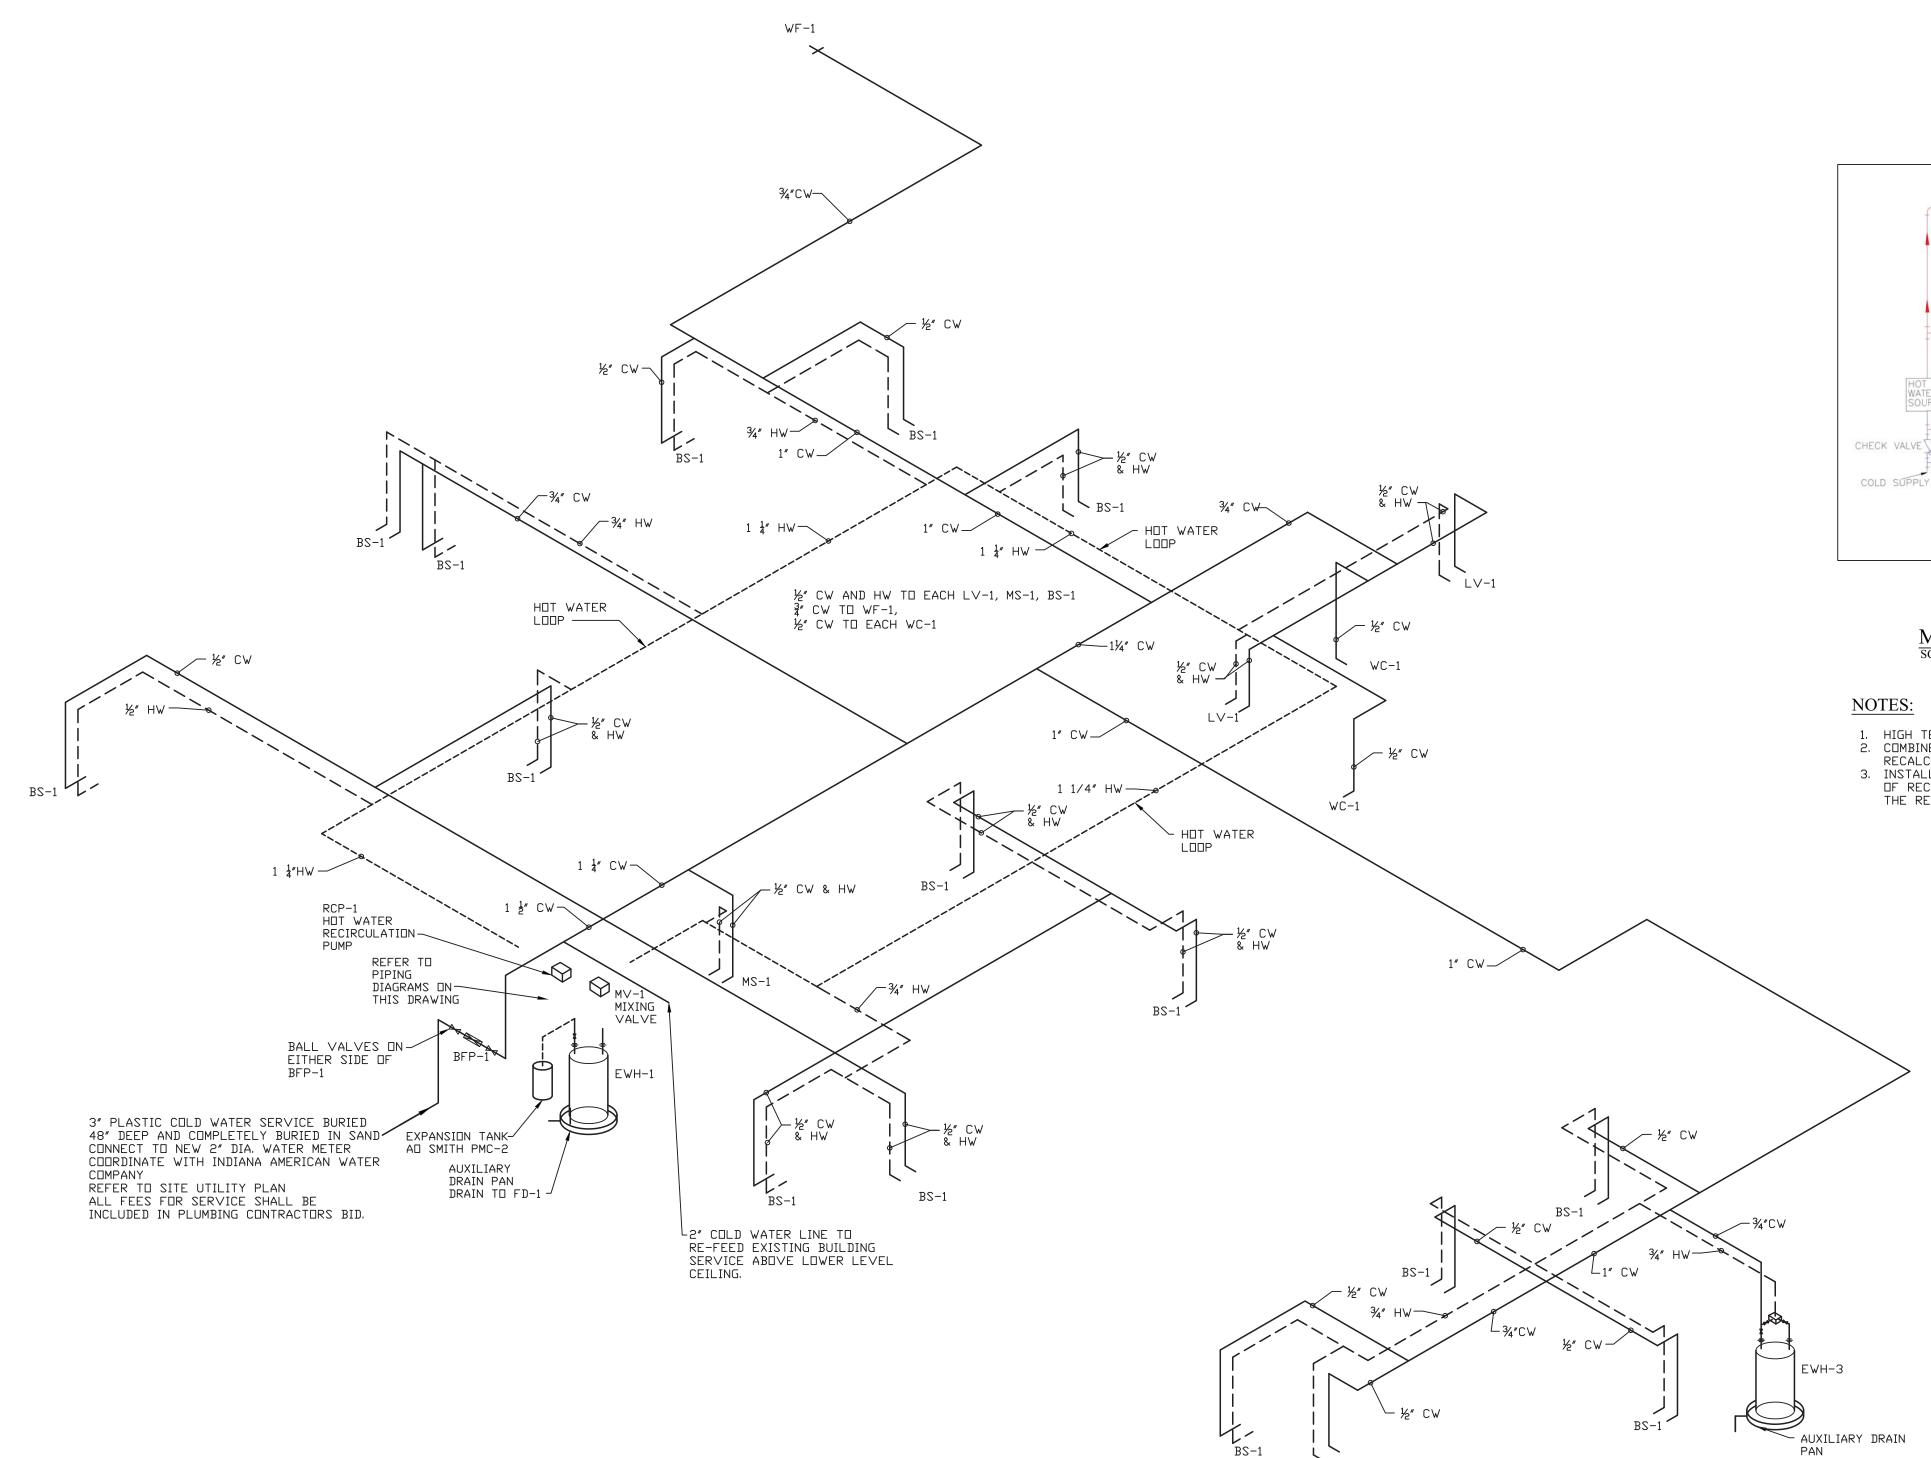
DATE REVISIONS

---- HOT WATER LINE --- SANITARY VENT LINE —— SANITARY DRAIN LINE 09-11-19 1. ALL CONTRACTORS AND SUB-CONTRACTORS SHALL REVIEW ALL DRAWINGS FOR WORK PERFORMED BY THAT CONTRACTOR.

DRAWN BY: DATE:

APPROVED BY:


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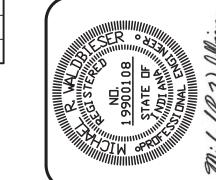
WATER SUPPLY PIPING ISOMETRIC

BS-1

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GAS PRESSURE REGULATOR SCHEDULE PRESSURE OUTLET NOTES 12" WATER COLUMN VERIFY DUTLET PRESSURE WITH MFG. 8" WATER COLUMN VERIFY DUTLET PRESSURE WITH MFG. 8" WATER COLUMN VERIFY DUTLET PRESSURE WITH MFG. 8″ WATER C□LUMN VERIFY DUTLET PRESSURE WITH MFG. 8" WATER COLUMN VERIFY DUTLET PRESSURE WITH MFG. VERIFY DUTLET PRESSURE WITH MFG. 8" WATER COLUMN 8″ WATER C□LUMN VERIFY DUTLET PRESSURE WITH MFG. 8" WATER COLUMN VERIFY DUTLET PRESSURE WITH MFG. 12" WATER COLUMN VERIFY DUTLET PRESSURE WITH MFG.



DATE REVISIONS

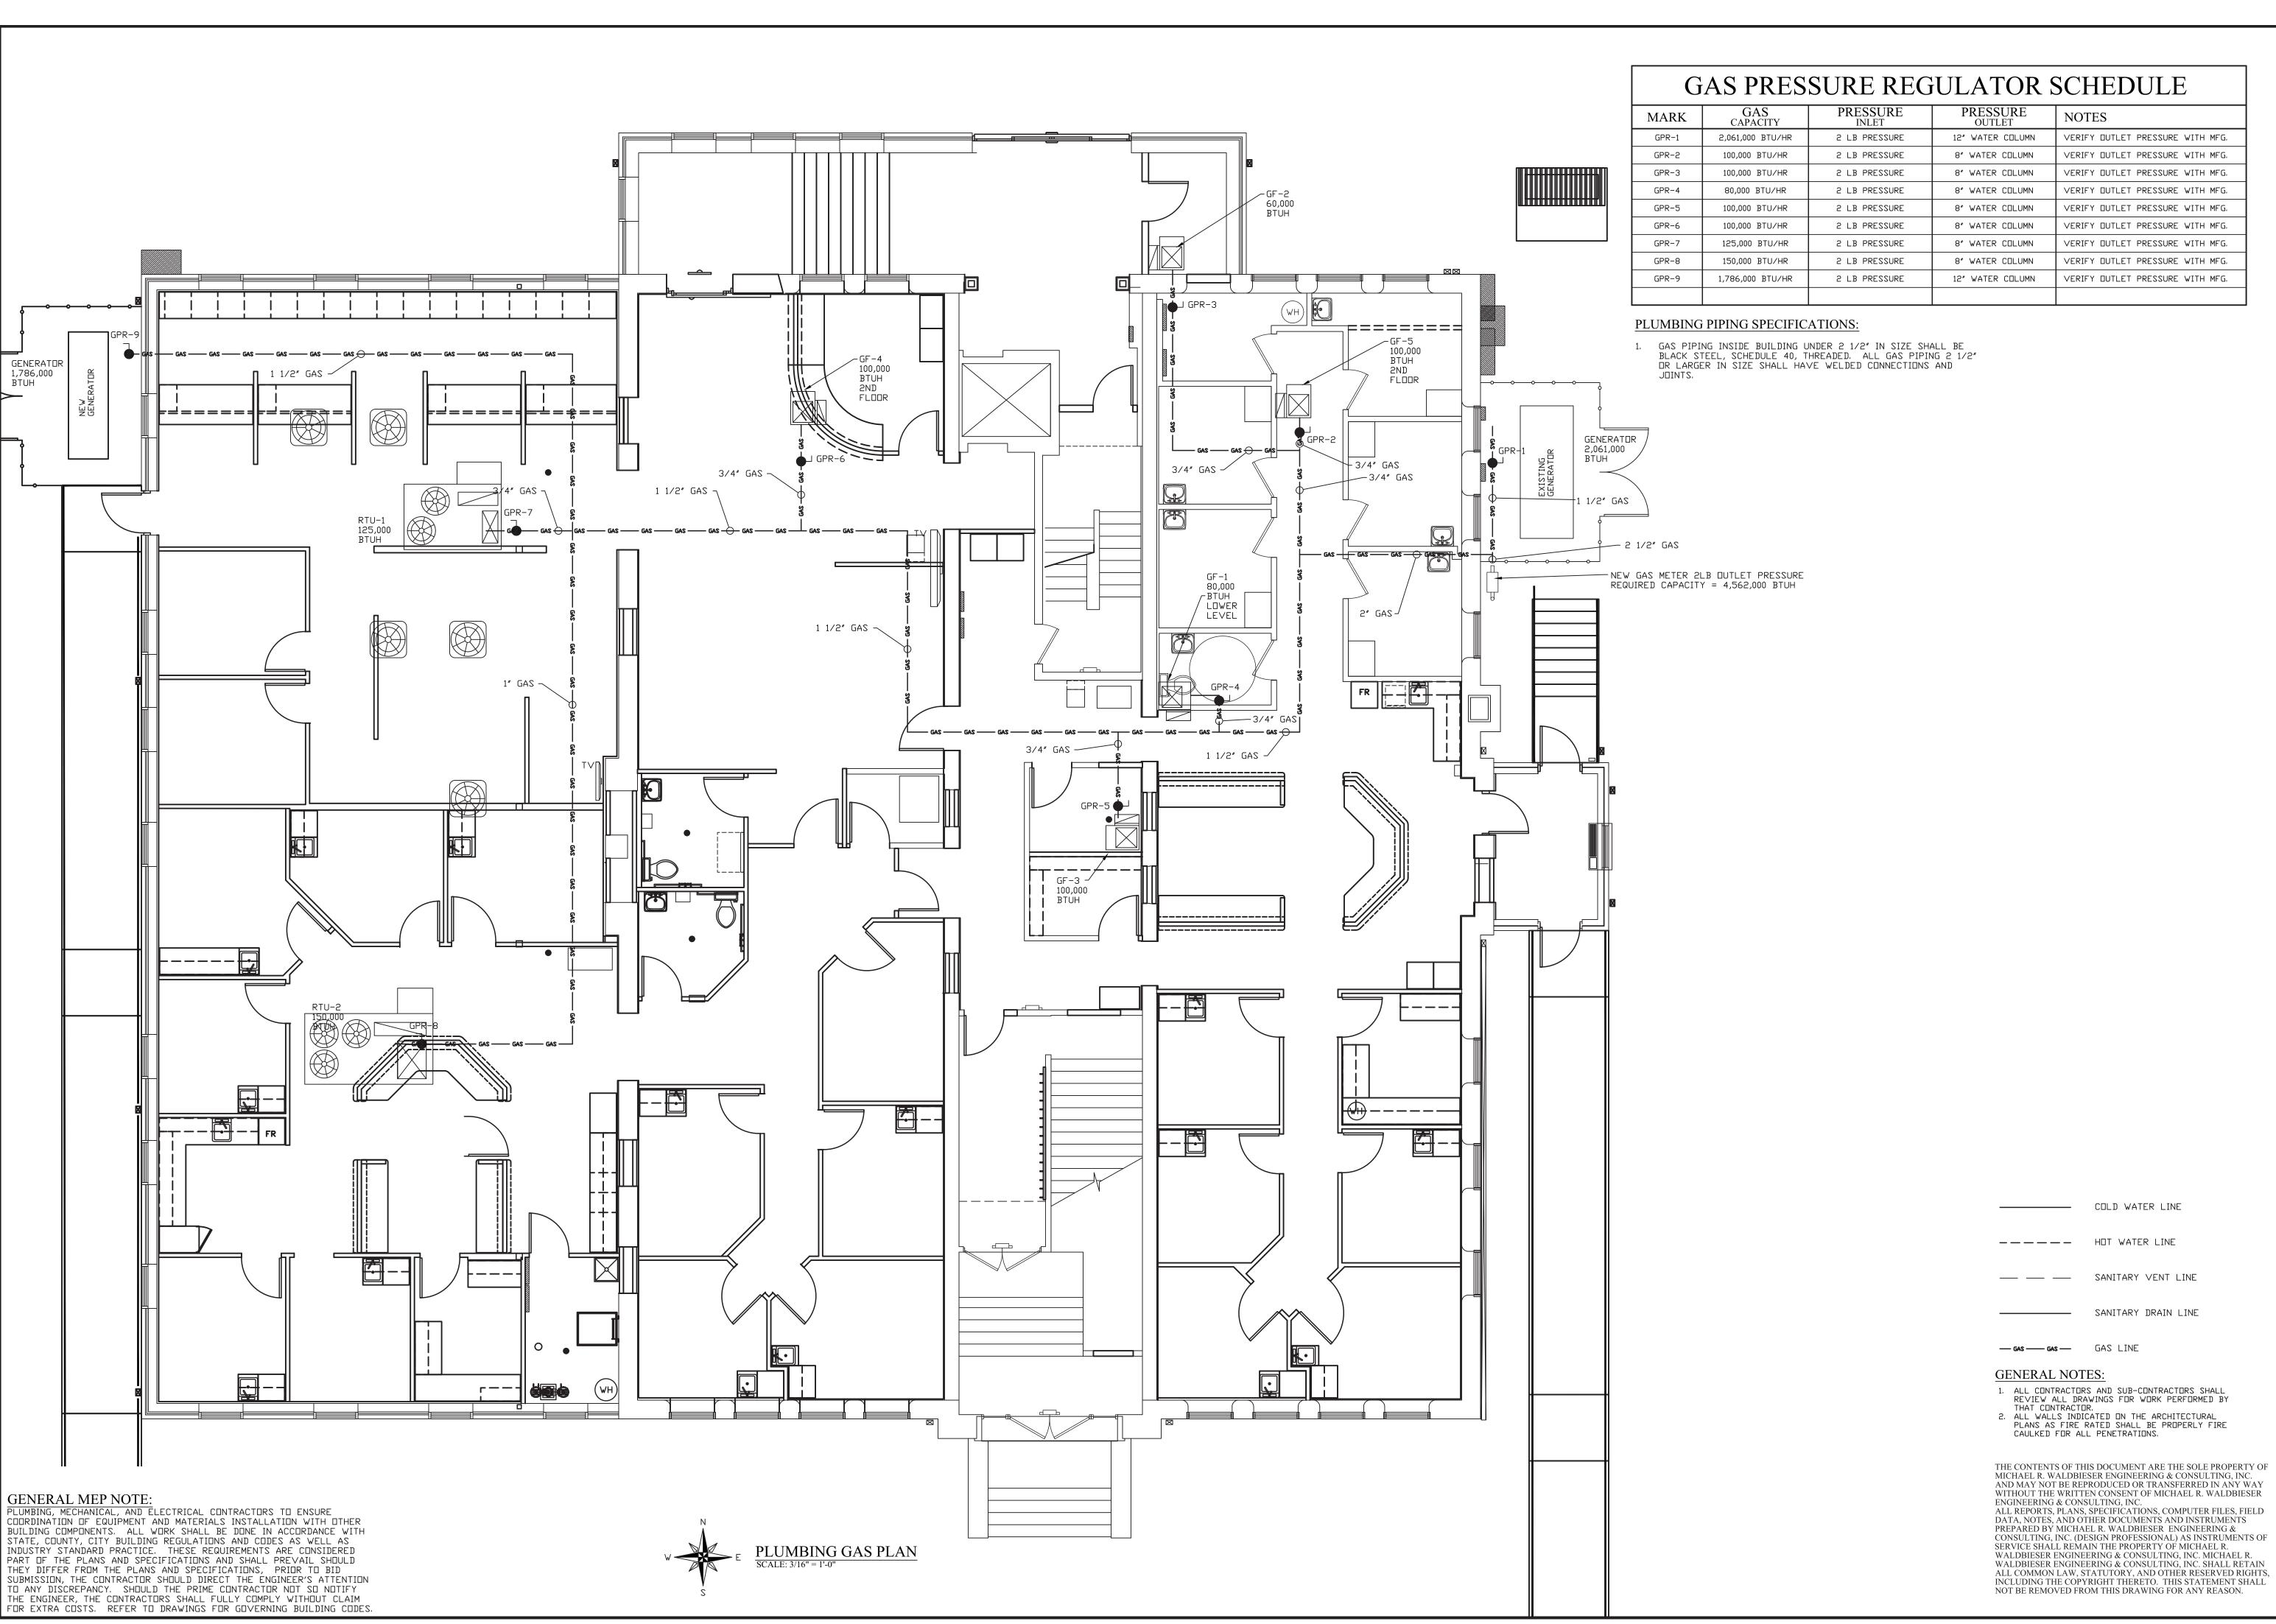
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PROVED BY: DATE:


——— SANITARY DRAIN LINE

THAT CONTRACTOR.

PROJECT: 18-20 FILE: Plum #F

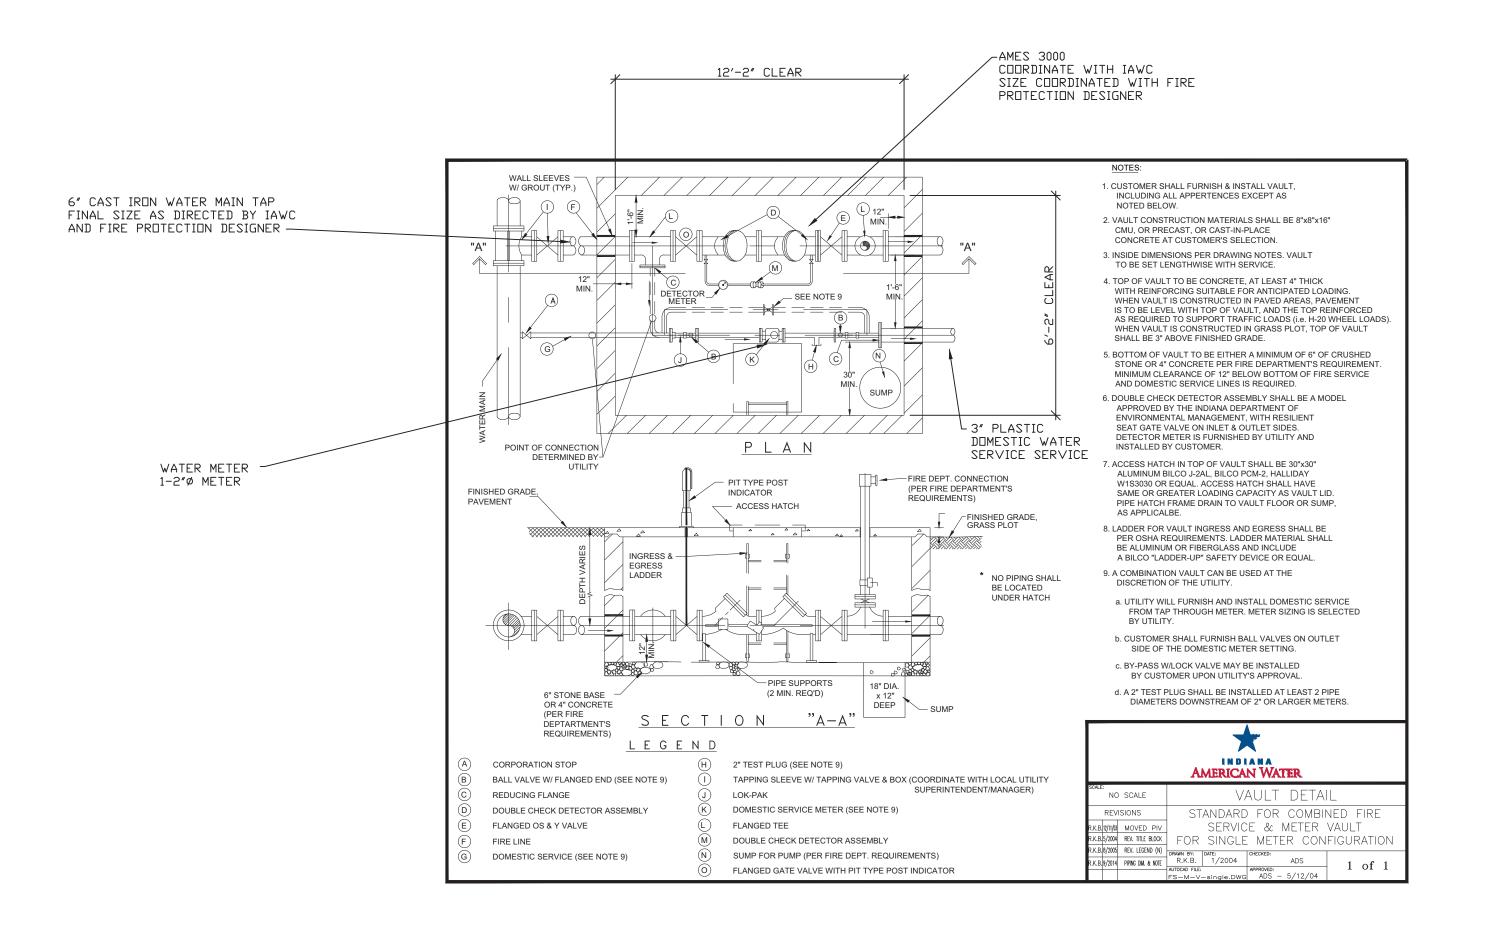

PRE-CAST CONCRETE VAULT INFORMATION

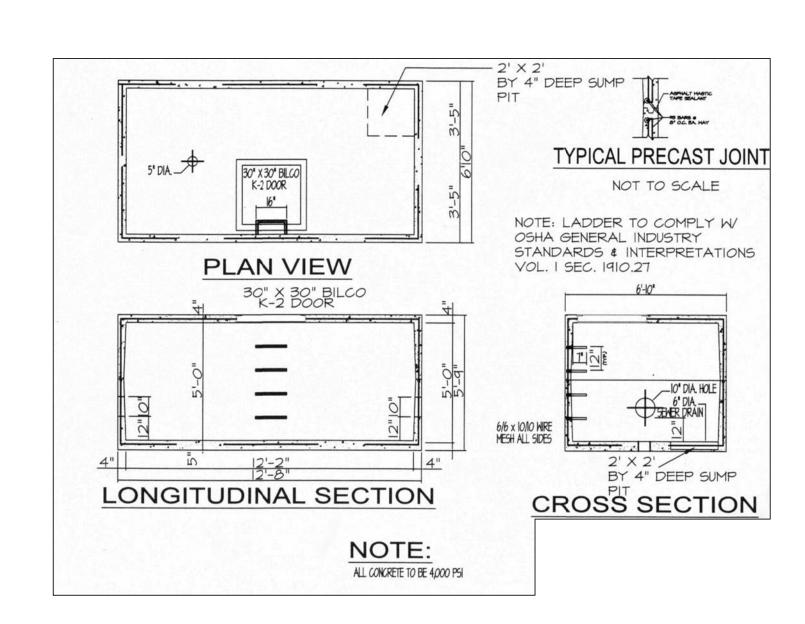

PRE-CAST CONCRETE VAULT INFORMATION

GOVERNING CODES

2014 INDIANA BUILDING CODE (IBC 2012 EDITION - WITH INDIANA AMENDMENTS) 2014 INDIANA FIRE CODE

(IFC 2012 EDITION - WITH INDIANA AMENDMENTS) 2012 INDIANA PLUMBING CODE

(IPC 2006 EDITION - WITH INDIANA AMENDMENTS) 2014 INDIANA MECHANICAL CODE (IMC 2012 EDITION - WITH INDIANA AMENDMENTS)

2010 INDIANA ENERGY CONSERVATION CODE (ANSI/ASHRAE 90.1 - 2007 EDITION - WITH INDIANA AMENDMENTS) 2009 INDIANA ELECTRICAL CODE

(NEC 2008 EDITION - WITH INDIANA AMENDMENTS)

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_____ COLD WATER LINE

--- SANITARY VENT LINE

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SANITARY DRAIN LINE

---- HOT WATER LINE

— GAS — GAS LINE

GENERAL NOTES:

THAT CONTRACTOR.

REVISIONS



WABASH VALLEY HEA 1436 LOCUST STREET TERRE HAUTE, INDIAN

DATE:

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			I		FITTINGS AND TRIM PLUMBING FIXTURE PIPE SIZE					т	
SYMBOL	LOCATION	MODEL	DESCRIPTION	FAUCET / FLUSH VALVE	FITTINGS AND TRIESTITINGS MODEL	M FITTING AND DESCRIPTION	WASTE	VENT	DCW	DHW	REMARKS
WC-1	RESTROOM	AMERICAN STANDARD #215AA.004	WATER CLOSET: CADET PRO RIGHT HEIGHT ELONGATED, 1.6 GPF, WHITE IN COLOR, ADA HANDICAPPED	N/A - TANK TYPE TOILET	AMERICAN STANDARD #5901.110	WHITE HEAVY DUTY ELONGATED SEAT WITH EVERCLEAN SURFACE	3″	2″	1/2"	N/A	WITH ANGLE STOP WITH SUPPLY LINE WITH FLANGE ON SUPPLY
LV-1	RESTROOM	AMERICAN STANDARD #0355.012	LAVATORY: LUCERNE WHITE WALL-HUNG	AMERICAN STANDARD COLONY PRO #7075.054 CHROME FAUCET METAL LEVER HANDLE LESS DRAIN, LESS POP-UP HOLE AND ROD	TRUEBRO LAV GUARD2	ADA COMPLIANT UNDERSINK WATER SUPPLY AND WASTE COVERS	1 1/4"	1 1/2"	1/2"	1/2"	RIM SET AT HANDICAPPED HEIGHT - I.E. RIM @ +34" A.F.F. WITH ANGLE STOPS WITH SUPPLY LINES WITH FLANGE ON SUPPLYS & WASTE WITH 1 1/4" CHROME PLATED P-TRAI WITH GRID DRAIN
BS-1	VARIES	ELKAY MFG. #LRAD151765	STAINLESS STEEL SINK: SIZE = 15" × 17 1/2" DEPTH 18 GAUGE TYPE 304 STAINLESS STEEL WITH LUSTROUS HIGHLIGHTED SATIN FINISH BOWL DEPTH = 6 1/2"	AMERICAN STANDARD #7500.170 MUNTERREY TWO-HANDLE CENTERSET POLISHED CHROME FAUCET WITH GOOSENECK SPOUT.	-	-	1 1/2"	1 1/2"	1/2"	1/2"	WITH ANGLE STOPS WITH SUPPLY LINES WITH FLANGE ON SUPPLYS & WASTE WITH 1 1/2" CHROME PLATED P-TRAF WITH BASKET STRAINER
BFP-1	VARIES	WILKINS #375AST-OSY-AG	BACKFLOW PREVENTER: REDUCED PRESSURE PRINCIPLE ASSEMBLY WITH AIR GAP ACCESSORY WITH STRAINER ON INCOMING SIDE	-	-	-	-	-	-	-	DRAIN AIR GAP TO FLOOR SINK COORDINATE ACCESSORIES WITH WATER PIPING MATERIAL AS REQUIRED.
WF-1	VARIES	WOODFORD #65	WALL FAUCET: BACKFLOW PROTECTED FREEZELESS WALL HYDRANT	-	-	-	-	-	3/4"	-	WITH INLET AND LENGTH AS REQUIRED FOR WALL THICKNESS WITH TEE KEY EXTERIOR OPTIONS: CHROME PLATED, POLISHED BRASS, OR ROUGH BRASS
C□-1	VARIES	ZURN EZC-PV	ADJUSTABLE FLOOR CLEANOUT: PVC BODY WITH ADJUSTABLE NICKEL BRONZE COVER	_	_	_	-	_	_	-	SAME SIZE AS DRAIN LINE
CD-2	VARIES	PVC	CLEANDUT: SCH 40 PVC ABDVE SUSPENDED CEILING.	-	-	-	-	_	-	-	SAME SIZE AS DRAIN LINE
FD-1	RESTROOM	ZURN #EZ1-P∨	ADJUSTABLE FLOOR DRAIN: PVC BODY WITH 5" DIA. ADJUSTABLE NICKEL BRONZE HEEL-PROOF GRATE	-	-	-	2"	-	-	-	-
FD-2	MECH. ROOM	PVC WITH 3" TO 2" PIPE REDUCER TOP	FLOOR DRAIN: SCH 40 PVC	-	-	-	2"	-	-	-	-
FS-1	MECH. ROOM	ZURN #FD-2370-P∨4-T	FLOOR DRAIN/SINK: 12"x12" PVC FLOOR SINK WITH 3/4" GRATE.	-	-	-	4"	-	-	-	-
MS-1	МЕСН. КООМ	MUSTEE #62M	MOP SERVICE BASIN: DURASTONE WHITE STRUCTURAL FIBERGLASS SIZE = 24" × 24" WITH 3" DRAIN SEAL BOWL DEPTH = 8 1/4"	AMERICAN STANDARD #8355.110 POLISHED CHROME FAUCET WITH CAST BRASS CONSTRUCTION WITH 3/4" HOSE THREAD END WITH VACUUM BREAKER WITH WALL BRACE WITH BUCKET HOOK	-	-	3"	1 1/2"	1/2"	1/2"	WITH HOSE & HOLDER WITH MOP HANGER WITH BUMPER GUARDS WITH DURAGUARD WALL GUARDS
MV-1	MECH. ROOM	LEONARD NUCLEUS #PNV-100-LF	DIGITALLY CONTROLLED MIXING VALVE	-	-	-	† -	_	_	_	3/4" INLET - 1" DUTLETS

PLUMBING FIXTURE NOTES:

- ALL ANGLE SUPPLIES SHALL BE BRASS CRAFT G2 SERIES 1/4 TURN CHROME PLATED BRASS ANGLE STOPS.
- ALL SUPPLY LINE SHALL BE BRASS CRAFT CHROME PLATED
- BRASS RISERS WITH CONNECTIONS AS REQUIRED. ALL SUPPLY AND WASTE LINES SHALL HAVE ONE PIECE CHROME
- PLATED FLANGES AT WALL LINES. 4. ALL P-TRAPS SHALL BE 17 GAUGE CHROME PLATED WITH
- CLEANDUTS IN BOTTOM OF TRAP. PROVIDE AND INSTALL 2" SURESEAL INLINE FLOOR DRAIN TRAP SEALER IN EACH FD-1 AND FD-2.

PLUMBING PIPING SPECIFICATIONS:

- SANITARY PIPING SHALL BE SDR35 PIPE MEETING ASTM-D3034.
- WASTE AND VENT PIPING SHALL BE SCH 40 PVC. WATER PIPING AS FOLLOWS:
- WATER PIPING IN THE BUILDING SHALL BE TYPE L HARD COPPER WITH LEAD FREE SOLDERED JOINTS AND INSULATED WITH 3/4" THICK ARMAFLEX INSULATION.
- ALTERNATE: TYPE L HARD COPPER WITH PRORESS FITTINGS. B. WATER PIPING UNDER THE CONCRETE SLAB SHALL BE
- PEX CROSS-LINKED POLYETHYLENE OF SIZE SHOWN ON THE C. WATER SERVICE PIPING SHALL BE 3" IPS SDR11 BLACK HDPE.

	WATER HEATER SCHEDULE												
MARK	MFG.	MODEL	ENERGY FACTOR	HEATING-ELECTRIC INPUT	GALLON CAPACITY	FIRST HR. RATING	VOLTAGE	MCA	OPTIONS				
EWH-1	A.D. SMITH	DRE-52-15	-	15,000	52	-	208 3 PHASE	41.6	1, 2, 3, 4				
EWH-2	HTIMZ .O.A	EJC-6	N/A	1,600	6	N/A	120	13.75	1, 3				
EWH-3	A.O. SMITH	EJC-5	N/A	2,500	19	N/A	120	20.83	1, 3				

WATER HEATER OPTIONS:

- PROVIDE PLASTIC AUXILIARY DRAIN PAN UNDER UNIT PROVIDE A.O. SMITH PMC-2 EXPANSION TANK
- PROVIDE DI-ELECTRIC UNIONS ON HOT AND COLD WATER LINES SET STORED WATER TEMPERATURE TO 140 DEGREES

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SECTION 15200 - PLUMBING SPECIFICATIONS

PART 1: GENERAL The General Conditions and other Contract Documents are hereby made a part of this Section to the same extent as if written out in full.

1.1 MANUFACTURER'S DESIGNATION

When manufacturers catalog numbers are given, they are for assistance to the bidder. In case of discrepancies in catalog numbers, the Contractor shall contact the Engineer of Record.

The Plumbing Contractor shall at all times throughout the construction period, maintain proper supervision of his employees, make orderly disposition of his materials, maintain high-class workmanship, systematically remove debris, cooperate fully with other contractors and subcontractors and avoid the creation of hazards to others on the

The plumbing Contractor shall make good any defect due to faulty material or workmanship; he shall correct any malfunction not due to misuse or abuse after date of acceptance, which develops in his work, for a period of one (1) year from date of acceptance. The date of final payment shall be recognized as the date of acceptance. 1.4 EQUIPMENT MARKING AND PAINTING

All marred or scratched equipment shall be touched up with same paint as that damaged. Steel and iron shall have grease, rust scale and dirt removed and left in a paintable condition. Painting will be done by General Contractor. 1.5 RULES, REGULATIONS AND PERMITS

All materials, workmanship, and installation shall conform to all local and state codes and federal O.S.H.A. standards. This Plumbing Contractor shall, at his own expense, furnish all necessary permits and fees required by the Local Ordinances and by the State of Indiana for construction and inspection of work installed by him. Refer to drawings for specific enforceable Building Codes. This includes all sanitary sewer tap fees and domestic water tap fees charged by local utilities.

The Plumbing Contractor shall furnish and install a temporary water service. A water outlet shall be provided at a location convenient for general use, and an outlet shall be provided on each floor of the building. The General Contractor will pay for the water used. 1.7 SYSTEM SCHEDULE

Systems shall include, but not be limited to:

Water Service and Supply System - connect as shown on the drawings Sanitary Sewer Piping - connect as shown on the drawings

Waste and Vent Piping Plumbing Fixtures - water closets, lavatories, faucets, floor drains, sinks, etc.

PART 2: MATERIALS AND METHODS

See drawings for model numbers and specifications.

The Plumbing Contractor shall use the accompanying drawings as his working drawings except that deviations may be made only where interferences may arise. Such deviations shall be called to the attention of the Engineer and prior approval obtained before making any installation. In no case shall codes, rules or regulations hereinbefore referred to be violated.

The Plumbing Contractor shall furnish "Shop Drawings" for all equipment supplied on this project. He shall obtain, ahead of job progress, all manufacturer's drawings, wiring diagrams, rough-in location drawings, operating instructions, etc., for each item of equipment furnished and set by him and connected to by other contractors. He shall see that the other contractors who connect to his equipment have the necessary drawings for rough-in and wiring diagrams ahead of their job progress. The Plumbing Contractor, shall also maintain a complete set of General, structural, electrical and mechanical drawings during the progress of the job. He shall also maintain a clean set of mechanical drawings for record purposes, upon which he shall mark, legibly, all deviations from the Contract Documents. This set shall be turned over to the Engineer at the termination of the job for an "As Built" set. 2.4 PIPE AND FITTINGS

All fittings shall be cast brass or wrought copper fittings.

All joints shall be made in accordance with instructions of the manufacturer of the fittings. Proper adapters and unions shall be used at connections to steel or iron pipe or equipment.

Fittings for gas piping inside the building shall be black, malleable, threaded. 2.5 WATER SUPPLY SYSTEM

System Description. The Plumbing Contractor shall install a complete system of cold water, hot water and hot water return as shown on the drawings. All fixtures shall have appropriate services connected. The complete system shall be pitched for drainage to low points and drain valves installed at each low point. All piping shall be run as high

Check valves shall be installed where necessary to prevent hot water from backing up into cold water All branches shall be valved at take-off from mains. Each branch to riser shall be provided with stop and waste.

All vertical pipe shall be supported where it passes through floors with an approved clamping device. All risers shall be securely fastened to floors and wall studs with any change from vertical supported by brackets or hangers in it's new position.

All piping shall be run true and straight and at right angles or parallel to walls. In all cases the exposed pipe must be run straight and plumb and in no case to be farther from walls and ceilings than is absolutely necessary.

All exposed connections to fixtures shall be chrome plated brass Wherever an exposed pipe passes through finished walls or ceilings it shall be provided with a chrome plated solid ring escutcheon. If pipe is covered, escutcheon shall fit over insulation.

Connections to fixtures shall be made with unions so that a fixture may be easily removed and reset without making new joints. Provide and install easily accessible stops for all fixtures.

All pipe shall be thoroughly cleaned of grease, oil and foreign material before installation All cuts and threads shall be thoroughly cleaned and reamed to remove shoulders and burrs before installation.

Wherever piping materials change from copper to a dissimilar metal, a dielectric union shall be installed.

System Description. The Plumbing Contractor shall install a complete and continuous system of soil, waste and vent piping as shown on the drawings. All openings for connections must be closed with screw plugs or other means until used, all hand holes must be closed at once, and the pipe must be kept clean. Any earth or foreign matter that gets into the pipes must be removed by the contractor. Vent pipes shall extend at least 12" above the roof and extensions through the roof shall not be smaller that 3" in accordance with state code. Vents in outside walls are to be offset at least 12" inside of the wall before extending through the roof. Vents shall be offset in attic as indicated on the drawings before going through the roof to provide a minimum separation of 10'-0 from outside air intakes of furnaces.

All horizontal waste and vent lines, branches, drains, etc., shall pitch at 1/8" per foot unless otherwise noted on the drawings. Waste lines shall pitch downward in the direction of flow. Vent lines shall pitch upward in the direction of venting.

All junctions and changes in direction shall be made by the appropriate use of 45 degree Wyes, half Wyes, long sweep quarter bends, sixth eighth, sixteenth bends, combination Wye and eight bends, except that single and double Sanitary Tees may be used on vertical stacks and short quarter bends may be used where the change in direction of flow is from horizontal to vertical. Tees and crosses may be used in vent piping only All vertical stacks (waste and vent) shall be supported wherever they pass through floors with an approved clamping device

All piping shall be run true and straight and at right angles or parallel to walls. Cleanouts shall be full size of the pipe up to 4" in diameter and not less than 4" for larger size pipe

In all cases the exposed pipe must be run straight and plumb and in no case to be farther from walls and ceilings than is absolutely necessary. Each and every fixture included in the contract must have a separate trap, except where noted otherwise on the drawings.

Floor level cleanouts shall be set with cleanout rim and plug face absolutely flush with the finished floor or they shall be chiseled out and reset at this Contractors expense. Floor and Area Drains. The Plumbing Contractor shall furnish and install floor and area drains complete with traps and cleanouts as specifi 2.7 GAS PIPING SYSTEM

System Description. The Plumbing Contractor shall furnish and install a complete system of gas distribution as shown on the drawings. The installation shall be included as a part of this Contract and shall be installed per the Codes. Dielectric unions shall be installed between the gas meter the piping in the building. Piping inside the building shall be run true and straight and shall be pitched to dirt pockets where required. The Plumbing Contractor shall make final connections to all equipment requiring gas service as shown on the drawings.

All piping inside the building shall have screwed joints except that all gas piping 2 1/2" or larger shall have welded joints. Pipe shall be reamed to remove shoulders and burrs and all threads and the pipe cleaned before erection. General. The Plumbing Contractor shall furnish all labor and material necessary to perform the following tests. Tests may be performed in sections of the Systems as they

are installed so as not to hold up construction. The Engineer shall be notified whenever such tests are to be made and shall witness all tests. Water Supply System. The Water Supply System shall be filled with water and subjected to a pressure of at least 150 PSIG per section under test. Pressure shall be obtained by use of an air compressor. Pressure shall hold for a period of one (1) hour without any additional pressure being applied. Soil and Waste System. The Soil, Waste and Vent System shall be subjected to a hydrostatic test by plugging or closing all holes in portion of the system under test and filling with water to a point twelve (12) feet higher than the highest pipe under test. Water level shall hold for a minimum of 24 hours without change in the water level with no additional water being applied. The Engineer may elect to shorten the test period due to freezing weather conditions. It shall be his prerogative. Gas Piping System. The Gas Piping system shall be subjected to an air pressure test of at least 150 PSIG and shall hold pressure for a period of 24 hours without any additional pressure being applied. Pressure shall be obtained from an air compressor. Each joint shall be soap tested to test for leaks.

PART 3: EXECUTION

The contractor must lay out the various pipe lines, as shown on the drawings, and carefully go over the work in the building and report to the Michael R. Waldbieser Engineering & Consulting, Inc. any obstacles that may be in the way to prevent proper run of pipes or interfere with the layout of the system in any way. All pipes included in the plumbing system must be run in such a manner as to not interfere with HVAC ductwork or electrical outlets All work on this project must be complete of all parts and supplies and hook-ups to make a complete operating job when the project is finished. All equipment shall be provided and installed in strict accordance with the manufacturer's installation instructions.

Compaction of soil shall be as stated in the General Written Specifications for all trenching. All trenching required for installation of products specified in this section of work shall be done by the Plumbing Contractor. Backfilling after trenching shall be done in accordance with the General Written Specifications by the Plumbing Contractor. After backfilling, the Plumbing Contractor shall finish grade the area disturbed by the trenching to match that of the site prior to trenching.

END OF SECTION

PERMIT & FEE NOTE:

PLUMBING CONTRACTOR SHALL INCLUDE IN HIS BASE BID ALL COSTS ASSOCIATED WITH OBTAINING DOMESTIC WATER SERVICE, SANITARY SEWER SERVICE AND GAS SERVICE. THIS SHALL INCLUDE ALL TAP FEES AND

GOVERNING CODES

2014 INDIANA BUILDING CODE

(IBC 2012 EDITION - WITH INDIANA AMENDMENTS)

2014 INDIANA FIRE CODE

(IFC 2012 EDITION - WITH INDIANA AMENDMENTS) 2012 INDIANA PLUMBING CODE

(IPC 2006 EDITION - WITH INDIANA AMENDMENTS)

2014 INDIANA MECHANICAL CODE (IMC 2012 EDITION - WITH INDIANA AMENDMENTS)

2010 INDIANA ENERGY CONSERVATION CODE

(ANSI/ASHRAE 90.1 - 2007 EDITION - WITH INDIANA AMENDMENTS)

2009 INDIANA ELECTRICAL CODE

(NEC 2008 EDITION - WITH INDIANA AMENDMENTS)

----- COLD WATER LINE ---- HOT WATER LINE

---- SANITARY VENT LINE

— GAS — GAS LINE

GENERAL NOTES:

1. ALL CONTRACTORS AND SUB-CONTRACTORS SHALL REVIEW ALL DRAWINGS FOR WORK PERFORMED BY THAT CONTRACTOR.

2. ALL WALLS INDICATED ON THE ARCHITECTURAL PLANS AS FIRE RATED SHALL BE PROPERLY FIRE CAULKED FOR ALL PENETRATIONS.

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REVISIONS



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