

PLUMBING, MECHANICAL, AND ELECTRICAL CONTRACTORS TO ENSURE

COORDINATION OF EQUIPMENT AND MATERIALS INSTALLATION WITH OTHER

STATE, COUNTY, CITY BUILDING REGULATIONS AND CODES AS WELL AS

INDUSTRY STANDARD PRACTICE. THESE REQUIREMENTS ARE CONSIDERED

PART OF THE PLANS AND SPECIFICATIONS AND SHALL PREVAIL SHOULD

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TO ANY DISCREPANCY. SHOULD THE PRIME CONTRACTOR NOT SO NOTIFY

THE ENGINEER, THE CONTRACTORS SHALL FULLY COMPLY WITHOUT CLAIM FOR EXTRA COSTS. REFER TO DRAWINGS FOR GOVERNING BUILDING CODES.

THEY DIFFER FROM THE PLANS AND SPECIFICATIONS, PRIOR TO BID

BUILDING COMPONENTS. ALL WORK SHALL BE DONE IN ACCORDANCE WITH

SYMBOL LEGEND

EXO

EXO

DEMO EXISTING RECEPTACLE DEMO EXISTING LIGHT D# D# D# D# D₩D DEMU FXISI FIXTURE COMPLETE DEMO EXISTING LIGHT DEMO EXISTING LIGHT D \$ D \$ FIXTURE COMPLETE SWITCH COMPLETE DEMO EXISTING LIGHT EXISTING RECEPTACLE EX∰ EX∯ EX∯EX∰ FIXTURE COMPLETE DEMO EXISTING LIGHT DО EX \$ EX \$ EXISTING LIGHT FIXTURE COMPLETE SWITCH REMAINS DEMO EXISTING EMERGENCY FIXTURE COMPLETE EXISTING LIGHT FIXTURE REMAINS

NUMBERED NOTES:

DISCONNECT POWER TO EXISTING GAS FURNACE. RE-CONNECT TO NEW GAS FURNACE AFTER INSTALLATION BY M.C.

EXISTING LIGHT

FIXTURE REMAINS EXISTING LIGHT

FIXTURE REMAINS EXISTING LIGHT

FIXTURE REMAINS EXISTING EMERGENCY

FIXTURE REMAINS

EXISTING PANEL "A" 200 AMP MLD 120 / 240 VOLT 40 CIRCUIT EXISTING BREAKERS 1 - 50 AMP 2P EXISTING A/C TO BE REMOVED COMPLETE 3 - 20 AMP 2P UNKNOWN 1 - 30 AMP 2P ELECTRIC HEATER NORTH ENTRANCE 1 - 30 AMP 2P WATER HEATER 4 - 30 AMP 2P FOR SNOW MELT - EAST STEPS & NORTH ENTRY TO BE REMOVED COMPLETE 1 - 20 AMP 2P FOR SNOW MELT - EAST STEPS & NORTH ENTRY TO BE REMOVED COMPLETE 1 - 20 AMP 1P FOR SNOW MELET - EAST STEPS & NORTH ENTRY TO BE REMOVED COMPLETE REMAINDER ARE 20 AMP 1P EXISTING VARIOUS

(3) EXISTING PANEL "B" 200 AMP MLD 120 / 240 VOLT 40 CIRCUIT EXISTING BREAKERS 1 - 90 AMP 2P EXISTING SUB PANEL "C" 1 - 20 AMP 2P HEATER AT MAIN ENTRANCE WEST TO BE REMOVED COMPLETE 2 - 50 AMP 2P EXISTING ELECTRIC OVENS IN KITCHEN 1 - 100 AMP 2P EXISTING SUB PANEL "B1" 30 - 20 AMP 1P EXISTING VARIOUS

(4) EXISTING PANEL "B1" 100 AMP MLO 120 / 240 VOLT 12 CIRCUIT EXISTING BREAKERS 1 - 30 AMP 2P EXISTING DRYER 6 - 20 AMP 1P EXISTING VARIOUS FED FROM PANEL "B"

EXISTING PANEL "C" 100 AMP MLO 120 / 240 VOLT 6 CIRCUIT 3 - 20 AMP 2P EXISTING BREAKERS FED FROM PANEL "B"

EXISTING PANEL "S" SNOW MELT PANEL 100 AMP MLO 120 / 240 VOLT 4 - 30 AMP 2P EXISTING 1 - 20 AMP 2P EXISTING 1 - 20 AMP 1P EXISTING CONTROLS

FED FROM EXISTING PANEL "A" TO BE REMOVED COMPLETE INCLUDING FEEDS FROM

REMOVE EXISTING WALL MOUNTED OCCUPANCY SENSOR.

DISCONNECT EXISTING EXHAUST FAN RE-CONNECT AFTER INSTALLED IN NEW CEILING

REFER TO SITE UTILITY DRAWING AND SITE LIGHTING DRAWING FOR ADDITIONAL WORK BY THE ELECTRICAL CONTRACTOR. ALSO REFER TO ARCHITECTURAL ELEVATIONS.

CONSTRUCTION PHASING NOTE

REFER TO CONSTRUCTION PHASING DRAWINGS #PH1, #PH2, AND #PH3 FOR THE CONSTRUCTION SEQUENCE OF THE PROJECT.

GOVERNING CODES

2014 INDIANA BUILDING CODE (IBC 2012 EDITION - WITH INDIANA AMENDMENTS) 2014 INDIANA FIRE CODE (IFC 2012 EDITION - WITH INDIANA AMENDMENTS) 2012 INDIANA PLUMBING CODE (IPC 2006 EDITION - WITH INDIANA AMENDMENTS) 2014 INDIANA MECHANICAL CODE (IMC 2012 EDITION - WITH INDIANA AMENDMENTS)

2010 INDIANA ENERGY CONSERVATION CODE (ANSI/ASHRAE 90.1 - 2007 EDITION - WITH INDIANA AMENDMENTS) 2009 INDIANA ELECTRICAL CODE

(NEC 2008 EDITION - WITH INDIANA AMENDMENTS)

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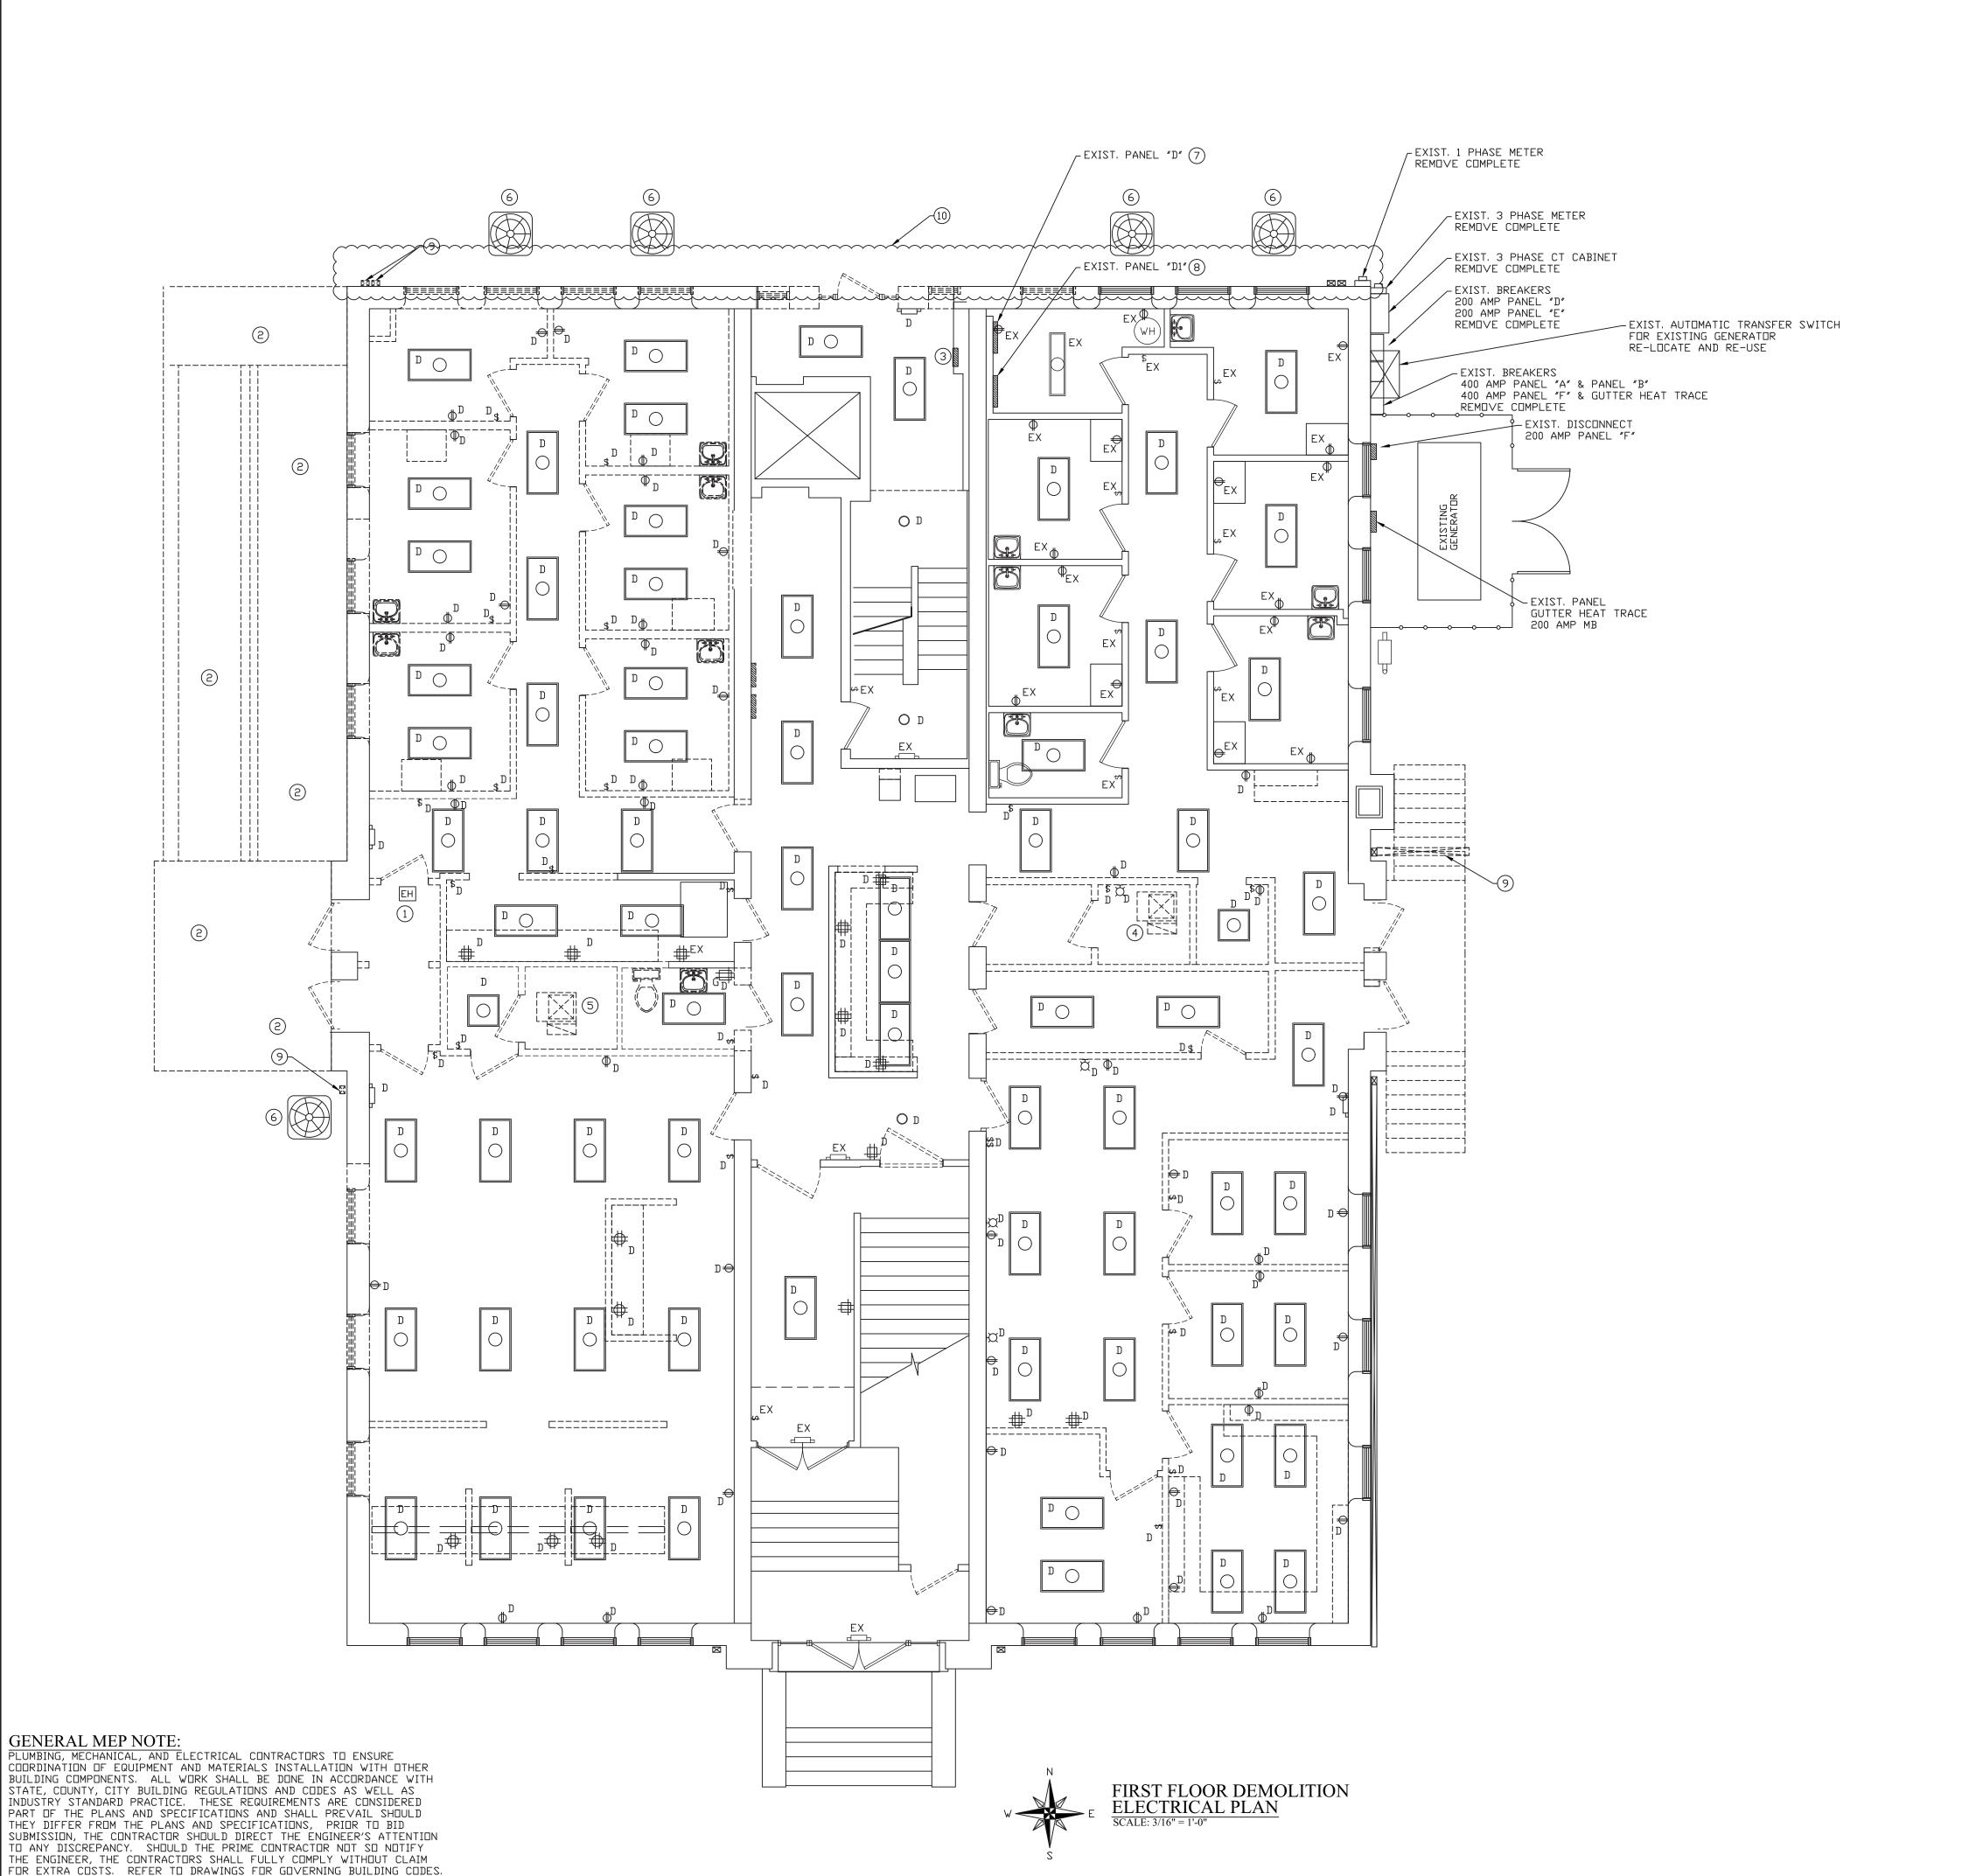
REVISIONS



WABASH VALLEY HEA 1436 LOCUST STREET TERRE HAUTE, INDIAN

ROVED BY:

DRAWN BY: DATE:



SYMBOL LEGEND

EXO

DEMO EXISTING LIGHT FIXTURE COMPLETE D ∰ D∯ D∯ D∰ DEMO EXISTING RECEPTACLE COMPLETE DEMO EXISTING LIGHT DEMO EXISTING LIGHT D \$ D \$ FIXTURE COMPLETE SWITCH COMPLETE DEMO EXISTING LIGHT EXISTING RECEPTACLE EX∰ EX∯ EX∯EX∯ FIXTURE COMPLETE DEMO EXISTING LIGHT DО EX \$ EX \$ EXISTING LIGHT FIXTURE COMPLETE SWITCH REMAINS DEMO EXISTING EMERGENCY

WABASH VALLEY HEA 1436 LOCUST STREET TERRE HAUTE, INDIAN

REVISIONS

NUMBERED NOTES:

- REMOVE EXISTING CEILING MOUNTED ELECTRICAL HEATER COMPLETE. INCLUDING ALL CONTROLS.
- DISCONNECT AND COMPLETELY REMOVE EXISTING RAMP HEATING SYSTEM.
- (3) EXISTING ELECTRICAL WALL HEATER REMAINS.

FIXTURE COMPLETE

EXISTING LIGHT

FIXTURE REMAINS

EXISTING LIGHT

EXISTING LIGHT

EXISTING LIGHT

FIXTURE REMAINS

FIXTURE REMAINS

FIXTURE REMAINS

EXISTING EMERGENCY

FIXTURE REMAINS

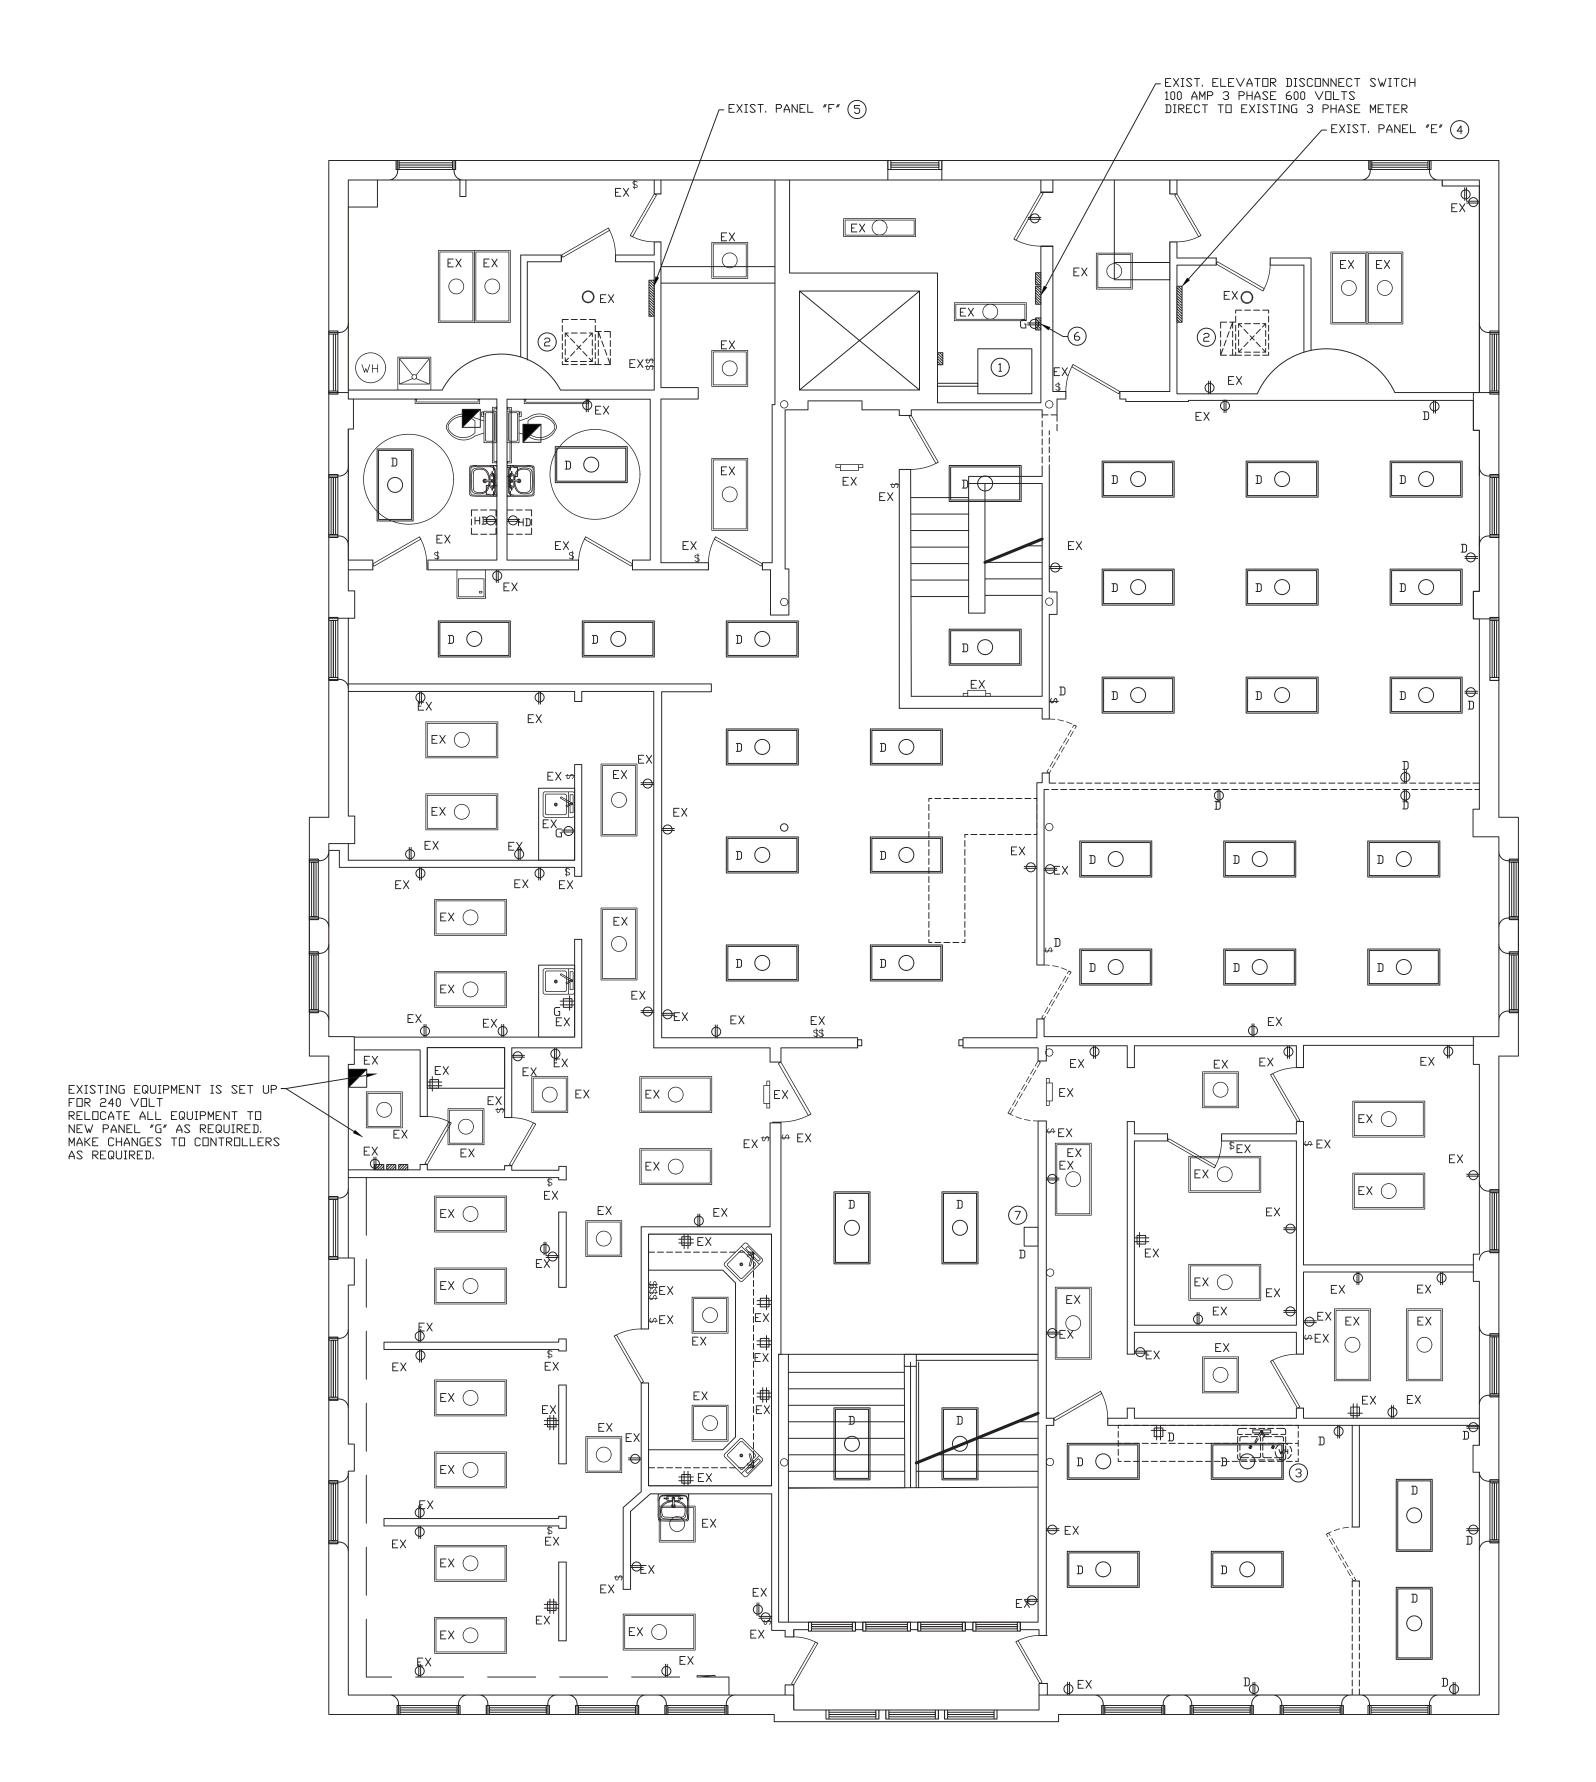
- DISCONNECT POWER TO EXISTING GAS FURNACE. RE-CONNECT TO NEW GAS FURNACE GF-3 AFTER INSTALLATION BY M.C. EXTEND POWER WIRING AS REQUIRED.
- DISCONNECT POWER TO EXISTING GAS FURNACE. REMOVE POWER WIRING BACK TO ELECTRICAL PANEL.
- DISCONNECT POWER TO EXISTING AIR CONDITIONER. REMOVE ALL DISCONNECTS, CONNECTIONS, POWER WIRING, AND BREAKER IN EXISTING ELECTRICAL NEW AIR CONDITIONERS WILL BE FED FROM NEW ELECTRICAL PANELS IN BUILDING ADDITION.
- (7) EXISTING PANEL "D" 200 AMP MB 120 / 240 VOLT 40 CIRCUIT EXISTING BREAKERS 1 - 50 AMP 2P EXISTING A/C UNIT
 - TO BE REMOVED COMPLETE 1 - 50 AMP 2P EXISTING A/C UNIT TO BE REMOVED COMPLETE
 - 3 30 AMP 2P EXISTING SNOW MELT ON WEST SIDE TO BE REMOVED COMPLETE
 - 1 20 AMP 1P EXISTING SNOW MELT ON WEST SIDE CONTROLS TO BE REMOVED COMPLETE 1 - 100 AMP 2P EXISTING PANEL "D1" 1 - 30 AMP 2P EXISTING HOT WATER HEATER REMAINDER ARE 20 AMP 1P EXISTING VARIOUS
- EXISTING PANEL "D1" 100 AMP MB OR MLP 120 / 240 VOLT 12 - 20 AMP 1P EXISTING BREAKERS FED FROM PANEL "D"
- EXISTING HEAT TRACE WILL NEED TO BE REWORKED IN EXISTING DOWNSPOUT. PROVIDE WORK AS REQUIRED.
- REMOVE ALL EXISTING SURFACE MOUNTED CONDUITS, WIRING, AND LIGHT FIXTURES ON THIS ENTIRE BUILDING ELEVATION.

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SECOND FLOOR DEMOLITION ELECTRICAL PLAN

SYMBOL LEGEND

DEMO EXISTING LIGHT FIXTURE COMPLETE D ∰ D∯ D∯ D∰ DEMO EXISTING RECEPTACLE COMPLETE DEMO EXISTING LIGHT DEMO EXISTING LIGHT D \$ D \$ FIXTURE COMPLETE SWITCH COMPLETE DEMO EXISTING LIGHT EXISTING RECEPTACLE EX∰ EX∯ EX∯EX∯ FIXTURE COMPLETE DEMO EXISTING LIGHT DО EXISTING LIGHT EX \$ EX \$ FIXTURE COMPLETE SWITCH REMAINS DEMO EXISTING EMERGENCY FIXTURE COMPLETE

EXISTING LIGHT FIXTURE REMAINS EXISTING LIGHT EXO FIXTURE REMAINS EXISTING LIGHT

FIXTURE REMAINS EXISTING LIGHT EXO FIXTURE REMAINS EXISTING EMERGENCY FIXTURE REMAINS

NUMBERED NOTES:

1) EXISTING ELEVATOR MOTOR ASSEMBLY. 208 VOLT 3 PHASE 20 HP 208 VOLT 3 PHASE

DISCONNECT POWER TO EXISTING GAS FURNACE. RE-CONNECT TO NEW GAS FURNACE AFTER INSTALLATION BY M.C.

3 DISCONNECT POWER TO EXISTING UNDER COUNTER WATER HEATER. CONNECT TO NEW UNIT AND EXTEND POWER WIRING AS REQUIRED.

4 EXISTING PANEL "E" 200 AMP MLO 120 / 240 VOLT 40 CIRCUIT EXISTING BREAKERS 2 - 60 AMP 2P EXISTING A/C TO BE REMOVED COMPLETE 1 - 20 AMP 2P EXISTING VACUUM TO BE RELOCATED TO PANEL "G" 1 - 20 AMP 2P EXISTING HWH 1 - 30 AMP 2P EXISTING VACUUM TO BE RELOCATED TO PANEL "G" 1 - 20 AMP 2P EXISTING DENTAL EQUIPMENT TO BE RELOCATED TO PANEL "G" 13 - 20 AMP 1P TANDEM EXISTING VARIOUS REMAINING ARE 20 AMP 1P EXISTING VARIOUS

EXISTING PANEL "F" 200 AMP MLD 120 / 240 VOLT 42 CIRCUIT 20 - 20 AMP 1P EXISTING DENTAL 1 - 30 AMP 2P ELECTRIC HEATER

6 EXISTING ELEVATOR CAB LIGHTS JUNCTION BOX FED FROM GFI

CHANGE CIRCUIT FEEDING THIS JB TO STAND ALONE CIRCUIT FED FROM PANEL "E" OR PANEL "F"

REMOVE EXISTING SURFACE MOUNTED BELL AND WIRING COMPLETE

REVISIONS



WABASH VALLEY HEA 1436 LOCUST STREET TERRE HAUTE, INDIAN

ROVED BY: 09-11-19 DRAWN BY:

DATE: PROJECT: 18-20

FILE: Elec #F

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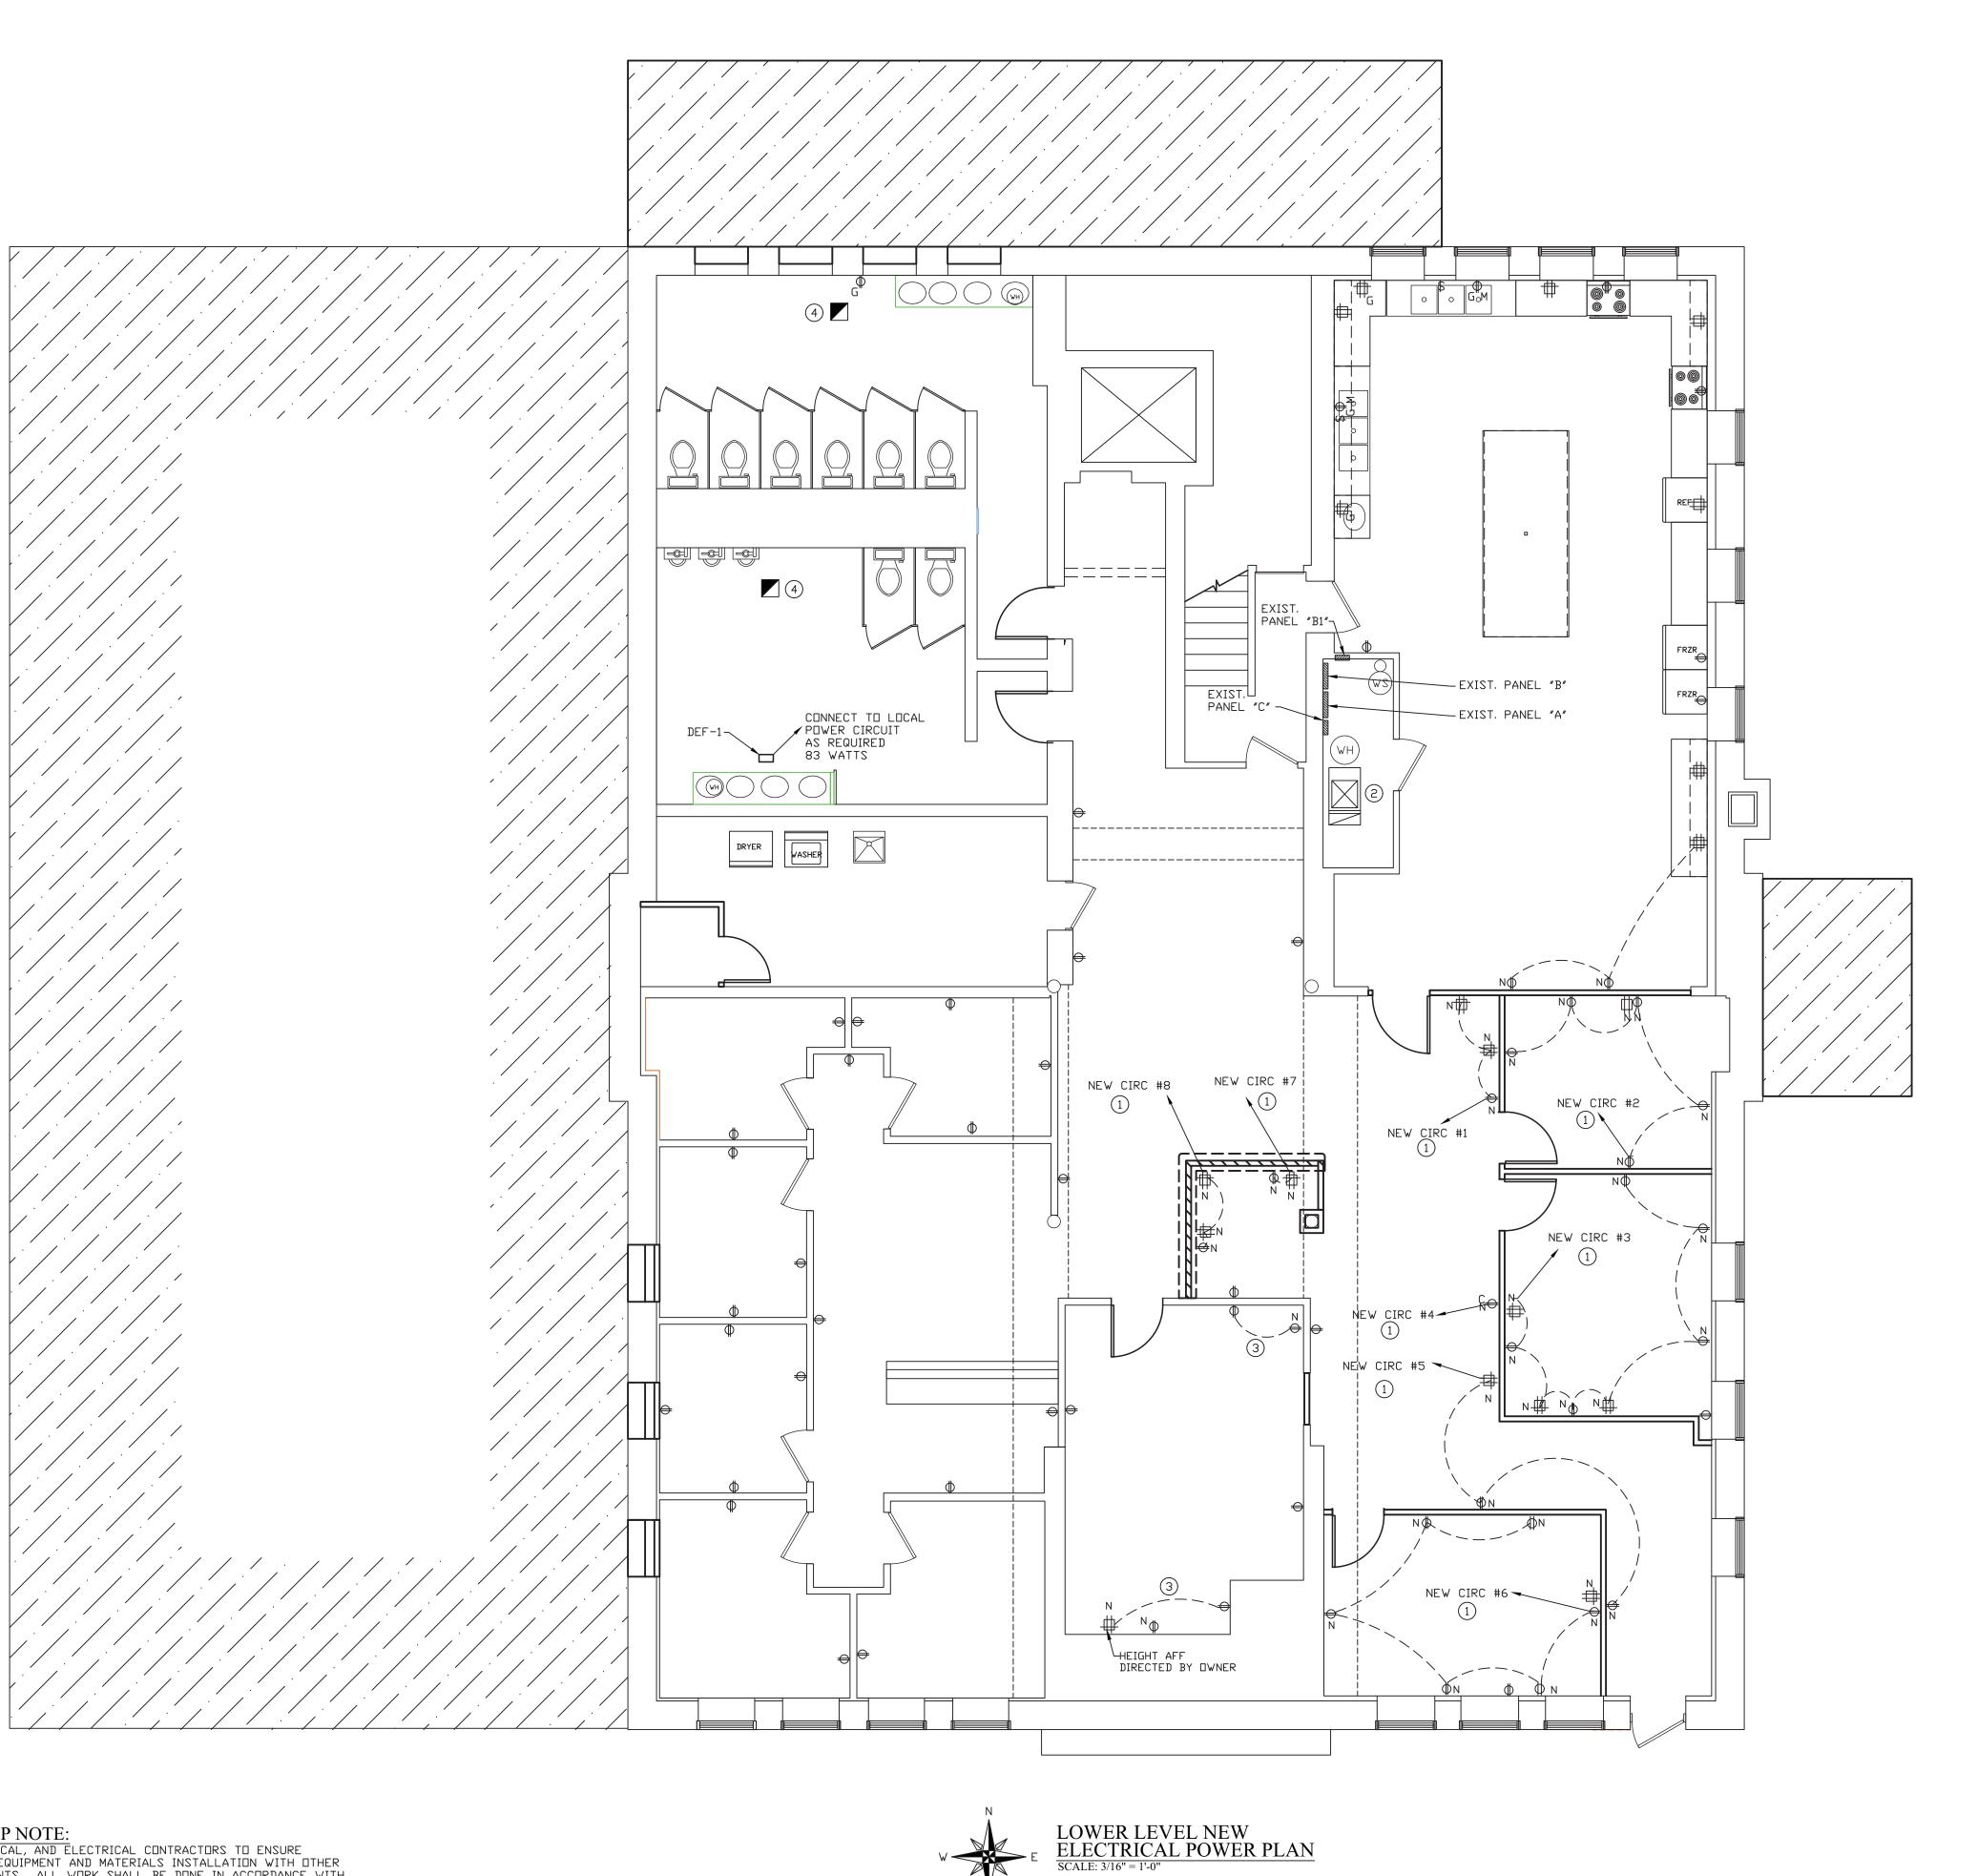
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- 1) CONNECT TO EXISTING LOWER LEVEL PANELS AS REQUIRED. PROVIDE ADDITIONAL BREAKERS AND TANDEM BREAKERS AS REQUIRED.
- (2) CONNECT EXISTING POWER TO NEW GAS FURNACE. PROVIDE NEW SWITCH FOR DISCONNECT. ALSO RE-CONNECT POWER FROM EXISTING CONDENSATE PUMP TO NEW CONDENSATE PUMP
- 3 CONNECT TO POWER TO EXISTING OUTLET AS REQUIRED.
- 4) CONNECT POWER TO EXISTING EXHAUST FAN WHICH HAS BEEN REINSTALLED IN NEW CEILING.



DATE REVISIONS

WABASH VALLEY HEALTH C 1436 LOCUST STREET TERRE HAUTE, INDIANA 4780

DATE:

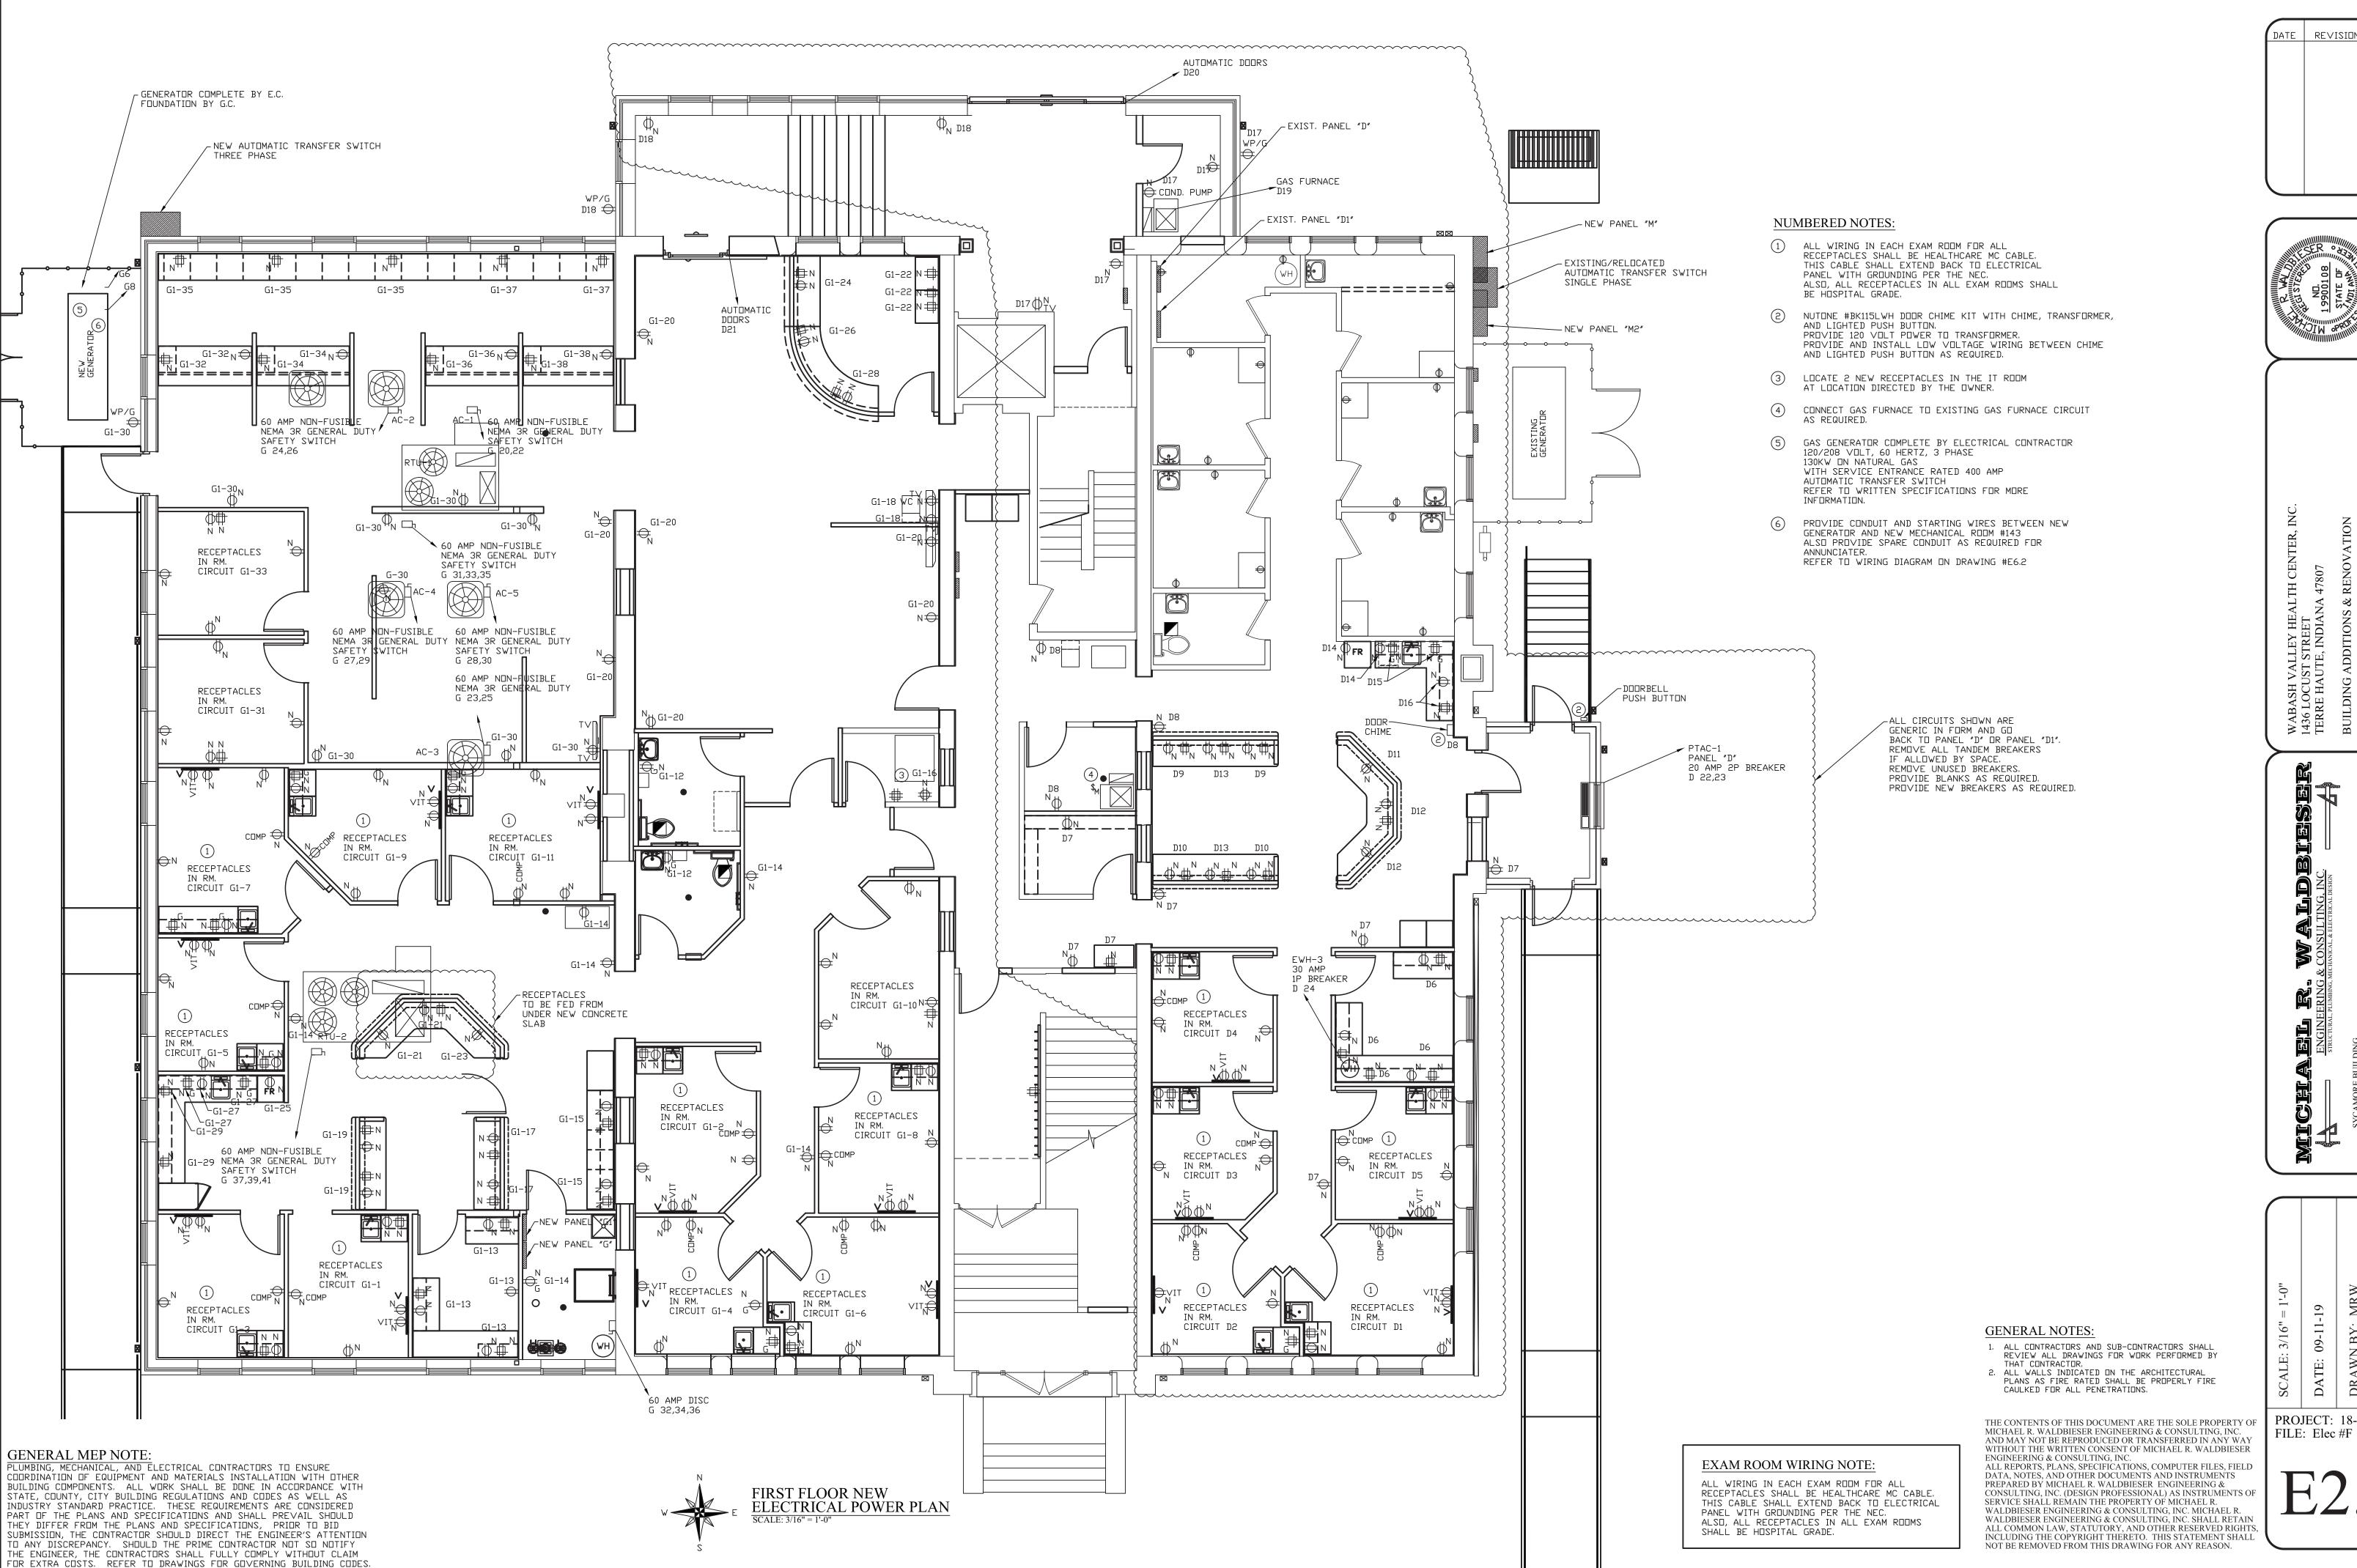
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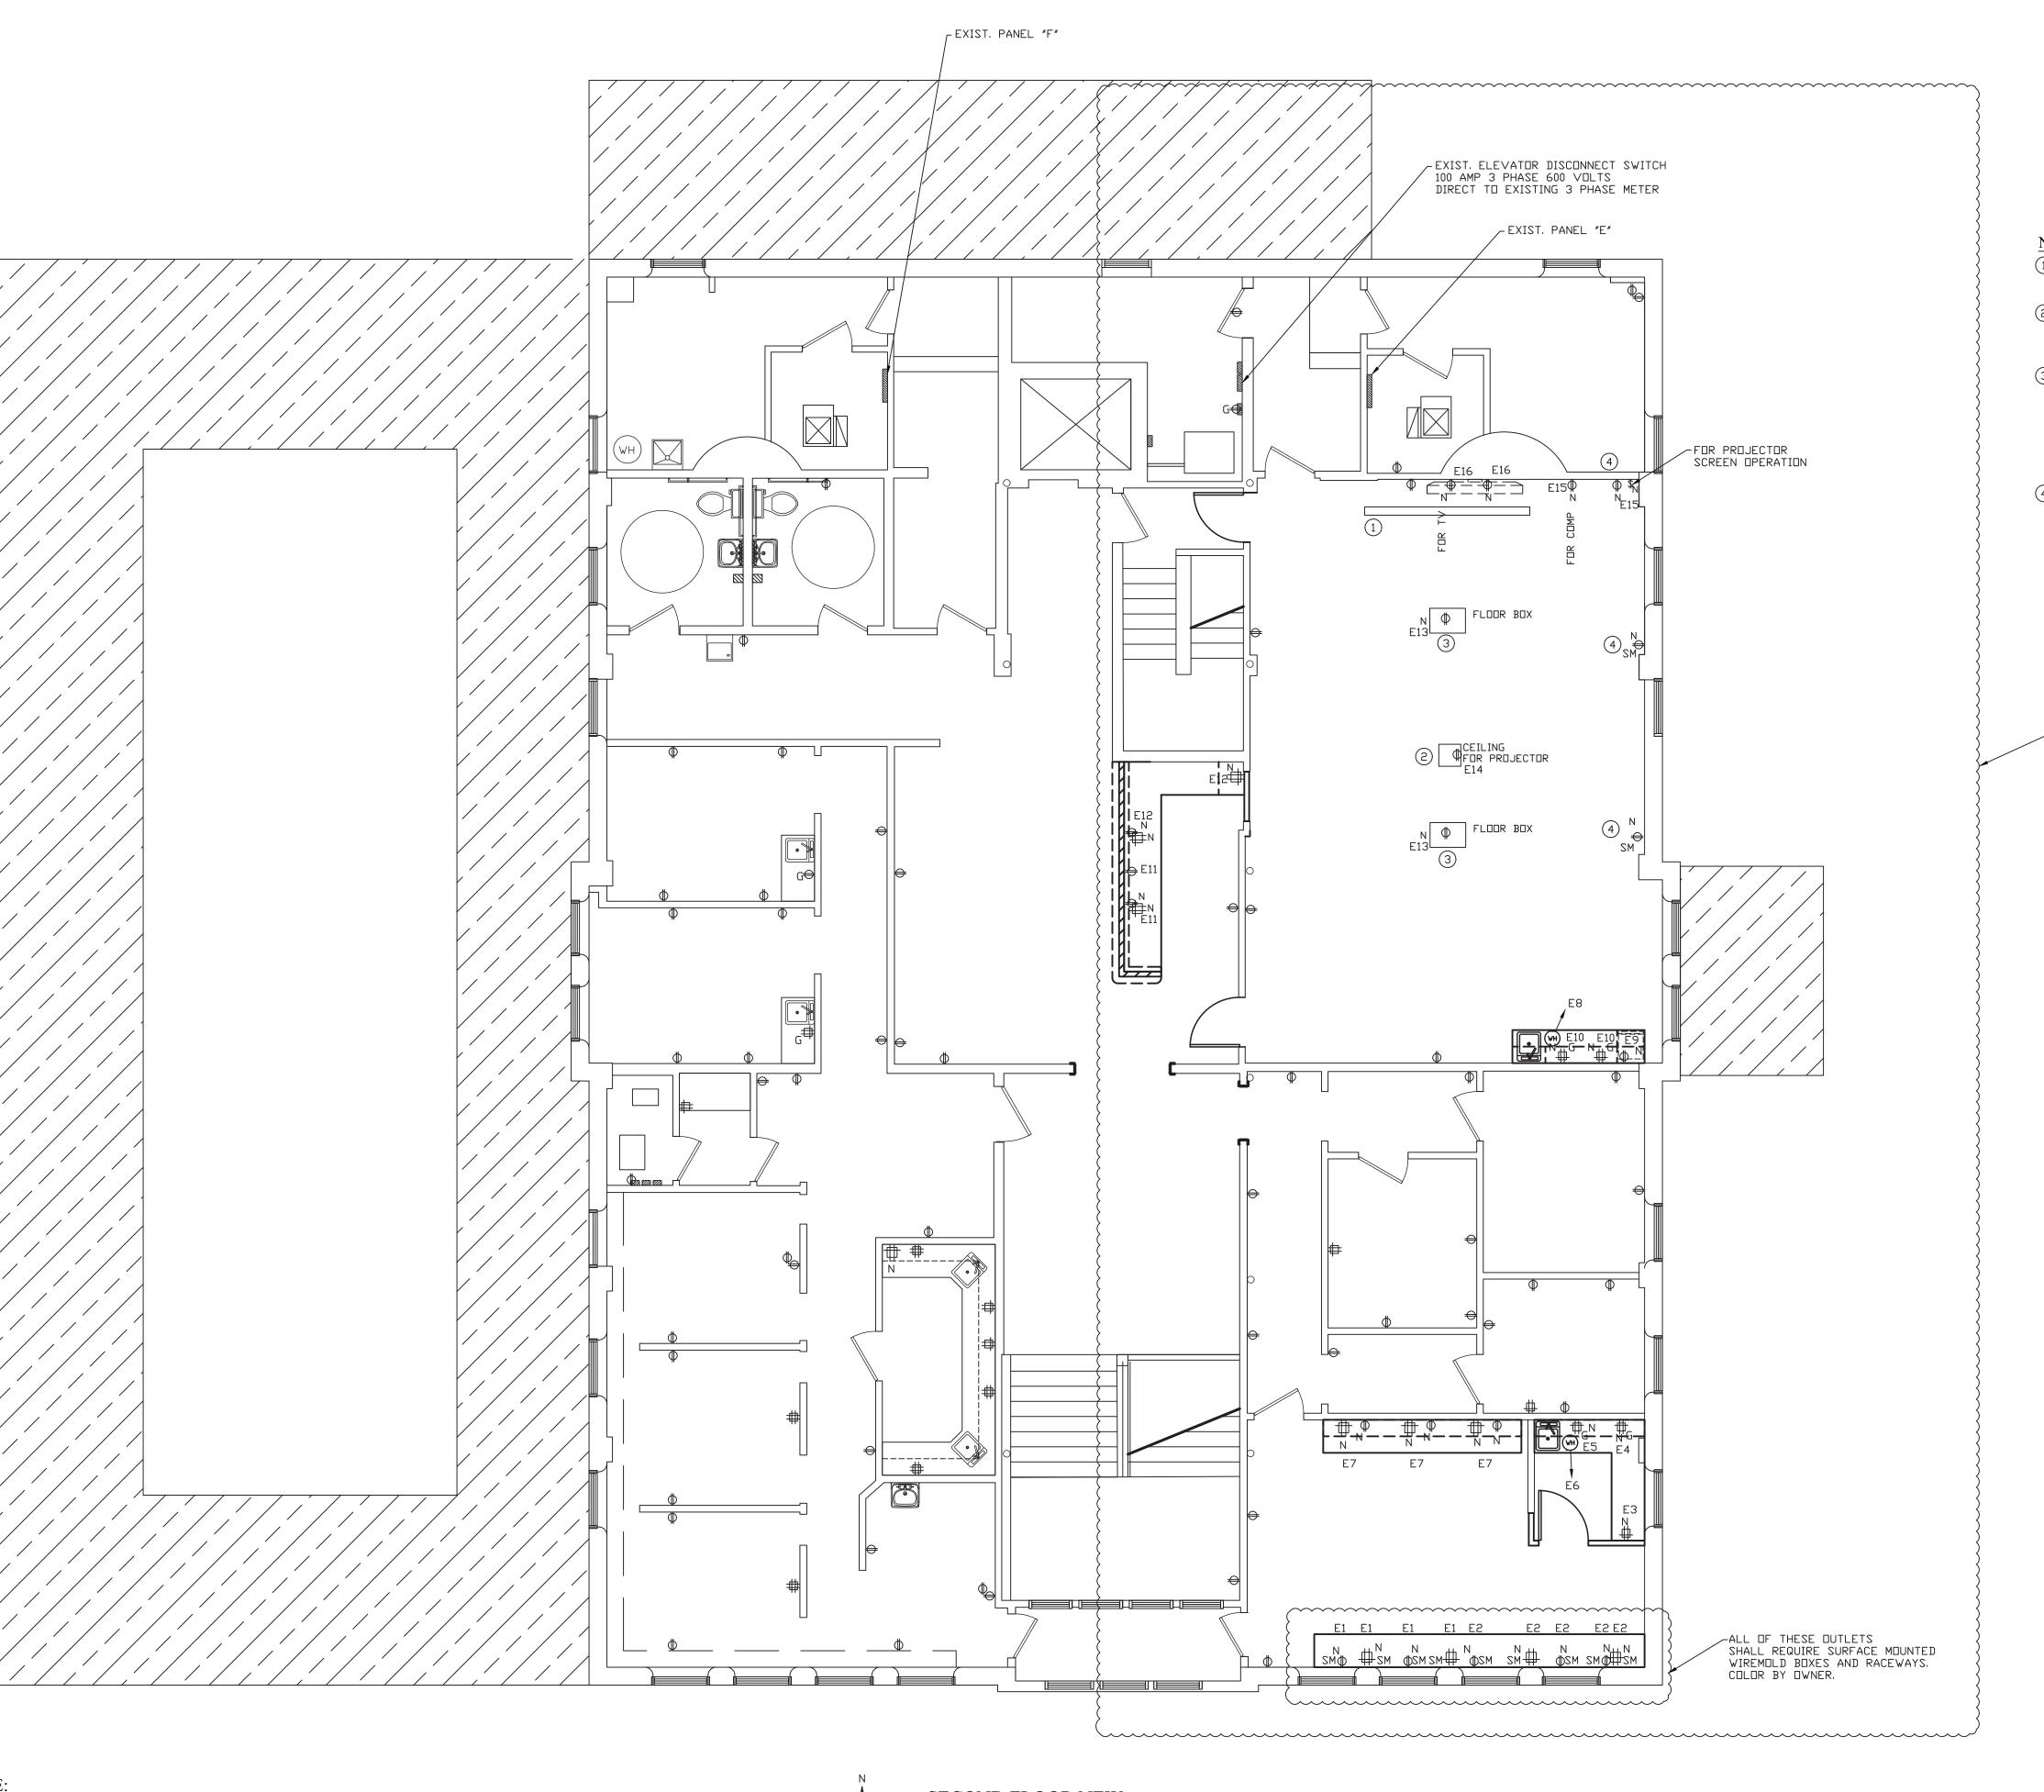


REVISIONS



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PROJECT: 18-20





- 1 PROJECTOR SCREENED SUPPLIED BY THE OWNER.
 INSTALLED BY E.C. COMPLETE.
 UNIT WILL BE POWERED WITH WALL SWITCH
 CONTROL.
- CONTROL.

 CEILING HUNG PROJECTOR SUPPLIED BY THE OWNER.

 INSTALLED BY E.C. COMPLETE.

 MOUNTING/SUSPENSION ITEMS BY OWNER. INSTALLED BY E.C.
- NEW SYSTEM ONE MODULAR IN FLOOR SYSTEM. PROVIDE WITH THE FOLLOWING: 1. ROUND MULTI-SERVICE PVC FLOOR BOX 2. CARPET ASSEMBLY UNIVERSAL COVER COLOR SELECTED BY OWNER
- 3. SUB-PLATE FOR POWER, DATA, AND TELEPHONE CONNECTIONS.

 4. CATEGORY 6E, PHONE, AND 20 AMP RECEPTACLE
- 4) CONNECT TO EXISTING CIRCUIT USED FOR REMOVED RECEPTACLE AT THIS LOCATION.

ALL CIRCUITS SHOWN ARE GENERIC IN FORM AND GO BACK TO PANEL "E" OR PANEL "F". REMOVE ALL TANDEM BREAKERS IF ALLOWED BY SPACE. REMOVE UNUSED BREAKERS. PROVIDE BLANKS AS REQUIRED.

PROVIDE NEW BREAKERS AS REQUIRED.

WABASH VALLEY HEALTH C 1436 LOCUST STREET TERRE HAUTE, INDIANA 4780

DATE REVISIONS

DATE:

PROJECT: 18-20 FILE: Elec #F

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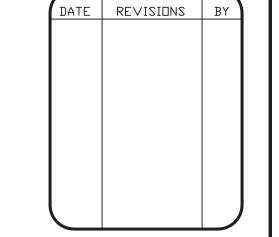
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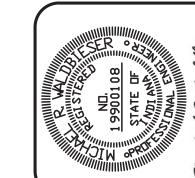
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SECOND FLOOR NEW ELECTRICAL POWER PLAN

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- 1) PROVIDE AND INSTALL NEW WALL MOUNTED OCCUPANCY SENSOR FOR CONTROL OF NEW LED LIGHTING. DIMMING CONTROL NOT REQUIRED.
- 2 PROVIDE AND INSTALL NEW WALL MOUNTED COMPATIBLE DIMMER.

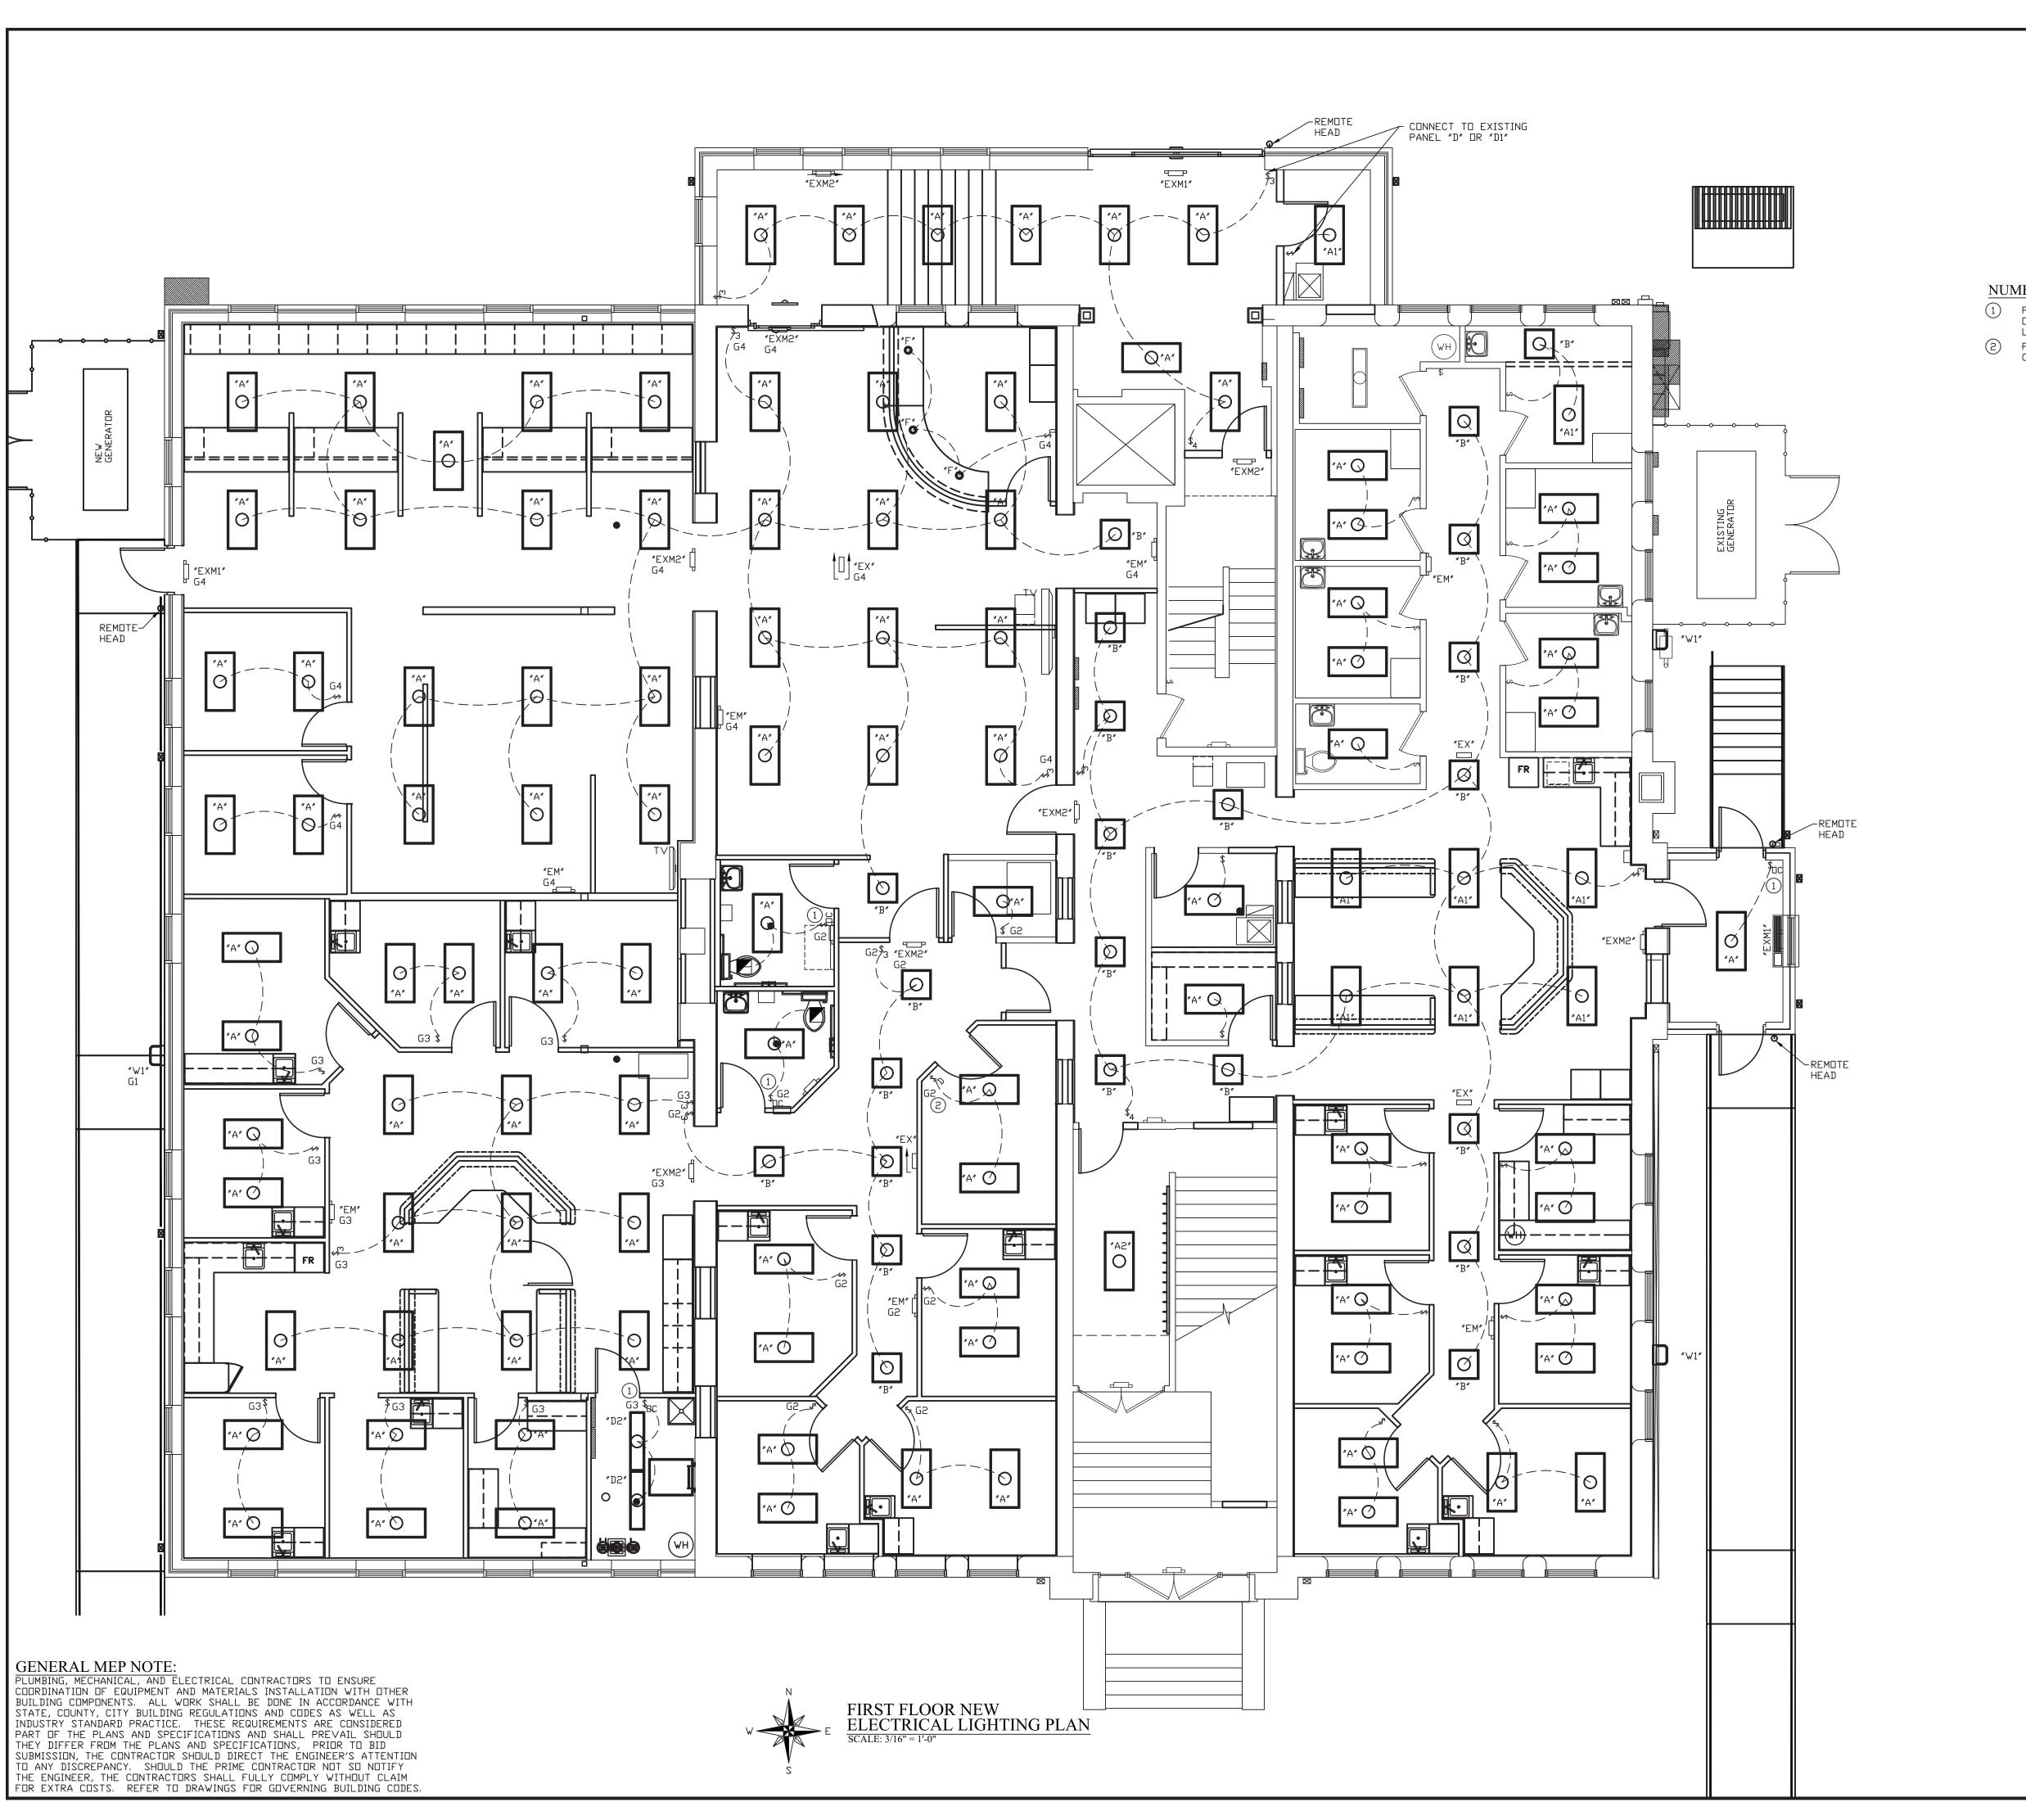
WABASH VALLEY HEALTH CE 1436 LOCUST STREET TERRE HAUTE, INDIANA 47807

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 CONNECT ALL LIGHT FIXTURES TO EXISTING LIGHTING CIRCUITS AS REQUIRED.

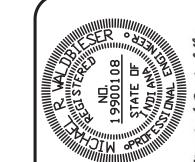
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- 1) PROVIDE AND INSTALL NEW WALL MOUNTED OCCUPANCY SENSOR FOR CONTROL OF NEW LED LIGHTING. DIMMING CONTROL NOT REQUIRED.
- 2 PROVIDE AND INSTALL NEW WALL MOUNTED COMPATIBLE DIMMER.



DATE REVISIONS

WABASH VALLEY HEALTH CE 1436 LOCUST STREET TERRE HAUTE, INDIANA 47807

09-11-19 ROVED BY: DRAWN BY:

DATE:

GENERAL NOTES:

ENGINEERING & CONSULTING, INC.

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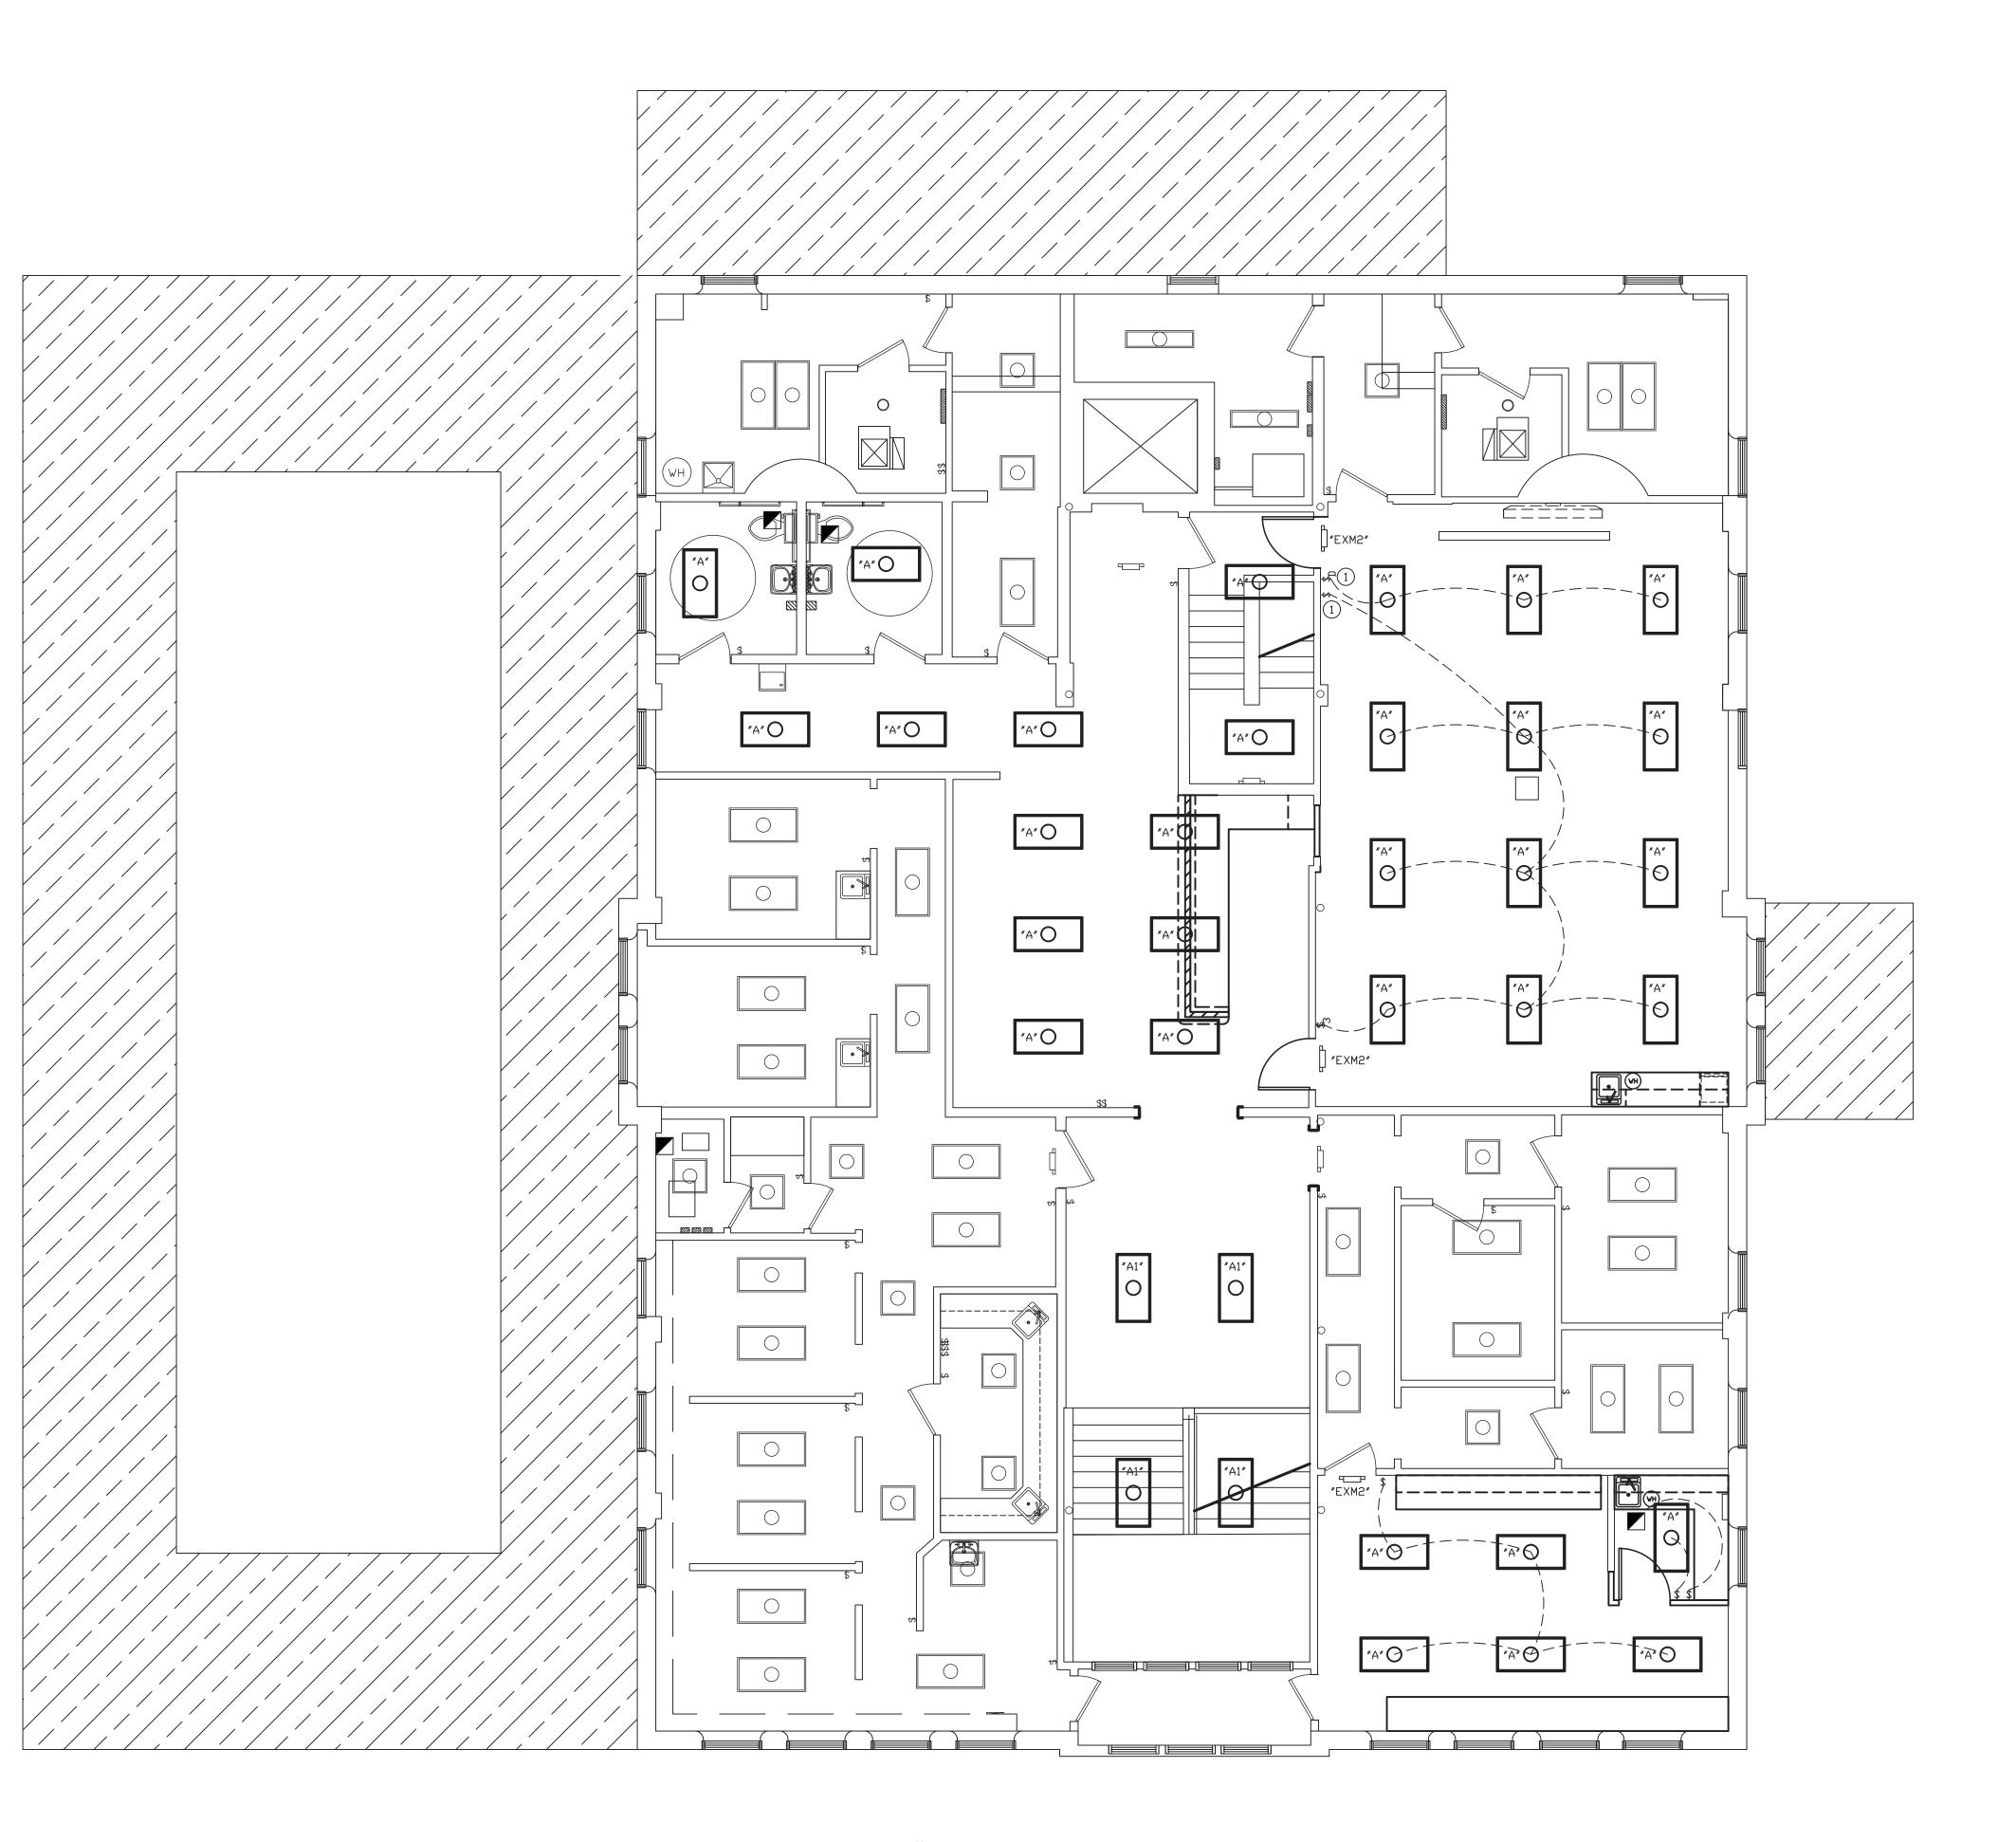
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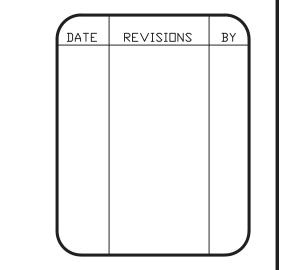
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1) PROVIDE AND INSTALL NEW WALL MOUNTED COMPATIBLE DIMMER.

WABASH VALLEY HEALTH CENTE 1436 LOCUST STREET TERRE HAUTE, INDIANA 47807

PROVED BY: 09-11-19

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PROJECT: 18-20 FILE: Elec #F

GENERAL NOTES:

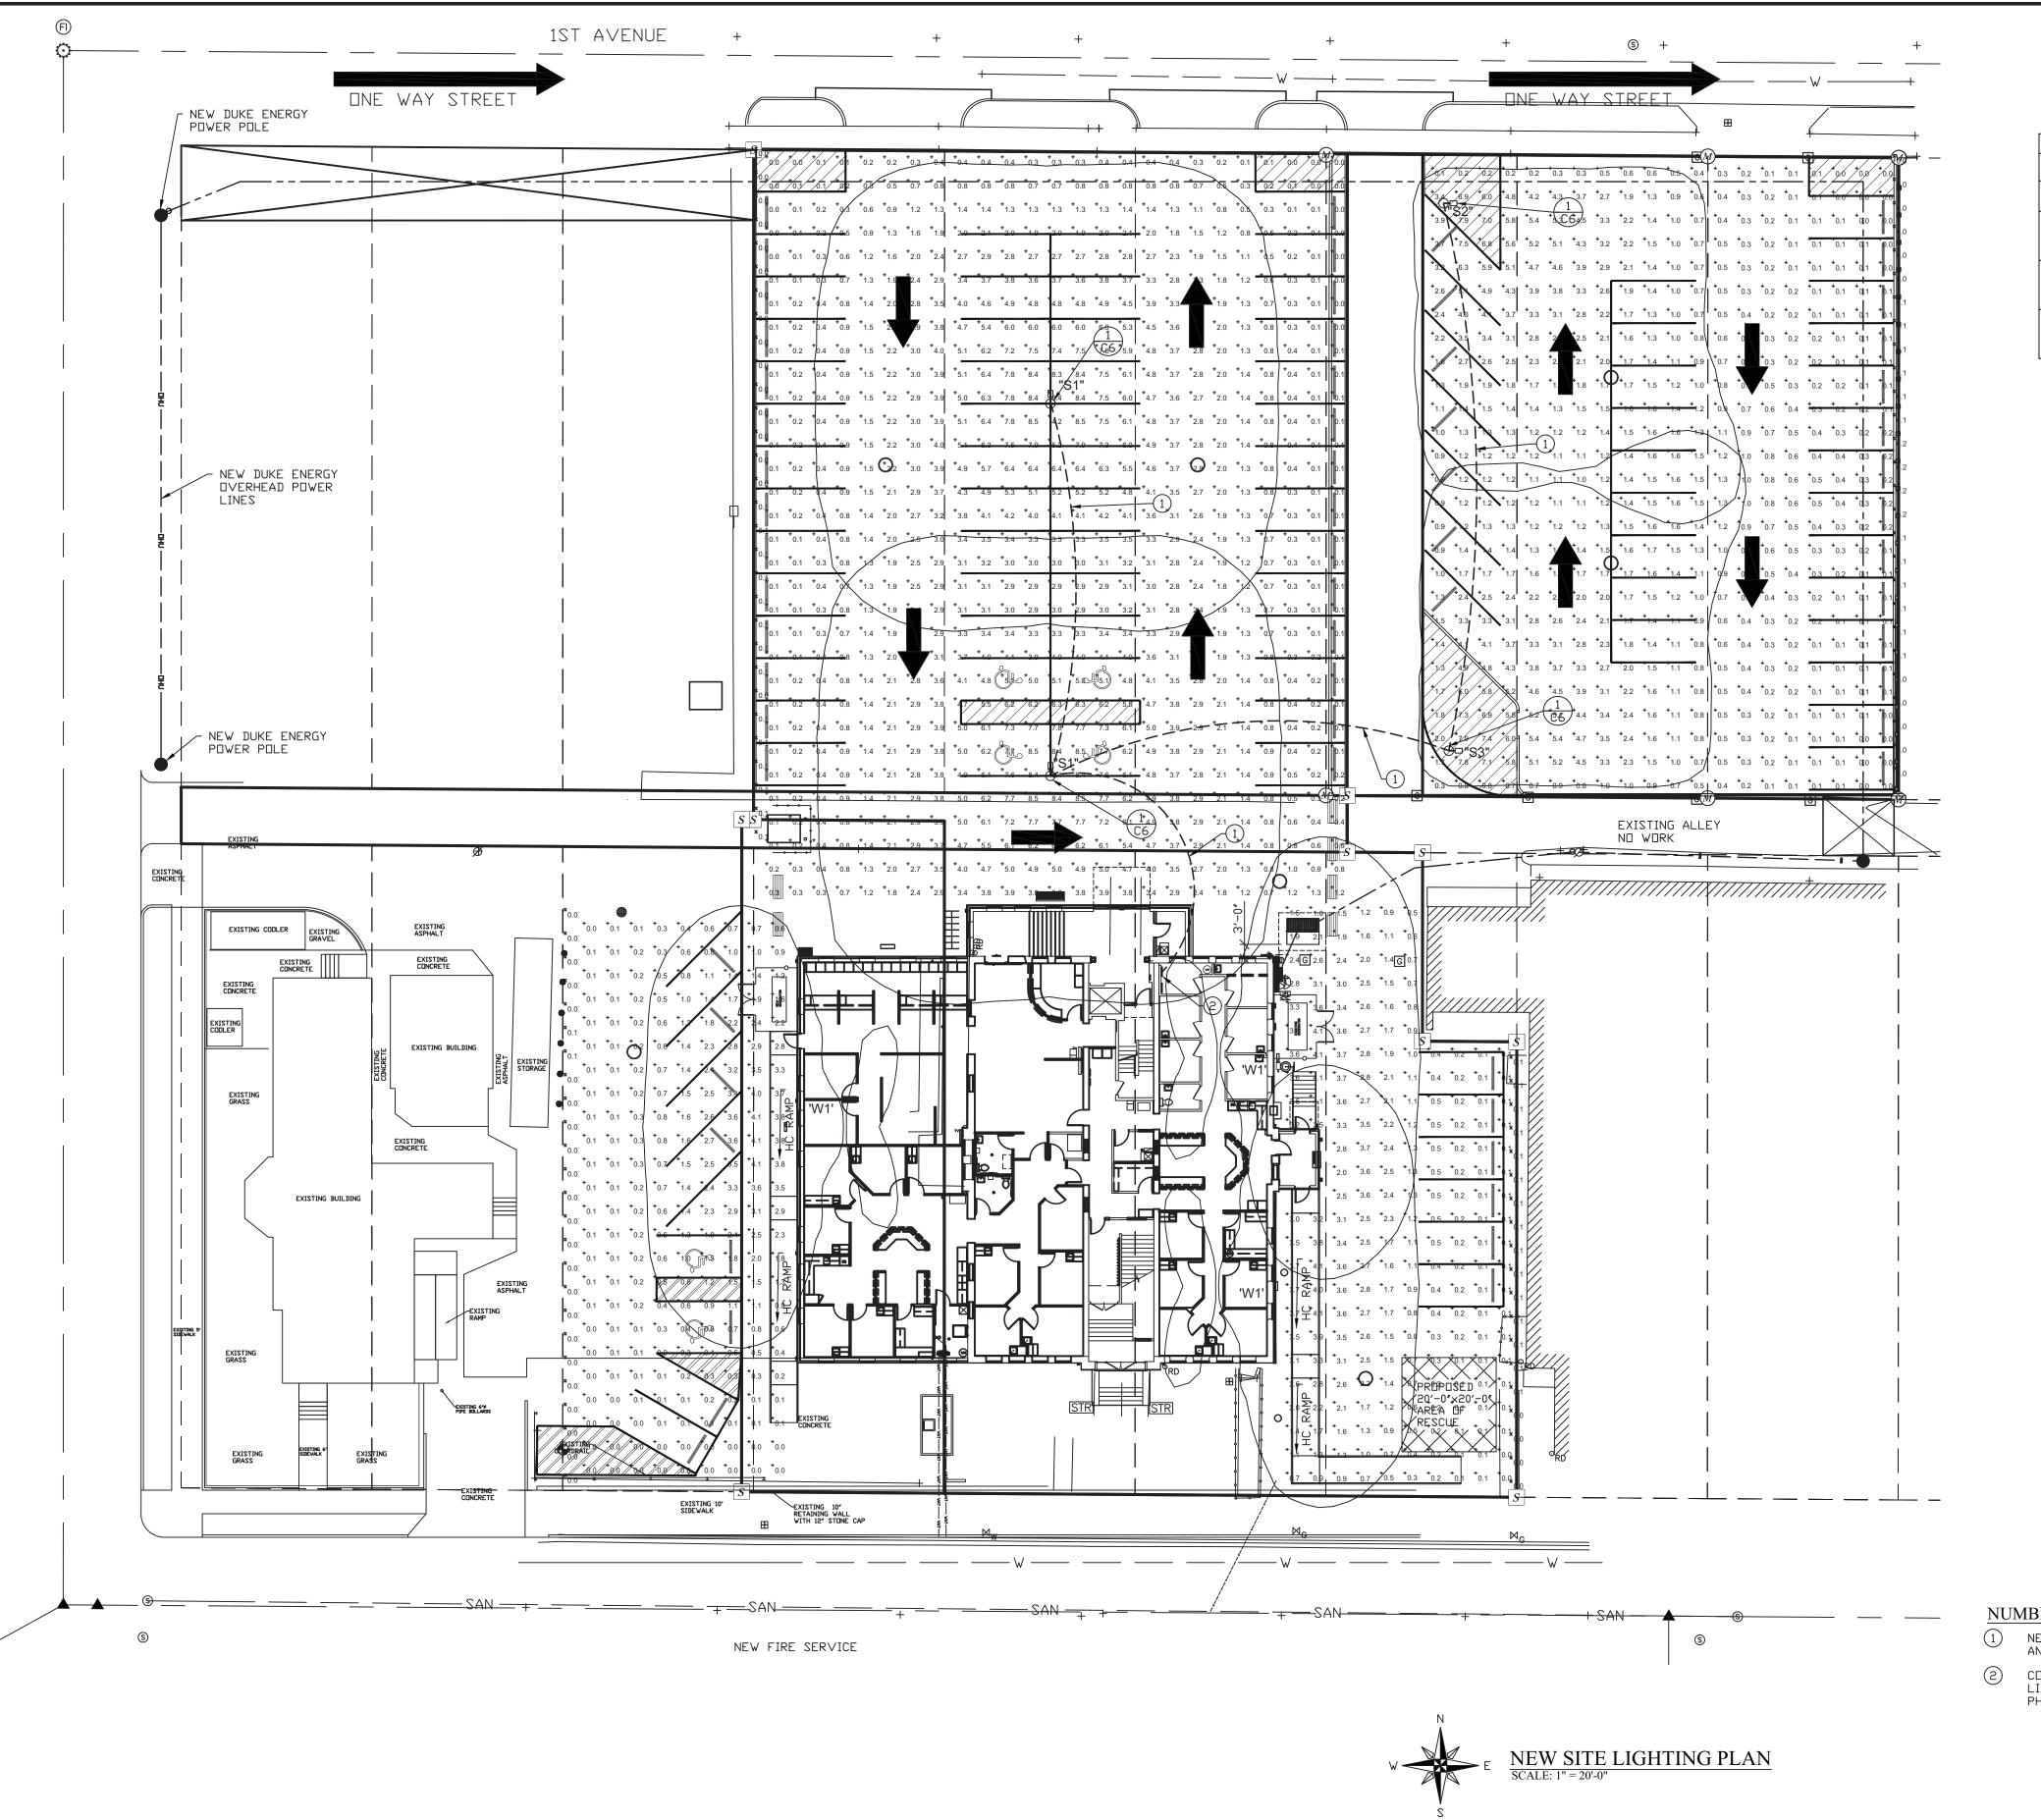
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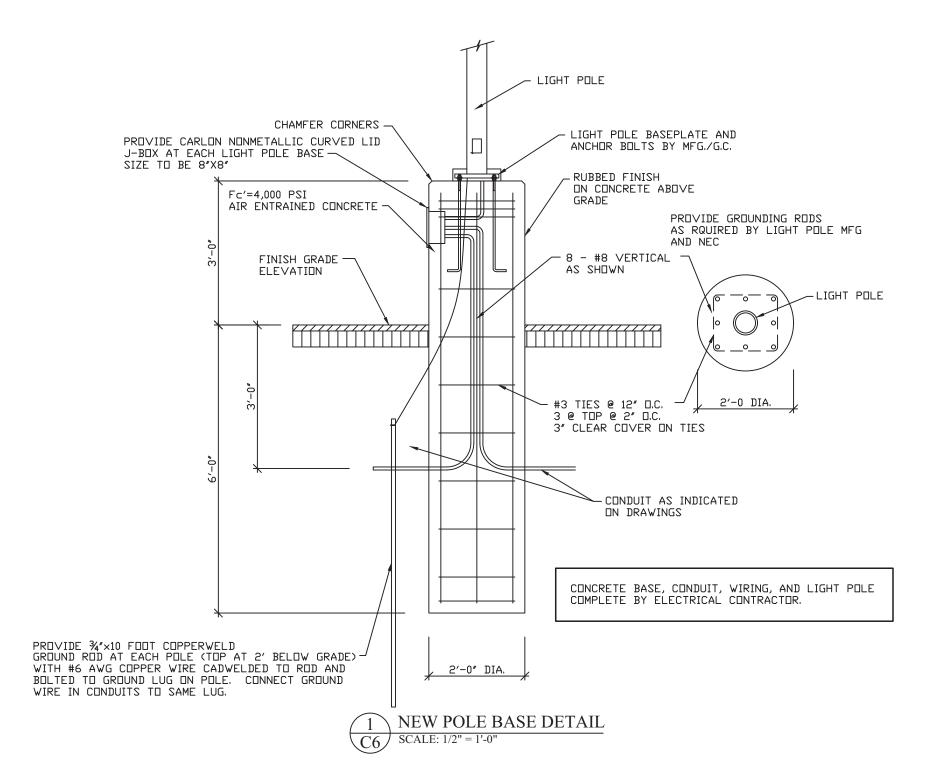
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Symbol	Label	Quantity	Manufacturer	Catalog Number	Lumens Per Lamp	Light Loss Factor	Wattage	
	W1	3	Lithonia Lighting	DSXW2 LED 20C 1000 40K T2S MVOLT	7674	0.92	73	
	S1	2	Lithonia Lighting	DSX1 LED P9 40K T5S MVOLT 20' POLE	28706		241	
	S2	1	Lithonia Lighting	DSX1 LED P6 40K LCCO MVOLT 20' POLE	11614	0.92	163	
	S3	1	Lithonia Lighting	DSX1 LED P6 40K RCCO MVOLT 20' POLE	11614	0.92	163	

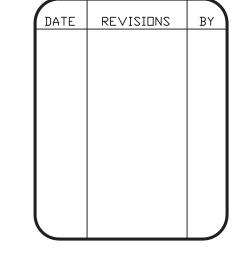
Statistics						
Description	Symbol	Avg	Max	Min	Max/Min	Avg/Min
Lighting Area 1_Grade	+	1.5 fc	7.9 fc	0.0 fc	N/A	N/A
Lighting Area 2_Grade	+	2.5 fc	8.5 fc	0.0 fc	N/A	N/A
Lighting Area 3_Grade	+	1.5 fc	4.1 fc	0.0 fc	N/A	N/A
Lighting Area 4_Grade	+	0.9 fc	4.1 fc	0.0 fc	N/A	N/A
PL-Northeast_Grade	Ж	0.1 fc	0.2 fc	0.0 fc	N/A	N/A
PL-Northwest_Grade	Ж	0.0 fc	0.1 fc	0.0 fc	N/A	N/A
PL-Southwest_Grade	Ж	0.0 fc	0.1 fc	0.0 fc	N/A	N/A
PL-Southwest_Grade	Ж	0.1 fc	0.1 fc	0.0 fc	N/A	N/A



- 1) NEW 3/4" CONDUIT WITH 2 #12 CU THHN WIRES AND 1 #12 CU GROUND
- 2 CONNECT TO NEW 2P BREAKER IN EXISTING PANEL. LIGHTS SHALL BE CONNECTED TO 208 VOLT 1 PHASE.

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WABASH VALLEY HEALTH CENTER, INC. 1436 LOCUST STREET
TERRE HAUTE, INDIANA 47807
BUILDING ADDITIONS & RENOVATION

A. ENGINEERING & CONSULTING, INC.

STRUCTURAL, PLUMBING, MECHANICAL, & ELECTRICAL DESIGN

SULDING

STREET, SUITE 804

PHONE: (812) 232-6510

ENGINEERING & CO
STRUCTURAL, PLUMBING, MECHAN
SYCAMORE BUILDING
19 SOUTH 6th STREET, SUITE 804
TERRE HAUTE, INDIANA 47807

SCALE: 1" = 20'-0"

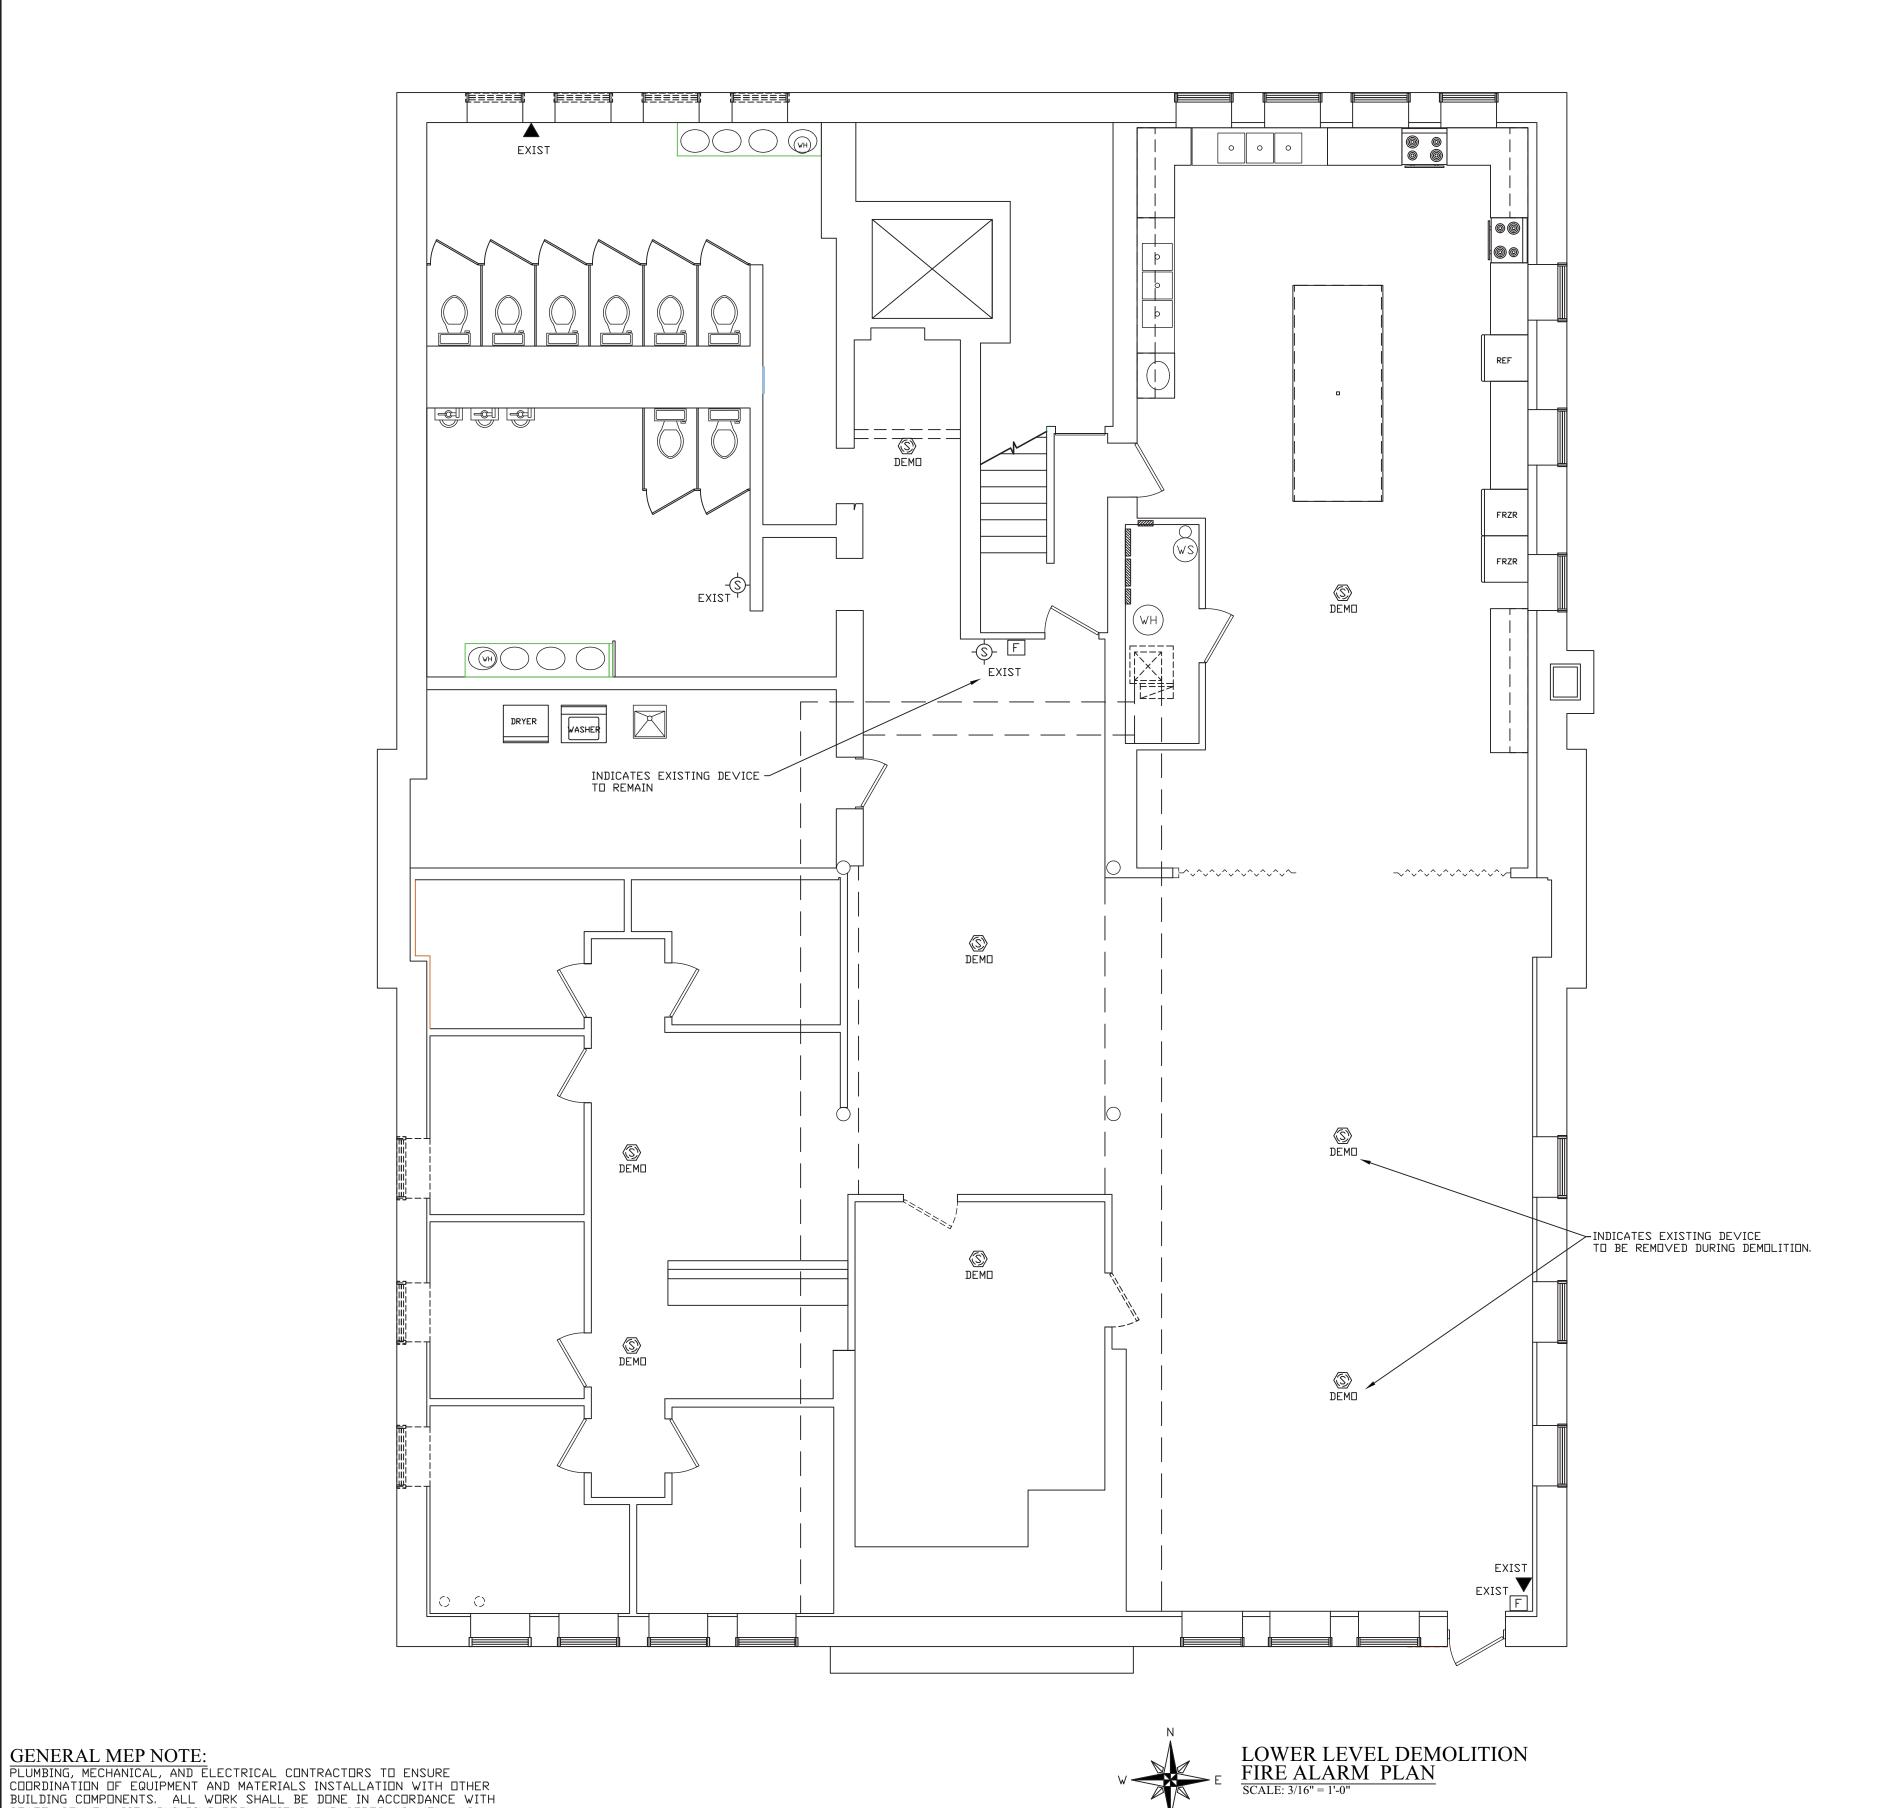
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DRAWN BY: MRW

PROJECT: 18-20 FILE: NSite #F

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ALARM SYSTEM DEVICE SCHEDULE

F PULL STATION

P POST INDICATING VALVE - AS REQUIRED FOR SPRINKLER SYSTEM.

FS | FLOW SWITCH - AS REQUIRED FOR SPRINKLER SYSTEM.

TS TAMPER SWITCH - AS REQUIRED FOR SPRINKLER SYSTEM.

AR 3 ADDRESSABLE RELAYS FOR ELEVATOR

SMOKE DETECTOR

S SMOKE DETECTOR WITH SOUNDER

SMOKE DETECTOR WITH CO2 SENSOR

⟨H⟩ | HEAT DETECTOR

D DUCT DETECTOR - WITH SAMPLING TUBE

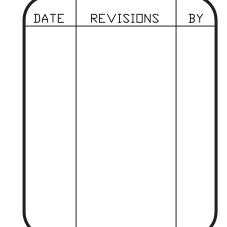
-(S)- | STROBE LIGHT

▼ HORN/STROBE LIGHT

PLAN NOTE:

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MAY ALSO REUSE EXISTING WIRING IF IN GOOD OPERATING





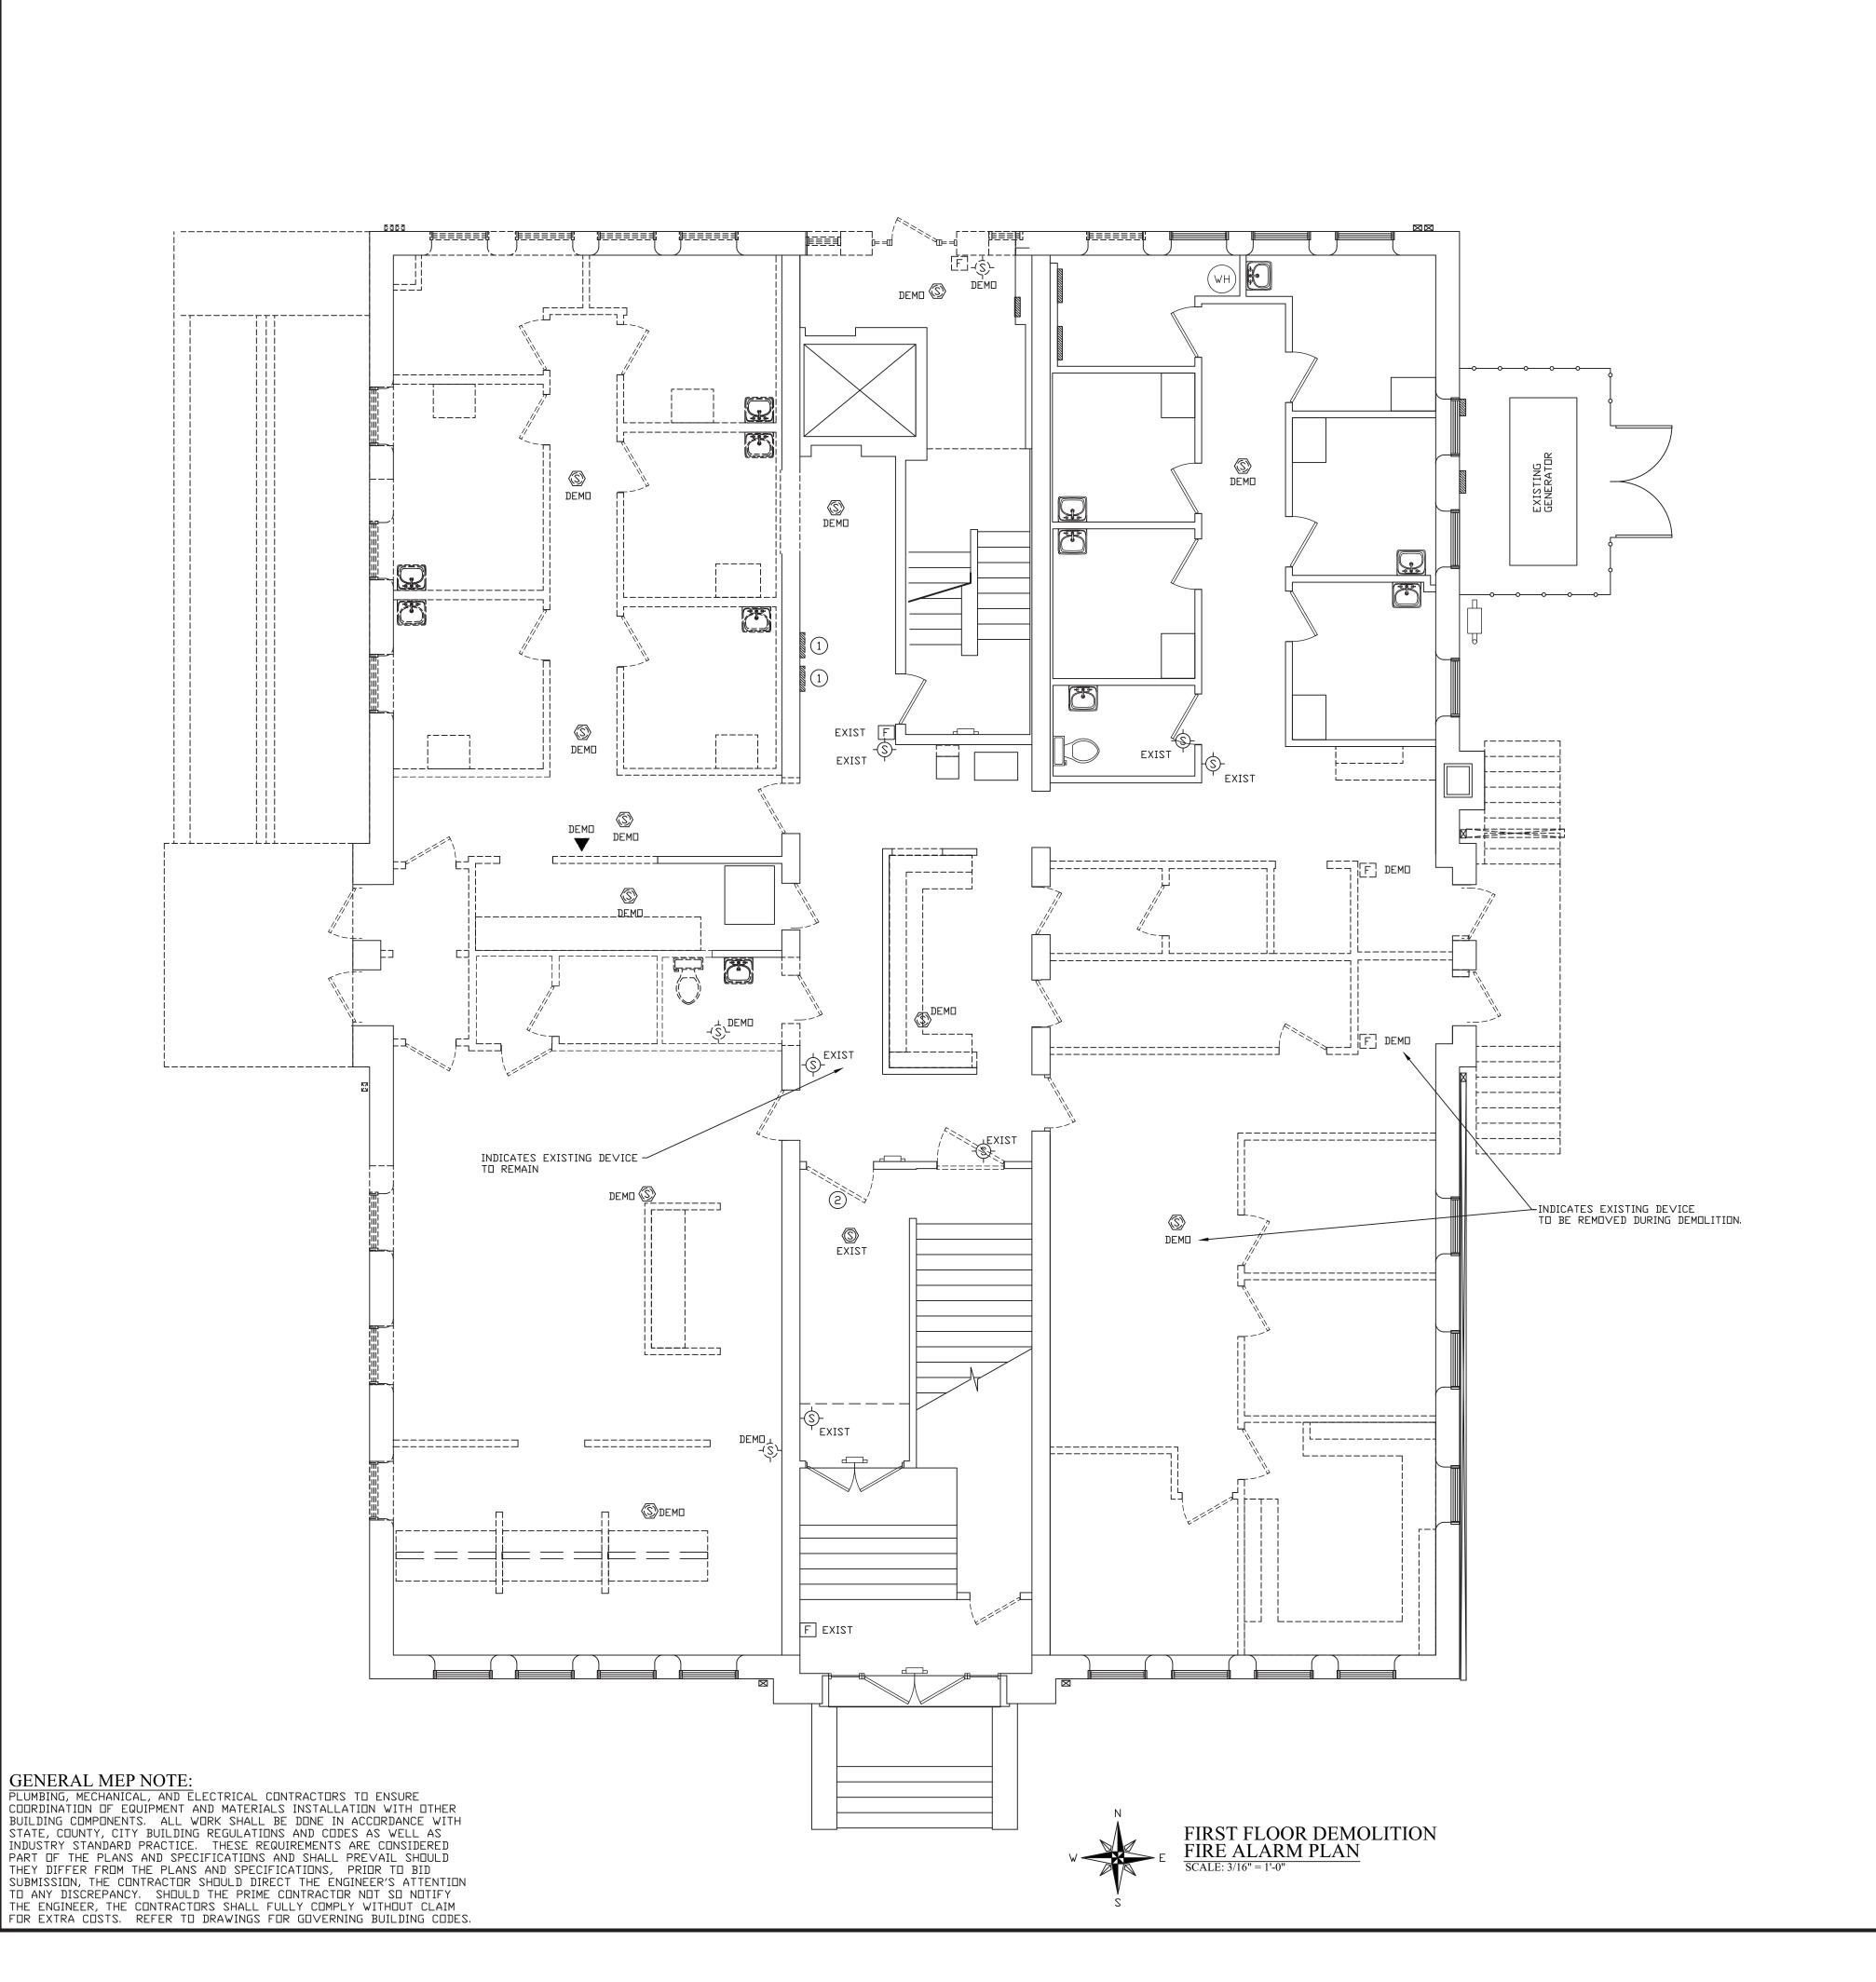
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09-11-19 APPROVED BY: DRAWN BY:]

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ALARM SYSTEM DEVICE SCHEDULE

- F | PULL STATION
- P POST INDICATING VALVE AS REQUIRED FOR SPRINKLER SYSTEM.
- FS | FLOW SWITCH AS REQUIRED FOR SPRINKLER SYSTEM. TS TAMPER SWITCH - AS REQUIRED FOR SPRINKLER SYSTEM.
- AR 3 ADDRESSABLE RELAYS FOR ELEVATOR
- SMOKE DETECTOR
- S SMOKE DETECTOR WITH SOUNDER
- SMOKE DETECTOR WITH CO2 SENSOR
- ⟨H⟩ | HEAT DETECTOR
- D | DUCT DETECTOR WITH SAMPLING TUBE
- S- STROBE LIGHT
- ▼ HORN/STROBE LIGHT

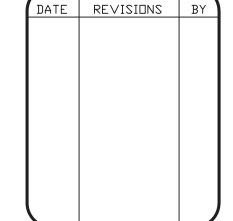
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 MAY ALSO REUSE EXISTING WIRING IF IN GOOD OPERATING





WABASH VALLEY HEALTH C 1436 LOCUST STREET TERRE HAUTE, INDIANA 4780

PANELS OR PROVIDE NEW. REMOVE EXISTING HOLD OPEN FROM EXISTING DOOR.

LOCATION OF THE EXISTING FIRE ALARM PANELS.

PANELS WILL RE-INSTALLED AT THE SAME

IT IS THE FINAL RESPONSIBILITY OF THE ELECTRICAL CONTRACTOR TO DETERMINE IF THE EXISTING FIRE ALARM PANELS CAN ACCEPT THE

ADDITIONAL DEVICES SHOWN ON THE DRAWINGS.

IF REQUIRED, ADD TO THE EXISTING FIRE ALARM

WILL NOT BE RE-INSTALLED ON NEW DOOR.

BOTH PANELS WILL NEED TO BE REMOVED FROM THE WALL FOR THE REMOVAL OF THE PLASTER BEHIND WHICH CONTAINS LEAD. THEN A NEW WALL CONSISTING OF METAL STUDS AND PAINTED GYPSUM

DRYWALL WILL BE INSTALLED. THEN THE EXISTING

NUMBERED NOTES:

LOCATION.

GENERAL NOTES:

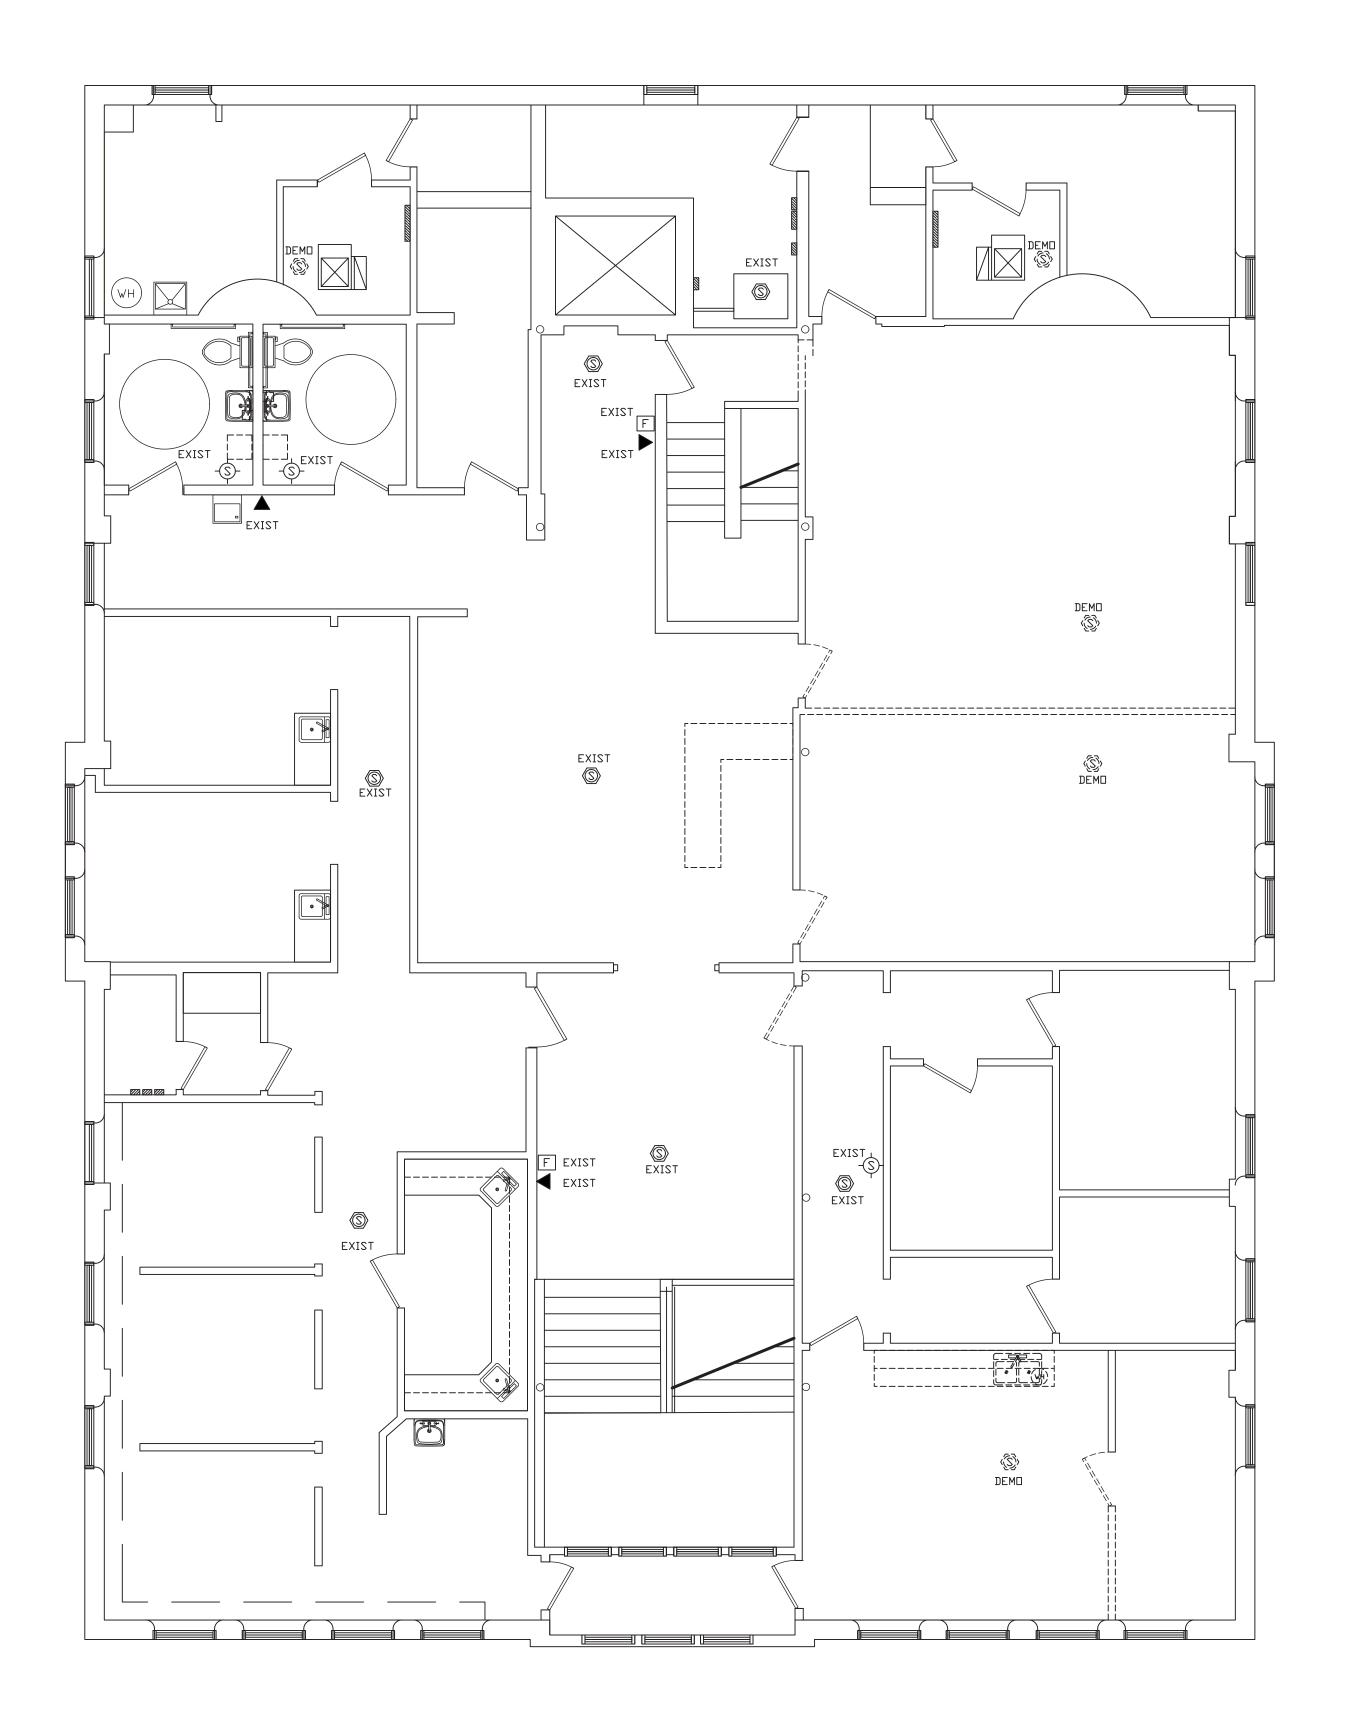
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SECOND FLOOR DEMOLITION FIRE ALARM PLAN

ALARM SYSTEM DEVICE SCHEDULE

F PULL STATION

P POST INDICATING VALVE - AS REQUIRED FOR SPRINKLER SYSTEM.

FS | FLOW SWITCH - AS REQUIRED FOR SPRINKLER SYSTEM. TS TAMPER SWITCH - AS REQUIRED FOR SPRINKLER SYSTEM.

AR 3 ADDRESSABLE RELAYS FOR ELEVATOR

SMOKE DETECTOR

S SMOKE DETECTOR WITH SOUNDER

SMOKE DETECTOR WITH CO2 SENSOR

⟨H⟩ | HEAT DETECTOR

DUCT DETECTOR - WITH SAMPLING TUBE

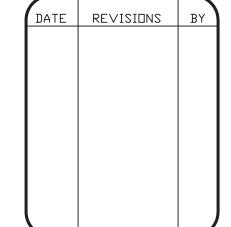
-(S)- | STROBE LIGHT

▼ HORN/STROBE LIGHT

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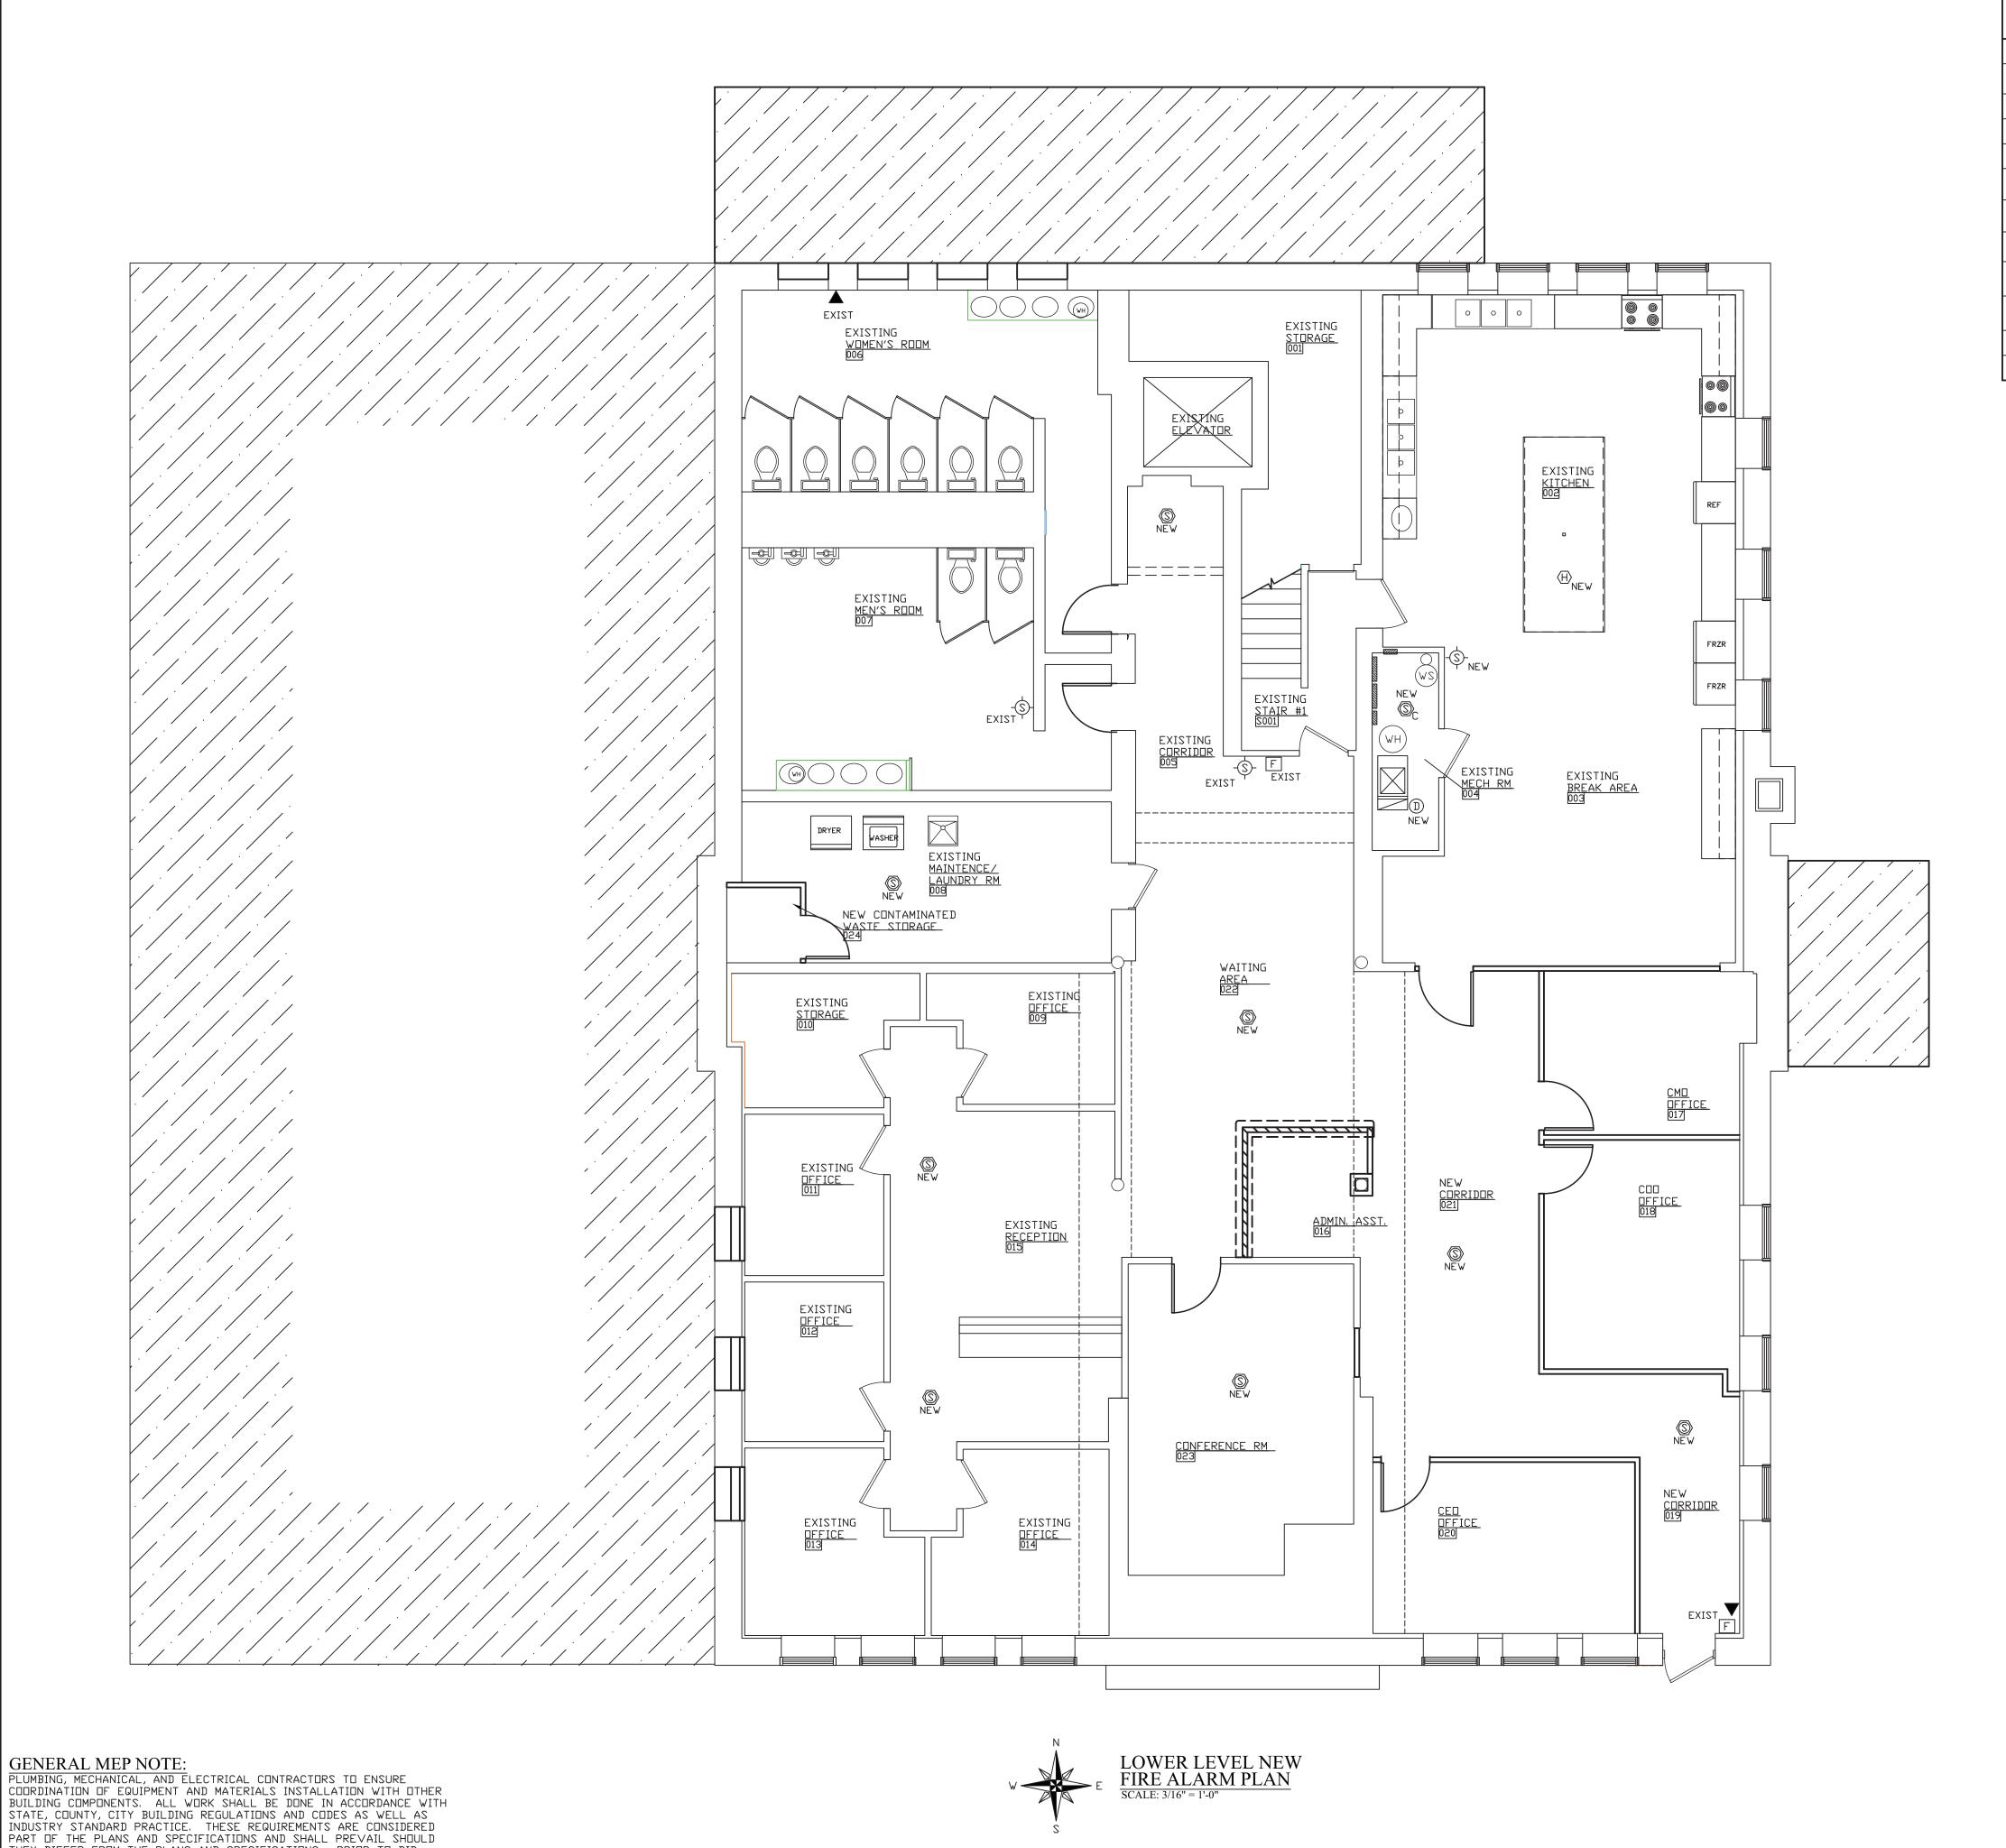
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S SMOKE DETECTOR WITH SOUNDER

S | SMOKE DETECTOR WITH CO2 SENSOR ⟨H⟩ | HEAT DETECTOR

DUCT DETECTOR - WITH SAMPLING TUBE

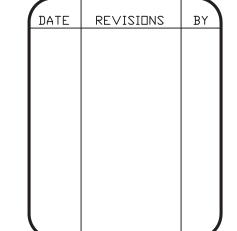
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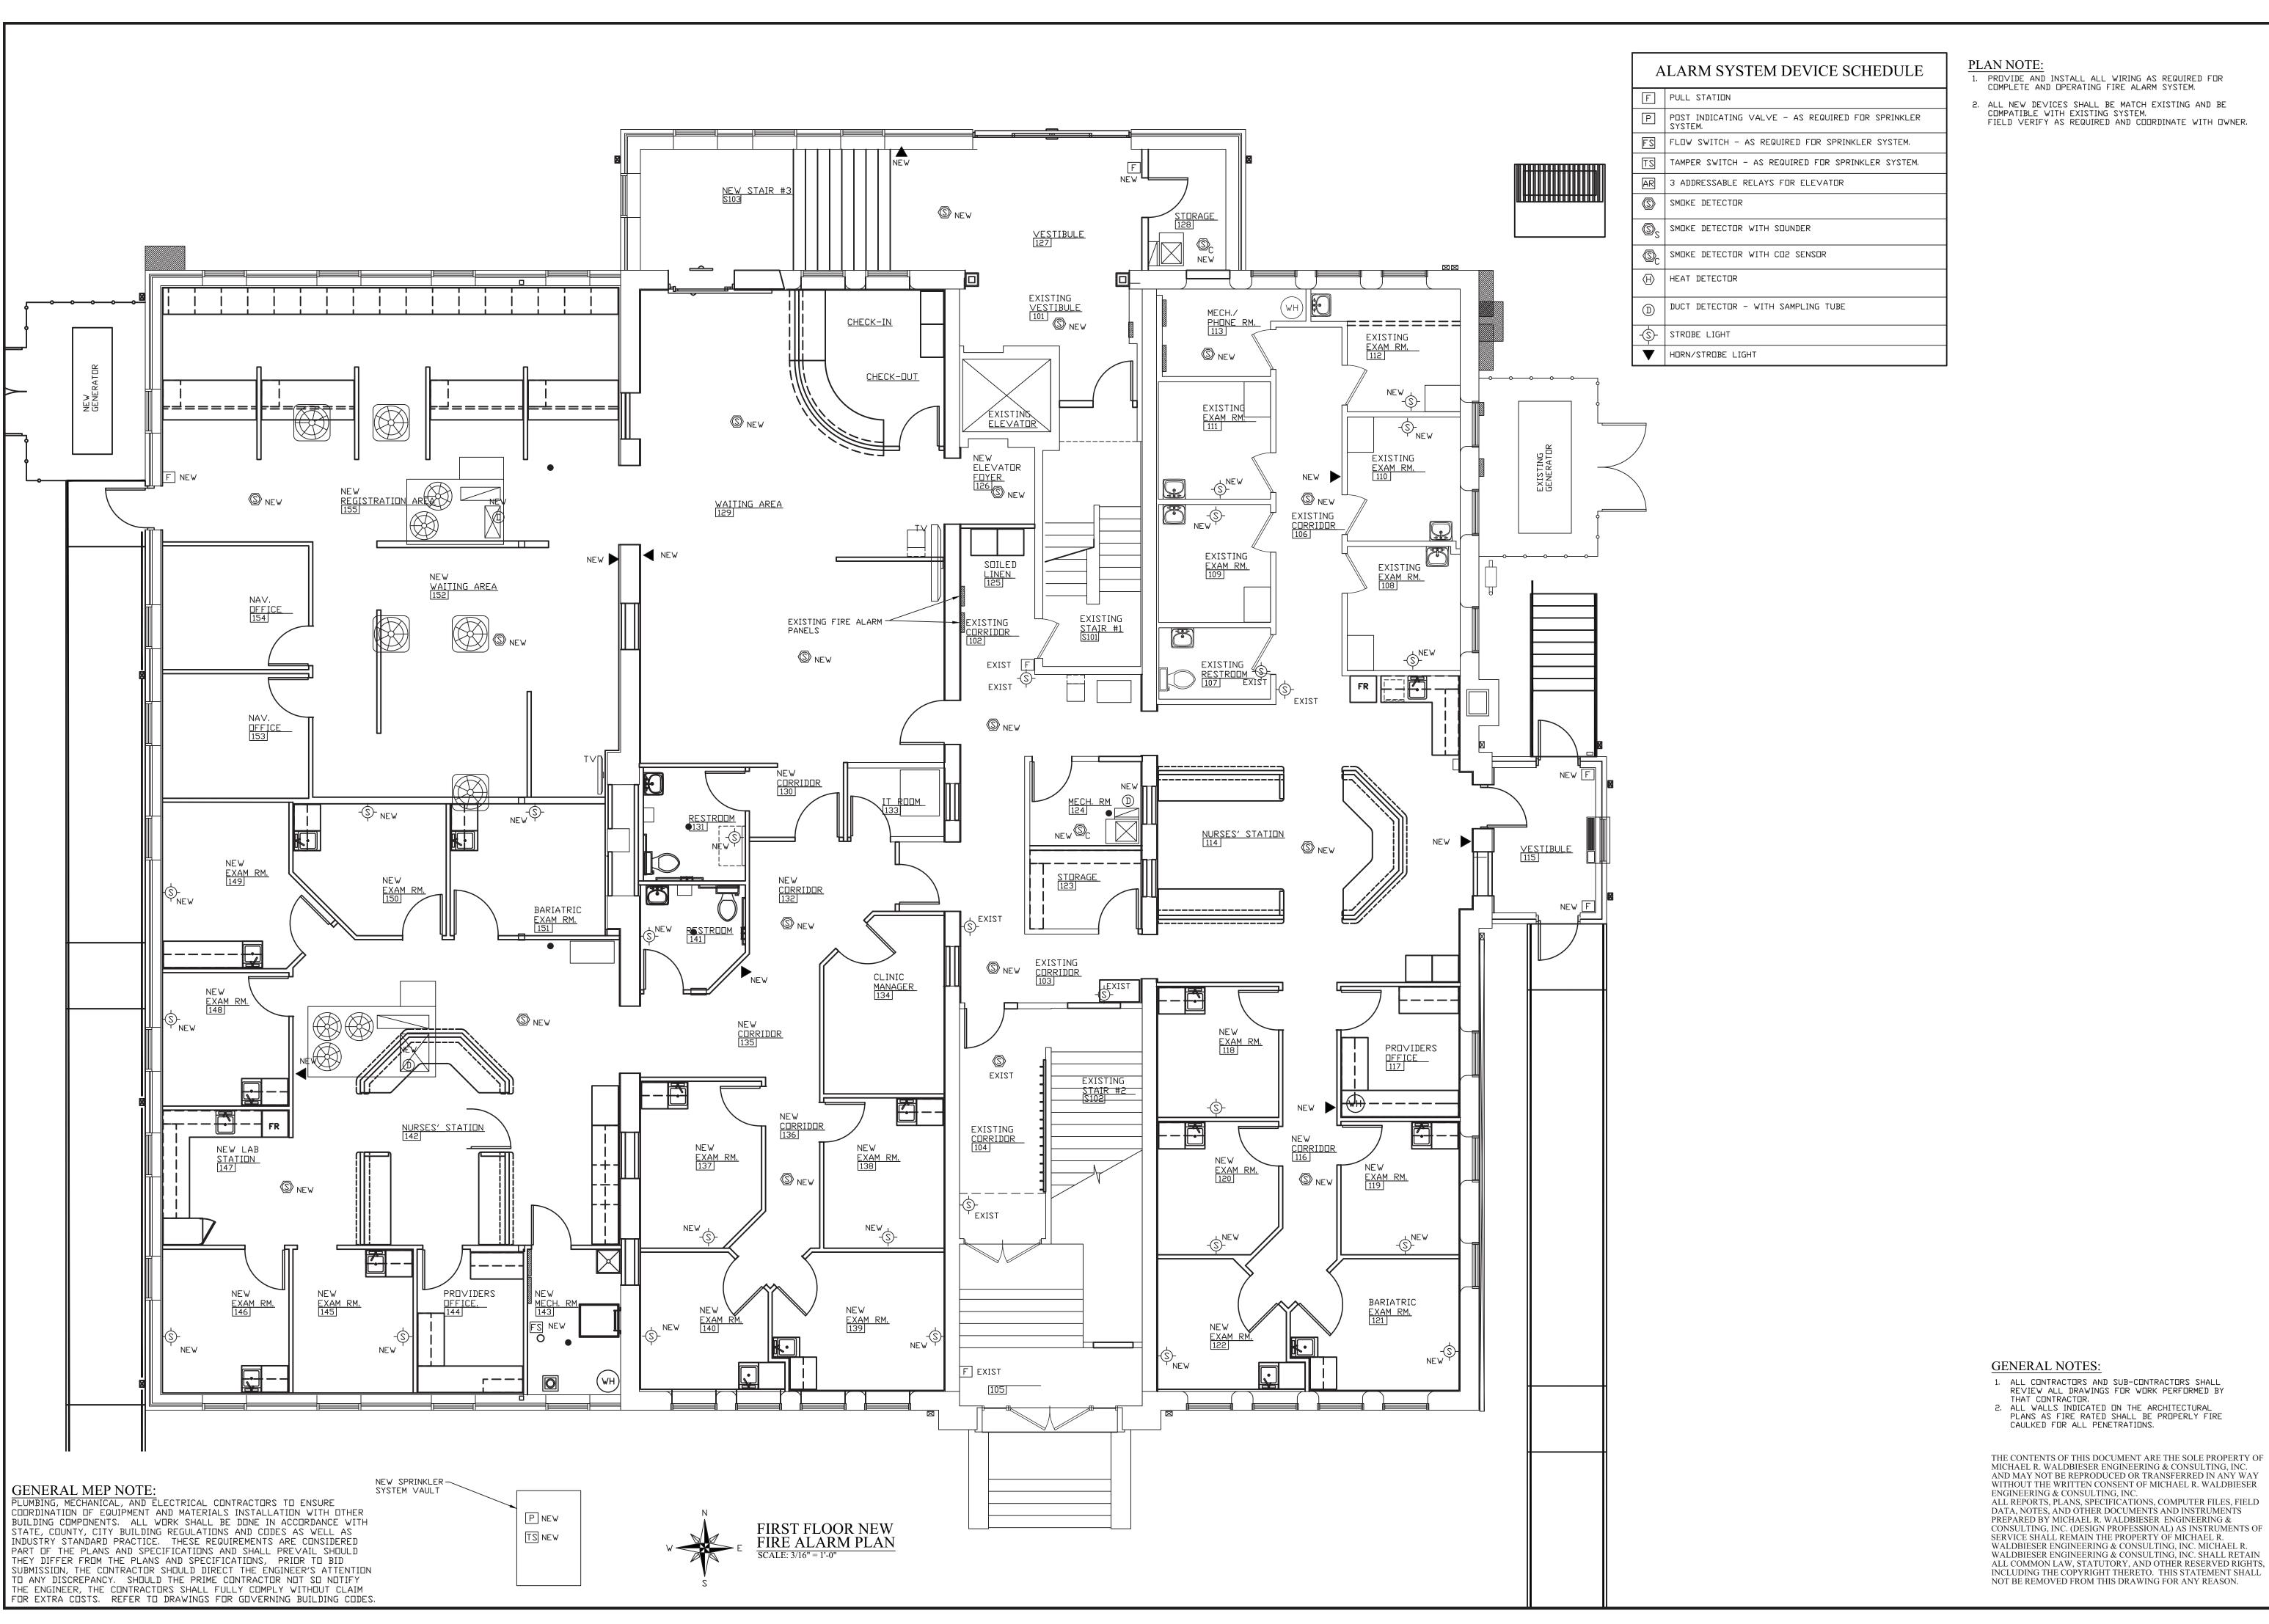
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09-11-19 DATE:

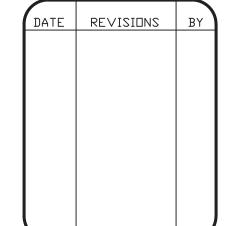
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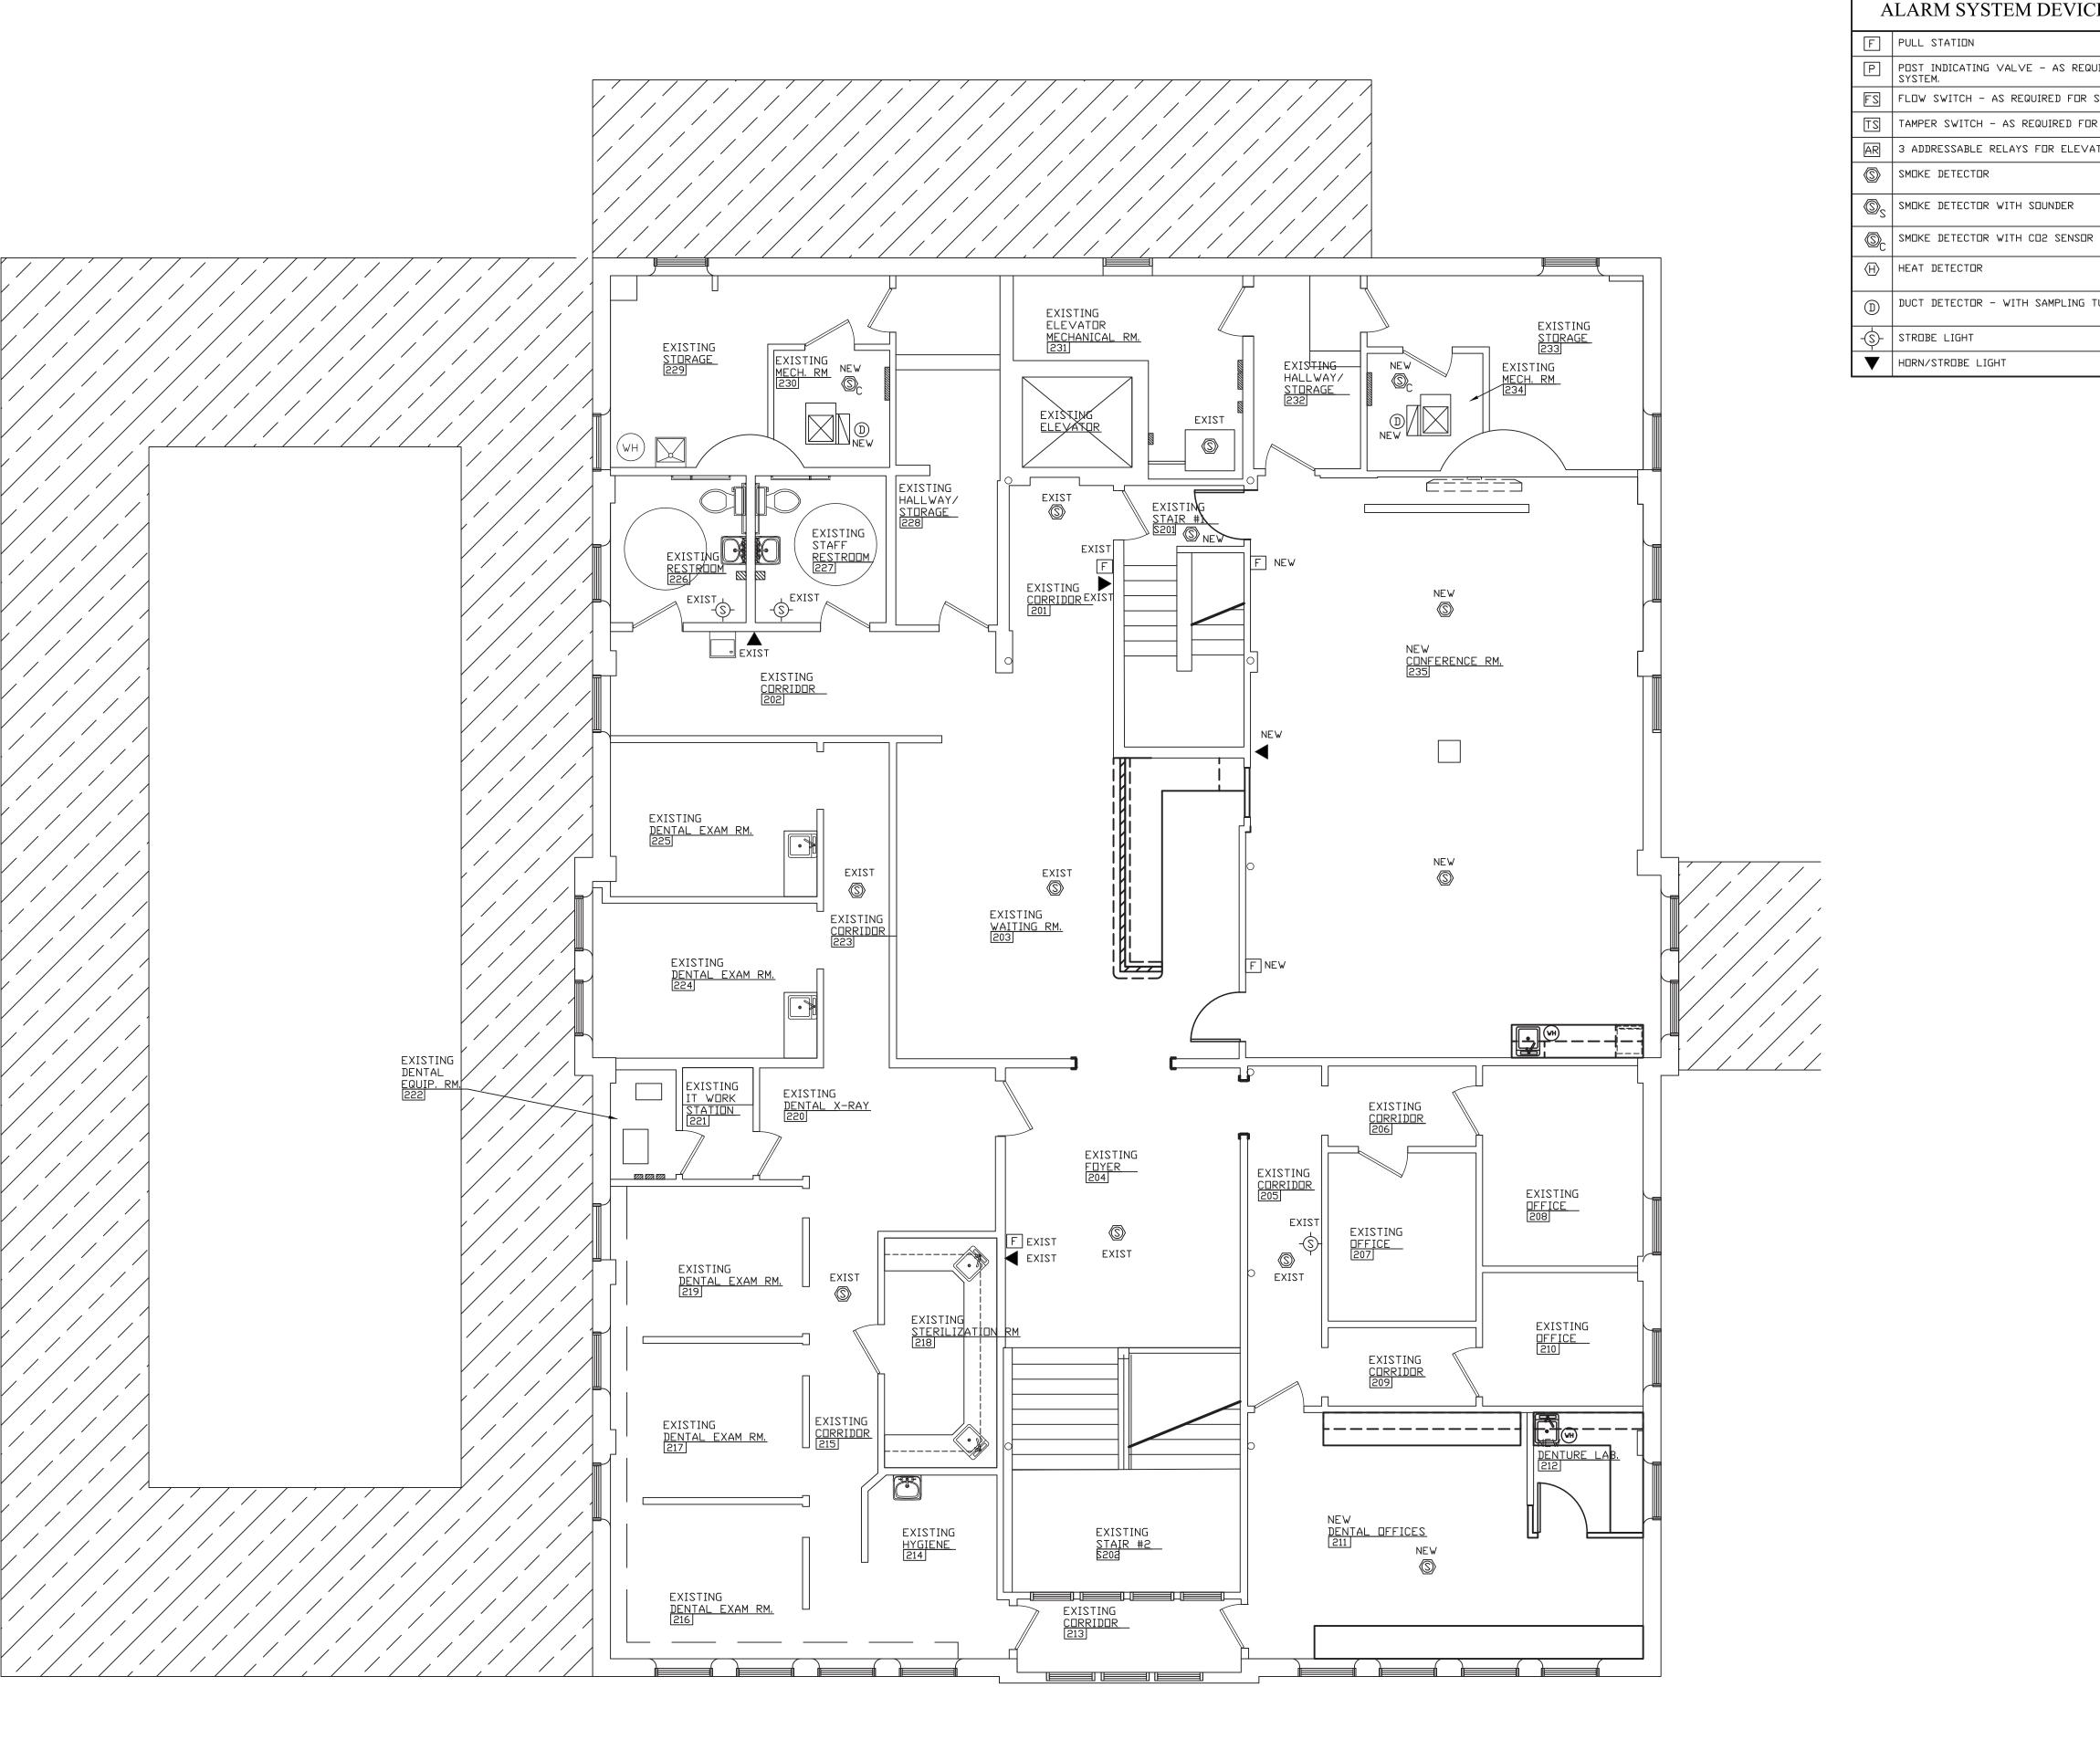


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ALARM SYSTEM DEVICE SCHEDULE

F PULL STATION

P POST INDICATING VALVE - AS REQUIRED FOR SPRINKLER SYSTEM.

FS | FLOW SWITCH - AS REQUIRED FOR SPRINKLER SYSTEM.

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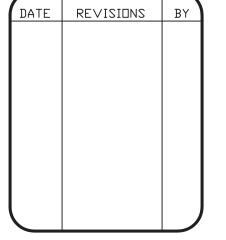
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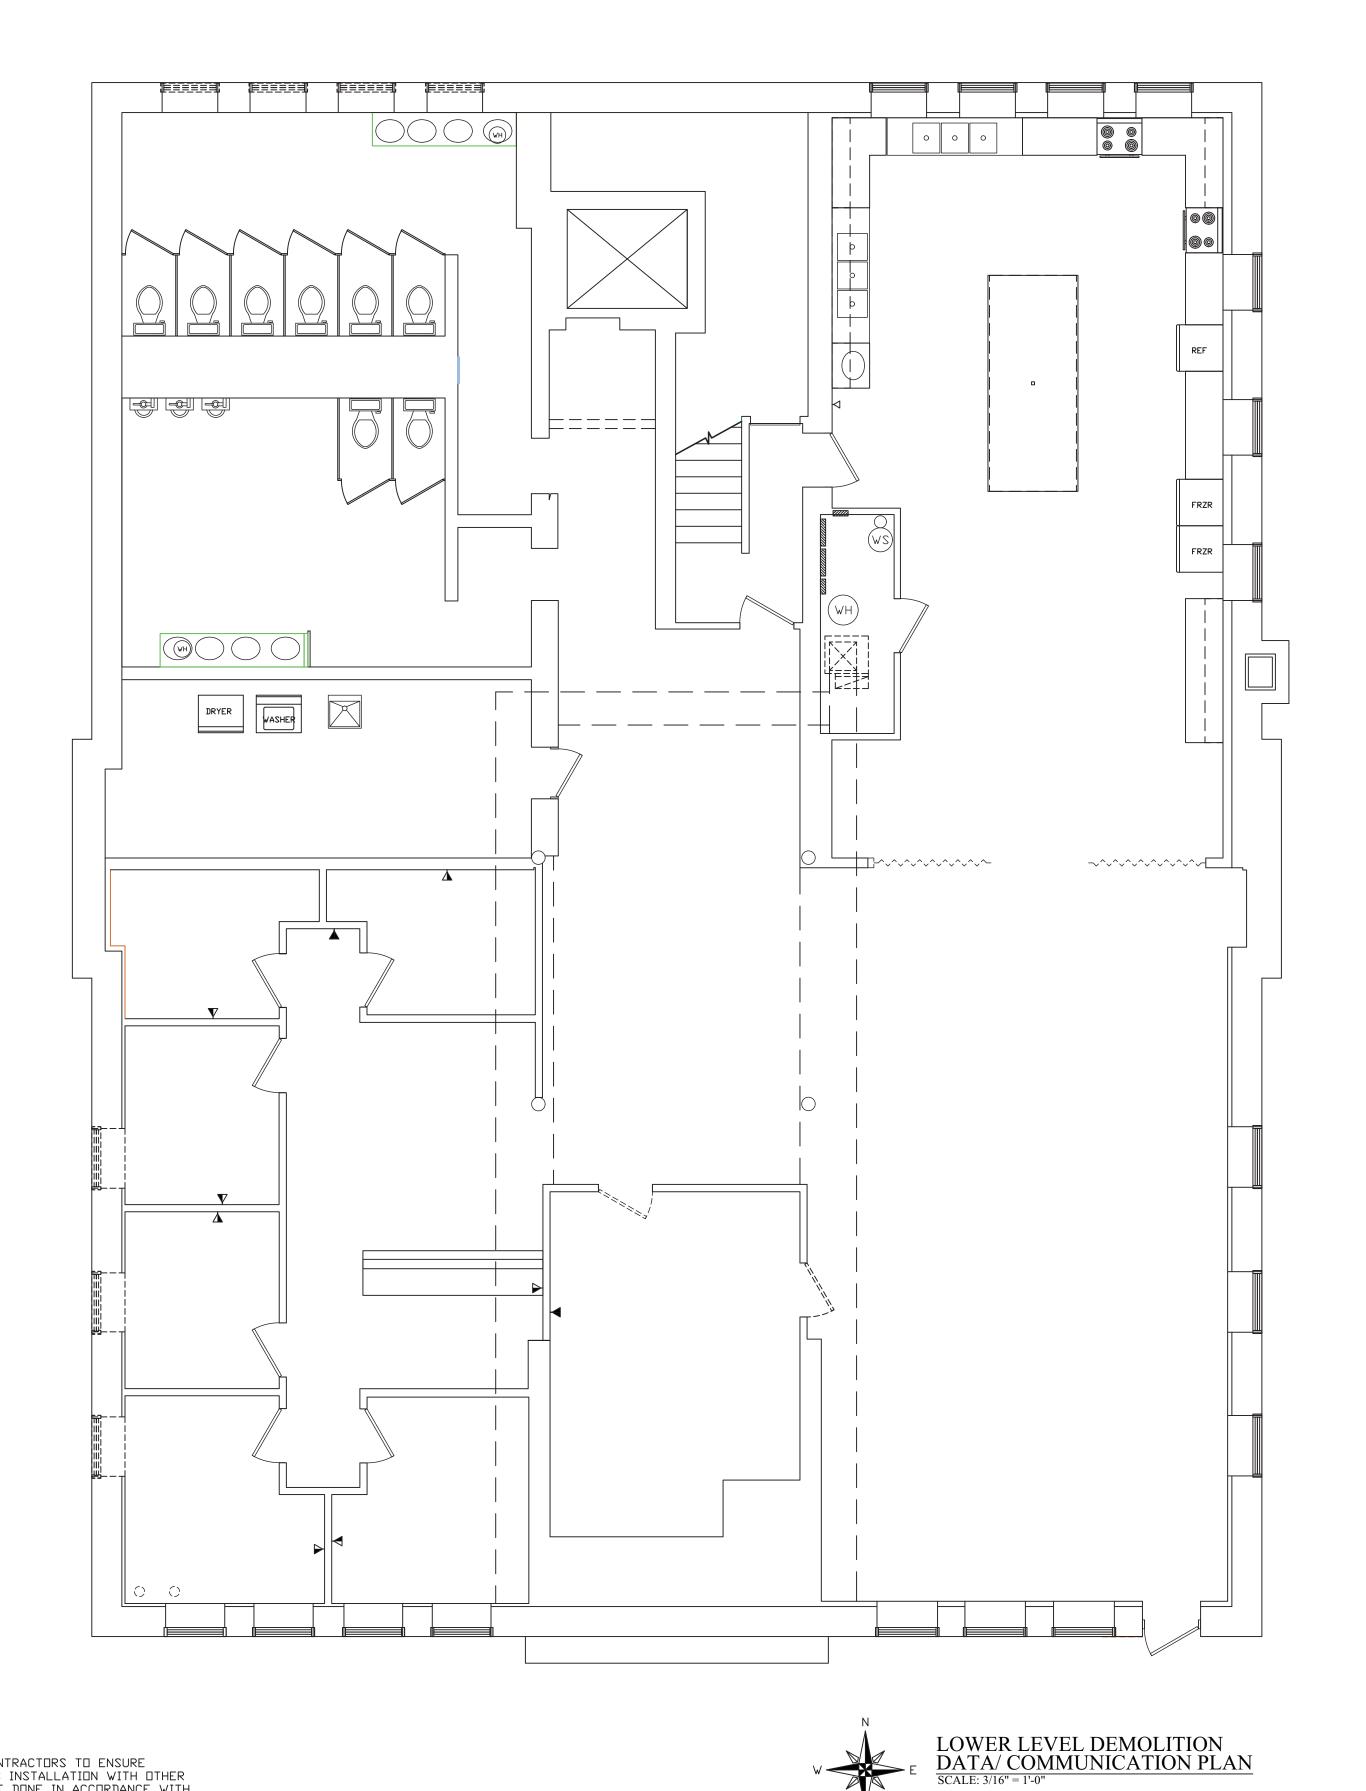
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PROVED BY:

SECOND FLOOR NEW FIRE ALARM PLAN

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- ▼n EXITING DATA DROP TO BE REMOVED COMPLETE
- YD EXISTING TELEPHONE DROP TO BE REMOVED COMPLETE
- Ψ_{D} existing combination data/telephone drop to be removed complete
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- FXISTING TELEPHONE DROP TO REMAIN
- ▼ EXISTING COMBINATION DATA / TELEPHONE DROP TO REMAIN



DATE REVISIONS

WABASH VALLEY HEALTH CENTE 1436 LOCUST STREET TERRE HAUTE, INDIANA 47807

DATE:

GENERAL NOTES:

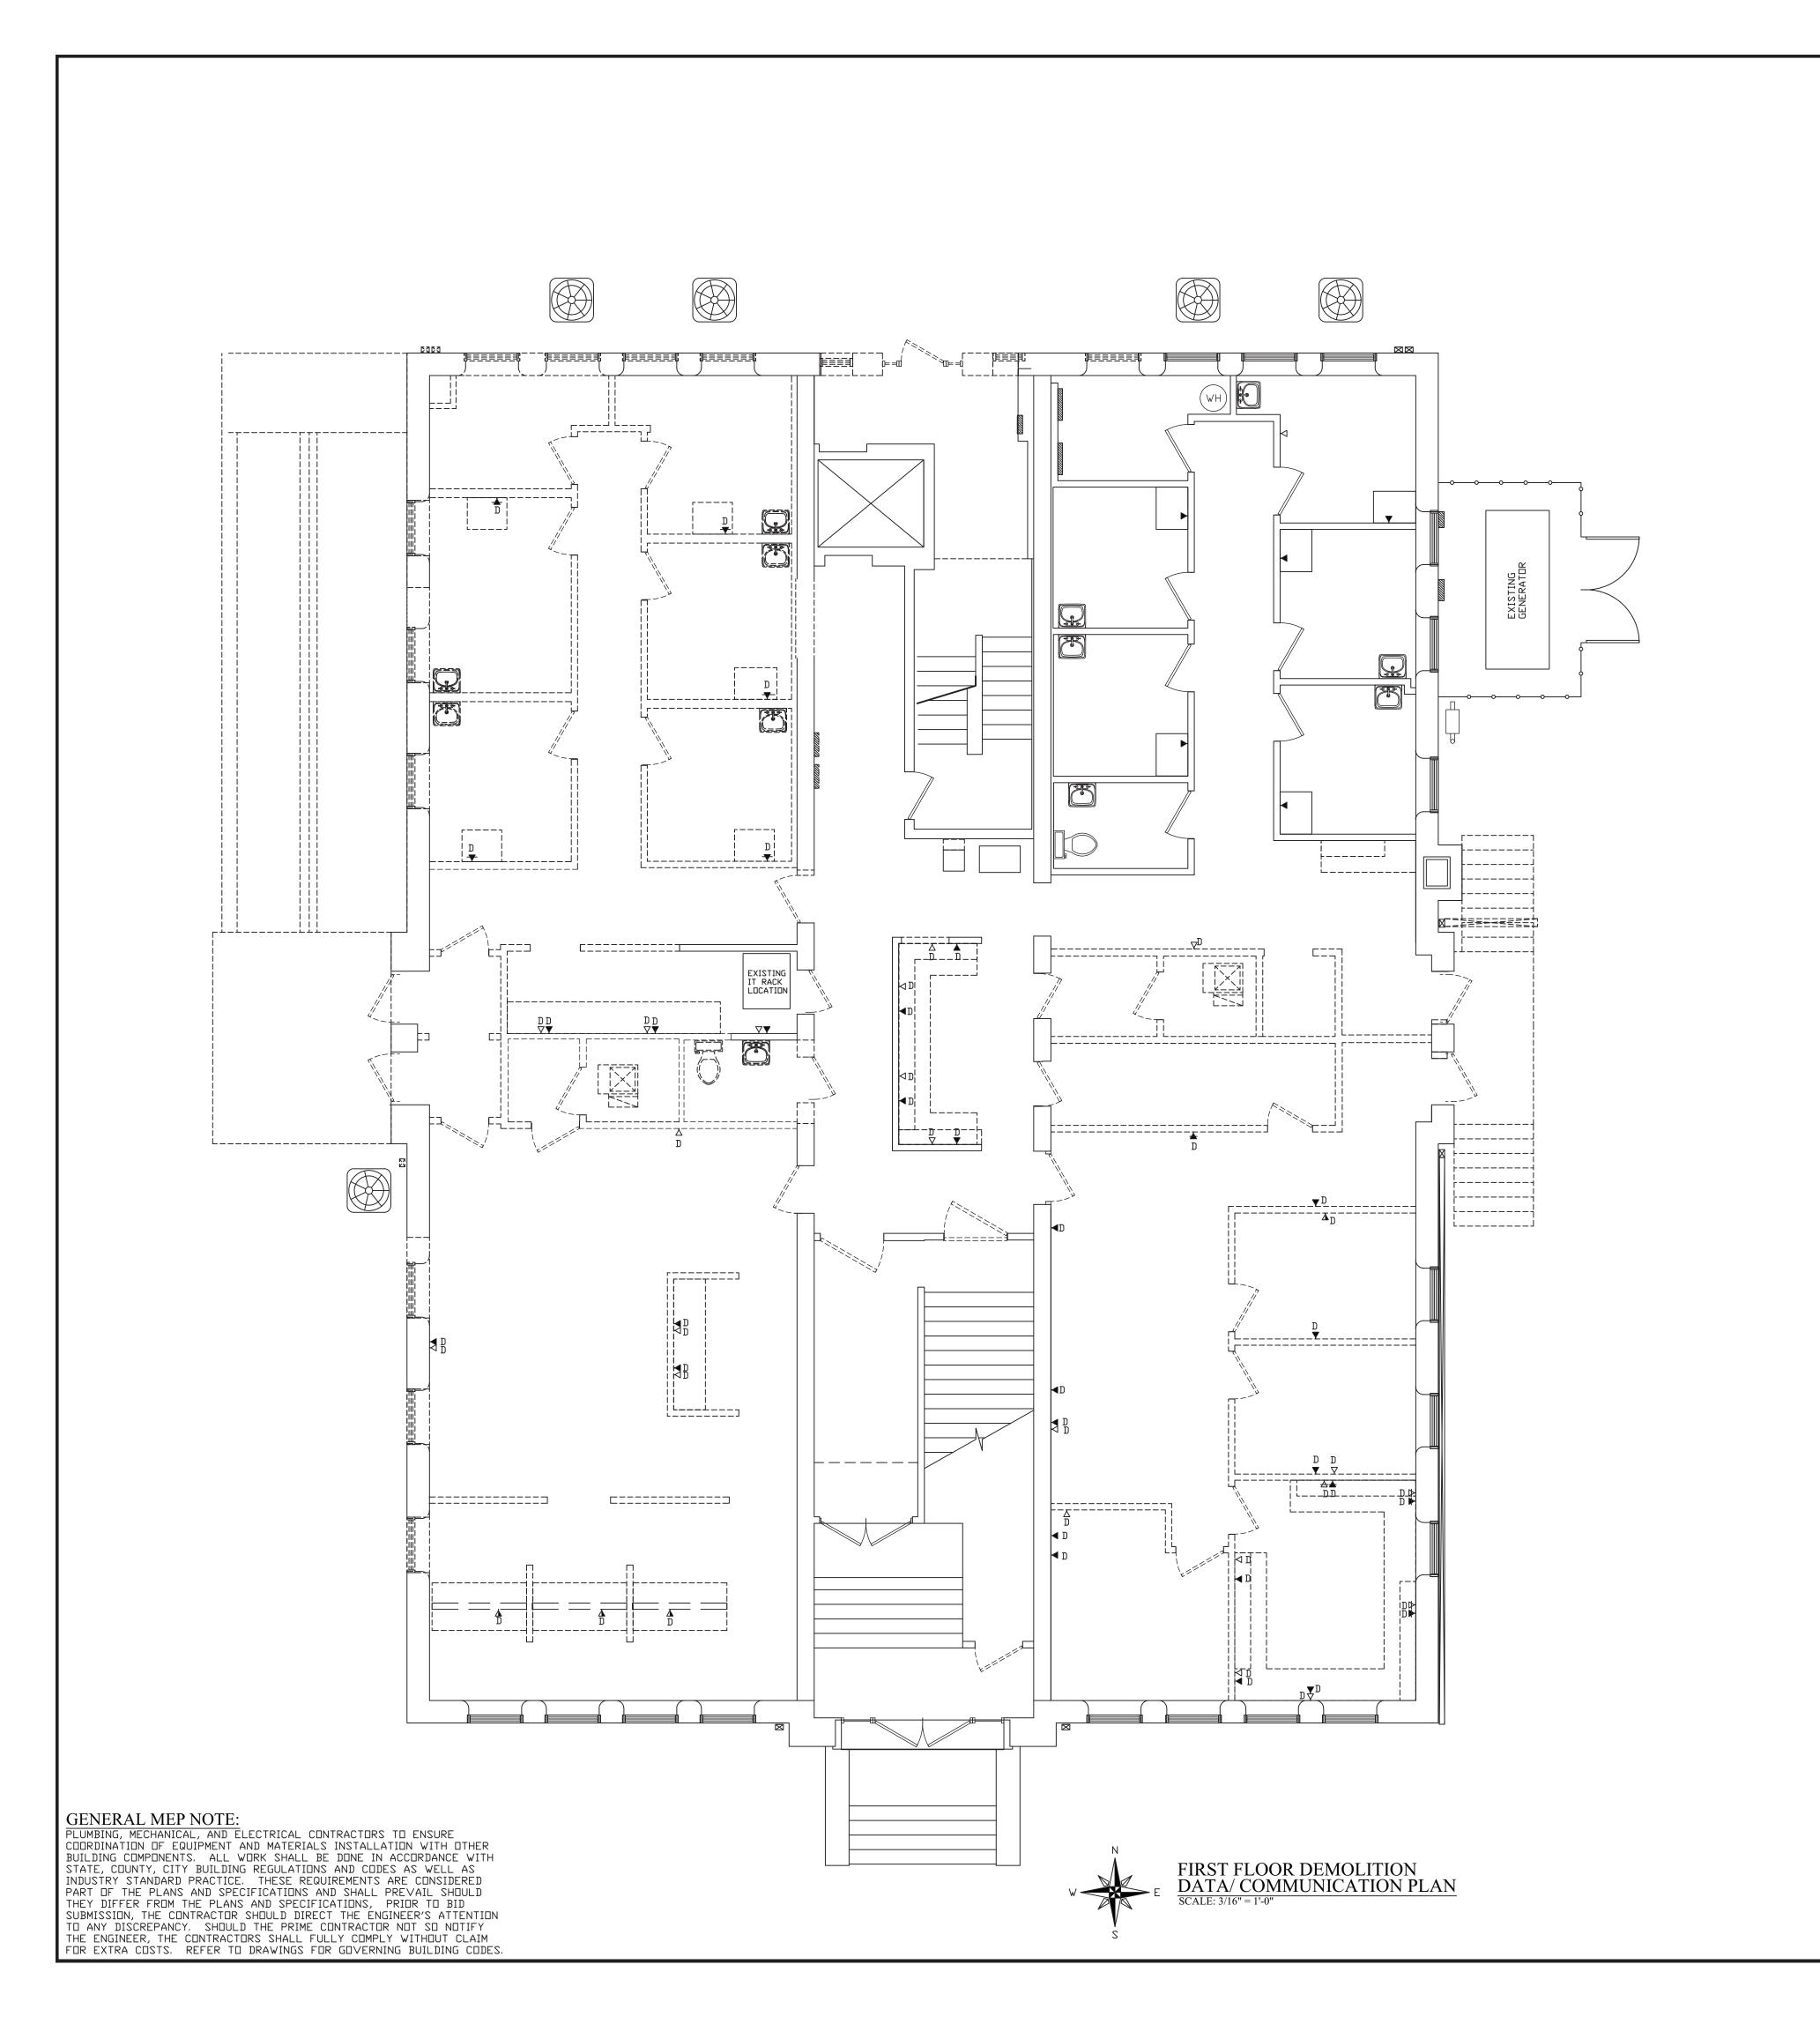
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- ▼D EXITING DATA DROP TO BE REMOVED COMPLETE
- $\nabla_{\mathbf{D}}$ EXISTING TELEPHONE DROP TO BE REMOVED COMPLETE
- \mathbf{v}_{D} existing combination data/telephone drop to be removed complete
- ▼ EXITING DATA DROP TO REMAIN
- Y EXISTING TELEPHONE DROP TO REMAIN
- ▼ EXISTING COMBINATION DATA / TELEPHONE DROP TO REMAIN



DATE REVISIONS



WABASH VALLEY HEALTH CENTE 1436 LOCUST STREET TERRE HAUTE, INDIANA 47807

09-11-19

DATE:

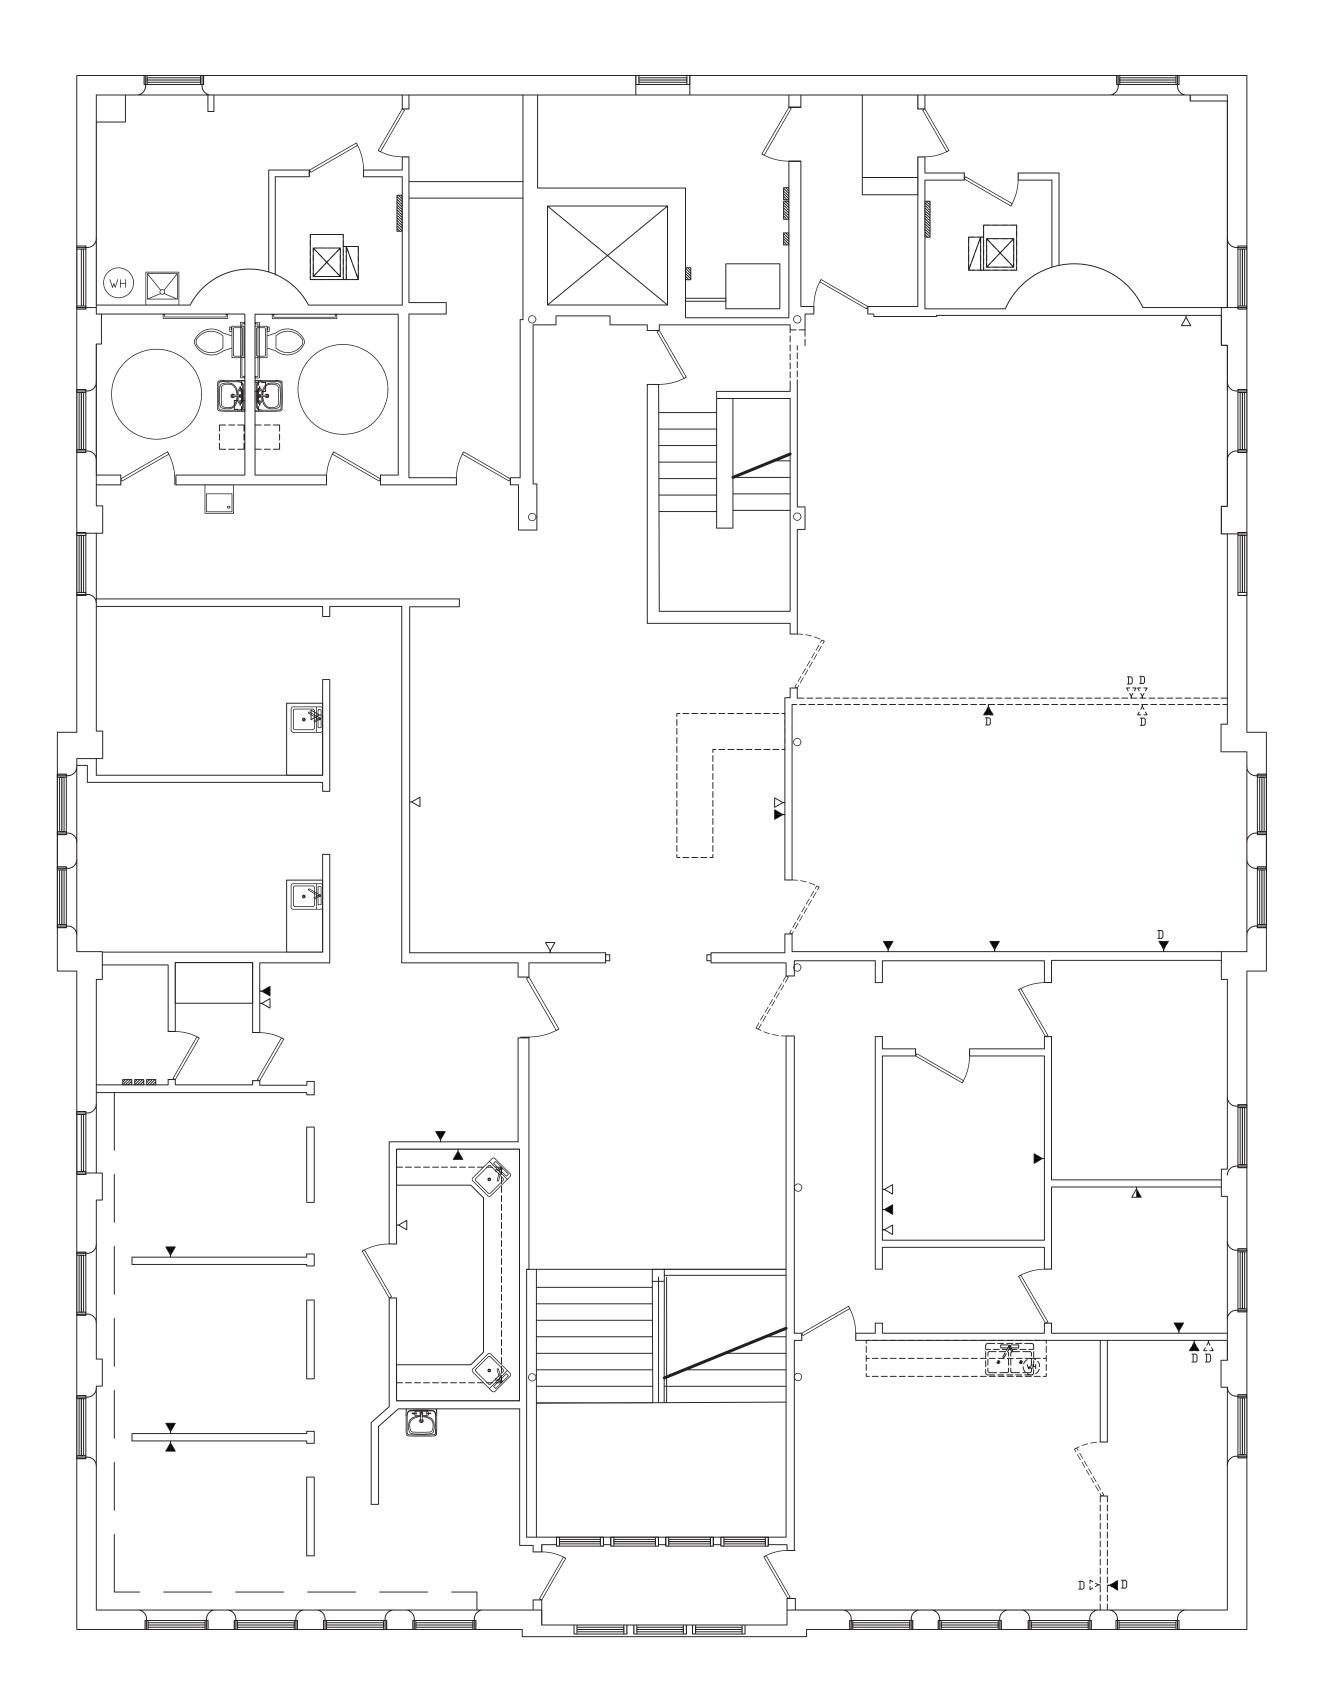
PROJECT: 18-20 FILE: Elec #F

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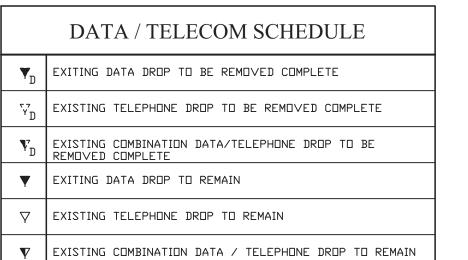


GENERAL MEP NOTE:

PLUMBING, MECHANICAL, AND ELECTRICAL CONTRACTORS TO ENSURE COORDINATION OF EQUIPMENT AND MATERIALS INSTALLATION WITH OTHER BUILDING COMPONENTS. ALL WORK SHALL BE DONE IN ACCORDANCE WITH

STATE, COUNTY, CITY BUILDING REGULATIONS AND CODES AS WELL AS INDUSTRY STANDARD PRACTICE. THESE REQUIREMENTS ARE CONSIDERED PART OF THE PLANS AND SPECIFICATIONS AND SHALL PREVAIL SHOULD THEY DIFFER FROM THE PLANS AND SPECIFICATIONS, PRIOR TO BID

SUBMISSION, THE CONTRACTOR SHOULD DIRECT THE ENGINEER'S ATTENTION TO ANY DISCREPANCY. SHOULD THE PRIME CONTRACTOR NOT SO NOTIFY THE ENGINEER, THE CONTRACTORS SHALL FULLY COMPLY WITHOUT CLAIM FOR EXTRA COSTS. REFER TO DRAWINGS FOR GOVERNING BUILDING CODES.





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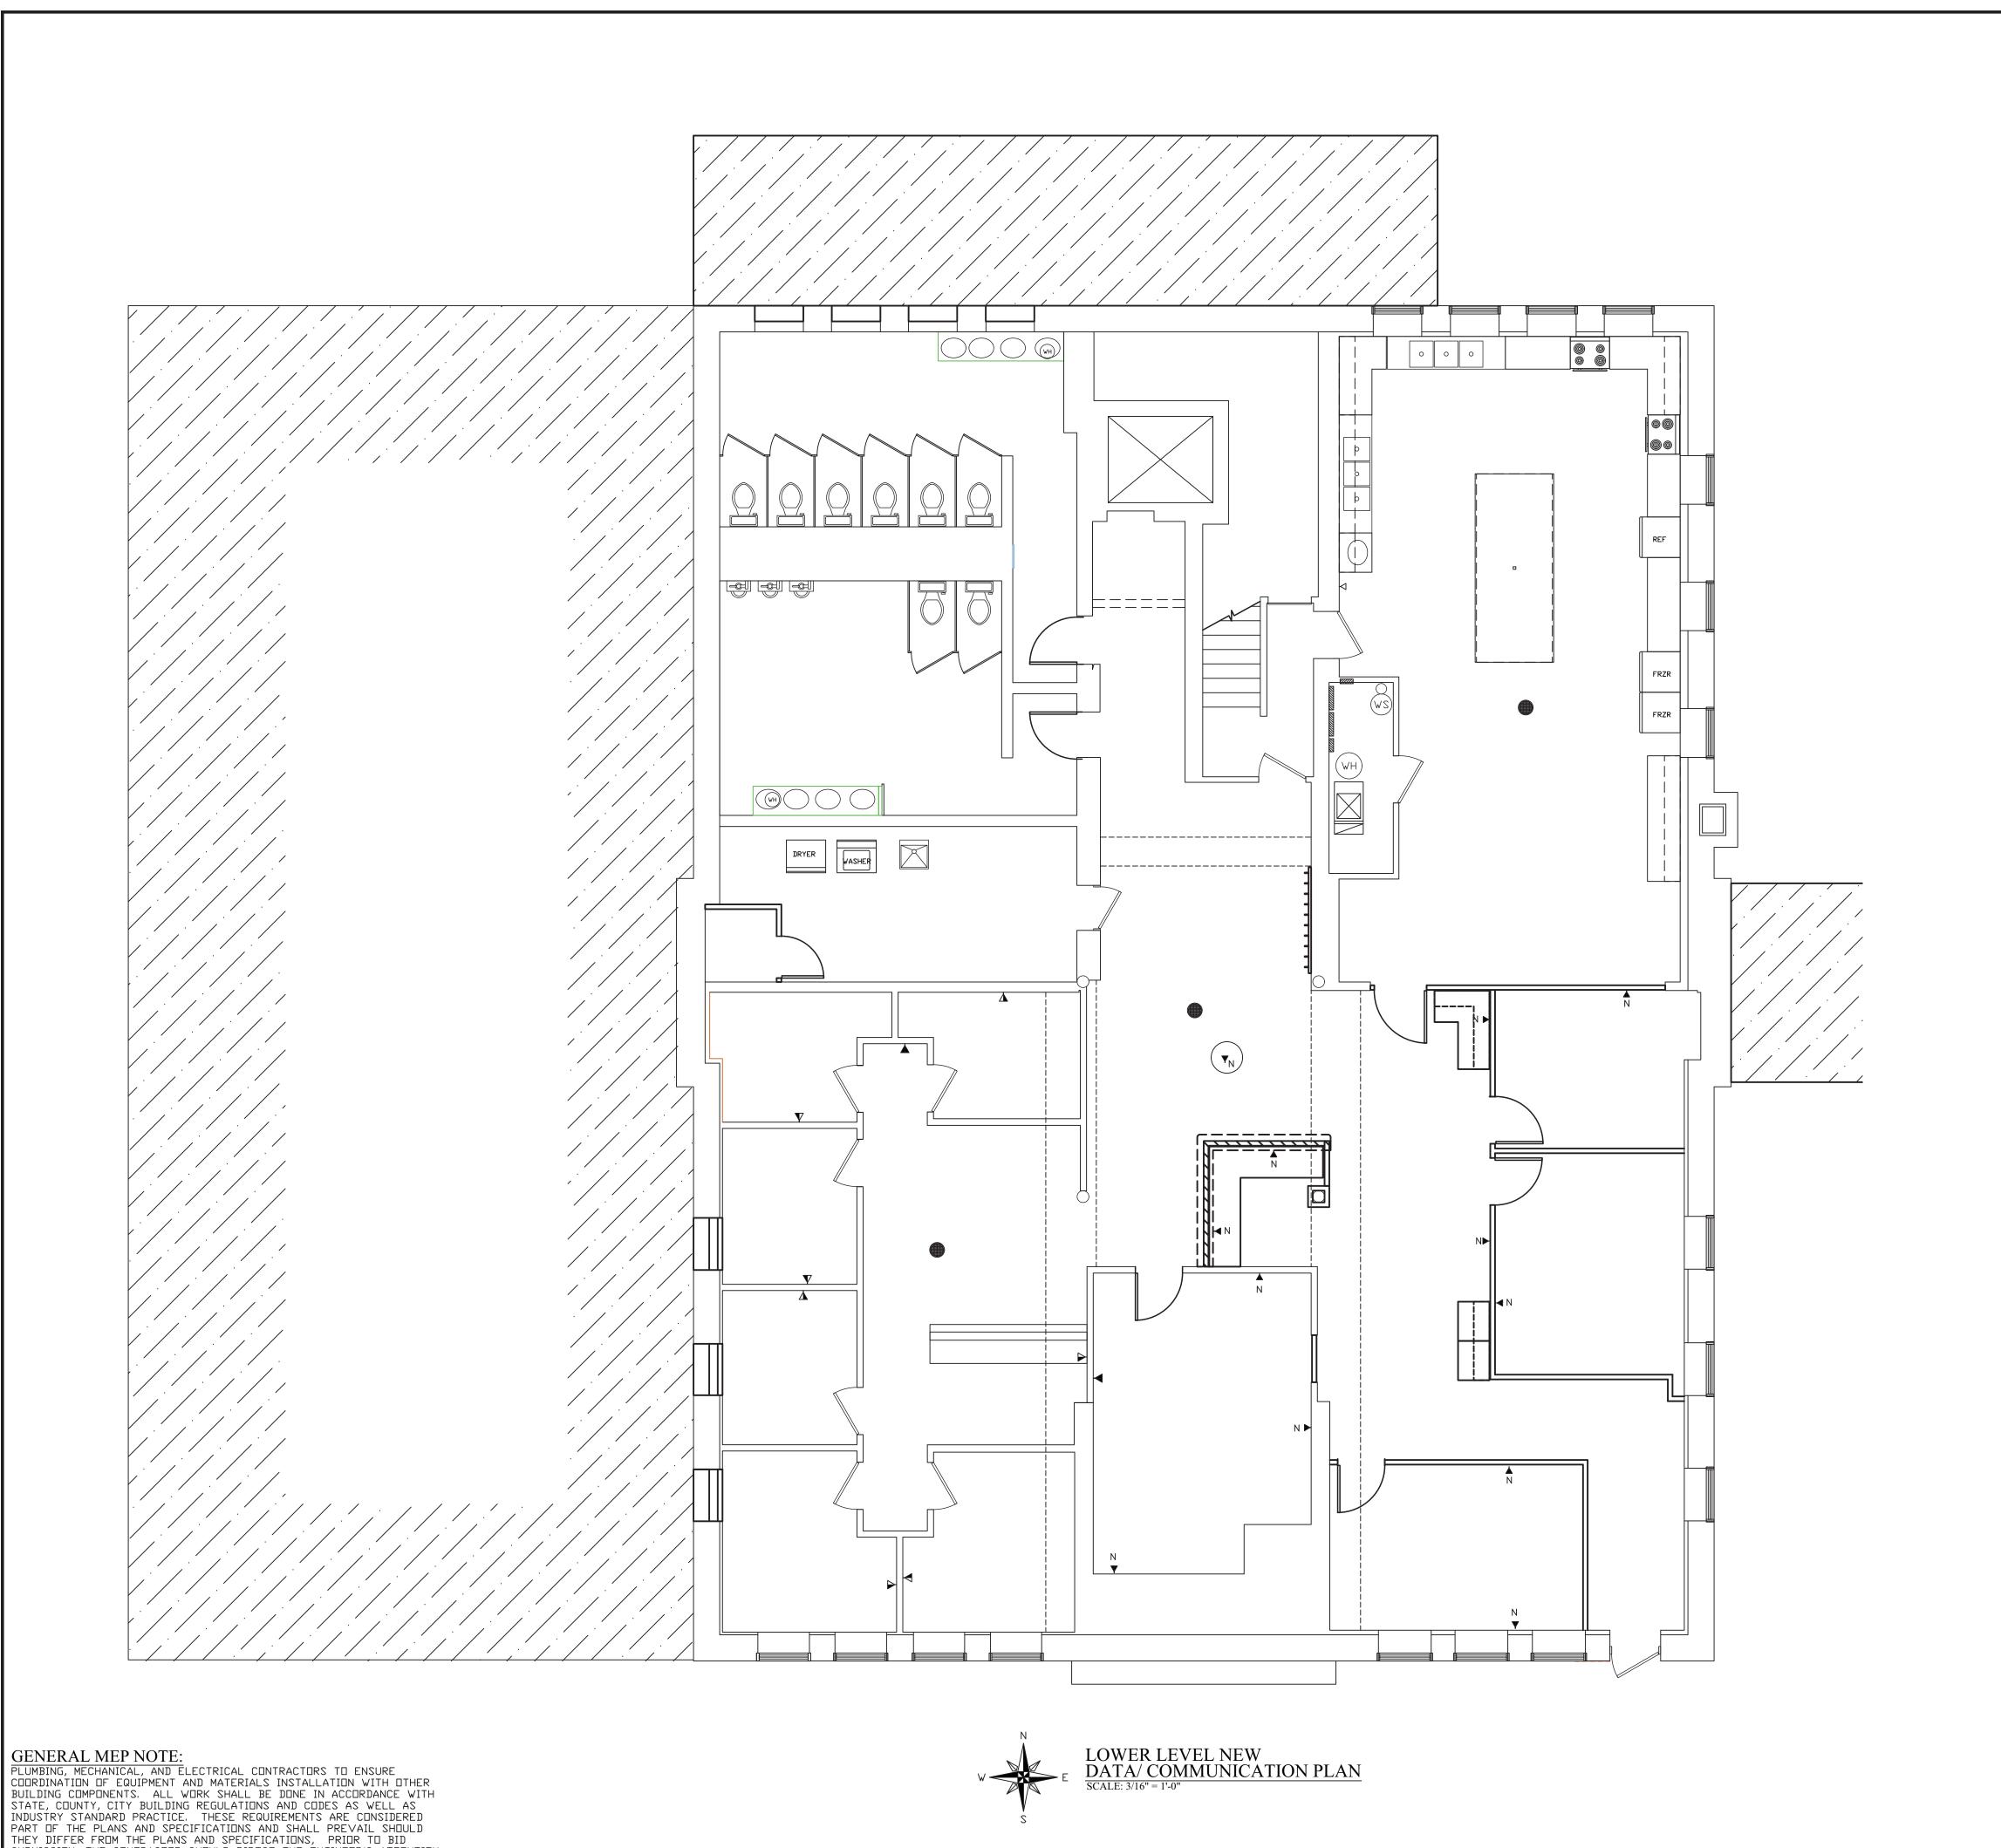
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DATE: PROJECT: 18-20 FILE: Elec #F

SECOND FLOOR DEMOLITION DATA/ COMMUNICATION PLAN



SUBMISSION, THE CONTRACTOR SHOULD DIRECT THE ENGINEER'S ATTENTION

TO ANY DISCREPANCY. SHOULD THE PRIME CONTRACTOR NOT SO NOTIFY THE ENGINEER, THE CONTRACTORS SHALL FULLY COMPLY WITHOUT CLAIM FOR EXTRA COSTS. REFER TO DRAWINGS FOR GOVERNING BUILDING CODES.



▼ EXITING DATA DROP TO REMAIN

▼ EXISTING TELEPHONE DROP TO REMAIN

▼ EXISTING COMBINATION DATA / TELEPHONE DROP TO REMAIN

NEW DATA LOCATION COMPLETE BY E.C.
LOCATE AT +16" AFF
RUN COPPER CATGE CABLE FROM THIS LOCATION BACK TO
EXISTING IT RACK.
PROVIDE TERMINATION AT NEW LOCATION TO COORDINATE

WITH DWNERS EQUIPMENT.

PROVIDE EXTRA 10'-0 LENGTH AT EXISTING IT RACK TO BE USED BY THE DWNER.

CONNECTION TO EXISTING IT RACK BY DWNER COMPLETE. TESTING OF NEW CATGE BY ELECTRICAL CONTRACTOR.

NEW DATA LOCATION COMPLETE BY E.C. WIFI ROUTER. LOCATE ABOVE CEILING.
RUN COPPER CATGE CABLE FROM THIS LOCATION BACK TO
EXISTING IT RACK.
PROVIDE TERMINATION AT NEW LOCATION TO COORDINATE

WITH DWNERS EQUIPMENT.

PROVIDE EXTRA 10'-0 LENGTH AT EXISTING IT RACK TO BE USED BY THE DWNER.

CONNECTION TO EXISTING IT RACK BY DWNER COMPLETE. TESTING OF NEW CATGE BY ELECTRICAL CONTRACTOR.

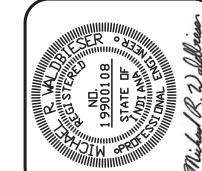
NEW DATA LOCATION COMPLETE BY E.C. WIFI ROUTER. LOCATE ABOVE CEILING.
RUN COPPER CATGE CABLE FROM THIS LOCATION BACK TO EXISTING IT RACK.
PROVIDE TERMINATION AT NEW LOCATION TO COORDINATE WITH OWNERS EQUIPMENT.

PROVIDE EXTRA 10'-0 LENGTH AT EXISTING IT RACK TO BE USED BY THE OWNER.

CONNECTION TO EXISTING IT RACK BY OWNER COMPLETE.

TESTING OF NEW CATGE BY ELECTRICAL CONTRACTOR.

NEW PAGING SPEAKER LOCATION. PROVIDED AND INSTALLED BY E.C. WIRING PROVIDED AND INSTALLED TO EXISTING OWNERS EQUIPMENT COMPLETE BY E.C.



DATE REVISIONS

WABASH VALLEY HEA 1436 LOCUST STREET TERRE HAUTE, INDIAN

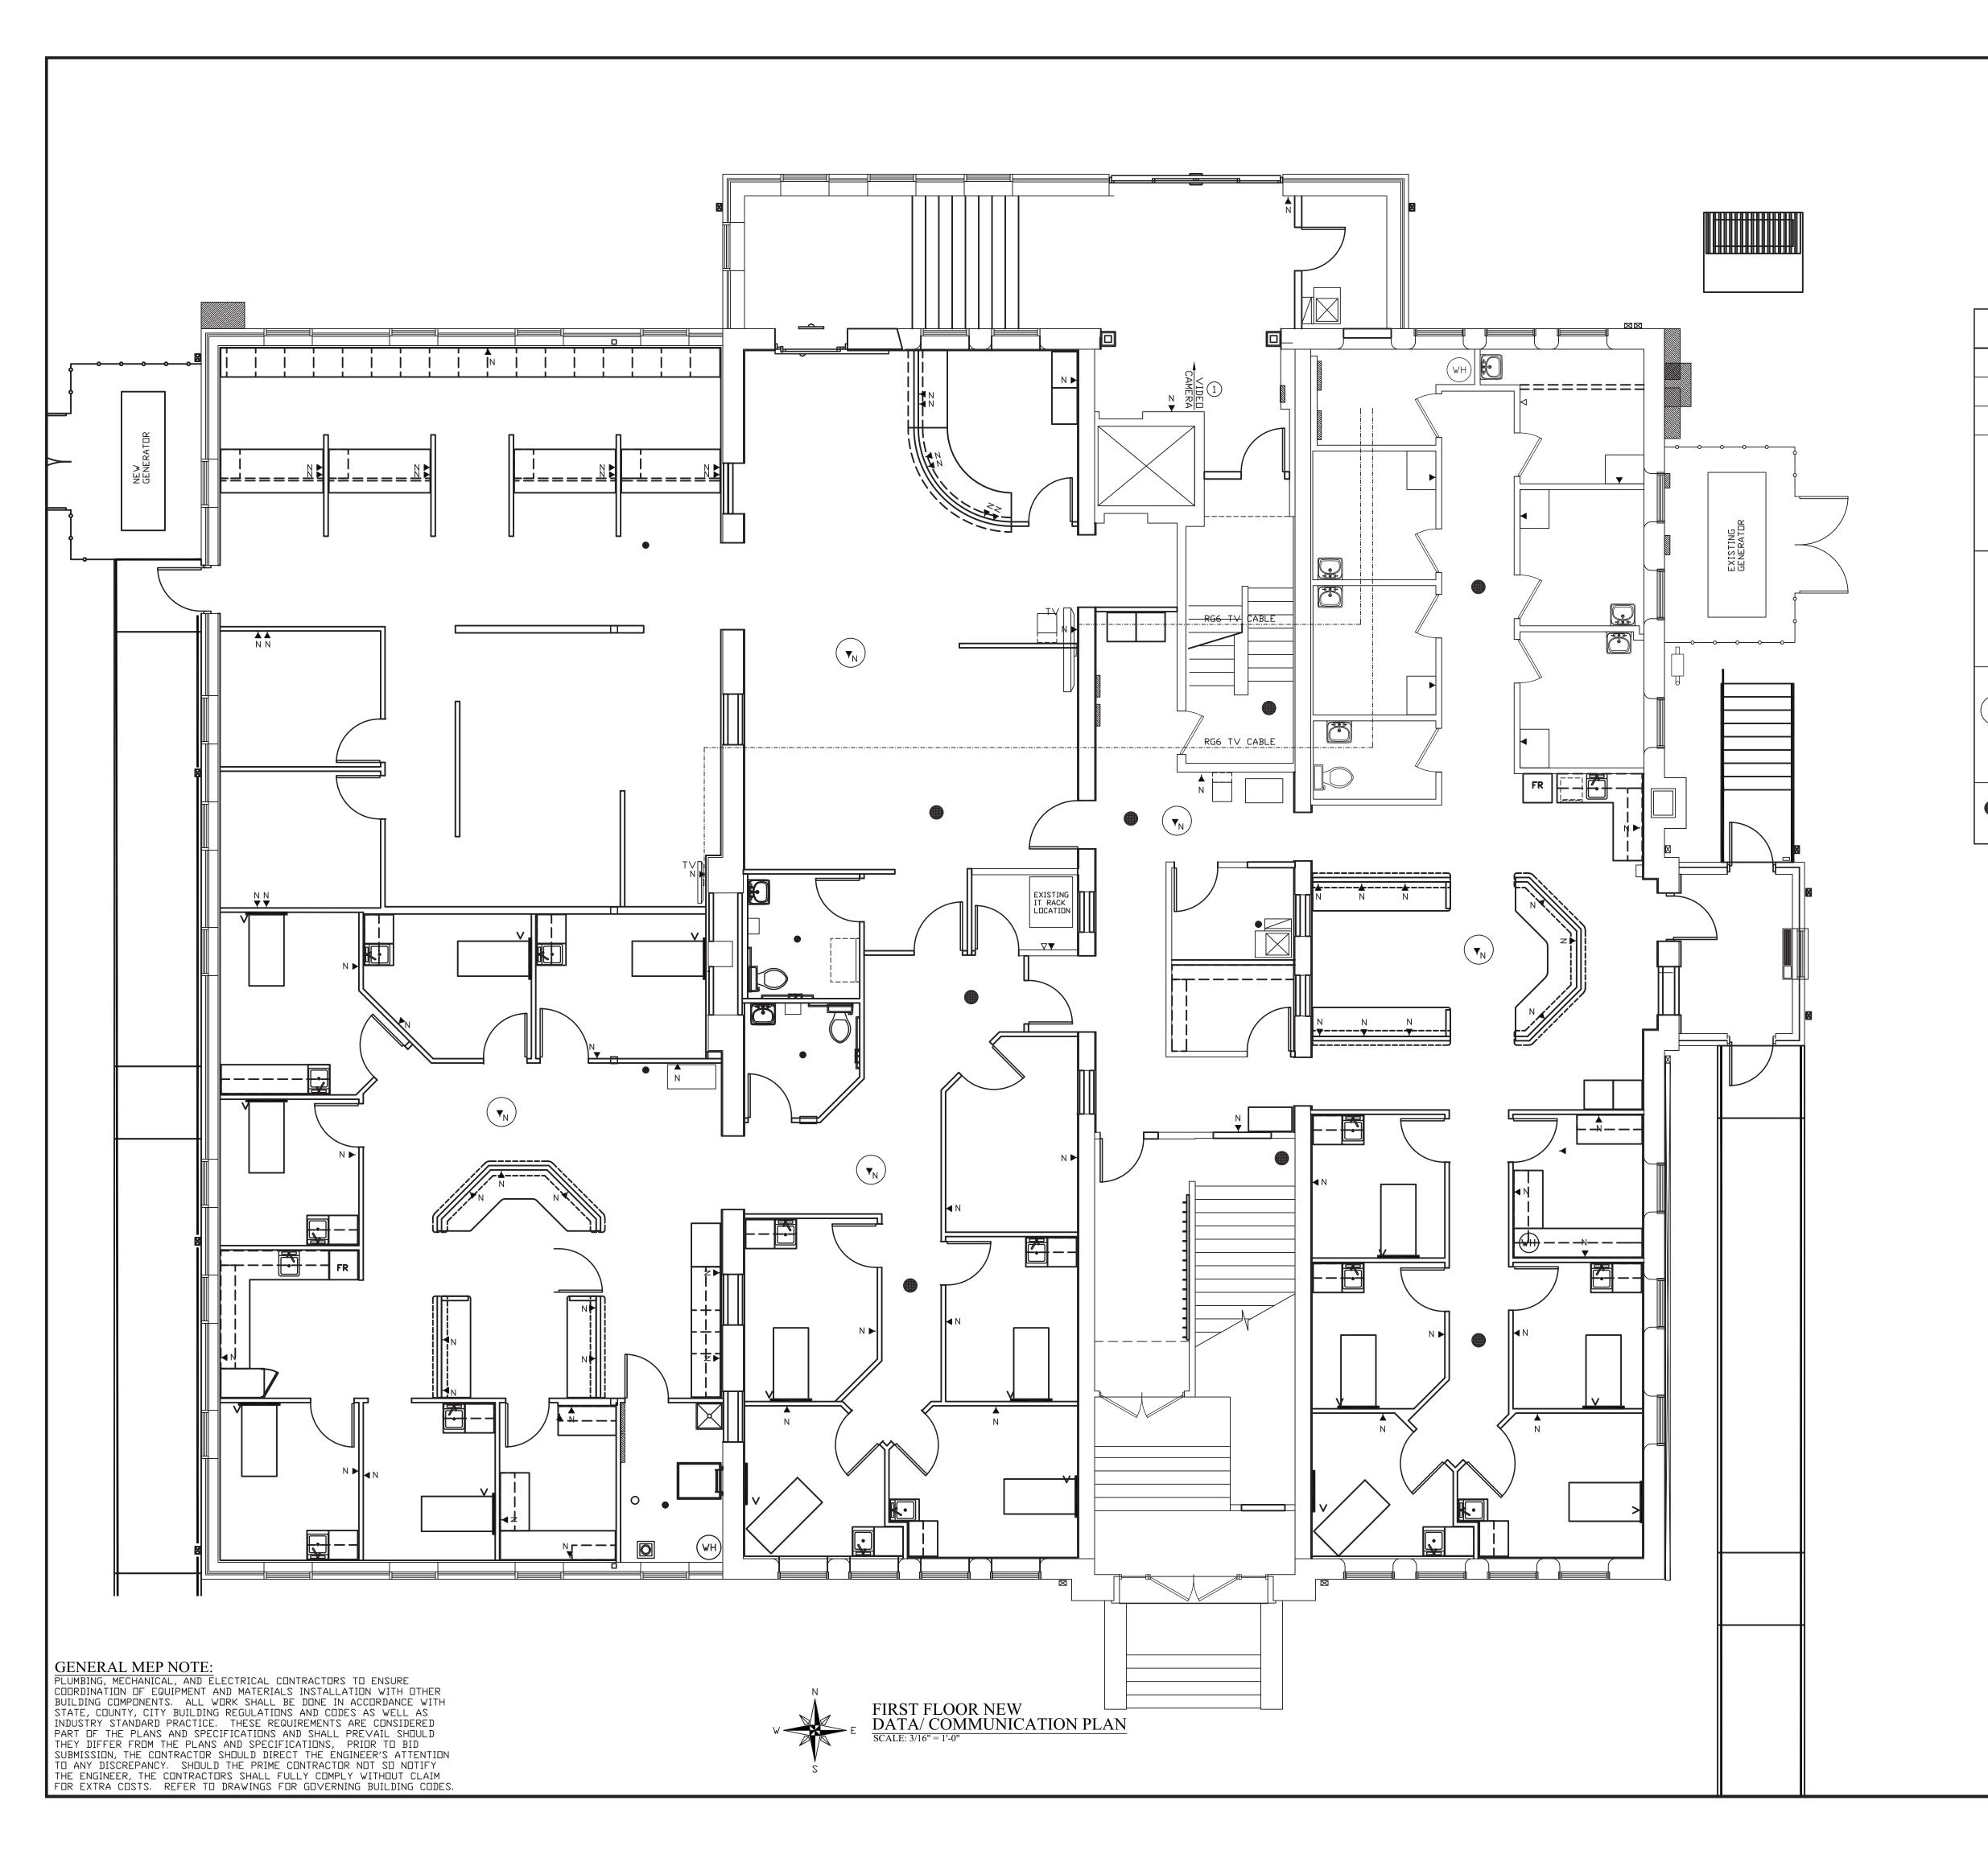
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- ▼ EXITING DATA DROP TO REMAIN
- ▼ EXISTING TELEPHONE DROP TO REMAIN

- EXISTING IT RACK.
 PROVIDE TERMINATION AT NEW LOCATION TO COORDINATE WITH DWNERS EQUIPMENT. PROVIDE EXTRA 10'-0 LENGTH AT EXISTING IT RACK TO BE USED BY THE OWNER.
 CONNECTION TO EXISTING IT RACK BY OWNER COMPLETE.
 TESTING OF NEW CATGE BY ELECTRICAL CONTRACTOR.
- LOCATE ABOVE CEILING.
 RUN COPPER CATGE CABLE FROM THIS LOCATION BACK TO EXISTING IT RACK.
 PROVIDE TERMINATION AT NEW LOCATION TO COORDINATE WITH DWNERS EQUIPMENT.

 PROVIDE EXTRA 10'-0 LENGTH AT EXISTING IT RACK TO BE USED BY THE OWNER. CONNECTION TO EXISTING IT RACK BY OWNER COMPLETE.
 TESTING OF NEW CATGE BY ELECTRICAL CONTRACTOR.
- NEW DATA LOCATION COMPLETE BY E.C. WIFI ROUTER. LOCATE ABOVE CEILING.
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 CONNECTION TO EXISTING IT RACK BY DWNER COMPLETE. TESTING OF NEW CATGE BY ELECTRICAL CONTRACTOR.
- NEW PAGING SPEAKER LOCATION. PROVIDED AND INSTALLED BY E.C. WIRING PROVIDED AND INSTALLED TO EXISTING DWNERS EQUIPMENT COMPLETE BY E.C.

SECURITY CAMERA SHALL BE PROVIDED BY THE OWNER AND INSTALLED COMPLETE BY THE ELECTRICAL CONTRACTOR.

ELECTRICAL CONTRACTOR SHALL RUN COPPER CAT6E CABLE FROM NEW CAMERA LOCATION BACK TO EXISTING IT RACK LOCATION

CONNECTION TO EXISTING IT RACK COMPLETE BY

PROVIDE EXTRA 10'-0 ON EACH END OF CABLE FOR POSSIBLE CAMERA RELOCATION.

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 $oldsymbol{
abla}$ EXISTING COMBINATION DATA / TELEPHONE DROP TO REMAIN

NEW DATA LOCATION COMPLETE BY E.C.
LOCATE AT +16" AFF
RUN COPPER CATGE CABLE FROM THIS LOCATION BACK TO

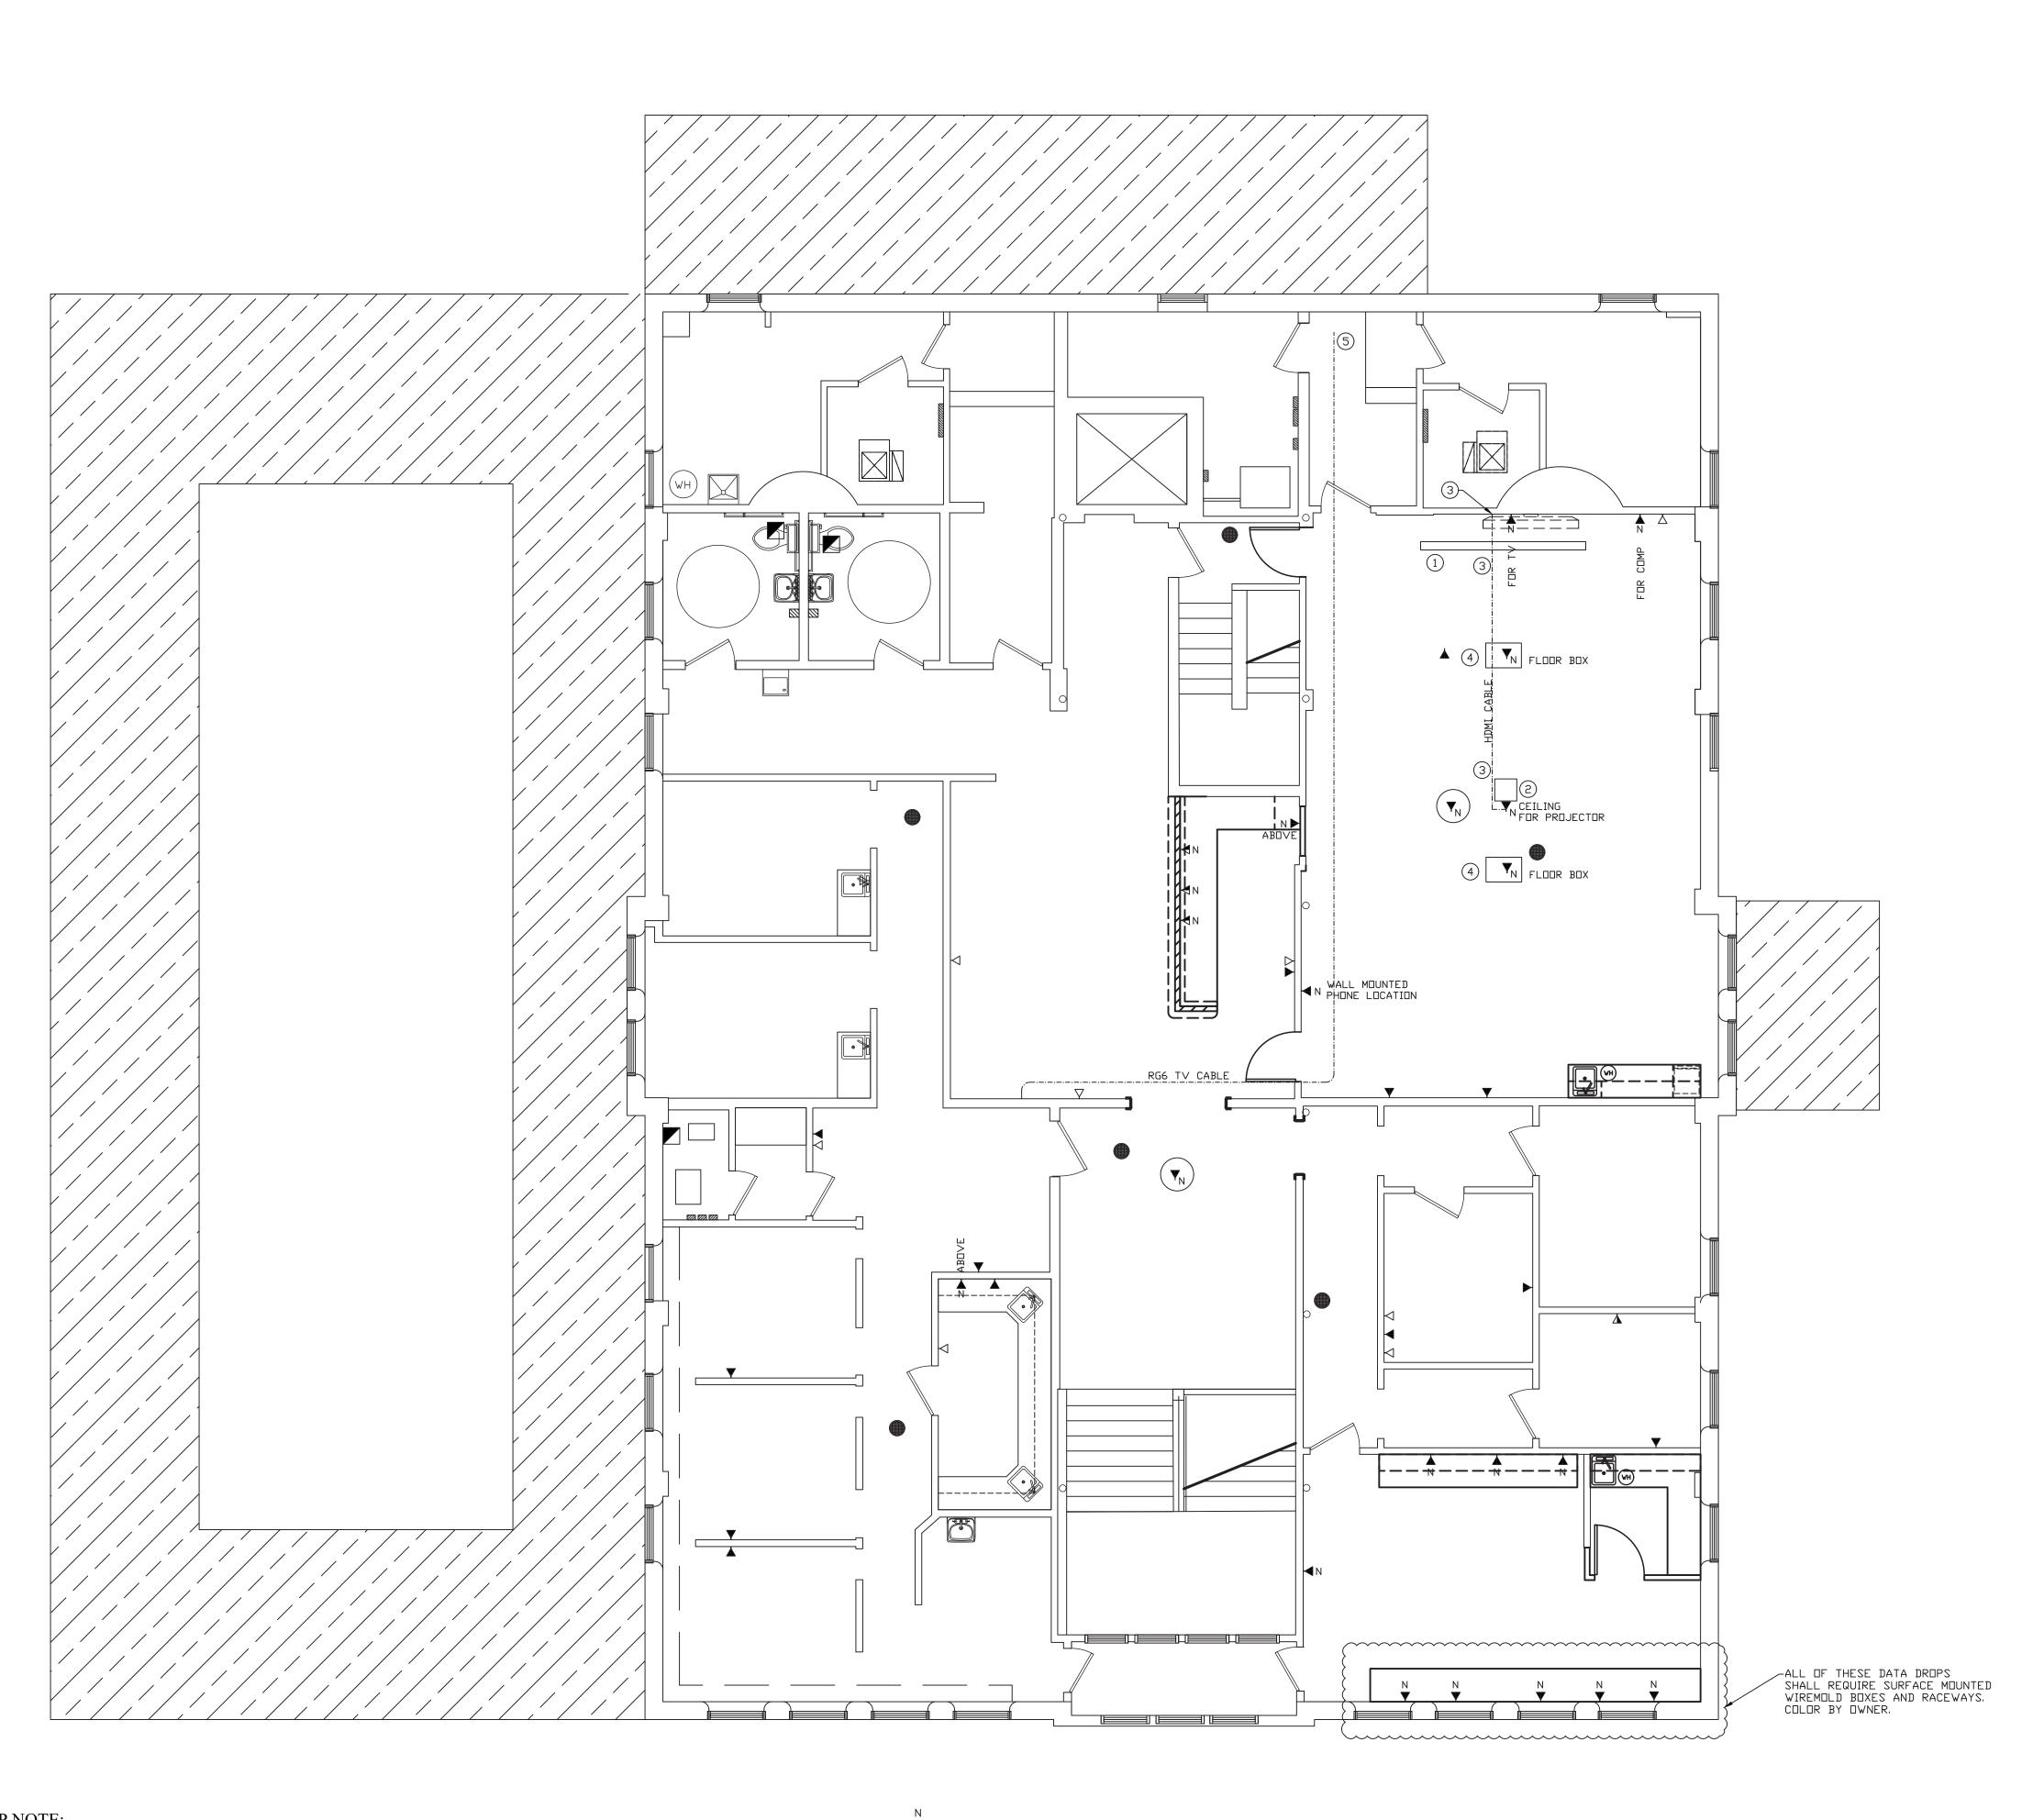
NEW DATA LOCATION COMPLETE BY E.C. WIFI ROUTER.

WABASH VALLEY HEALTH C 1436 LOCUST STREET TERRE HAUTE, INDIANA 4780

DATE REVISIONS

DATE:

APPROVED BY:



SECOND FLOOR NEW

DATA/ COMMUNICATION PLAN



▼ EXITING DATA DROP TO REMAIN

▼ EXISTING TELEPHONE DROP TO REMAIN

▼ EXISTING COMBINATION DATA / TELEPHONE DROP TO REMAIN

NEW DATA LOCATION COMPLETE BY E.C.
LOCATE AT +16" AFF
RUN COPPER CATGE CABLE FROM THIS LOCATION BACK TO EXISTING IT RACK.
PROVIDE TERMINATION AT NEW LOCATION TO COORDINATE WITH DWNERS EQUIPMENT.
PROVIDE EXTRA 10'-0 LENGTH AT EXISTING IT RACK TO BE USED BY THE OWNER.
CONNECTION TO EXISTING IT RACK BY OWNER COMPLETE.
TESTING OF NEW CATGE BY ELECTRICAL CONTRACTOR.

NEW DATA LOCATION COMPLETE BY E.C. WIFI ROUTER. LOCATE ABOVE CEILING.
RUN COPPER CATGE CABLE FROM THIS LOCATION BACK TO YN EXISTING IT RACK, PROVIDE TERMINATION AT NEW LOCATION TO COORDINATE WITH DWNERS EQUIPMENT.
PROVIDE EXTRA 10'-0 LENGTH AT EXISTING IT RACK TO BE USED BY THE DWNER.
CONNECTION TO EXISTING IT RACK BY DWNER COMPLETE.
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CONNECTION TO EXISTING IT RACK BY DWNER COMPLETE.
TESTING OF NEW CAT6E BY ELECTRICAL CONTRACTOR.

NEW PAGING SPEAKER LOCATION. PROVIDED AND INSTALLED BY E.C. WIRING PROVIDED AND INSTALLED TO EXISTING DWNERS EQUIPMENT COMPLETE BY E.C.

NUMBERED NOTES:

1) PROJECTOR SCREENED SUPPLIED BY THE OWNER. INSTALLED BY E.C. COMPLETE. UNIT WILL BE POWERED WITH WALL SWITCH

CEILING HUNG PROJECTOR SUPPLIED BY THE OWNER.
INSTALLED BY E.C. COMPLETE. MOUNTING/SUSPENSION ITEMS BY E.C. COMPLETE.. INSTALLED BY E.C.

PROVIDE BOX IN WALL WITH CONDUIT TO ABOVE CEILING, PROVIDE AND INSTALL HDMI CABLE BETWEEN THIS BOX AND THE NEW CEILING MOUNTED PROJECTOR PROVIDED BY OWNER, PROVIDE TERMINATIONS AS REQUIRED.

4 NEW SYSTEM ONE MODULAR IN FLOOR SYSTEM.
PROVIDE WITH THE FOLLOWING:

1. ROUND MULTI-SERVICE PVC FLOOR BOX CARPET ASSEMBLY UNIVERSAL COVER

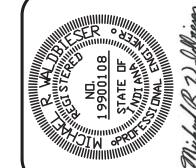
COLOR SELECTED BY OWNER

3. SUB-PLATE FOR POWER, DATA, AND TELEPHONE 4. CATEGORY 6E, PHONE, AND 20 AMP RECEPTACLE

TERMINATE NEW CABLE TV CABLE IN EXISTING FIRST FLOOR MECHANICAL ROOM

THAT CONTRACTOR.

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DATE:

PROJECT: 18-20 FILE: Elec #F

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SECTION 16000 - ELECTRICAL

PART 1: GENERAL The General Conditions and other Contract Documents are hereby made a part of this Section to the same extent as if written out in full.

When manufacturers catalog numbers are given, they are for assistance to the bidder. In case of discrepancies in catalog numbers, the Contractor shall contact the

All material to be new and in original cartons and bear the UL approval if such material is available with UL Label. The Electrical Contractor shall, at all times throughout the construction period, maintain proper supervision of his employees, make orderly disposition of his materials

maintain high-class workmanship, systematically remove debris, cooperate fully with other contractors and subcontractors and avoid the creation of hazards to others on the The Electrical Contractor shall make good any defects due to faulty material or workmanship; he shall correct any malfunction not due to misuse or abuse after date of

acceptance which develops in his work, for a period on one (1) year from date of acceptance. The date of final payment shall be recognized as the date of acceptance. 1.4 EQUIPMENT MARKING AND PAINTING

All panels shall have card holders for circuit identification. Circuit legend shall by typewritten. Each outlet and switch shall have circuit identification marked on back of plate.

1.5 RULES, REGULATIONS AND PERMITS

All materials, workmanship, and installation shall conform to all local and state codes and federal O.S.H.A. standards. This Electrical Contractor shall, at his own expense, furnish all necessary permits and fees required by the Local Ordinances and by the State of Indiana for construction and inspection of work installed by him. Refer to drawings for specific enforceable Building Codes. Electrical contractor shall include in his bid all cost associated with obtaining service requirements shown on drawings.

The Electrical Contractor shall furnish and maintain an adequate temporary electric service located at a convenient point, and shall also furnish and maintain adequate temporary lighting the full length of each corridor, with outlets for lights and plug-ins for power at approximately twenty (20) foot intervals. Adequate lighting shall be maintained throughout the building during normal working hours.

1.7 SYSTEM SCHEDULE The Electrical Contractor shall furnish and install all systems as hereinafter specified and shown on the drawings.

The work intended under this DIVISION consists of the provision of all labor and material required for the installation of complete systems all in accordance with the specifications and the accompanying drawings. Each system shall be constructed to be complete after all components are in place, and all in working order as approved by the Engineer. Furnish and install all electrical systems specified herein and as shown on the drawings. All electrical work to be installed according to the National Electrical Code, current issue, and with service requirements of the Electric Company for this project.

PART 2: MATERIALS AND METHODS

ELECTRIC SERVICE: Service shall be as outlined on the electrical drawings for voltage, phase and number of wires. This Contractor will extend branches as indicated.

FEEDER CIRCUITS: Feeder circuits shall be installed as shown on the drawings. All conduit shall be concealed except where necessary to use for connections to equipment and panel boards. Each feeder shall be protected with fuses and switches as shown on the drawings. BRANCH CIRCUITS: Branch circuits shall be run from panels as shown with convenience outlet circuits. Outlets shall be grouped on circuits as shown on the drawings.

PANELS: As indicated on the drawings. Panels and main breakers shall have integrated equipment short circuit rating as required by the local electrical utility and match the existing panels RECEPTACLES: See device specifications on drawings.

Backwiring is strictly prohibited. All wiring connections to be properly made at screw terminals with all units wrapped in electrical tape to cover all exposed terminals. SWITCHES: See device specifications on drawings.

LIGHTING FIXTURES: See schedule on drawings. To be installed with a complete complement of lamps. Before roughing-in outlets for various fixtures, this Contractor shall make certain that the fixture to be supplied is fitted with the proper hanging accessories to suit the

Flush type or recessed fixtures shall be installed with proper plaster rings or ceiling aligning devices for the ceilings to which they are to be attached, and shall be correctly spaced for symmetry with the surrounding ceiling pattern All recessed fixtures shall be light-tight under the surface trim; if not inherently leakproof by manufacturer's design, they shall be corrected by the use of adhering type

Surface type fixtures shall have adequate knockouts, symmetrically spaced to insure access to the wiring space in the outlet above. Surface fixture bodies shall be effectively grounded by (1) fixture support, (2) two screws into the appliance or plaster cover, or (3) bare bonding wire from a ground bushing in the outlet box to the fixture

The Electrical Contractor shall furnish and install, complete with all glassware and lamps of sizes indicated by wattage, all fixtures as shown in the fixture schedule on the

All fixtures shall bear the Underwriters' Laboratories Labe SAFETY SWITCHES: Provide proper size, heavy duty safety switches for motors and equipment where indicated and not in proximity of the panel from which fed.

Switches to be of the non-fused type. Switches on outdoor equipment shall have NEMA 3R enclosures. MISCELLANEOUS WIRING: Provide and install service feeders for air conditioning units, exhaust and ventilating fans, water heater, etc. as indicated. Temperature control wiring to be provided and installed by the Electrical Contractor. Control wiring connections to thermostats and mechanical units to be by the Mechanical Contractor. All equipment provided for this project are to be as specified on the drawings. Other manufacturer's may be substituted as long as the product is an approved "equal" by the Engineer of Record.

DATA / INTERNET SYSTEMS: AS SHOWN ON DRAWINGS FIRE ALARM SYSTEM: AS SHOWN ON DRAWINGS

TELEPHONE SYSTEM: BY OWNER COMPLETE VIDEO SYSTEM: AS SHOWN ON THE DRAWINGS

GROUNDING: Grounding of all interior metallic water piping is to be per NEC. Grounding of all steel buildings is to be in strict accordance with NEC. Grounding of interior gas piping as required by Code.

2.2 WIRING PLAN The Electrical Contractor may use the accompanying drawings as his working drawings. In this case, the general plan and circuiting shall be substantially followed except for deviations due to mechanical and structural interference.

The Contractor shall, however, furnish additional drawings as hereinafter designated, or wherever directed, to bring out detail to a greater degree than that given on the accompanying drawings, or where alternate equipment, as furnished, does not fit the layout as planned on the original drawings. The Contractor may elect to furnish complete working drawings of his own. In this case, he shall furnish prints for approval before the work has begun. Any work installed before Engineer's approval of the drawings may be subject to rejection, if in the Engineer's opinion, it does not conform with the intent of these specifications and the accompanying drawings.

2.3 DRAWINGS The Electrical Contractor shall furnish "Shop Drawings" in accordance with the requirements of DIVISION 1, GENERAL CONDITIONS and all amendments thereto. He shall obtain, ahead of

job progress, the necessary manufacturer's drawings, wiring diagrams, and operating instructions for other Contractors equipment to which he is to connect. He shall also maintain a complete set of general, structural, electrical and mechanical drawings during the progress of the job. He shall also maintain a clean set of electrical drawings for record purposes, upon which he shall mark, legibly, all deviations from the Contract Documents. This set shall be turned over to the Engineer at the termination of the job 2.4 FIELD LAYOUT

The intent of the drawings and these specifications is to cover circuiting, outlet location, and system coordination rather than to cover the exact location of each conduit: therefore, where interference with mechanical equipment and with the lines of other contractors are encountered, this Contractor shall at all times plan his work far enough in advance to avoid interfering with heavy equipment and large piping which cannot be readily shifted. 2.5 TYPE OF INSTALLATION

The basic wiring system shall be installed in accordance with the National Electrical Code. All wiring shall be THHN in EMT conduit where exposed. All concealing wireing may be MC Cable. Shared neutrals are not allowed. 2.6 CONDUIT AND FITTINGS

Conduit for mains and feeders 2" IPS and larger shall be rigid galvanized heavy wall, threaded. All conduits exposed to weather, exposed through floors subject to hose cleaning and mopping, or exposed in earth filled spaces, shall be heavy wall galvanized. Other non-exposed conduits may be installed with either rigid conduit or electrical metallic tubing hereinafter referred to as EMT

Conduits laid underfloor indoors may be bare galvanized. In case of cast in slab work, all runs of EMT which may be bent or broken by removal of forms shall be carefully installed

All boxes shall be galvanized steel for use with MC Cable or EMT Conduit. Fiberglass boxes shall be used for all NM-B installations. Blue plastic PVC boxes are prohibited 2.7 BASIC WIRING SYSTEM

The basic wiring system shall be fabricated as specified on the electrical drawings or in this specification. Wiring shall be sized as required to conform to the requirements of the latest National Electrical Code. All wire in conduit to be type THHN copper with all sizes larger than #8 AWG to be stranded. A. For wire #8 and smaller, provide solid wire; for wire larger than #8, provide stranded

B. Connectors shall be Thomas-Betts, Appleton, or Metallectrics.

C. Conductors shall be Triangle, Anaconda, Phelps Dodge, Columbia, Hatfield or Paranite and shall be sized per the requirements of NEC.

No conductor to be smaller than #12 AWG

All wire in conduit to be THHN copper with all sizes larger than #8 AWG to be stranded. No conductor smaller than #12.

Back-Wiring is strictly prohibited. All wiring connections to be properly made at screw terminals with all units wrapped in electrical tape to cover all exposed terminals.

Power service to be as specified on the electrical drawing The Contractor shall not charge as an extra, relocation of devices and fixtures, if new location is not over six feet from the original location.

Grounding of all interior metallic water piping to be per NEC.

Exterior outlets and outlets indicated near sinks and lavatories shall be protected by approved "Ground Fault Circuit Interrupters" (GFI) typical throughout. GFI's installed where required by the National Electrical Code. 2.8 LOCATION OF OUTLETS AND EQUIPMENT CONNECTIONS All outlets, as shown on the drawings, are intended to be in proper relative positions as far as symbol standards and the scale of the drawings permit. The exact positioning

and final locations of these outlets, however, shall be as directed by the Engineer. This Contractor shall obtain the necessary horizontal and vertical dimensions of the outlets before roughing-in begins. This Contractor shall also obtain all necessary drawings and rough-in dimensions from the other contractors whose equipment is to be 2.9 CUTTING AND PATCHING

The Electrical Contractor shall do all the necessary cutting and fitting required for the proper installation of his work and shall repair any damage done by him or his workmen to the satisfaction of the Engineer.

The Electrical Contractor shall dispose of all material in a legal matter. Including any existing fluorescent tubes and ballasts.

All work on this project must be complete of all parts and supplies and hook-ups to make a complete operating job when the project is finished.

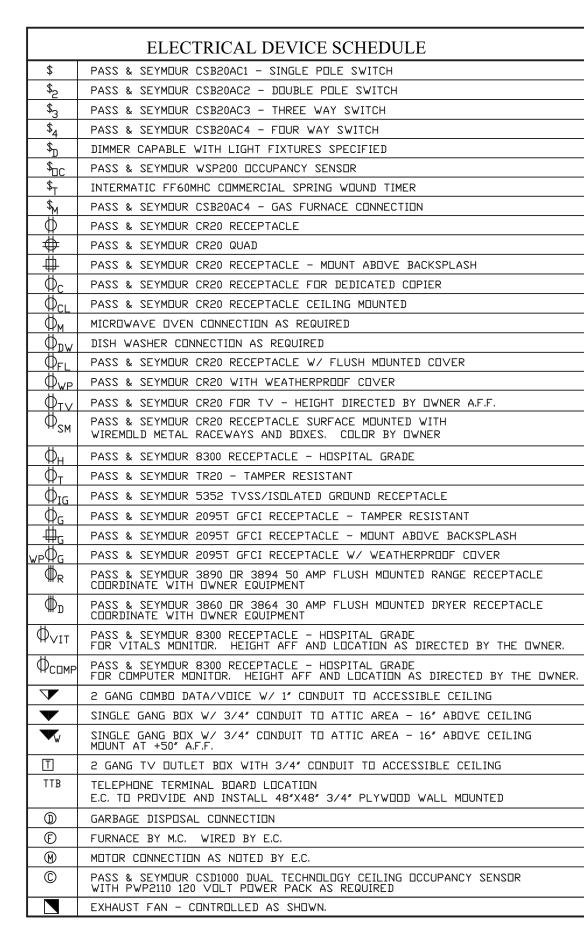
All equipment shall be installed in strict accordance with the manufacturer's installation instructions.

Verify voltage and amperage requirements for all equipment with Mechanical Contractor prior to start of the project. Compaction of soil shall be as stated in the General Written Specifications for all trenching.

All trenching required for installation of products specified in this section of work shall be done by the Electrical Contractor. Backfilling after trenching shall be done in accordance with the General Written Specifications by the Electrical Contractor. After backfilling, the Electrical Contractor shall finish grade the area disturbed by the trenching to match that of the site prior to trenching.

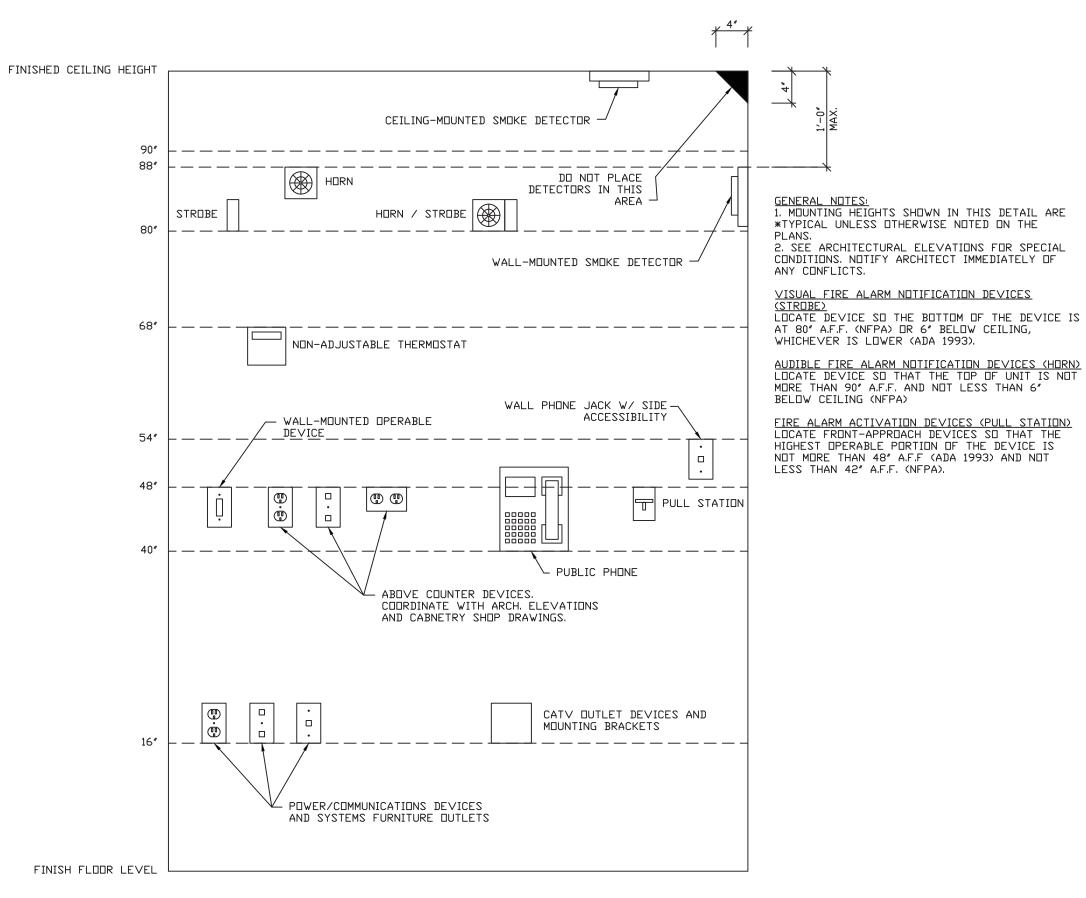
END OF SECTION

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ELECTRICAL DEVICE NOTES:

- COLOR OF DEVICES AS SELECTED BY THE OWNER. WALL PLATES SHALL BE PASS & SEYMOUR THERMOSET PLASTIC
- FIELD COORDINATE DEVICE LOCATION WITH ARCHITECTURAL CASEWORK
- 4. DEVICES AS LISTED OR APPROVED EQUALS.



ELECTRICAL MOUNTING HEIGHT SCHEDULE

	LIGHT FIXTURE SCHEDULE									
MARK	MFG.	MODEL	DESCRIPTION	VOLTAGE	INPUT WATTS	LAMPS	REMARKS			
"A"	LITHONIA	2BLT4-40L-ADP-GZ1-LP840	2'-0"x4'-0" RECESSED LED FIXTURE WITH VOLUMETRIC DISTRIBUTION 4064 LUMENS	120 VOLT	31 WATTS	4000K 82CRI	CONTROLLED BY COMPATIBLE WALL MOUNTED DIMMER AT LOCATIONS SHOWN.			
"A1"	LITHONIA	2BLT4-48L-ADP-GZ1-LP840	2'-0"x4'-0" RECESSED LED FIXTURE WITH VOLUMETRIC DISTRIBUTION 5039 LUMENS	120 V□LT	28 WATTS	4000K 82CRI	CONTROLLED BY COMPATIBLE WALL MOUNTED DIMMER AT LOCATIONS SHOWN.			
"A2"	LITHONIA	2BLT4-48L-ADP-GZ1-LP840	2'-0"x4'-0" SURFACE MOUNTED LED FIXTURE WITH VOLUMETRIC DISTRIBUTION 5039 LUMENS	120 V□LT	28 WATTS	4000K 82CRI	CONTROLLED BY COMPATIBLE WALL MOUNTED DIMMER AT LOCATIONS SHOWN.			
"B"	LITHONIA	2BLT2-20L-ADP-GZ1-LP840	2'-0"x2'-0" RECESSED LED FIXTURE WITH VOLUMETRIC DISTRIBUTION 2065 LUMENS	120 VOLT	16 WATTS	4000K 82CRI	CONTROLLED BY COMPATIBLE WALL MOUNTED DIMMER AT LOCATIONS SHOWN.			
"C"	LITHONIA	BLT4-30L-ADP-GZ1-LP840	1'-0"x4'-0" RECESSED LED FIXTURE WITH VOLUMETRIC DISTRIBUTION 2965 LUMENS	120 V□LT	23 WATTS	4000K 82CRI	-			
"D"	LITHONIA	LBL4-4000LM-80CRI-40K	10"x4'-0" SURFACE LED FIXTURE LOW PROFILE CURVED BASKET 4253 LUMENS	120 V□LT	2TTAW EE	4000K 80CRI	-			
"D1"	LITHONIA	LBL4-3000LM-80CRI-40K	10"x4'-0" SURFACE LED FIXTURE LOW PROFILE CURVED BASKET 3288 LUMENS	120 V□LT	26 WATTS	4000K 80CRI	-			
"D2"	LITHONIA	LBL4-4000LM-80CRI-40K	10"x4'-0" SURFACE LED FIXTURE LOW PROFILE CURVED BASKET 4253 LUMENS	120 V□LT	2TTAW EE	4000K 80CRI	CHAIN HUNG FROM STRUCTURE AS REQUIRED			
"EM"	LITHONIA	ELM2-LED-SD	QUANTUM THERMOPLASTIC EMERGENCY LIGHT. WHITE IN COLOR WITH SELF-DIAGNOSTICS	120 V□LT	3.0 WATTS	2 - 1.5W 3.6V WHITE LED	-			
"EXM1"	LITHONIA	LHQM-LED-G-HO-SD WITH ELA-QWP-LO309SD REMOTE HEAD.	QUANTUM THERMOPLASTIC EXIT/UNIT COMBO WITH SELF-DIAGNOTICS. WHITE IN COLOR. WITH REMOTE HEAD.	120 VOLT	3.0 WATTS	2 - 1.5W 9.6V WHITE LED	-			
"EXM2"	LITHONIA	LHQM-LED-G-SD	QUANTUM THERMOPLASTIC EXIT/UNIT COMBO WITH SELF-DIAGNOTICS. WHITE IN COLOR.	120 VOLT	3.0 WATTS	2 - 1.5W 9.6V WHITE LED	-			
"EX"	LITHONIA	#LQM-G-W-3-R-120/277 -ELN-SD	QUANTUM THERMOPLASTIC EXIT UNIT WITH SELF-DIAGNOTICS. WHITE IN COLOR.	120 V□LT	3.0 WATTS	2 - 1.5W 9.6V WHITE LED	-			
"F"	-	LED FIXTURE WITH DIMMING CAPABILITY	ALLOWANCE ITEM. \$500.00 PER FIXTURE	120 VOLT	-	4000K	STEM MOUNTED FROM CEILING			

LIGHT FIXTURE NOTES:

1. ALL LIGHT FIXTURES SHALL BE DLC CERTIFIED.

2. SPECIFIED UNITS ARE BY LITHONIA NO SUBSTITUTIONS OR ALTERNATES ALLOWED.

DIMMING LIGHT FIXTURES SPECIFIED HAVE 0-10 VOLT DIMMING

AND WILL REQUIRE ADDITIONAL WIRE FOR DIMMING CONTROL. PROVIDE AND INSTALL ADDITIONAL WIRE FOR DIMMING CONTROL AS REQUIRED.

GOVERNING CODES

2014 INDIANA BUILDING CODE

(IBC 2012 EDITION - WITH INDIANA AMENDMENTS)

2014 INDIANA FIRE CODE

(IFC 2012 EDITION - WITH INDIANA AMENDMENTS) 2012 INDIANA PLUMBING CODE

(IPC 2006 EDITION - WITH INDIANA AMENDMENTS)

2014 INDIANA MECHANICAL CODE

(IMC 2012 EDITION - WITH INDIANA AMENDMENTS)

2010 INDIANA ENERGY CONSERVATION CODE (ANSI/ASHRAE 90.1 - 2007 EDITION - WITH INDIANA AMENDMENTS)

2009 INDIANA ELECTRICAL CODE

(NEC 2008 EDITION - WITH INDIANA AMENDMENTS)

GENERAL NOTES:

1. ALL CONTRACTORS AND SUB-CONTRACTORS SHALL REVIEW ALL DRAWINGS FOR WORK PERFORMED BY THAT CONTRACTOR.

POWER/COMMUNICATION DEVICES: OUTLETS SHALL BE LOCATED AT 16"

ABOVE COUNTER DEVICES SHALL BE

THE DEVICES. VERIFY WITH

ARCHITECTURAL DETAILS.

"CALL" DEVICES

OF THE COUNTER TO THE BOTTOM OF

O THE BOTTOM OF THE BOX.

LOCATED AT 2" ABOVE THE BACKSPLASH

WALL-MOUNTED OPERABLE DEVICES:
OPERABLE DEVICES SHALL BE LOCATED
AT 48" A.F.F. TO THE TOP OF THE

WALL-MOUNTED TELEPHONE JACKS WITH

INCLUDE, BUT ARE NOT LIMITED TO THE

LIGHT SWITCHES, DIMMERS, CONTROLS, ETC. PUSH BUTTONS OTHER CONTROL OR

FOLLOWING: ADJUSTABLE THERMOSTATS

SIDE ACCESSIBILITY MAY BE MOUNTED UP

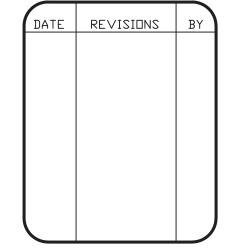
OPERABLE PORTION OF THE DEVICE.

WALL-MOUNTED OPERABLE DEVICES

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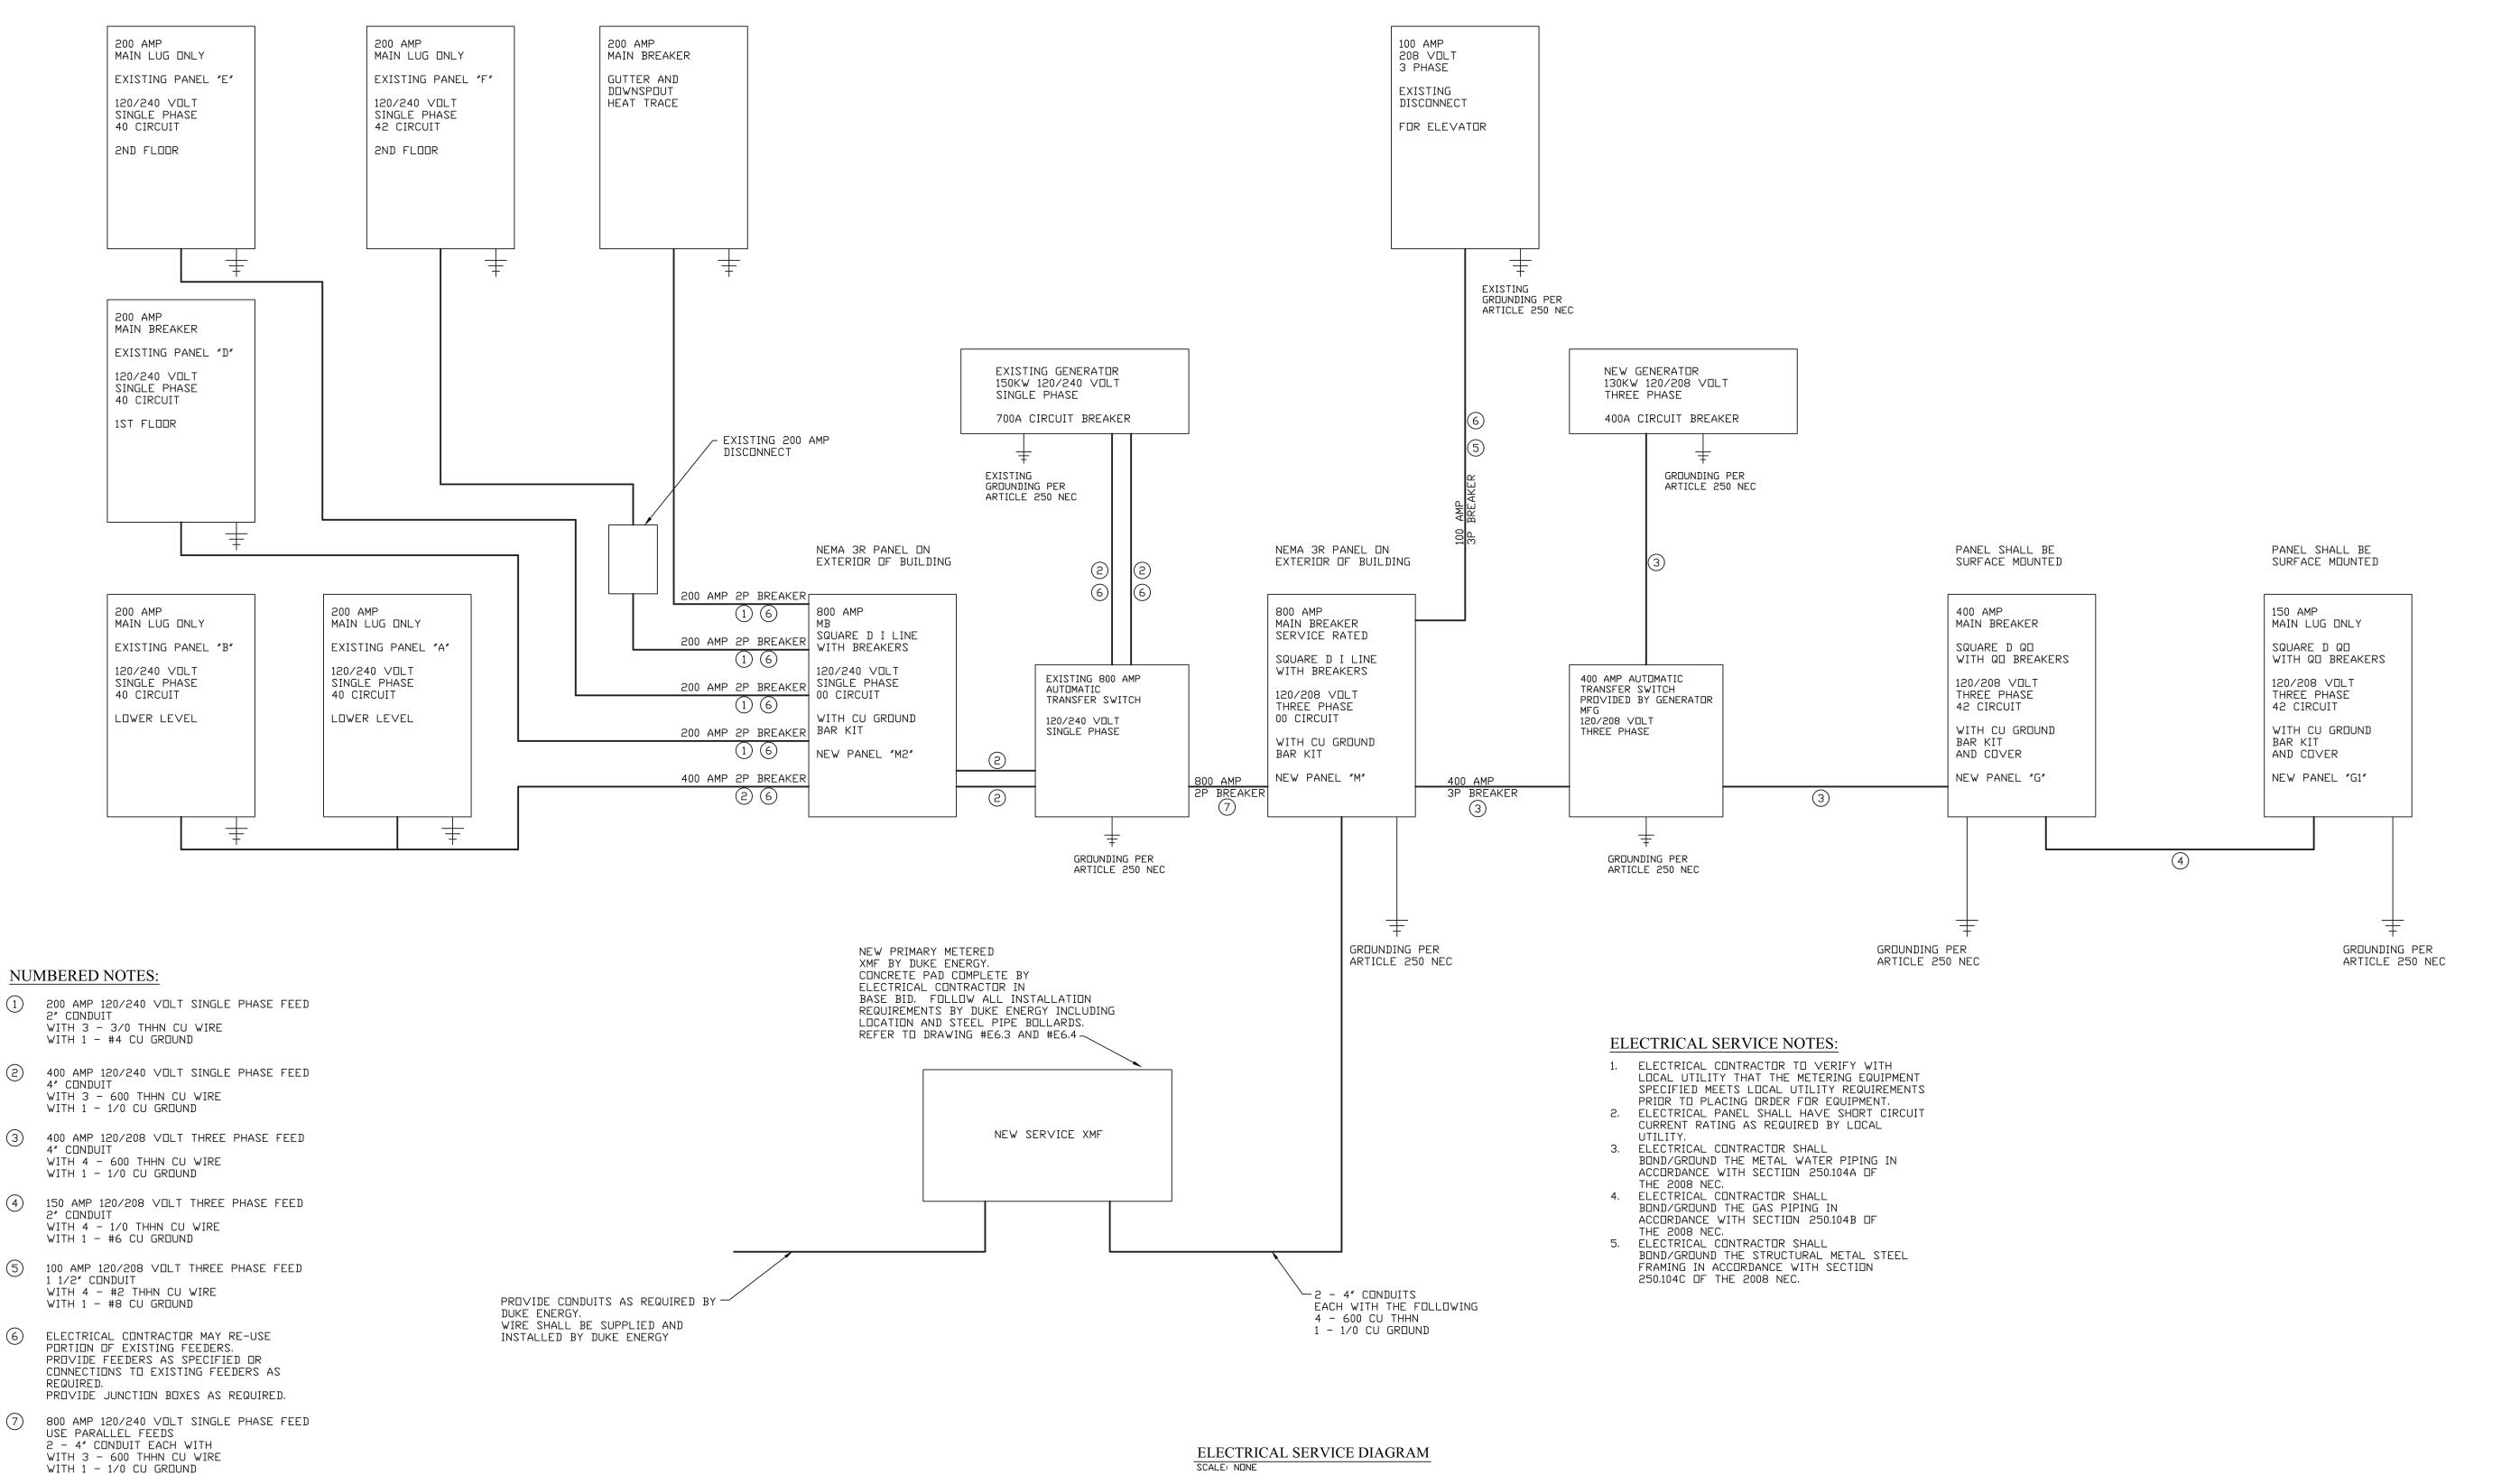


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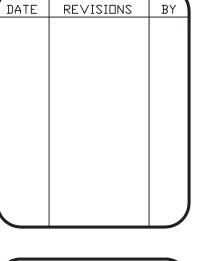
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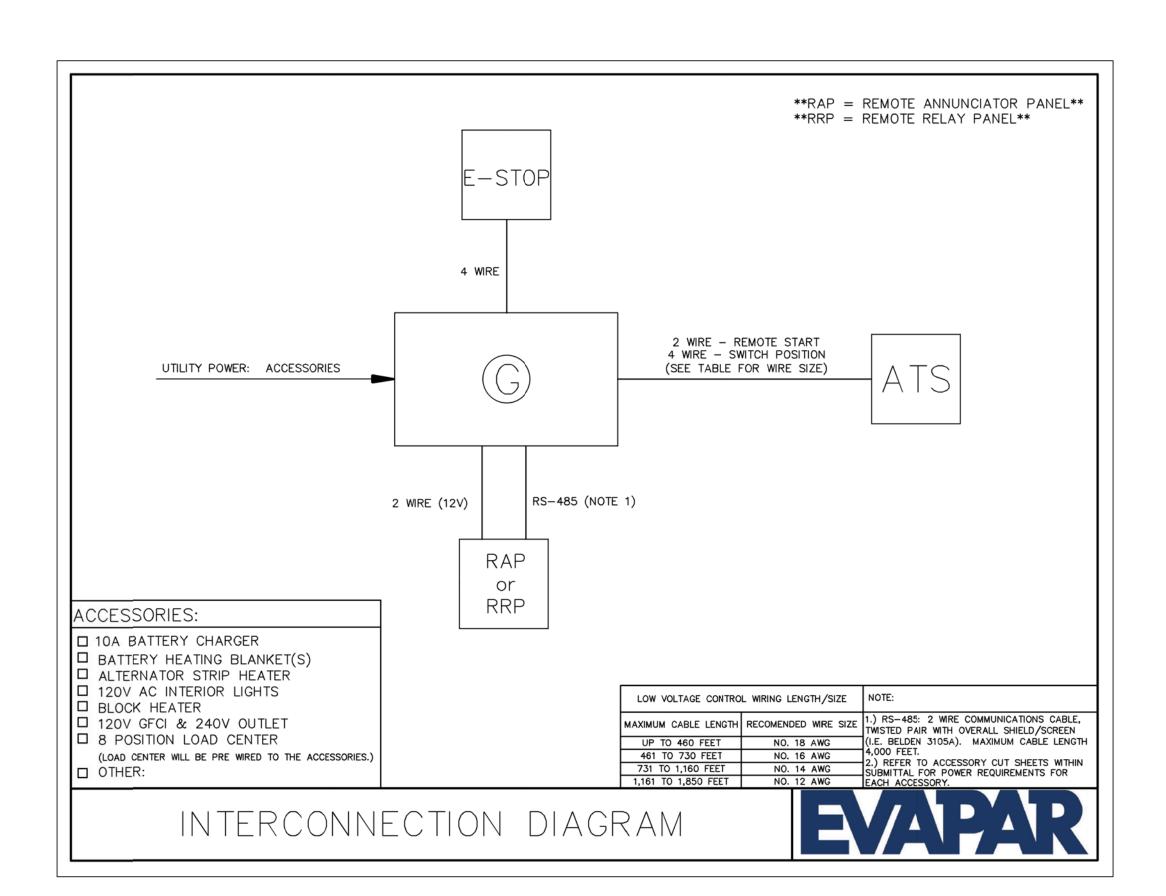
WABASH VALLEY HEALTH CENTE 1436 LOCUST STREET TERRE HAUTE, INDIANA 47807

MRW 09-11-19 DRAWN BY: APPROVED I DATE:

3 PHASE – 4 WIRE – SOLID NEUTRAL PANELBOARD 120/208 VOLT 400 AMP MAIN BREAKER 3 PHASE – 4 WIRE – SOLID NEUTRAL PANELBOARD 120/208 VOLT 150 AMP MAIN LUG ONLY SITE LIGHTING 1 20 2 LIGHTING EXAM ROOM RECEPTACLES 1 20 2 EXAM ROOM RECEPTACLES EXAM ROOM RECEPTACLES 3 20 20 4 EXAM ROOM RECEPTACLES LIGHTING 3 20 20 4 LIGHTING EXAM ROOM RECEPTACLES 5 20 20 6 EXAM ROOM RECEPTACLES 7 _______ 20 8 NEW GENERATOR BATTERY CHARGER EXAM ROOM RECEPTACLES 7 20 20 8 EXAM ROOM RECEPTACLES EXAM ROOM RECEPTACLES 9 20 20 10 CLINIC MGR RECEPTACLES EXAM ROOM RECEPTACLES 11 20 20 12 RESTROOM RECEPTACLES 11 _______12 PROVIDERS RECEPTACLES 13 20 20 14 CORRIDOR RECEPTACLES RELOCATED DENTAL VACCUM 15 30 20 16 RELOCATED DENTAL EQUIPMENT WORK STATION RECEPTACLES 15 20 20 16 IT ROOM RECEPTACLE NURSE STATION RECEPTACLES 17 20 20 18 WAITING ROOM RECEPTACLES RELOCATED DENTAL VACCUM 19 20 60 20 AC-1 NURSE STATION RECEPTACLES 19 20 20 WAITING RM RECEPTACLES 21 _______ 22 NURSE STATION RECEPTACLES 21 20 20 22 CHECK IN RECEPTACLES AC-3 23 60 35 24 AC-2 NURSE STATION RECEPTACLES 23 20 20 24 CHECK IN RECEPTACLES 25 _______ 26 LAB STATION REF 25 20 26 CHECK IN RECEPTACLES AC-4 27 60 28 AC-5 29 30 LAB STATION RECEPTACLES 27 20 28 CHECK IN RECEPTACLES LAB STATION RECEPTACLES 29 20 20 30 WAITING RM RECEPTACLES RTU-1 31 50 32 NAV OFFICE RECEPTACLES 31 20 20 32 REGISTRATION RECEPTACLES NAV OFFICE RECEPTACLES 33 20 20 34 REGISTRATION RECEPTACLES RECEPTION BACK RECEPTACLES 35 20 20 36 REGISTRATION RECEPTACLES RECEPTION BACK RECEPTACLES 37 20 20 38 REGISTRATION RECEPTACLES 39 40 42

NEW PANEL "G1"

NEW PANEL "G"



GENERATOR WIRING DIAGRAM

DATE | REVISIONS



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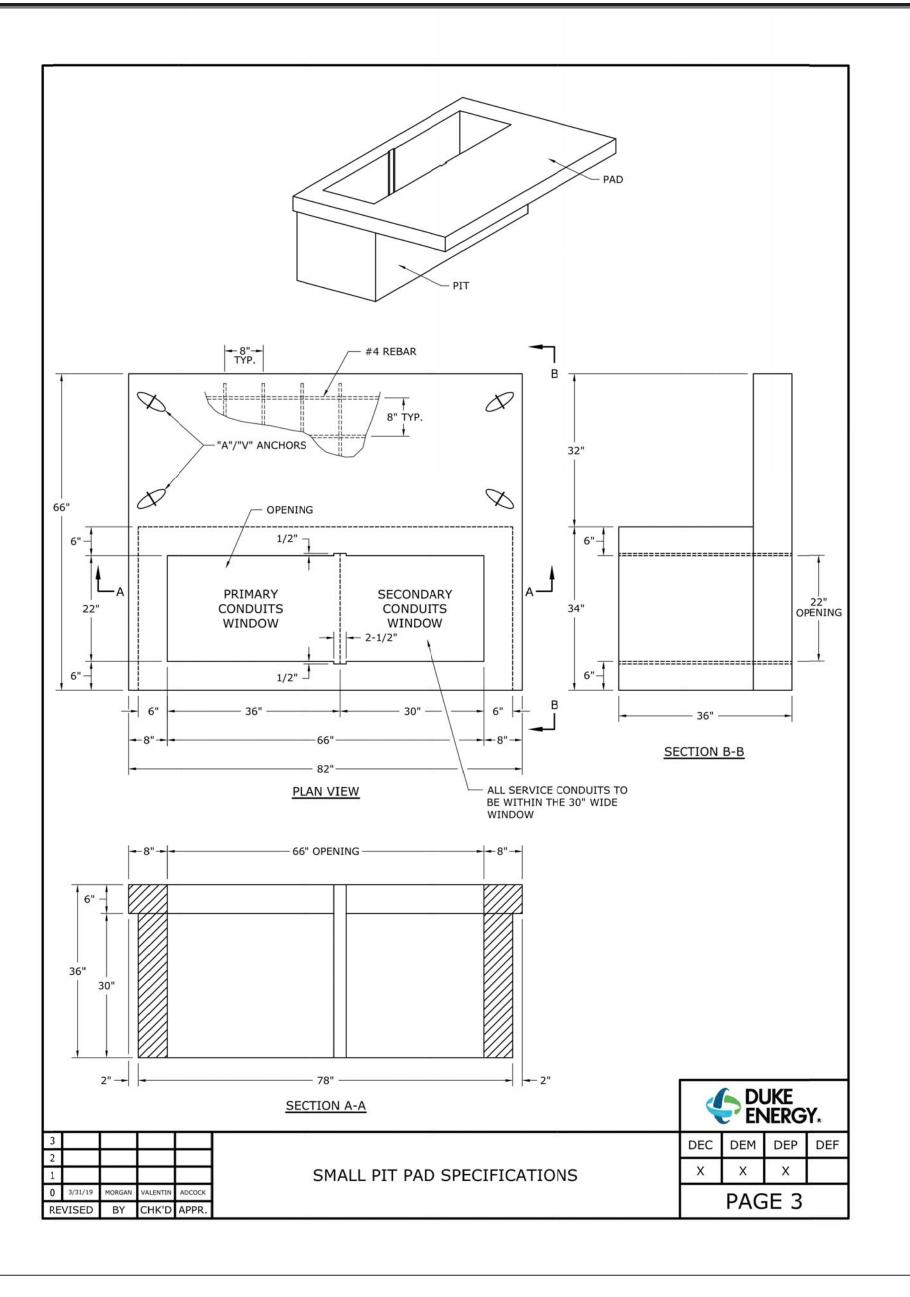
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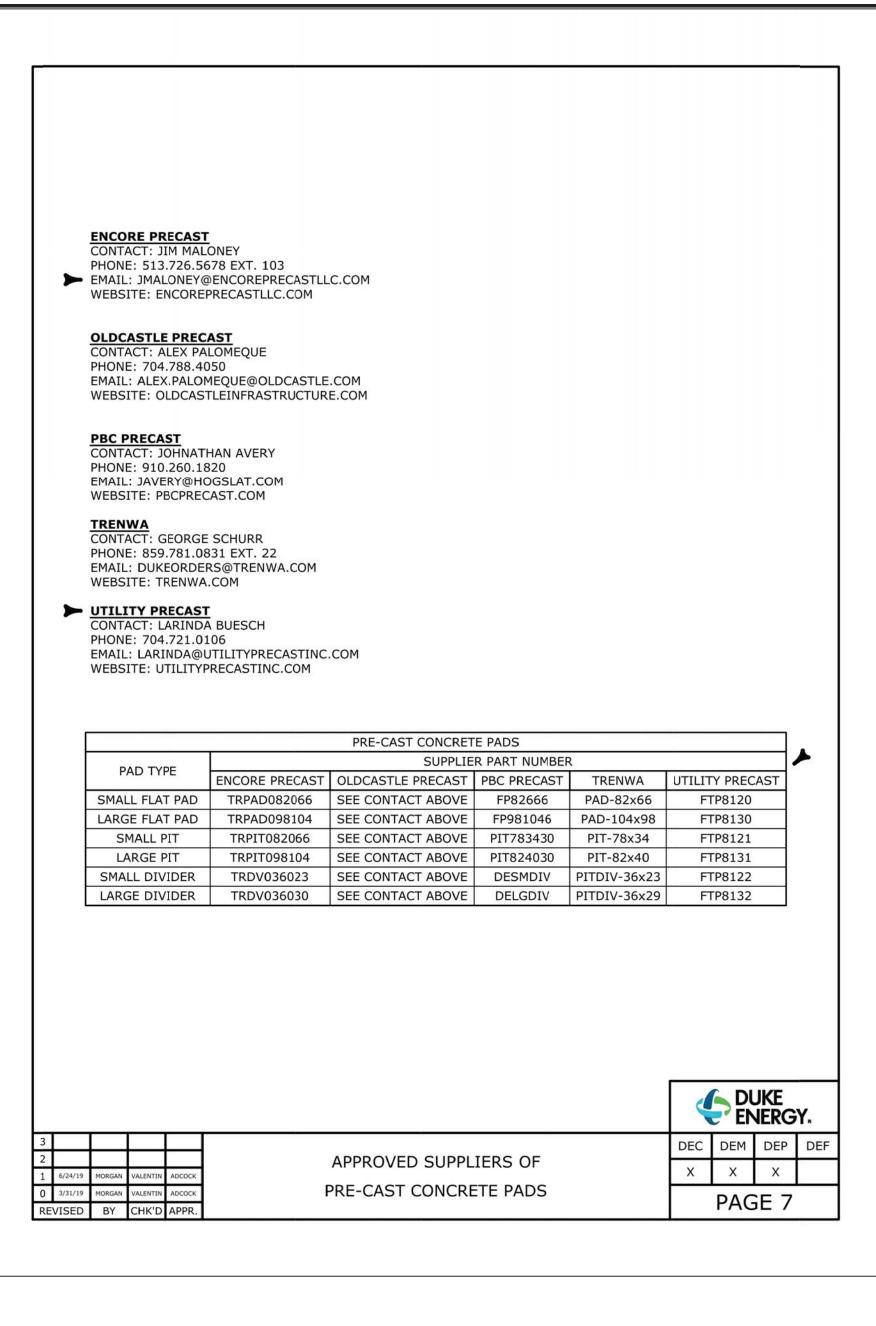
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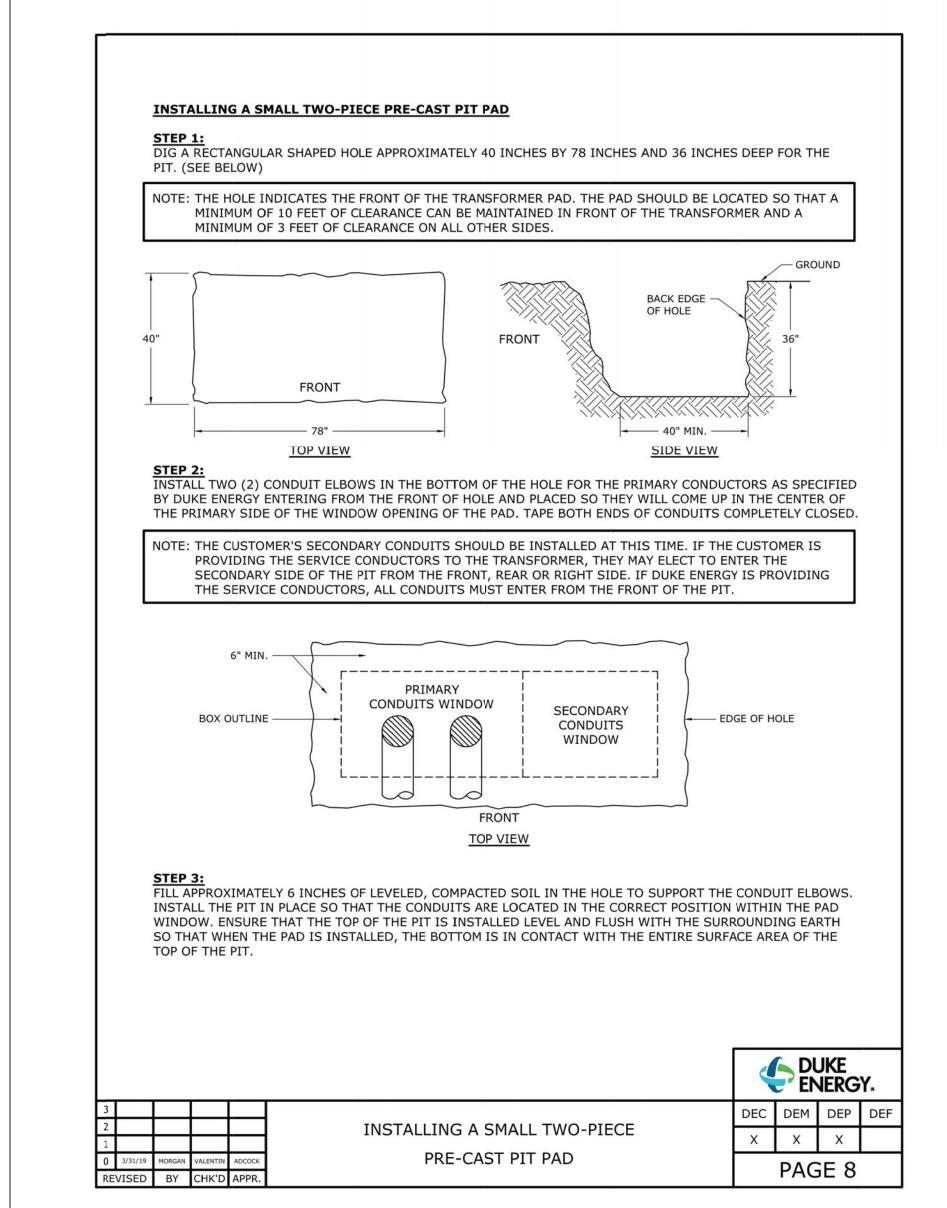
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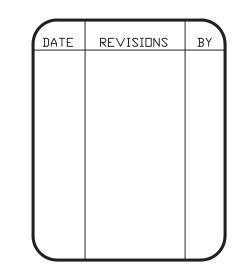
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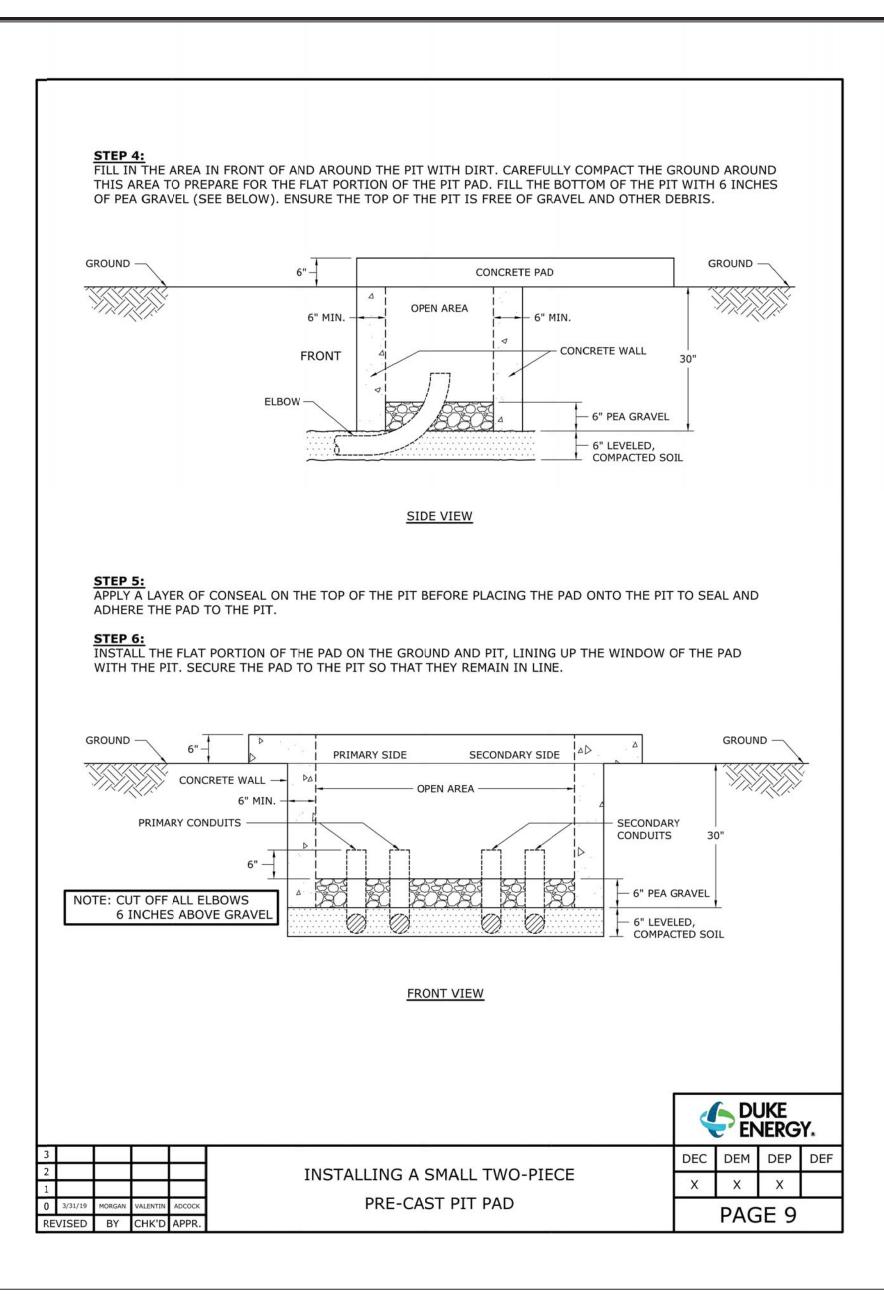
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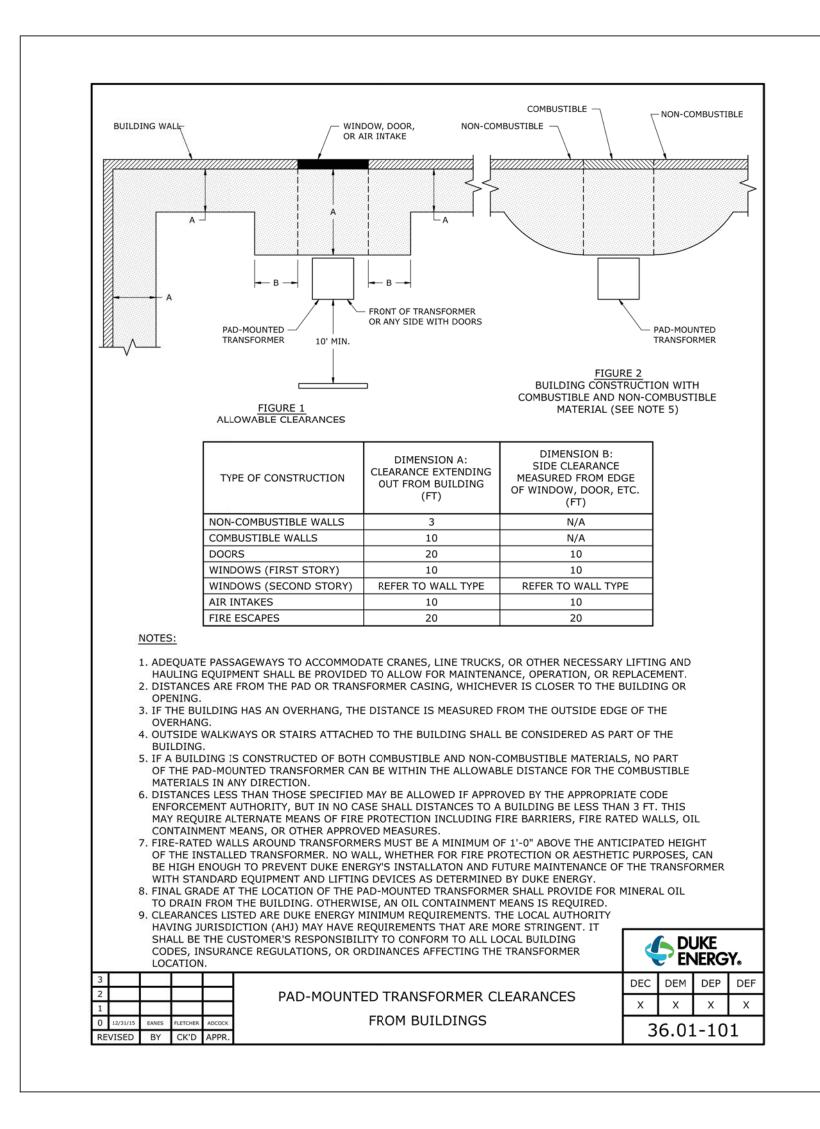
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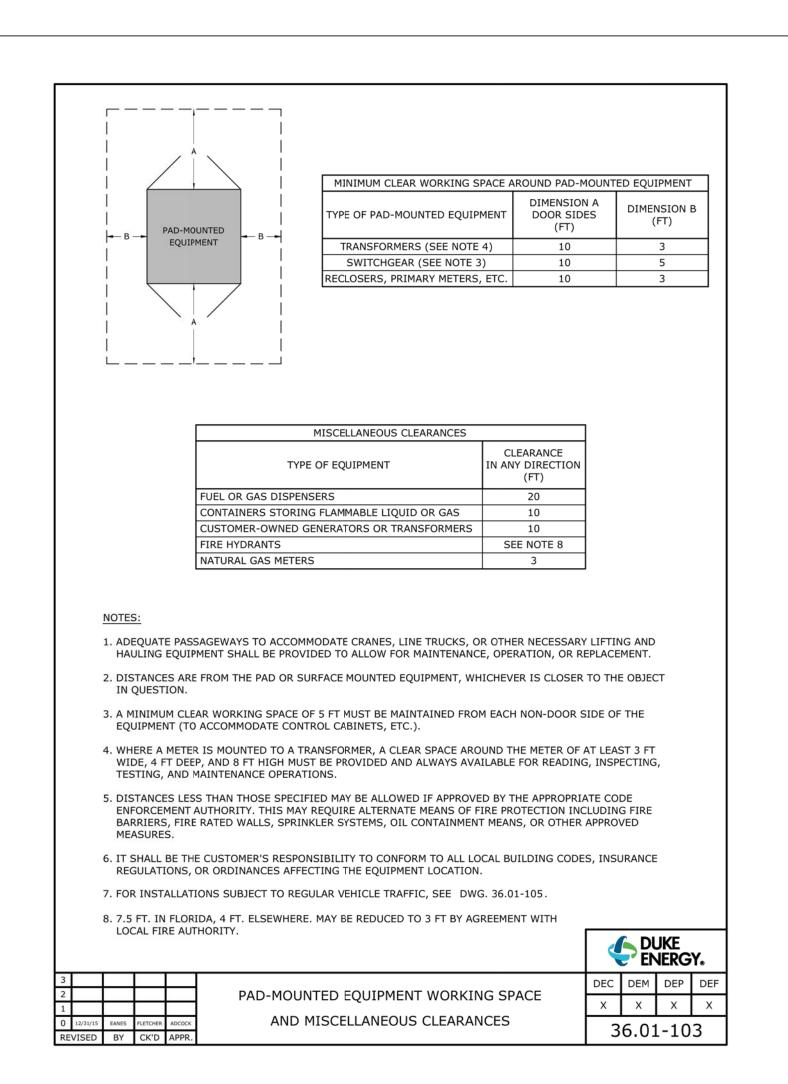
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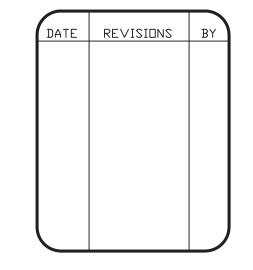
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