

#	Revision	Date
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Project #: 20-700-151-2

Designed By: LD/SP

Drawn By: CP


Checked By: LD/IV

Date: 02.04.2022



Eric Wehlen

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WALL TYPES

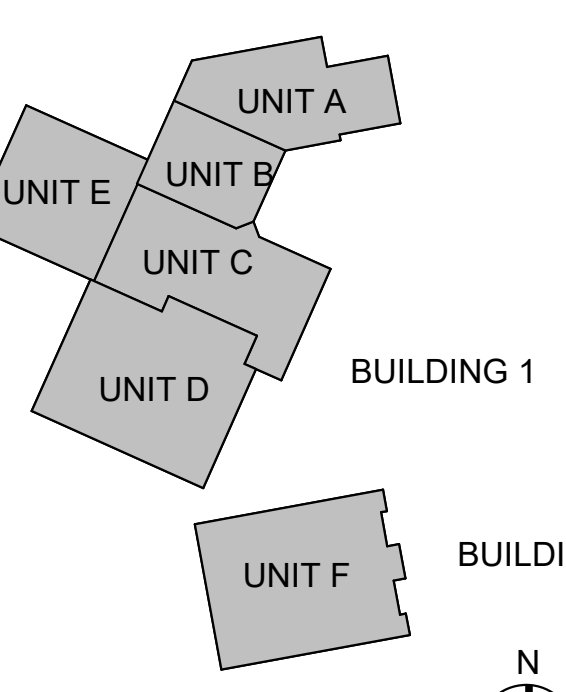



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Project #: 20-700-151-2  
Designed By: LD/SP  
Drawn By: CP  
Checked By: LD/IV  
Date: 01.28.2022




*Eric Welfen*


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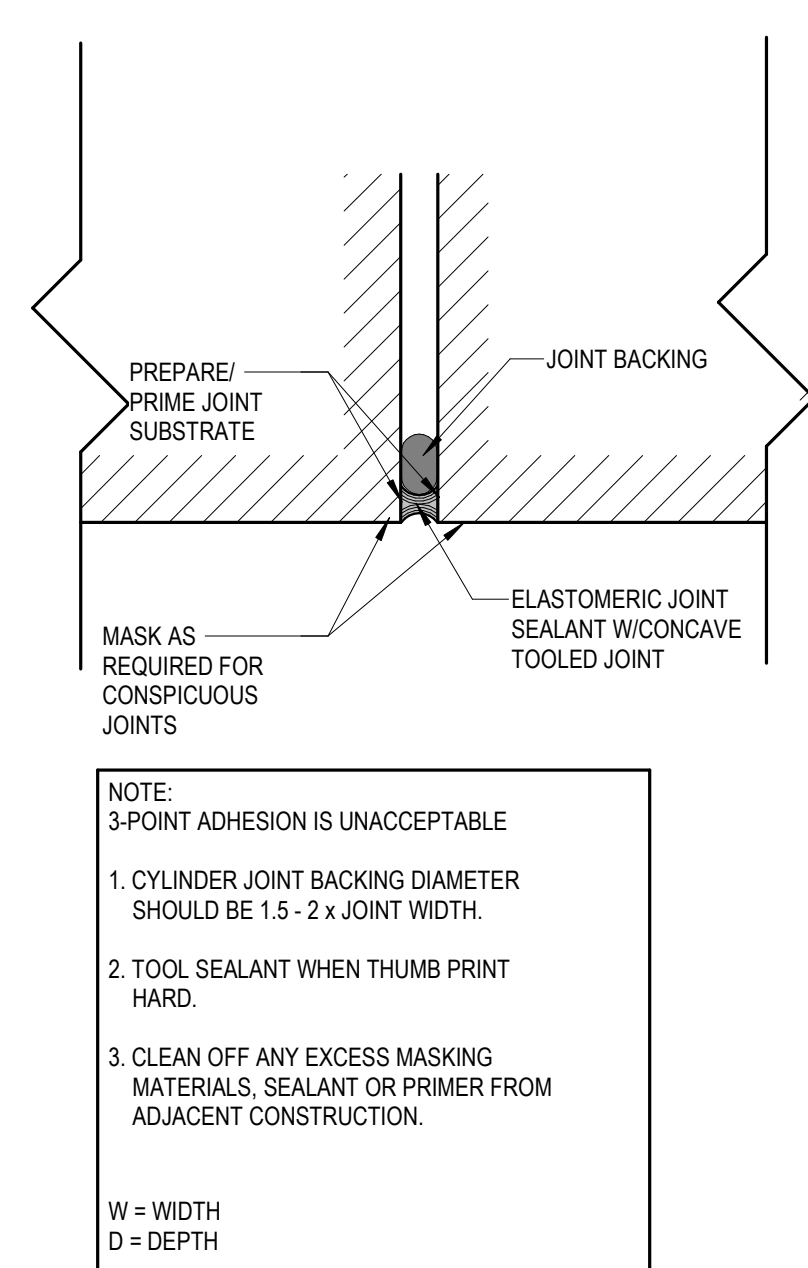
1D STANDARD SHOWER ELEVATIONS  
1/2" = 1'-0"

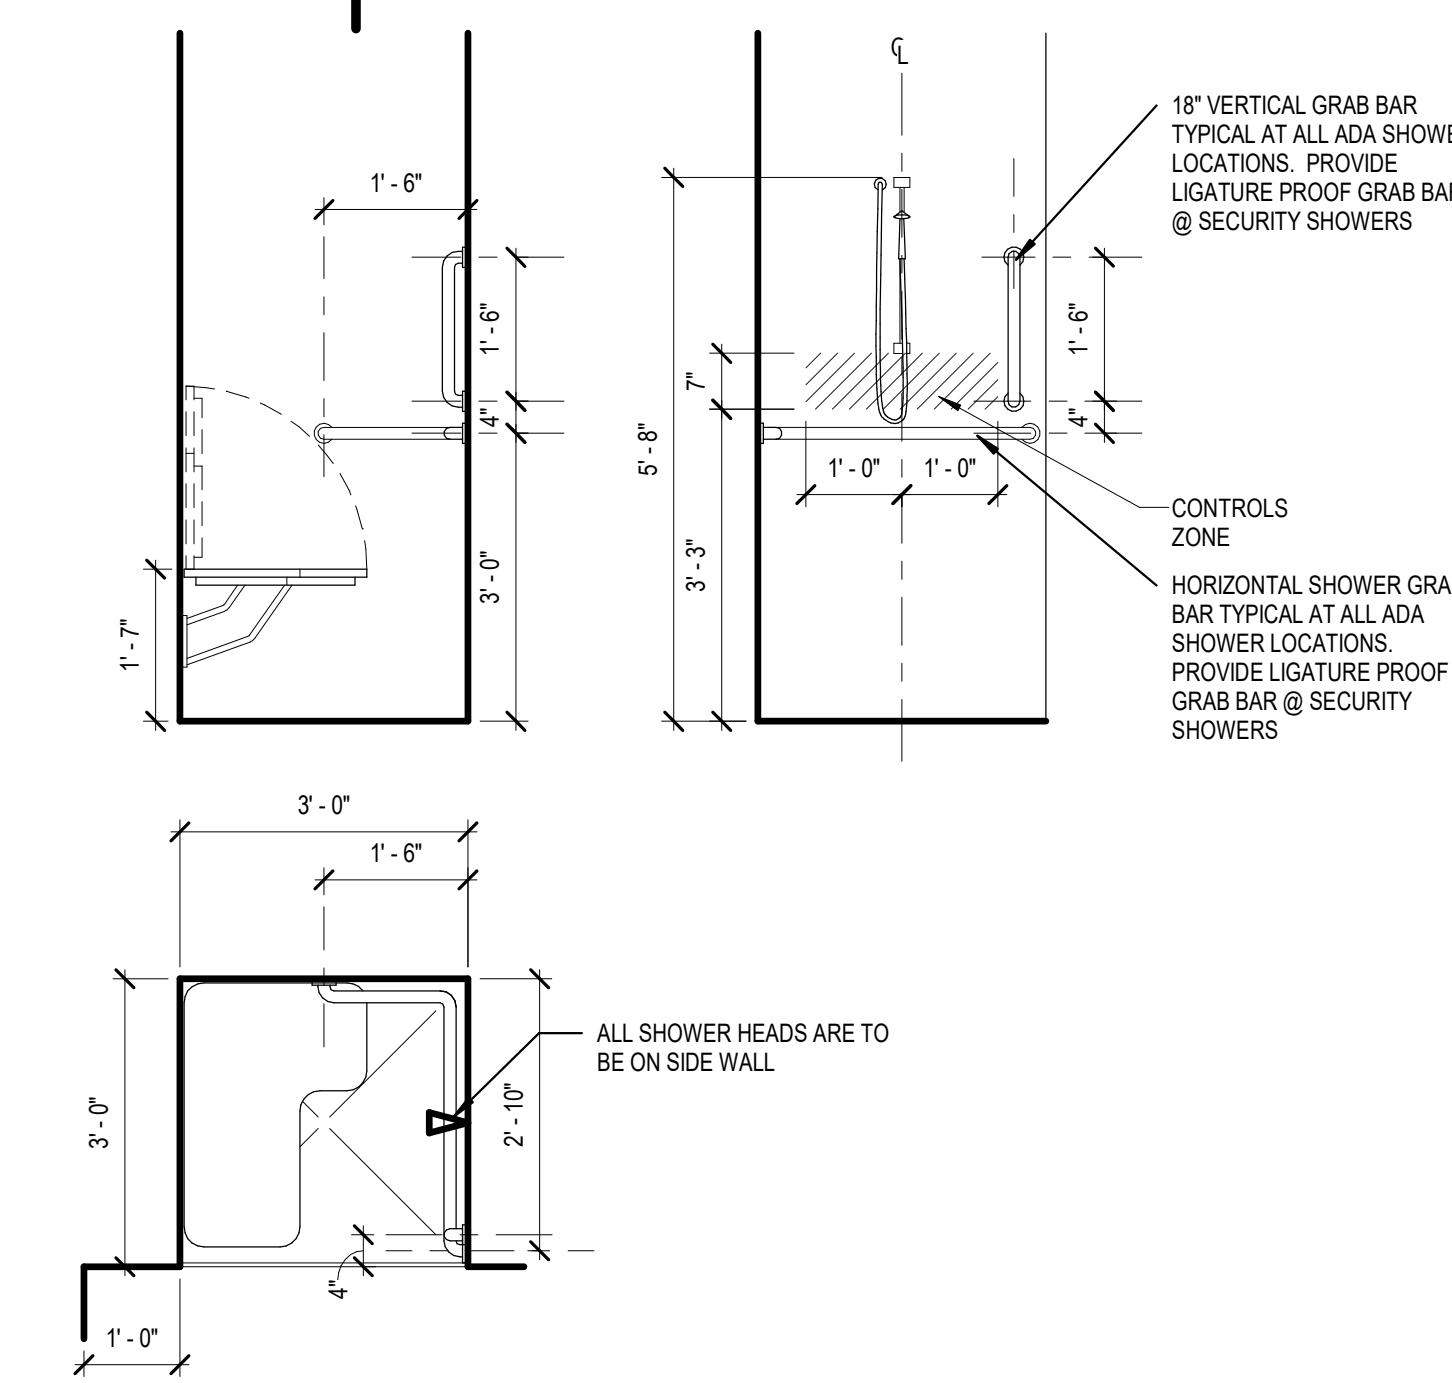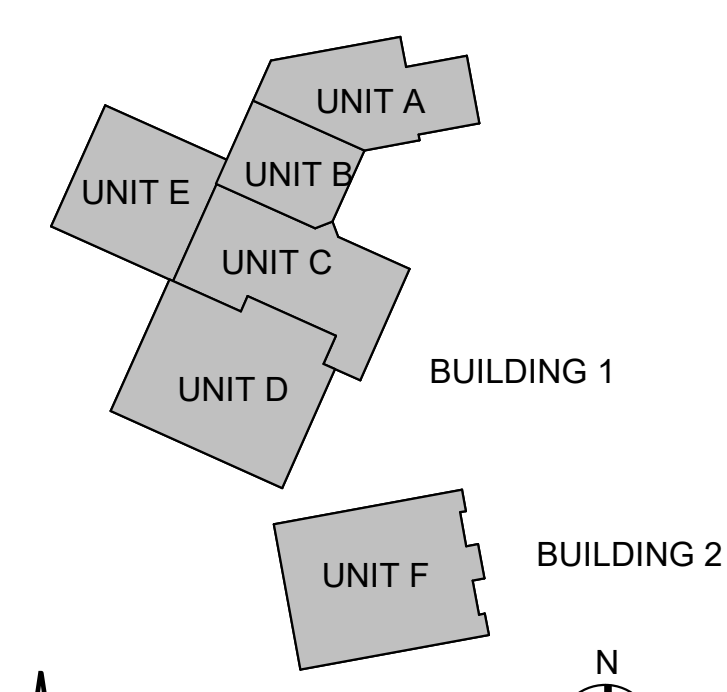


1C TYPICAL CONTROL JOINTS  
1/8" = 1'-0"

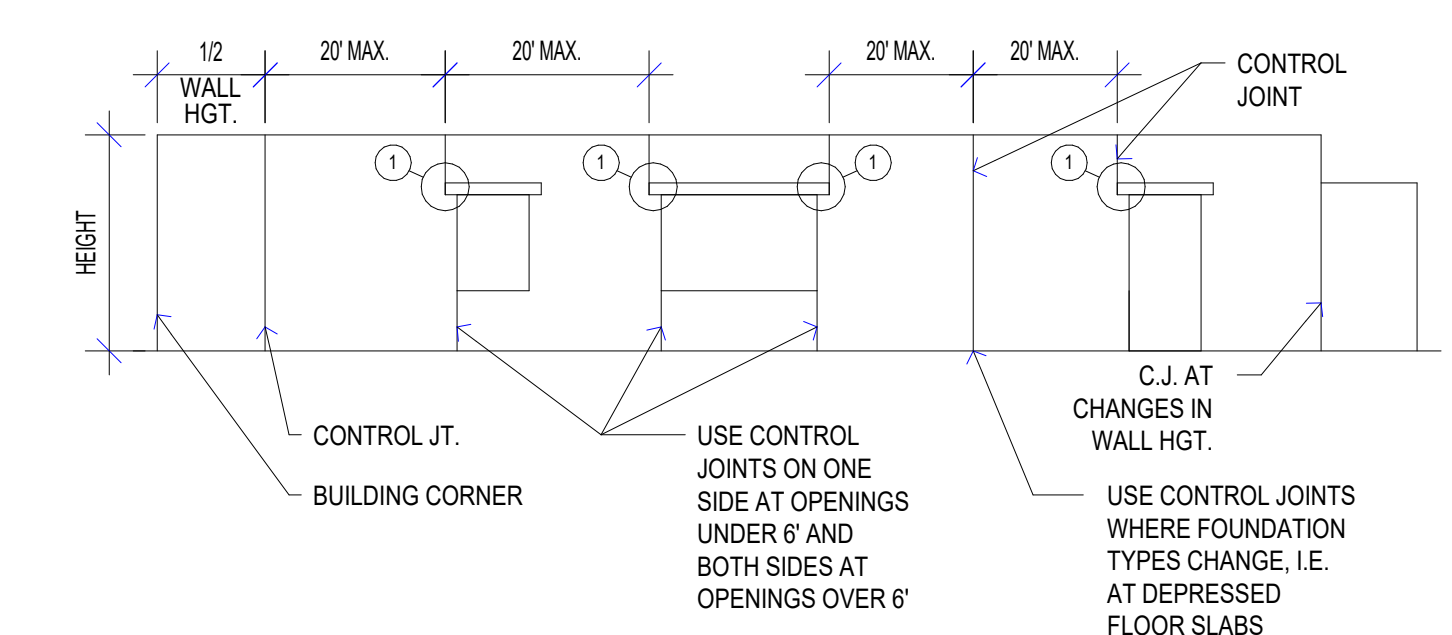


1B THRU-WALL FLASHING END DAM DETAIL  
1 1/2" = 1'-0"

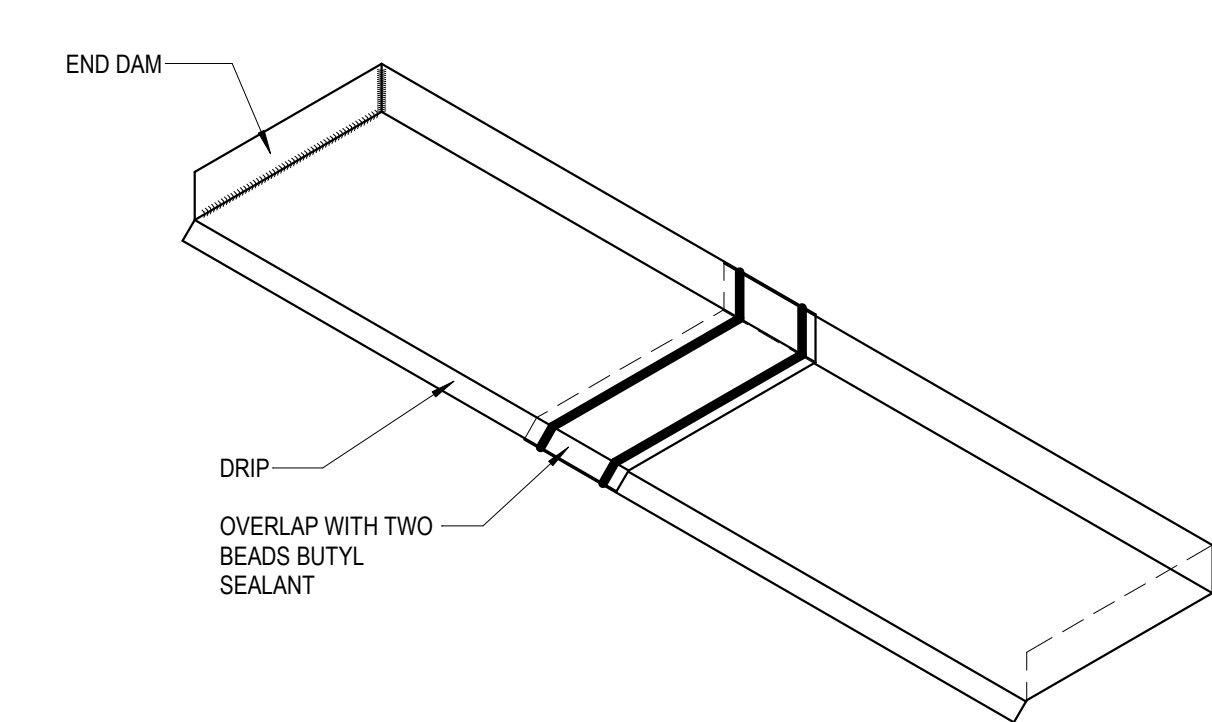


1A SEALANT JOINT W/BACKING  
8" = 1'-0"

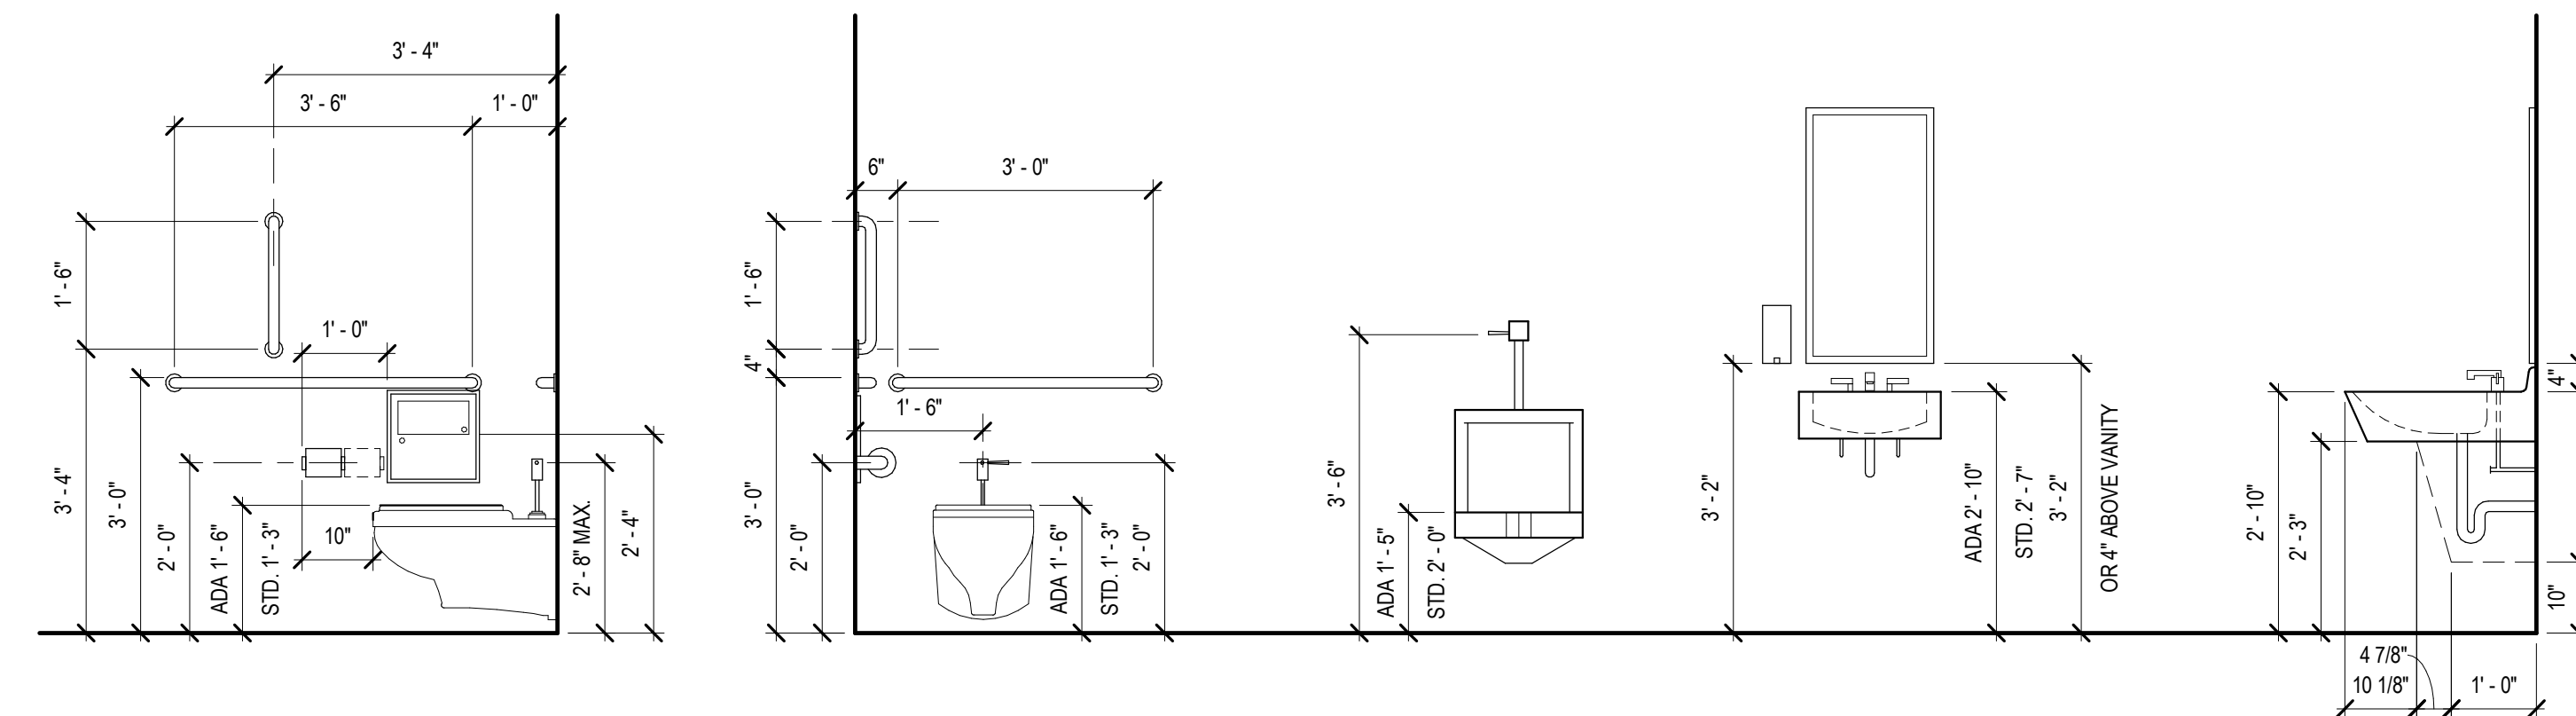


2E STANDARD RESTROOM ELEVATIONS  
1/2" = 1'-0"

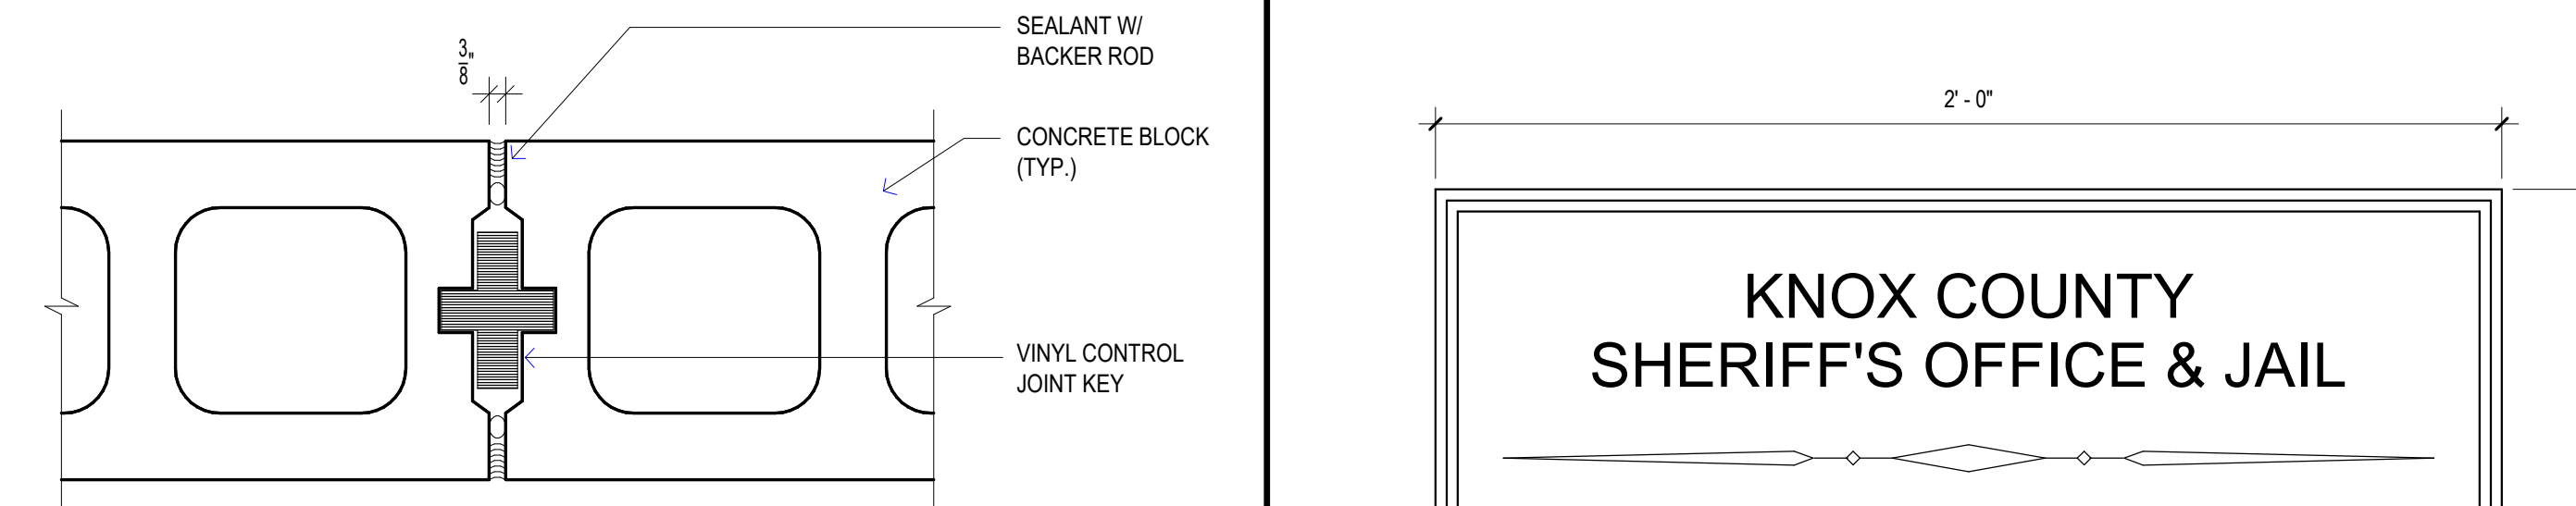


2D TYPICAL CONTROL JOINT DETAIL  
3" = 1'-0"

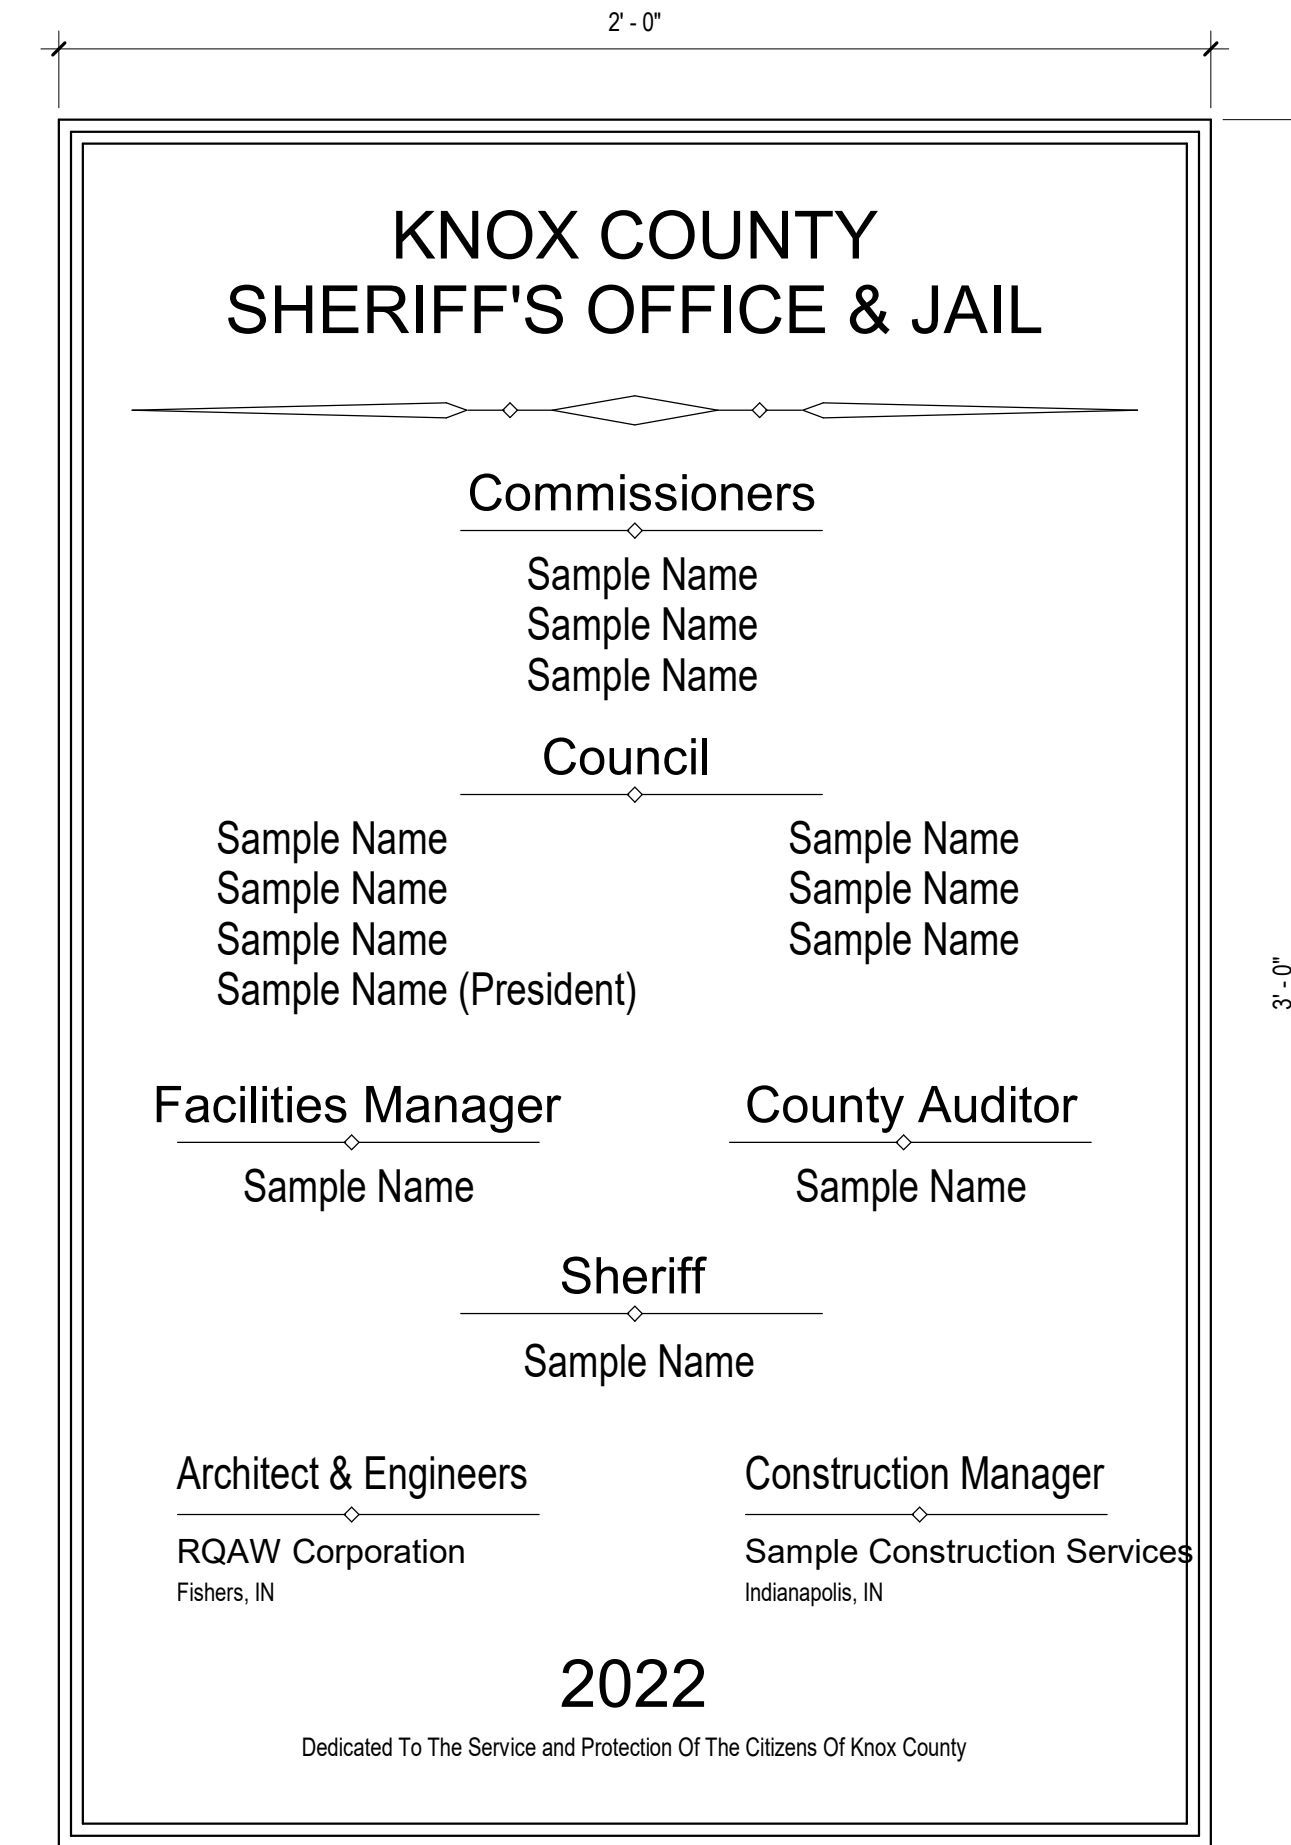

2B SAMPLE BUILDING DEDICATION BRONZE 24"x36" PLAQUE  
3" = 1'-0"

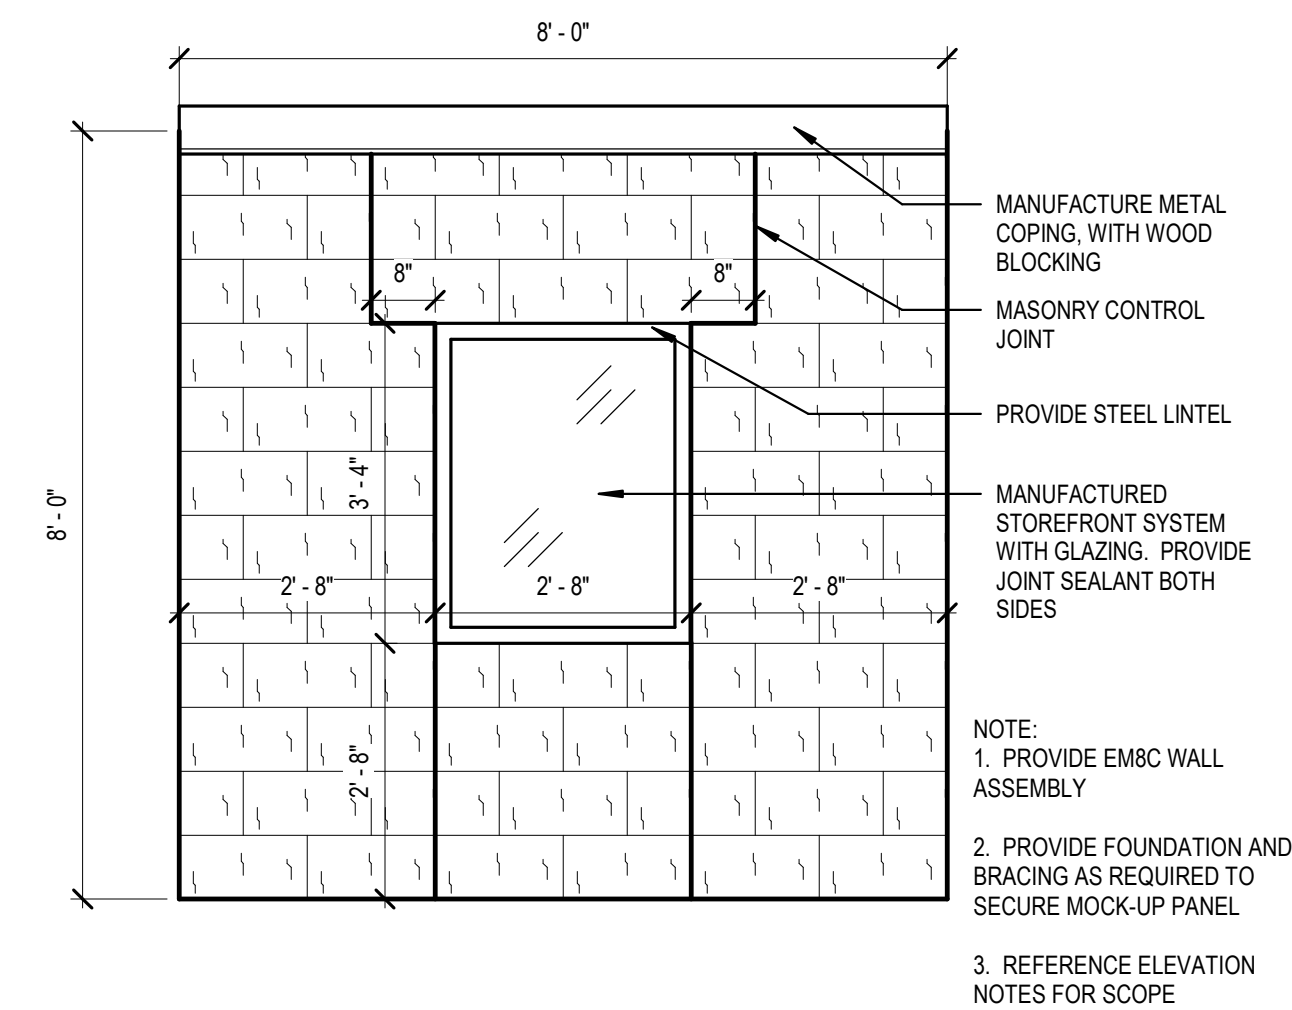


2A MOCK-UP DETAIL  
1/2" = 1'-0"

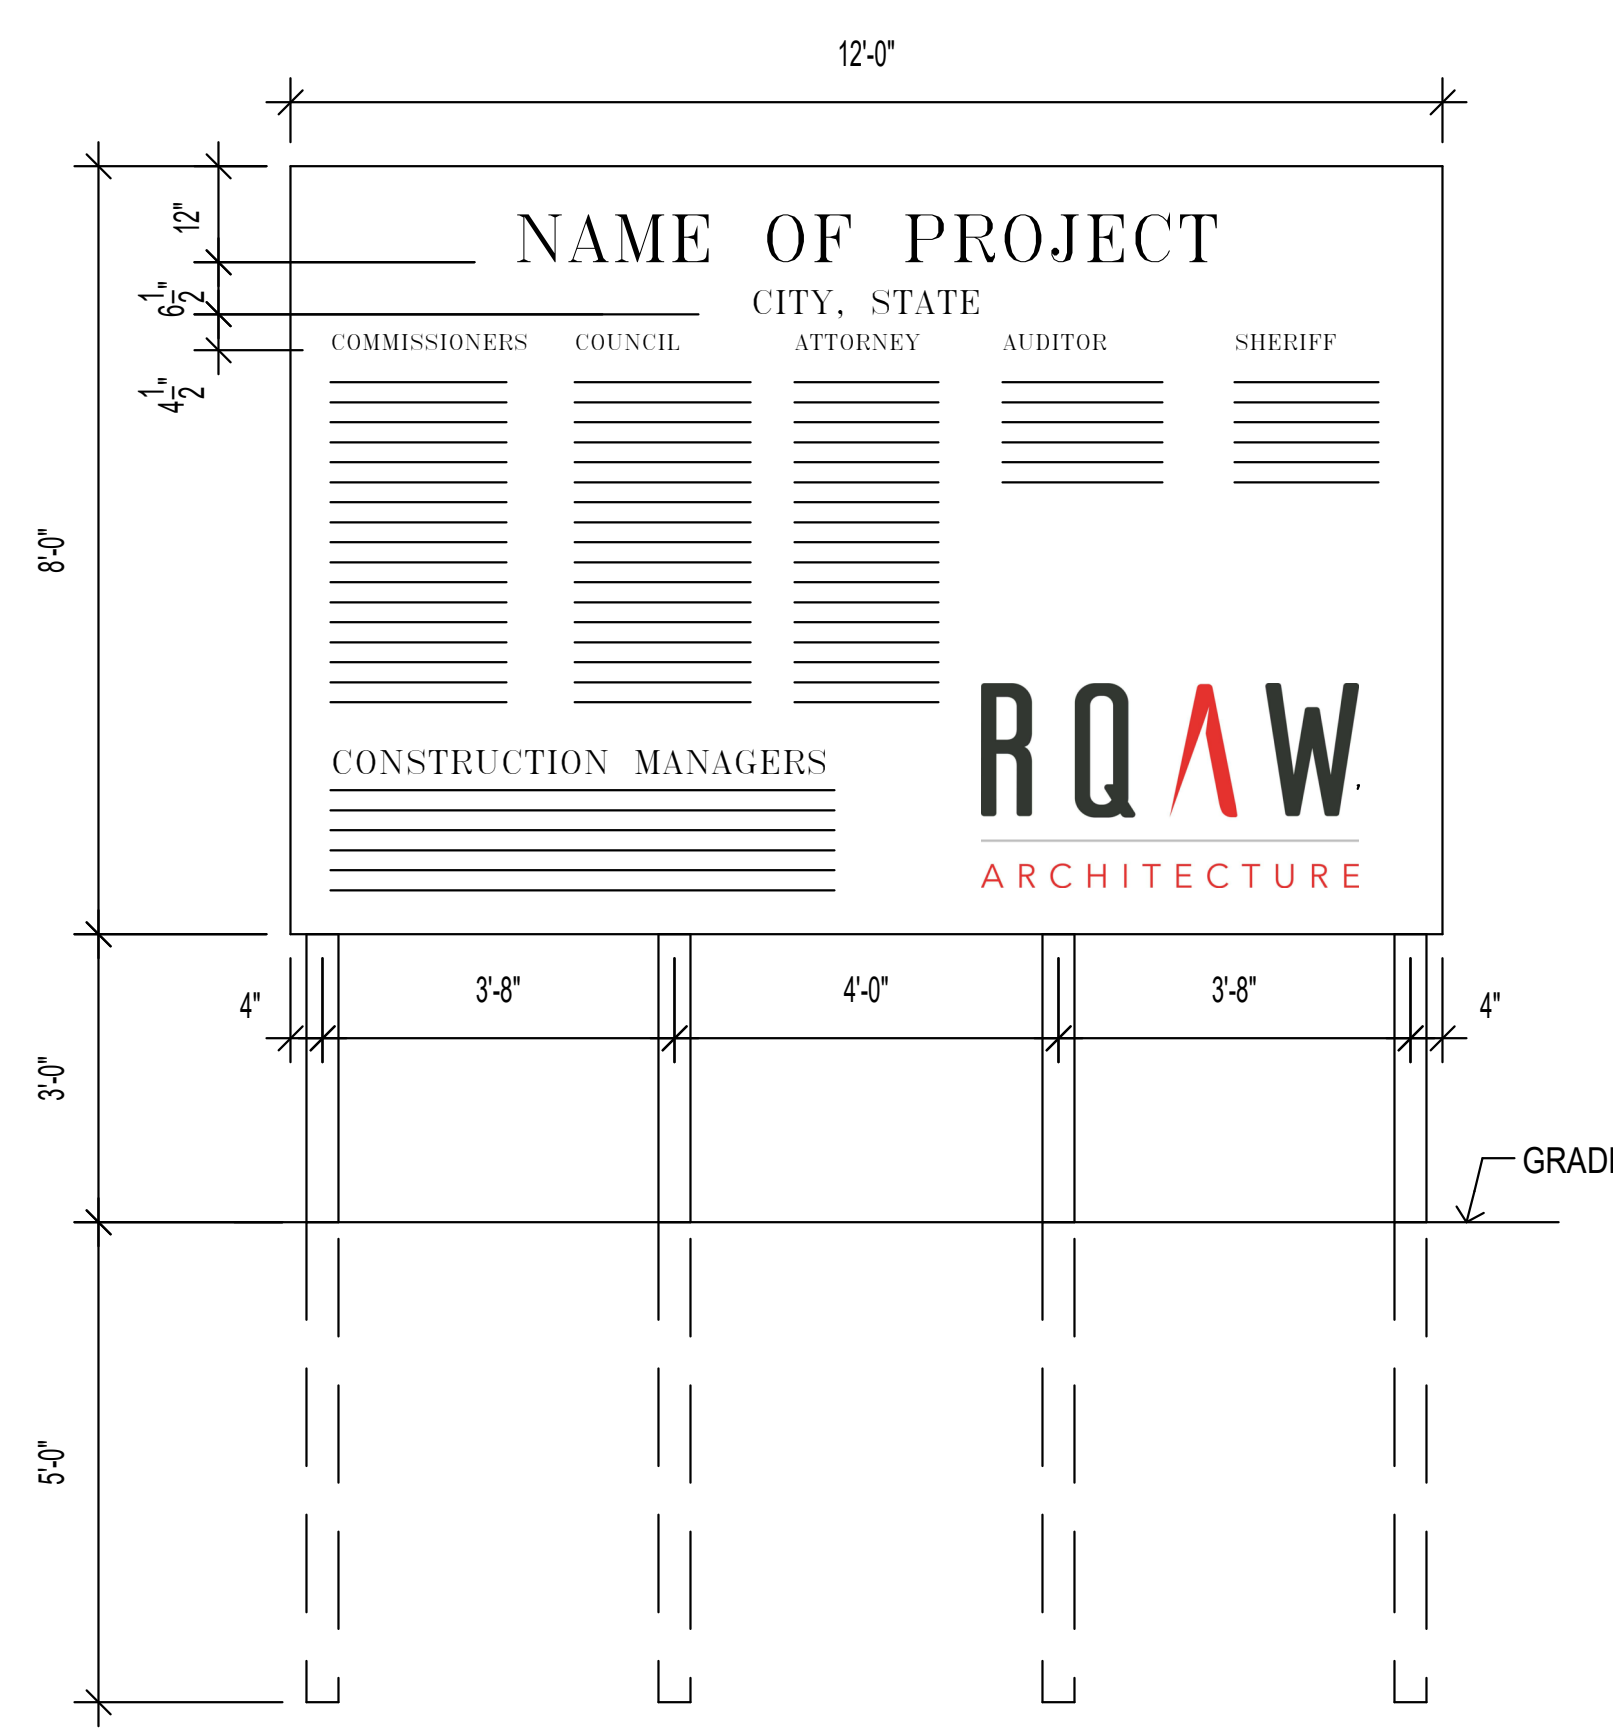


4A PROJECT SIGN  
1/2" = 1'-0"


- NOTES:
- SUBMIT SHOP DRAWING TO ARCHITECT FOR REVIEW PRIOR TO CONSTRUCTION.
  - LOCATE PER ARCHITECT'S DIRECTION.
  - SEE 01500.02 FOR ADDITIONAL INFORMATION
  - A COPY OF THE RENDERING (24"x36" or 81/2"x11") WILL BE PROVIDED TO THE SUCCESSFUL BIDDER.
  - RENDERING TO BE FULL SIZE, FULL COLOR, PAINTED RENDERING

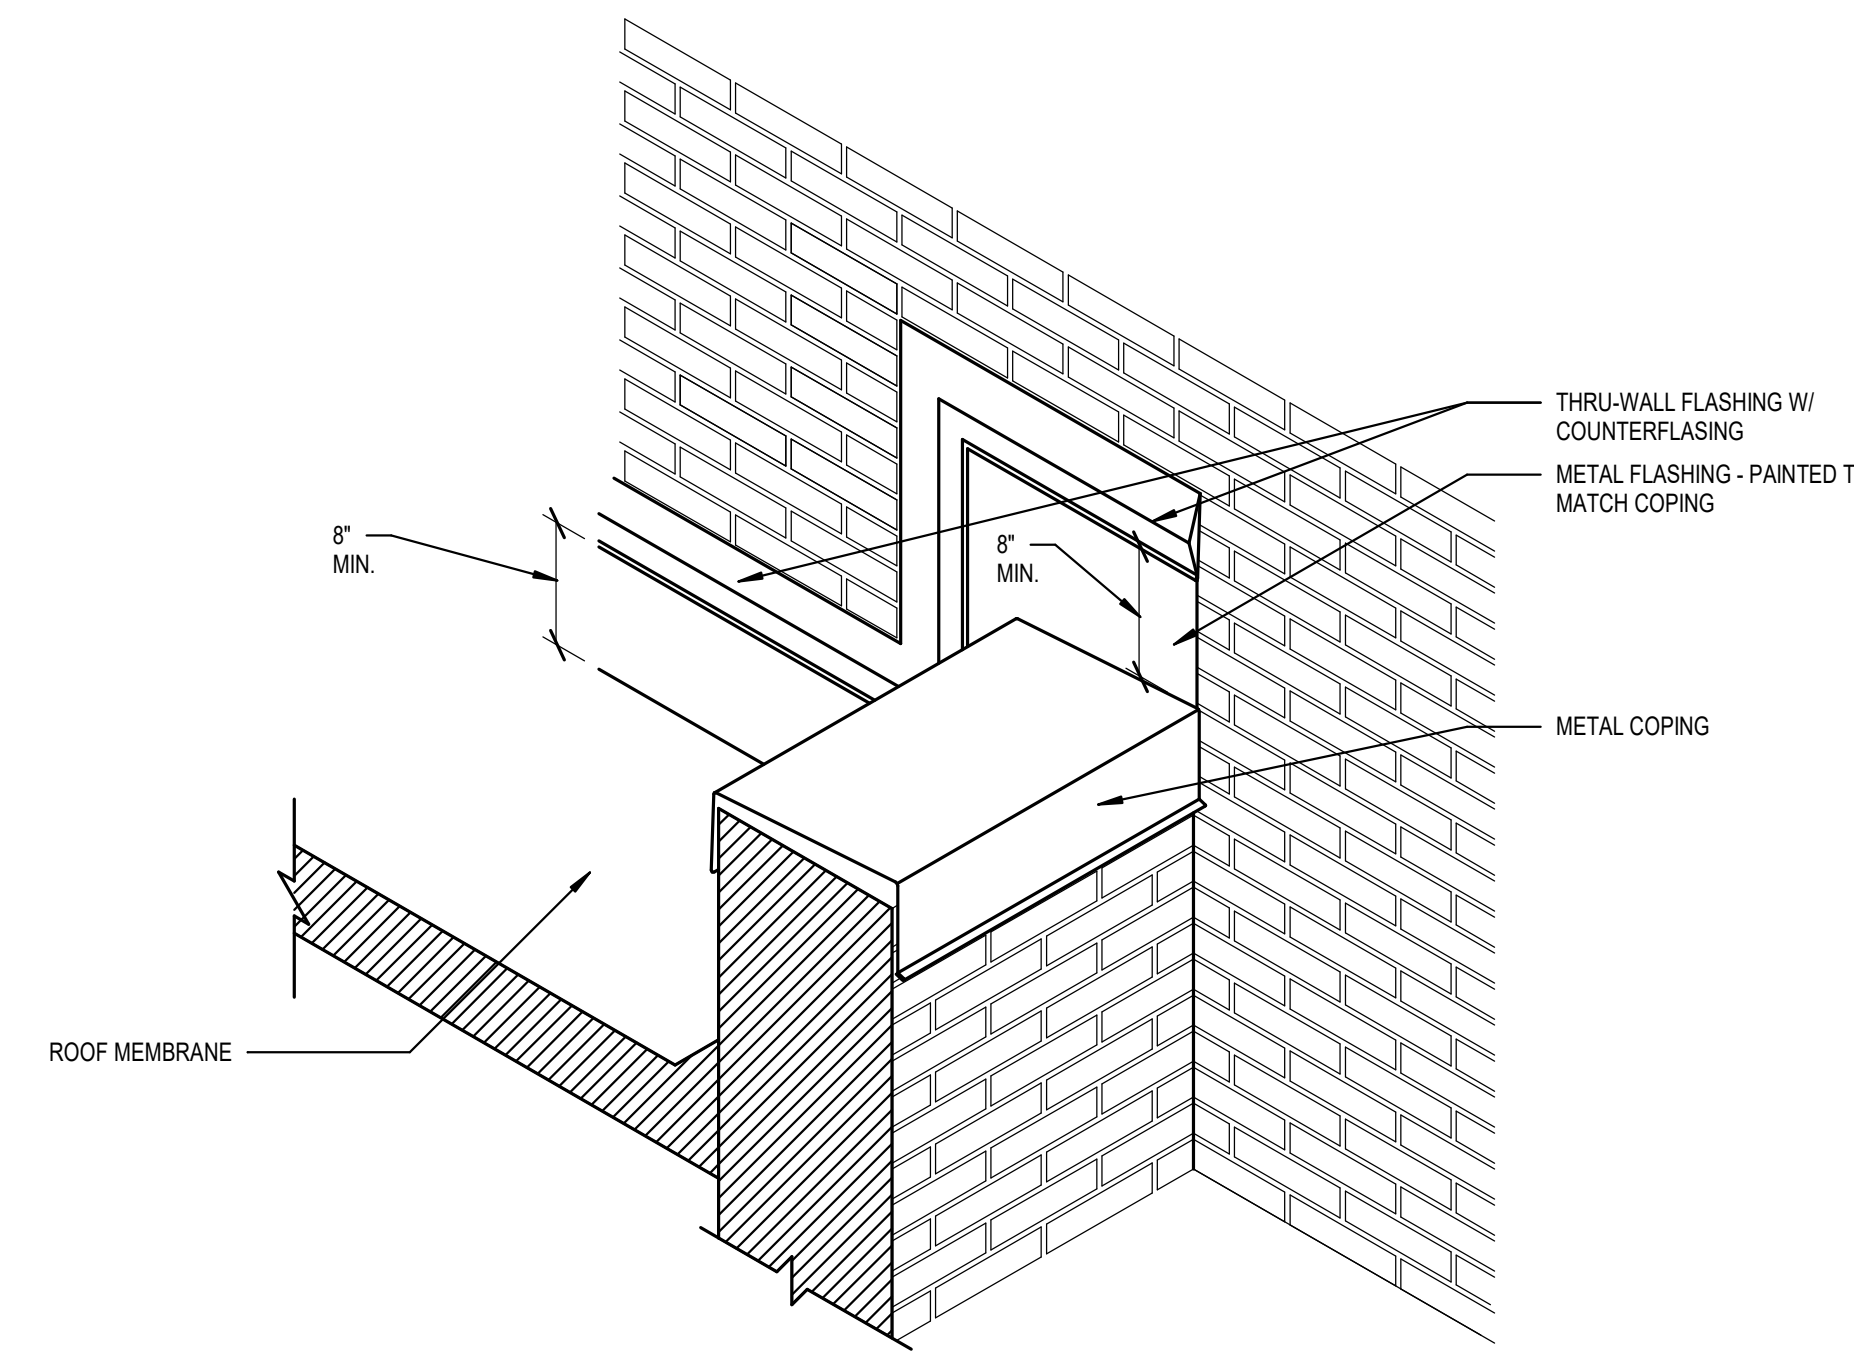

1 COPING ABUTMENT DETAIL  
1" = 1'-0"

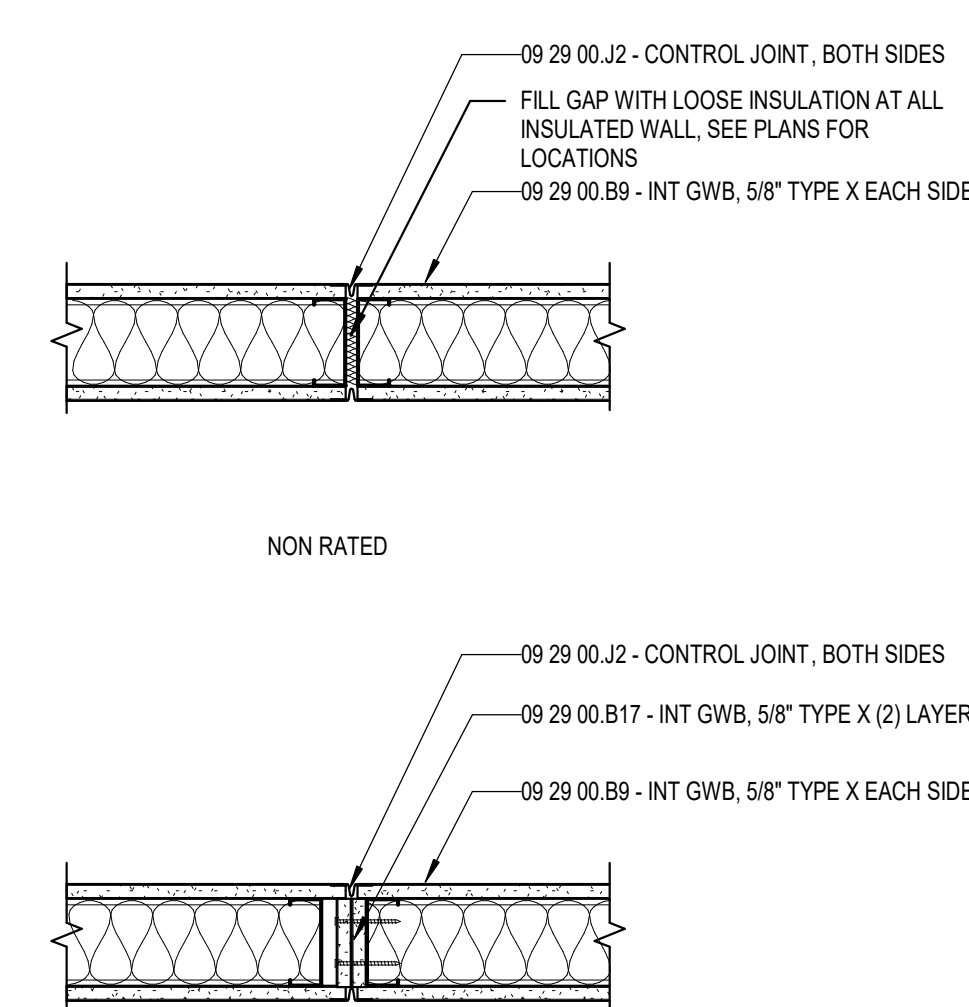


2 GYPSUM WALLS CONTROL JOINTS  
1 1/2" = 1'-0"

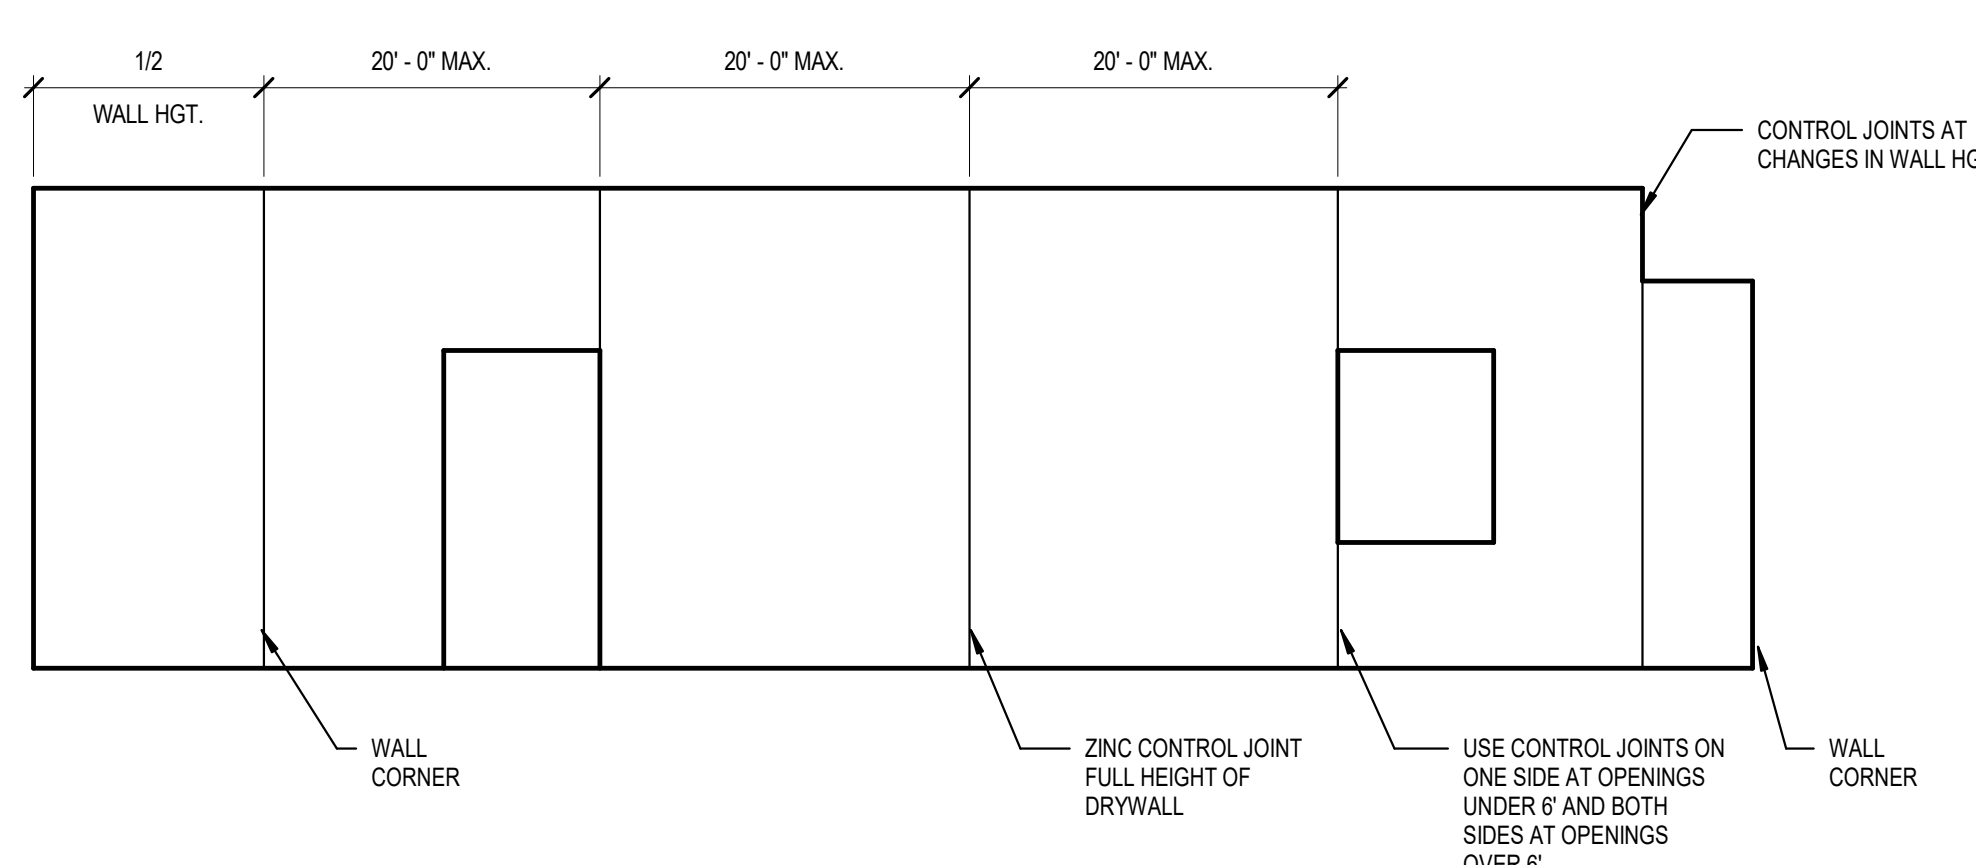

2 GYPSUM WALLS CONTROL JOINTS  
1 1/2" = 1'-0"



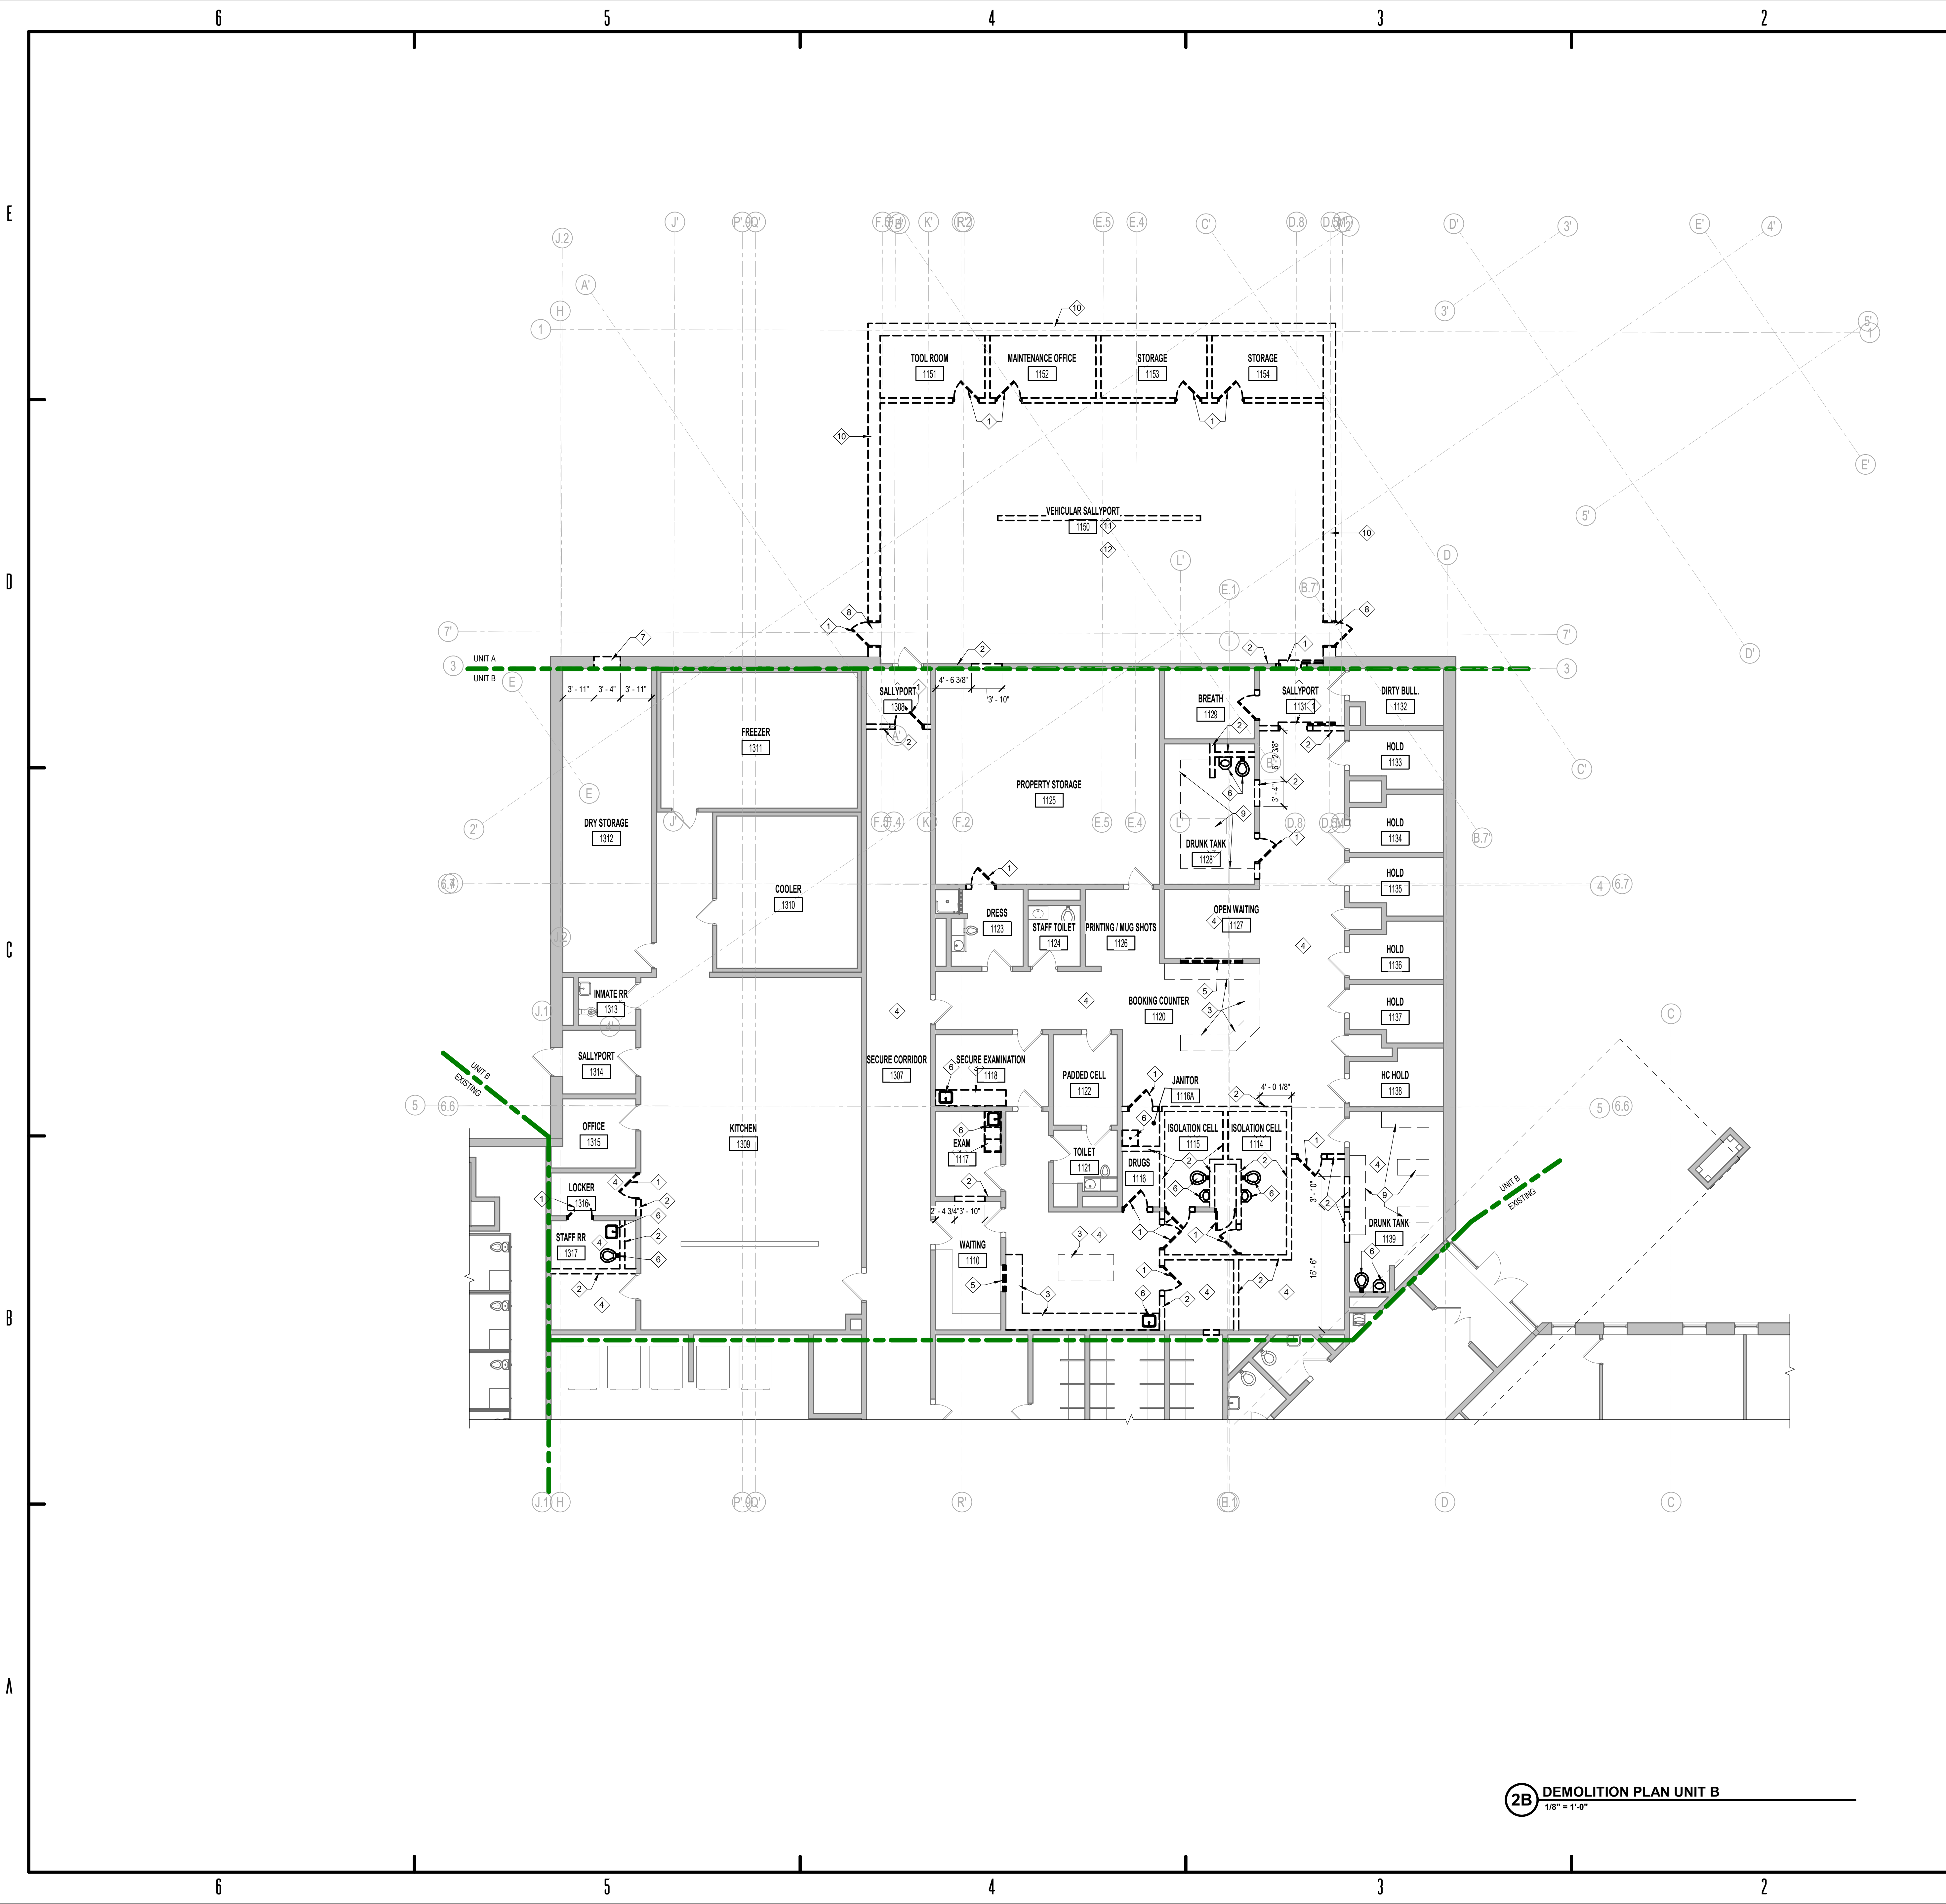

**2B** DEMOLITION PLAN UNIT B  
1/8" = 1'-0"

5.4.092 - DEMO FLOOR PLAN...	
Key	Note
1	REMOVE EXISTING DOOR AND FRAME IN ITS ENTIRETY, INCLUDING ALL ACCESSORIES AND ANCHORS. PATCH EXISTING SURFACES TO REMAIN AND PREP TO RECEIVE NEW CONSTRUCTION. MATCH EXISTING WALL TYPE.
2	REMOVE EXISTING INTERIOR WALL CONSTRUCTION TO LIMITS INDICATED INCLUDING, BUT NOT LIMITED TO, DOORS, FRAMES, WINDOW SYSTEMS, BULKHEADS AND MISCELLANEOUS FRAMING. FIELD VERIFY ALL EXISTING WALL CONSTRUCTION AND CONDITIONS. REFER TO ARCHITECTURAL FLOOR PLANS FOR FINISH CONDITIONS AND DIMENSIONS. NEW CONSTRUCTION TO TOOTH-IN TO EXISTING MASONRY COURSING WHERE APPLICABLE. PATCH AND REPAIR EXISTING SURFACES TO REMAIN.
3	REMOVE EXISTING CASEWORK TO LIMITS INDICATED, INCLUDING BUT NOT LIMITED TO ANY ADHESIVES AND ANCHORS. PATCH AND PREP SURFACES TO REMAIN TO RECEIVE NEW CONSTRUCTION.
4	REMOVE EXISTING CEILING SYSTEM IN ITS ENTIRETY, INCLUDING ALL ACCESSORIES, ANCHORS AND ADHESIVES. PATCH EXISTING SURFACES TO REMAIN TO RECEIVE NEW CONSTRUCTION.
5	REMOVE EXISTING WINDOW ASSEMBLY IN ITS ENTIRETY, INCLUDING ALL ASSOCIATED HARDWARE, ANCHORS AND BRACING. PREPARE OPENING FOR NEW CONSTRUCTION. REFERENCE ARCHITECTURAL FLOOR PLANS FOR NEW CONSTRUCTION.
6	REMOVE EXISTING PLUMBING FIXTURES IN ITS ENTIRETY, INCLUDING ALL ANCHORS, ADHESIVES, AND ACCESSORIES. PREP SURFACES TO REMAIN TO RECEIVE NEW CONSTRUCTION. ADJUST EXISTING PLUMBING AS REQUIRED TO RECEIVE NEW CONSTRUCTION. COORDINATE WITH PLUMBING DRAWINGS.
7	REMOVE EXISTING EXTERIOR WALL CONSTRUCTION TO LIMITS INDICATED INCLUDING, BUT NOT LIMITED TO, DOORS, FRAMES, WINDOW SYSTEMS, BULKHEADS AND MISCELLANEOUS FRAMING. FIELD VERIFY ALL EXISTING WALL CONSTRUCTION AND CONDITIONS. REFER TO ARCHITECTURAL FLOOR PLANS FOR FINISH CONDITIONS AND DIMENSIONS. NEW CONSTRUCTION TO TOOTH-IN TO EXISTING MASONRY COURSING WHERE APPLICABLE. PATCH AND REPAIR EXISTING SURFACES TO REMAIN.
8	REMOVE ALL EXTENTS OF EXISTING TRANSITION STRIP
9	REMOVE EXISTING CONCRETE BENCH IN ITS ENTIRETY, INCLUDING ALL ACCESSORIES, ADHESIVES, AND ANCHORS. PATCH EXISTING SURFACES TO REMAIN AND PREP TO RECEIVE NEW CONSTRUCTION.
10	REMOVE EXISTING EXTERIOR WALL CONSTRUCTION IN ITS ENTIRETY TO 8" BELOW GRADE, INCLUDING, BUT NOT LIMITED TO, DOOR, FRAMES, WINDOW SYSTEMS. FIELD VERIFY EXISTING WALL CONSTRUCTION AND CONDITIONS.
11	REMOVE EXISTING CONCRETE SLAB IN ITS ENTIRETY.
12	REMOVE EXISTING ROOF AND ROOF STRUCTURE IN ITS ENTIRETY.



BID SET

KNOX COUNTY BOARD OF COMMISSIONERS

**KNOX COUNTY JUSTICE CAMPUS**

2375 OLD DECKER RD. VINCENNES, IN 47591

#	Revision	Date
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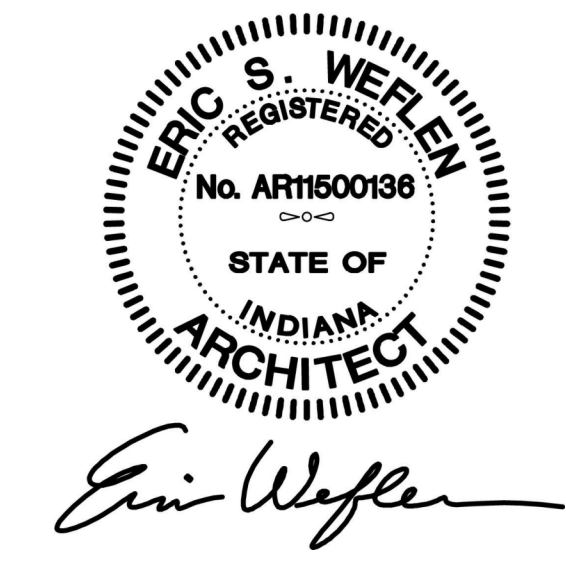
Project #: 20-700-151-2

Designed By: LD/SP


Drawn By: CW

Checked By: LD/EV

Date: 01.28.2022



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DEMOLITION PLAN UNIT B

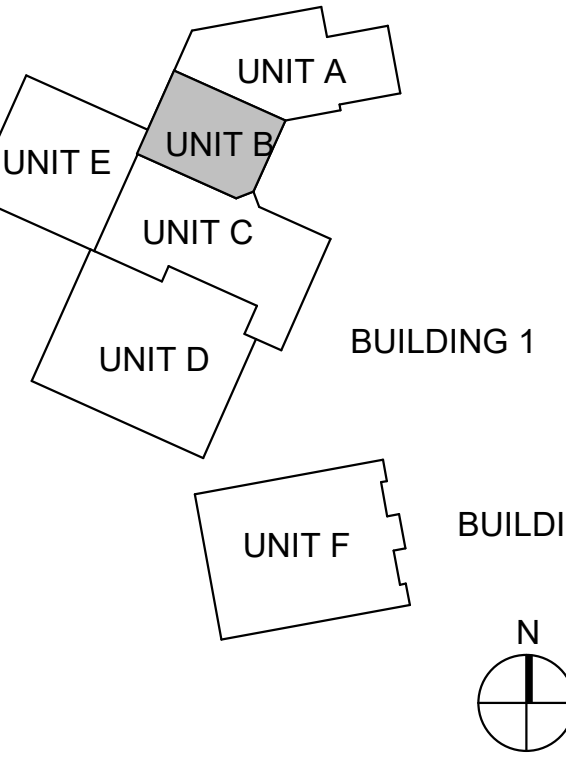



5.4.092 - DEMO FLOOR PLAN...	
Key	Note
1	REMOVE EXISTING DOOR AND FRAME IN ITS ENTIRETY, INCLUDING ALL ACCESSORIES AND ANCHORS. PATCH EXISTING SURFACES TO REMAIN AND PREP TO RECEIVE NEW CONSTRUCTION. MATCH EXISTING WALL TYPE.
2	REMOVE EXISTING INTERIOR WALL CONSTRUCTION TO LIMITS INDICATED INCLUDING, BUT NOT LIMITED TO, DOORS, FRAMES, WINDOW SYSTEMS, BULKHEADS AND MISCELLANEOUS FRAMING. FIELD VERIFY ALL EXISTING WALL CONSTRUCTION AND CONDITIONS. REFER TO ARCHITECTURAL FLOOR PLANS FOR FINISH CONDITIONS AND DIMENSIONS. NEW CONSTRUCTION TO TOOTH-IN TO EXISTING MASONRY COURSING WHERE APPLICABLE. PATCH AND REPAIR EXISTING SURFACES TO REMAIN.
3	REMOVE EXISTING CASEWORK TO LIMITS INDICATED, INCLUDING BUT NOT LIMITED TO ANY ADHESIVES AND ANCHORS. PATCH EXISTING SURFACES TO REMAIN TO RECEIVE NEW CONSTRUCTION.
4	REMOVE EXISTING CEILING SYSTEM IN ITS ENTIRETY, INCLUDING ALL ACCESSORIES, ANCHORS AND ADHESIVES. PATCH EXISTING SURFACES TO REMAIN TO RECEIVE NEW CONSTRUCTION.
5	REMOVE EXISTING WINDOW ASSEMBLY IN ITS ENTIRETY, INCLUDING ALL ASSOCIATED HARDWARE, ANCHORS AND BRACING. PREPARE OPENING FOR NEW CONSTRUCTION. REFERENCE ARCHITECTURAL FLOOR PLANS FOR NEW CONSTRUCTION.
6	REMOVE EXISTING PLUMBING FIXTURES IN ITS ENTIRETY, INCLUDING ALL ANCHORS, ADHESIVES, AND ACCESSORIES. PREP SURFACES TO REMAIN TO RECEIVE NEW CONSTRUCTION. ADJUST EXISTING PLUMBING AS REQUIRED TO RECEIVE NEW CONSTRUCTION. COORDINATE WITH PLUMBING DRAWINGS.
7	REMOVE EXISTING EXTERIOR WALL CONSTRUCTION TO LIMITS INDICATED INCLUDING, BUT NOT LIMITED TO, DOORS, FRAMES, WINDOW SYSTEMS, BULKHEADS AND MISCELLANEOUS FRAMING. FIELD VERIFY ALL EXISTING WALL CONSTRUCTION AND CONDITIONS. REFER TO ARCHITECTURAL FLOOR PLANS FOR FINISH CONDITIONS AND DIMENSIONS. NEW CONSTRUCTION TO TOOTH-IN TO EXISTING MASONRY COURSING WHERE APPLICABLE. PATCH AND REPAIR EXISTING SURFACES TO REMAIN.
8	REMOVE ALL EXTENTS OF EXISTING TRANSITION STRIP
9	REMOVE EXISTING CONCRETE BENCH IN ITS ENTIRETY, INCLUDING ALL ACCESSORIES, ADHESIVES, AND ANCHORS. PATCH EXISTING SURFACES TO REMAIN AND PREP TO RECEIVE NEW CONSTRUCTION.
10	REMOVE EXISTING EXTERIOR WALL CONSTRUCTION IN ITS ENTIRETY TO 8" BELOW GRADE, INCLUDING, BUT NOT LIMITED TO, DOOR, FRAMES, WINDOW SYSTEMS. FIELD VERIFY EXISTING WALL CONSTRUCTION AND CONDITIONS.
11	REMOVE EXISTING CONCRETE SLAB IN ITS ENTIRETY.
12	REMOVE EXISTING ROOF AND ROOF STRUCTURE IN ITS ENTIRETY.
13	EXTENTS OF CEILING DEMOLITION. REMOVE TO NEAREST CEILING GRID LINE. PROTECT REMAINING EXISTING CEILING.



BID SET

KNOX COUNTY BOARD OF COMMISSIONERS

KNOX COUNTY JUSTICE CAMPUS

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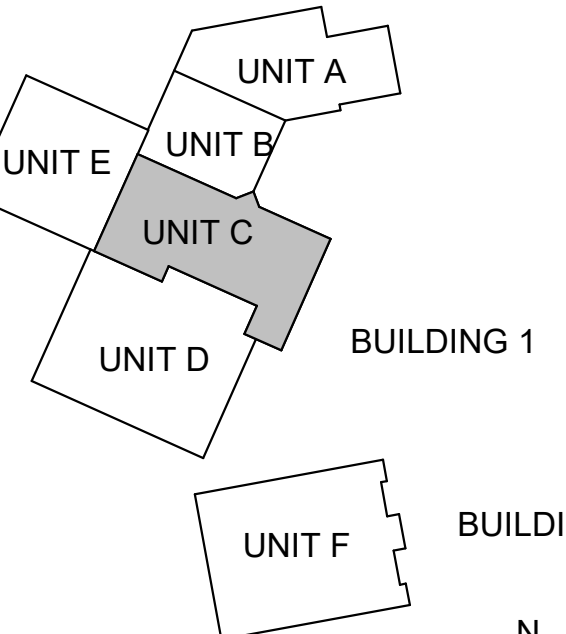
Drawn By: CW

Checked By: LD

Date: 02.04.2022



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DEMOLITION PLAN UNIT C

AD 1C1



#	Revision	Date
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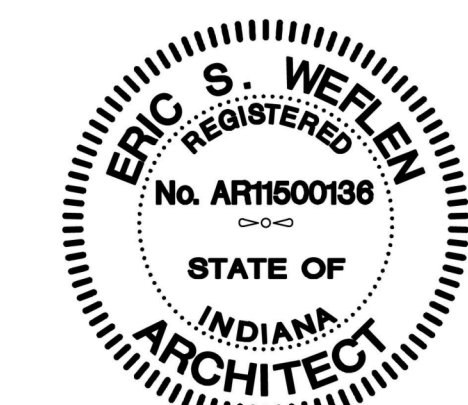
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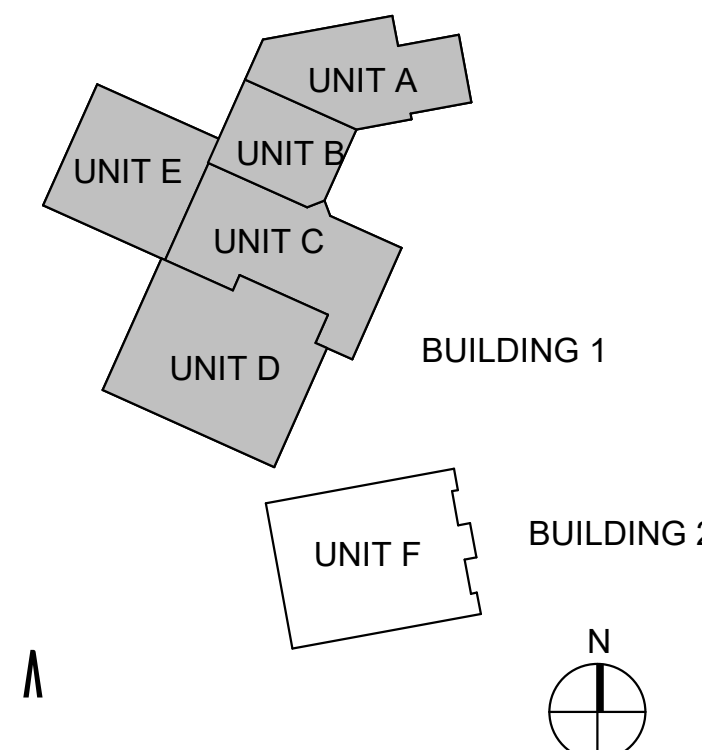
Drawn By: JW

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OVERALL FIRST FLOOR  
PLAN BUILDING 1

AF 101

## General Plan Notes

- A. PLAN NOTES INDICATE ONE GRAPHIC REPRESENTATION TYPICAL. THE CONTRACTOR SHALL USE THE GRAPHIC REPRESENTATIONS FOR THE COUNT. NOT THE KEYED PLAN NOTES. THE ABSENCE OF A KEYED PLAN NOTE ON THE PLAN DOES NOT ABSOLVE THE CONTRACTOR FROM PROVIDING THE FEATURE GRAPHICALLY REPRESENTED ON THE DRAWINGS.
- B. ALL DIMENSIONS SHOWN ARE TO FACE OF STUD OR MASONRY, UNLESS NOTED OTHERWISE. DIMENSIONS DESIGNATED AS "CLR OR "CLEAR" INDICATE A CLEAR DIMENSION FROM FACE OF FINISH TO FACE OF FINISH. DIMENSIONS OF EXTERIOR WALLS ARE TO OUTSIDE EDGE OF FOUNDATION.
- C. DIMENSIONS FOR ALL OPENINGS FOR MECHANICAL, PLUMBING, FIRE PROTECTION AND ELECTRICAL SHALL BE FIRE STOPPED AT EACH FLOOR AND RATED WALL PENETRATION.
- D. PROVIDE BRACING AND BLOCKING AS REQUIRED IN WALLS SUPPORTING CASEWORK, TACKBOARDS, MARKERBOARDS, TELEVISIONS, RESTROOM ACCESSORIES, AND ANY ADDITIONAL WALL MOUNTED EQUIPMENT. COORDINATE WALL MOUNTED EQUIPMENT WITH MECHANICAL, ELECTRICAL, PLUMBING, AND FIRE PROTECTION DRAWINGS.
- E. ALL COMMERCIAL DOOR FRAMES ARE LOCATED 4" FROM ADJACENT WALL, UNLESS NOTED OTHERWISE. ALL DETENTION DOOR FRAMES ARE LOCATED 4" FROM ADJACENT WALL, UNLESS NOTED OTHERWISE.
- F. ALL EXPOSED OUTSIDE CORNERS OF CMU SHALL BE BULLNOSE.
- G. SEAL ALL JOINTS BETWEEN DISSIMILAR MATERIALS.
- H. ALL GYPSUM WALLBOARD IS 5/8" TYPE "X", UNLESS NOTED OTHERWISE.
- I. ALL EXTERIOR WALLS ARE TYPE "ES88" UNLESS NOTED OTHERWISE.
- J. ALL INTERIOR STUD WALLS ARE TYPE "S40" (3/8" METAL STUD TO DECK WITH SOUND ATTENUATION INSULATION TO UNDERSIDE OF ROOF DECK) UNLESS NOTED OTHERWISE. ALL INTERIOR MASONRY WALLS ARE M-8 (7/8" CMU TO DECK) UNLESS NOTED OTHERWISE.
- K. BASE ELEVATION IS AS INDICATED ON C200 - SITE LAYOUT PLAN (UNITED STATES GEOLOGICAL SURVEY DATA). COORDINATE WITH CIVIL DRAWINGS.
- L. ALL WALLS GOING TO DECK ARE TO BE SECURED TO DECKSTRUCTURE ABOVE AS REQUIRED. PROVIDE ADDITIONAL BRACING AS REQUIRED.
- M. ALL WALLS THAT HAVE THE DESIGNATION "C", AND ARE IN A SPACE WITH NO CEILING WILL BE 10FT TALL.
- N. DRAWINGS ESTABLISH THE DESIGN INTENT OF WORK TO BE PERFORMED. ALL WORK SHALL BE PERFORMED IN ACCORDANCE WITH THE HIGHEST INDUSTRY STANDARDS. ALL PRODUCTS SHALL BE INSTALLED IN ACCORDANCE WITH THE MANUFACTURER'S RECOMMENDATIONS. ALL TRADES SHALL CAREFULLY COORDINATE WORK OF ALL OTHER TRADES. ANY DISCREPANCIES OR CONFLICTS SHALL BE BROUGHT TO THE IMMEDIATE ATTENTION OF THE ARCHITECT AND THE OWNER PRIOR TO FABRICATION OR INSTALLATION.
- O. CONTRACTORS SHALL BE RESPONSIBLE FOR CHECKING THE CONSTRUCTION DOCUMENTS FOR COORDINATION BETWEEN ARCHITECTURAL, STRUCTURAL, CIVIL, MECHANICAL, ELECTRICAL, PLUMBING, SECURITY AND LANDSCAPING. CONTRACTORS SHALL BE RESPONSIBLE FOR FIELD VERIFYING EXISTING CONDITIONS AND FOR VERIFYING WITH THE CONTRACT DOCUMENTS. ANY DISCREPANCY IN THE CONTRACT DRAWINGS AND SPECIFICATIONS SHALL BE BROUGHT TO THE NOTICE OF THE ARCHITECT PRIOR TO ANY FABRICATION OR CONSTRUCTION.
- P. ALL CORRIDOR SURFACES SHALL BE FLUSH AT JUNCTIONS OF MASONRY AND STUD WALLS. MASONRY WALL LOCATIONS SHALL HOLD TRUE AND NOT BE MOVED. STUDS SHALL BE MOVED AS REQUIRED TO PROVIDE FLUSH CONNECTION BETWEEN GYP. BD. AND MASONRY. VERIFY NO. OF LAYERS OF GYP. BD. BY WALL TYPES. RELOCATION OF WALL SHALL BE APPROVED BY ARCHITECT PRIOR TO CONST. AT TRANSITIONS FROM 1 LAYER GYP. BD. TO 2 LAYERS OF GYP. BD. ON INTL. STUDS A MIN. CORRIDOR WIDTH OF 5'-2" FROM FACE OF STUDS SHALL BE MAINTAINED.
- Q. ALL BUILDING MATERIALS (INCLUDING BUT NOT LIMITED TO METAL FLASHING, VAPOR BARRIERS, AIRWATER RESISTANT BARRIERS, THRU-WALL FLASHING, ETC.) SHALL BE LAPPED TO SHED WATER TO THE OUTSIDE OF THE BUILDING ENVELOPE.
- R. SEE CODE COMPLIANCE PLAN G-101 AND G-102 FOR FIRE RATED WALLS.
- S. SEE WALL TYPE SHEET A-002 FOR WALLS AND CONSTRUCTION REQUIREMENTS. SEE A-003 FOR ADDITIONAL GENERAL WALL DETAILS.
- T. WHEREVER POSSIBLE KEEP MINIMUM SIZE OF CUT MASONRY TO 4" OR GREATER.
- U. ALL DIAGONAL WALLS SHALL BE AT 45° (UN.O.)
- V. COORDINATE WITH STRUCTURAL DRAWINGS FOR CONTROL/EXPANSION JOINT LOCATIONS.
- W. SLOPE CONCRETE SLABS TO FLOOR DRAINS AT 1/8" MIN. PER FT.
- X. ALL CMU WALLS WITH EMBEDDED DETENTION EQUIP. TO HAVE WALLS GROUTED SOLID & REIN. W/ #4 BAR @ 1' O.C. FOR MIN. 4'-0" AROUND EMBEDDED EQUIPMENT OR USE STEEL BLOCKS.
- Y. ALL EXPOSED PIPES, DUCTS CONDUITS IN SECURITY AREAS SHALL BE ENCLOSED WITH SECURITY BULKHEAD/COVERPLATES. PROVIDE TAMPER RESISTANT ANCHORS.
- Z. ALL DOORS AND BORROWED LITE FRAMES IN SECURITY MASONRY WALLS TO BE FULLY GROUTED. ALL SECURITY DOORS AND BORROWED LITE FRAMES IN MASONRY WALLS TO BE FULLY GROUTED. ALL SECURITY DOORS AND BORROWED LITE FRAMES IN STUD WALLS TO HAVE JAMBS FULLY GROUTED UNLESS NOTED OTHERWISE.
- AA. WHEREVER VOLUME DAMPERS (V.D.) ARE LOCATED ABOVE SECURITY CEILINGS, PROVIDE 2"x2'-0" ACCESS PANELS IN THE CEILING. REFER TO MECHANICAL DRAWINGS FOR NUMBER AND LOCATION. COORDINATE WITH ELECTRICAL DRAWINGS. PANELS SHALL BE SECURITY TYPE TO MATCH ADJACENT CEILING.
- BB. ALL CHASE WALLS SHALL BE FULL HEIGHT UNLESS NOTED OTHERWISE.
- CC. ALL INTERIOR AND EXTERIOR EXPOSED STEEL TO BE PAINTED. COLOR TO BE SELECTED BY ARCHITECT.
- DD. PROVIDE (1) ONE 8"x12" GRAPHIC SITE CONSTRUCTION SIGNS. ARCHITECT TO PROVIDE GRAPHIC CONTRACTOR TO INSTALL.
- EE. ALL EXTERIOR WINDOWS ARE TYPE F2, UNLESS NOTED OTHERWISE.
- FF. SUFFIXES WITHIN SPECIFICATION REFERENCES (i.e. 10 11 33 XX or 10 11 33 A1) IN THE DRAWINGS CAN BE IGNORED. THESE SUFFIXES ARE A SORTING MECHANISM USED IN PREPARING THESE DRAWINGS.
- GG. ALL ROUGH OPENINGS (R.O.) SHALL BE VERIFIED WITH SELECTED WINDOW AND DOOR MANUFACTURER. ANY CHANGES FROM THE BASIS OF DESIGN WILL BE COORDINATED WITH ALL TRADES AND ROUGH OPENINGS ADJUSTED AS REQUIRED. ANY DISCREPANCIES FOUND WILL BE BROUGHT TO THE ATTENTION OF THE ARCHITECT PRIOR TO CONSTRUCTION. ANY CHANGES AND REVISIONS WILL BE AT CONTRACTORS' EXPENSE.
- HH. ALL CONSTRUCTION AROUND PLUMBING FIXTURES IS REQUIRED TO BE COORDINATED WITH SELECTED MANUFACTURERS. ADJUST WALLS AS REQUIRED TO ACCOMMODATE THE INSTALLATION OF THE SELECTED MANUFACTURERS PLUMBING FIXTURES. ANY CHANGES AND REVISIONS WILL BE DONE AT CONTRACTORS' EXPENSE. ALL COMMERCIAL TOILET FIXTURES ARE TO HAVE 60" CLEAR IN BOTH X AND Y DIRECTION. ALL TOILET FIXTURES TO SIT 17" TO 19" OF THE ADJACENT WALL TO CENTERLINE OF FIXTURE. ALL SINKS TO SIT 18" OFF THE FACE OF THE ADJACENT WALL TO CENTERLINE OF FIXTURE.
- II. ALL 48" WIDE DETENTION DOORS SHALL BE (H) SECURITY TYPE HINGES. ALL 48" WIDE COMMERCIAL DOORS SHALL HAVE CONTINUOUS HINGES.
- JJ. ALL DOOR HARDWARE EXPOSED FASTENERS IN SECURITY AREA ARE TO BE SECURITY TYPE.
- KK. ALL EXPOSED STRUCTURE TO BE PRIMED AND PAINTED WITH HIGH PERFORMANCE PAINT.
- LL. NON-PREFINISHED INTERIOR SURFACES (MASONRY/DRYWALL/STEEL) IN DETENTION AREAS SHALL RECEIVE HIGH PERFORMANCE EPOXY COATING, AND SHOULD BE PROTECTED DURING CONSTRUCTION. ANY DAMAGE TO PREFINISHED SURFACES DURING CONSTRUCTION SHALL BE REPAIRED AT CONTRACTORS' EXPENSE.
- MM. ALL DOOR HARDWARE FASTENERS IN SECURITY AREAS ARE TO BE SECURITY TYPE.
- NN. PROVIDE SHOWER CURTAINS IN ALL SHOWER LOCATIONS.
- OO. PROVIDE STEEL COVER PLATES AT ALL EXPOSED COLUMNS IN THE DETENTION AREAS, SECURE UTILIZING SECURITY SCREWS AND SECURITY CALVING.
- PP. ALL WALLS TO DECKSTRUCTURE ARE TO HAVE SOUND ATTENUATION BLANKET STUFFED FULL DEPTH AND HEIGHT OF THE CAVITY BETWEEN TOP OF WALL AND BOTTOM OF DECKSTRUCTURE. AT RATED WALLS PROVIDE MINERAL WOOL INSULATION WITH METAL CLOSURE PLATES AND FIRE RESISTIVE JOINT SYSTEM.
- QQ. ALL ADA SHOWER UNITS ARE TO RECEIVE BUILT IN SHOWER SEAT AND CODE COMPLIANT GRAB BARS, UNLESS NOTED OTHERWISE.
- RR. PROVIDE CLOSURE TRIM AT ALL CMU TO PRE-ENGINEERED METAL BUILDING WALL EXTERIOR WALL TYPES.
- SS. ALL ELECTRICAL DEVICES TO BE COORDINATED WITH ALL CASEWORK LOCATION. ADJUST DEVICE LOCATIONS AS REQUIRED TO AVOID CONFLICT. ANY CONFLICT NEEDS TO BE DIRECTED AND APPROVED BY ARCHITECT/ENGINEER PRIOR TO INSTALLATION.
- TT. PROVIDE STEEL FINISH PANEL ABOVE ALL SECURITY SHOWER UNITS. EXTEND TO CEILING FLUSH ON ALL SIDES. SECURE AS REQUIRED WITH SECURITY FASTENERS.
- UU. PROVIDE WATER MANAGEMENT SYSTEM AT DETENTION PLUMBING FIXTURES INCLUDING BUT NOT LIMITED TO GENERAL POPULATION HOUSING, HOLDING, ISOLATION, MEDICAL, AND OBSERVATION CELLS. PROVIDE POWER TO ALL WATER MANAGEMENT DEVICES AS REQUIRED BY MANUFACTURER.
- VV. SECURITY PLUMBING FIXTURES ACCESSORIES. ALL SECURITY PLUMBING TOILETS/INK COMBO UNITS ARE TO RECEIVE A SINGLE LIGATURE PROOF HOOK AND STAINLESS STEEL MIRROR. ALL SECURITY PLUMBING ADA TOILETS/INK COMBO UNITS ARE TO RECEIVE A SINGLE LIGATURE PROOF HOOK, (2) STAINLESS STEEL MIRRORS, 42" HORIZONTAL AND 18" VERTICAL LIGATURE PROOF GRAB BARS, SECURITY TOILET PAPER HOLDER RECESSED IN THE ADJACENT WALL. ALL NON-ADA SECURITY SHOWERS ARE TO RECEIVE A SINGLE LIGATURE PROOF HOOK AND A SHOWER CURTAIN. ALL ADA SECURITY SHOWERS ARE TO RECEIVE A SINGLE LIGATURE PROOF HOOK, A SHOWER CURTAIN, AND ADA HORIZONTAL AND VERTICAL GRAB BARS. REVIEW PLANS FOR ADDITIONAL ACCESSORIES.
- WW. ALL HANDRAILS TO EXTEND 12" PAST THE TREAD EDGE AT TOP AND BOTTOM OF STAIRS. RAILING ARE NOT TO PROTRUDE INTO A WALKING PATH AND SHOULD TURN AT PERPENDICULAR WALL IF ONE IS AVAILABLE. ANY DISCREPANCIES ARE TO BE BROUGHT TO THE ATTENTION OF THE ARCHITECTS PRIOR TO FABRICATION AND INSTALLATION.
- XX. ALL COMMERCIAL HOLLOW METAL FRAMES IN STUD WALL CONSTRUCTION TO BE WRAP AROUND WALL DEPTH. ALL COMMERCIAL HOLLOW METAL FRAMES IN CMU CONSTRUCTION TO BE 5/8" DEEP CENTRALLY LOCATED IN THE WALL ASSEMBLY WITH BULLNOSE CMU CORNERS. ALL SECURITY HOLLOW METAL FRAMES IN CMUPRECAST WALLS TO BE 7/8" DEEP, CENTRALLY LOCATED OR AT EXTERIOR APPLICATION 3" FROM THE EXTERIOR FACE.
- YY. ALL STAIR ASSEMBLIES ARE TO BE ENGINEERED. STAIR SUPPLIER TO PROVIDE ADDITIONAL FRAMING AS REQUIRED FOR A FULLY WARRANTED SYSTEM.
- ZZ. PROVIDE ADDITIONAL ACCESS PANELS AT ALL LOCATIONS REQUIRED FOR MAINTENANCE. COORDINATE WITH MECHANICAL, ELECTRICAL, PLUMBING, AND FIRE PROTECTION CONTRACTOR. PROVIDE SECURITY ACCESS PANELS IN SECURITY AREAS. SEE AF102 AND AF104 FOR SECURITY AREAS.
- AAA. SECURITY SEALANT: PROVIDE SECURITY TYPE SEALANT AT ALL DISSIMILAR MATERIAL IN SECURITY AREAS. SEE AF103 AND AF104 FOR SECURITY AREAS. ALL MASONRY CONTROL JOINTS ARE TO RECEIVE SECURITY SEALANTS IN SECURITY AREAS. ALL RATED ASSEMBLIES ARE TO RECEIVE RATED SECURITY SEALANT FROM THE SAME MANUFACTURER. SECURITY SEALANT TO BE TO 10" ABOVE FINISH LEVEL WHERE WANTS WILL BE PRESENT. @ 10 AFF PROVIDE COMMERCIAL GRADE JOINT SEALANT OR FIRE RATED JOINT SYSTEM.
- BBB. PROVIDE EXCEL. BBS XLERATOR STAINLESS STEEL ANTIMICROBIAL WALL GUARD OR EQUAL AT ALL HAND DRYER LOCATIONS.
- CCC. ALL TOP OF MASONRY WALLS SHALL BE TO DECK AS INDICATED ON PLANS 2" SHORT OF DECK OR STRUCTURE ABOVE. FILL GAP WITH SOUND ATTENUATION BLANKET. AND PROVIDE JOINT SEALANT ON BOTH SIDES BETWEEN TOP OF WALL AND UNDERSIDE OF STRUCTURE/DECK. AT RATED WALL ASSEMBLIES PROVIDE FIRE RESISTIVE JOINT SYSTEM BETWEEN TOP OF WALL AND BOTTOM OF STRUCTURE/DECK.
- DDD. PROVIDE MOP/BROOM HOLDERS AT ALL MOP BASIN LOCATIONS. SEE SPECIFICATIONS FOR MANUFACTURER AND TYPE.
- EEE. REFERENCE STRUCTURAL DRAWINGS FOR ALL BEARING HEIGHTS.
- FFF. ALL DOORS SHOWN AT 45 DEGREES ARE EXISTING TO REMAIN. DOOR TAGS SHOWN FOR SECURITY ELECTRONICS SCOPE PURPOSES ONLY. SEE PLAN NOTES FOR ADDITIONAL SCOPE AT THE EXISTING DOORS.
- GGG. HATCHING WITHIN WALLS SHOWN IN PLANS AND SECTIONS INDICATES NEW CONSTRUCTION. SOLID HATCHING GRAY / OR HAFTONE INDICATES EXISTING CONSTRUCTION.
- HHH. ALL NEW DETENTION FIXTURES SHALL RECEIVE NEW DETENTION ACCESSORIES PER RESTROOM ACCESSORY SCHEDULE ON SHEET A-40.

**2A OVERALL FIRST FLOOR PLAN BUILDING 1**  
1/16" = 1'-0"




#	Revision	Date
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Project #: 20-700-151-2  
Designed By: LD/SP  
Drawn By: JW  
Checked By: LD/IV  
Date: 01.28.2022



*Eric Welfer*

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OVERALL SECOND FLOOR PLAN BUILDING 1

AF 102
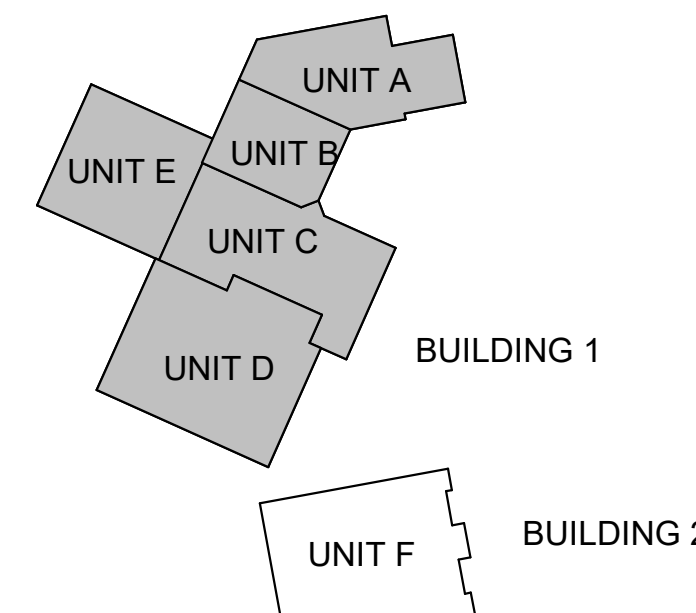
## General Plan Notes

- A. PLAN NOTES INDICATE ONE GRAPHIC REPRESENTATION TYPICAL. THE CONTRACTOR SHALL USE THE GRAPHIC REPRESENTATIONS FOR THE COUNT, NOT THE KEYED PLAN NOTES. THE ABSENCE OF A KEYED PLAN NOTE ON THE PLAN DOES NOT ABSOLVE THE CONTRACTOR FROM PROVIDING THE FEATURE GRAPHICALLY REPRESENTED ON THE DRAWINGS.
- B. ALL DIMENSIONS SHOWN ARE TO FACE OF STUD OR MASONRY, UNLESS NOTED OTHERWISE. DIMENSIONS DESIGNATED AS "CLR OR "CLEAR" INDICATE A CLEAR DIMENSION FROM FACE OF FINISH TO FACE OF FINISH. DIMENSIONS OF EXTERIOR WALLS ARE TO OUTSIDE EDGE OF FOUNDATION.
- C. DIMENSIONS FOR ALL OPENINGS FOR MECHANICAL, PLUMBING, FIRE PROTECTION AND ELECTRICAL SHALL BE FIRE STOPPED AT EACH FLOOR AND RATED WALL PENETRATION.
- D. PROVIDE BRACING AND BLOCKING AS REQUIRED IN WALLS SUPPORTING CASEWORK, TABLEBOARDS, MARKERBOARDS, TELEVISIONS, RESTROOM ACCESSORIES, AND ANY ADDITIONAL WALL MOUNTED EQUIPMENT. COORDINATE WALL MOUNTED EQUIPMENT WITH MECHANICAL, ELECTRICAL, PLUMBING, AND FIRE PROTECTION DRAWINGS.
- E. ALL COMMERCIAL DOOR FRAMES ARE LOCATED 4" FROM ADJACENT WALL, UNLESS NOTED OTHERWISE. ALL DETENTION DOOR FRAMES ARE LOCATED 4" FROM ADJACENT WALL, UNLESS NOTED OTHERWISE.
- F. ALL EXPOSED OUTSIDE CORNERS OF CMU SHALL BE BULLNOSE.
- G. SEAL ALL JOINTS BETWEEN DISSIMILAR MATERIALS.
- H. ALL GYPSUM WALLBOARD IS 5/8" TYPE "X", UNLESS NOTED OTHERWISE.
- I. ALL EXTERIOR WALLS ARE TYPE "ES88", UNLESS NOTED OTHERWISE.
- J. ALL INTERIOR STUD WALLS ARE TYPE "S40" (3/8" METAL STUD TO DECK WITH SOUND ATTENUATION INSULATION TO UNDERSIDE OF ROOF DECK) UNLESS NOTED OTHERWISE. ALL INTERIOR MASONRY WALLS ARE M-8 (7/8" CMU TO DECK) UNLESS NOTED OTHERWISE.
- K. BASE ELEVATION IS AS INDICATED ON C200 - SITE LAYOUT PLAN (UNITED STATES GEOLOGICAL SURVEY DATA). COORDINATE WITH CIVIL DRAWINGS.
- L. ALL WALLS GOING TO DECK ARE TO BE SECURED TO DECKSTRUCTURE ABOVE AS REQUIRED. PROVIDE ADDITIONAL BRACING AS REQUIRED.
- M. ALL WALLS THAT HAVE THE DESIGNATION "C", AND ARE IN A SPACE WITH NO CEILING WILL BE 10FT TALL.
- N. DRAWINGS ESTABLISH THE DESIGN INTENT OF WORK TO BE PERFORMED. ALL WORK SHALL BE PERFORMED IN ACCORDANCE WITH THE HIGHEST INDUSTRY STANDARDS. ALL PRODUCTS SHALL BE INSTALLED IN ACCORDANCE WITH THE MANUFACTURER'S RECOMMENDATIONS. ALL TRADES SHALL CAREFULLY COORDINATE WORK OF ALL OTHER TRADES. ANY DISCREPANCY OR CONFLICTS SHALL BE BROUGHT TO THE IMMEDIATE ATTENTION OF THE ARCHITECT AND THE OWNER PRIOR TO FABRICATION OR INSTALLATION.
- O. CONTRACTORS SHALL BE RESPONSIBLE FOR CHECKING THE CONSTRUCTION DOCUMENTS FOR COORDINATION BETWEEN ARCHITECTURAL, STRUCTURAL, CIVIL, MECHANICAL, ELECTRICAL, PLUMBING, SECURITY AND LANDSCAPING. CONTRACTORS SHALL BE RESPONSIBLE FOR FIELD VERIFYING EXISTING CONDITIONS AND FOR VERIFYING WITH THE CONTRACT DOCUMENTS. ANY DISCREPANCY IN THE CONTRACT DRAWINGS AND SPECIFICATIONS SHALL BE BROUGHT TO THE NOTICE OF THE ARCHITECT PRIOR TO ANY FABRICATION OR CONSTRUCTION.
- P. ALL CORRIDOR SURFACES SHALL BE FLUSH AT JUNCTIONS OF MASONRY AND STUD WALLS. MASONRY WALL LOCATIONS SHALL HOLD TRUE AND NOT STUDS SHALL BE MOVED AS REQUIRED TO PROVIDE FLUSH CONNECTION BETWEEN GYP. BD. AND MASONRY. VERIFY NO. OF LAYERS OF GYP. BD. BY WALL TYPES. RELOCATION OF WALL SHALL BE APPROVED BY ARCHITECT PRIOR TO CONST. AT TRANSITIONS FROM 1 LAYER GYP. BD. TO 2 LAYERS OF GYP. ON MTL. STUDS A MIN. CORRIDOR WIDTH OF 5'-2" FROM FACE OF STUDS SHALL BE MAINTAINED.
- Q. ALL BUILDING MATERIALS (INCLUDING BUT NOT LIMITED TO METAL FLASHING, VAPOR BARRIERS, AIRWATER RESISTANT BARRIERS, THRU-WALL FLASHING, ETC.) SHALL BE LAPPED TO SHED WATER TO THE OUTSIDE OF THE BUILDING ENVELOPE.
- R. SEE CODE COMPLIANCE PLAN G-101 AND G-102 FOR FIRE RATED WALLS.
- S. SEE WALL TYPE SHEET A-002 FOR WALLS AND CONSTRUCTION REQUIREMENTS. SEE A-003 FOR ADDITIONAL GENERAL WALL DETAILS.
- T. WHEREVER POSSIBLE KEEP MINIMUM SIZE OF CUT MASONRY TO 4" OR GREATER.
- U. ALL DIAGONAL WALLS SHALL BE AT 45° (U.N.D.).
- V. COORDINATE WITH STRUCTURAL DRAWINGS FOR CONTROL/EXPANSION JOINT LOCATIONS.
- W. SLOPE CONCRETE SLABS TO FLOOR DRAINS AT 1/8" MIN. PER FT.
- X. ALL CMU WALLS WITH EMBEDDED DETENTION EQUIP. TO HAVE WALLS GROUTED SOLID & REIN. W/ 1 #4 BAR @ 16" O.C. FOR MIN. 4'-0" AROUND EMBEDDED EQUIPMENT OR USE STEEL BLOCKS.
- Y. ALL EXPOSED PIPES, DUCTS/CONDUITS IN SECURITY AREAS SHALL BE ENCLOSED WITH SECURITY BULKHEAD/COVERPLATES. PROVIDE TAMPER RESISTANT ANCHORS.
- Z. ALL DOORS AND BORROWED LITE FRAMES IN SECURITY MASONRY WALLS TO BE FULLY GROUTED. ALL SECURITY DOORS AND BORROWED LITE FRAMES IN MASONRY WALLS TO BE FULLY GROUTED. ALL SECURITY DOORS AND BORROWED LITE FRAMES IN SECURITY STUD WALLS TO HAVE JAMBS FULLY GROUTED UNLESS NOTED OTHERWISE.
- AA. WHEREVER VOLUME DAMPERS (V.D.) ARE LOCATED ABOVE SECURITY CEILINGS, PROVIDE 2'-0"X2'-0" ACCESS PANELS IN THE CEILING. REFER TO MECHANICAL DRAWINGS FOR NUMBER AND LOCATION. COORDINATE WITH ELECTRICAL DRAWINGS. PANELS SHALL BE SECURITY TYPE TO MATCH ADJACENT CEILING.
- BB. ALL CHASE WALLS SHALL BE FULL HEIGHT UNLESS NOTED OTHERWISE.
- CC. ALL INTERIOR AND EXTERIOR EXPOSED STEEL TO BE PAINTED. COLOR TO BE SELECTED BY ARCHITECT.
- DD. PROVIDE (1) ONE 8'X12' GRAPHIC SITE CONSTRUCTION SIGNS. ARCHITECT TO PROVIDE GRAPHIC CONTRACTOR TO INSTALL.
- EE. ALL EXTERIOR WINDOWS ARE TYPE F2, UNLESS NOTED OTHERWISE.
- FF. SUFFIXES WITHIN SPECIFICATION REFERENCES (i.e. 10 11 33 XX or 10 11 33 A1) IN THE DRAWINGS CAN BE IGNORED. THESE SUFFIXES ARE A SORTING MECHANISM USED IN PREPARING THESE DRAWINGS.
- GG. ALL ROUGH OPENINGS (R.O.) SHALL BE VERIFIED WITH SELECTED WINDOW AND DOOR MANUFACTURER. ANY CHANGES FROM THE BASIS OF DESIGN WILL BE COORDINATED WITH ALL TRADES AND ROUGH OPENINGS ADJUSTED AS REQUIRED. ANY DISCREPANCIES FOUND WILL BE BROUGHT TO THE ATTENTION OF THE ARCHITECT PRIOR TO CONSTRUCTION. ANY CHANGES AND REVISIONS WILL BE AT CONTRACTORS' EXPENSE.
- HH. ALL CONSTRUCTION AROUND PLUMBING FIXTURES IS REQUIRED TO BE COORDINATED WITH SELECTED MANUFACTURERS. ADJUST WALLS AS REQUIRED TO ACCOMMODATE THE INSTALLATION OF THE SELECTED MANUFACTURERS PLUMBING FIXTURES. ANY CHANGES AND REVISIONS WILL BE DONE AT CONTRACTORS' EXPENSE. ALL COMMERCIAL TOILET FIXTURES ARE TO HAVE 6" CLEAR IN BOTH X AND Y DIRECTION. ALL TOILET FIXTURES TO SIT 17" TO 19" OFF OF THE ADJACENT WALL TO CENTERLINE OF FIXTURE. ALL SINKS TO SIT 18" OFF THE FACE OF THE ADJACENT WALL TO CENTERLINE OF FIXTURE.
- II. ALL 48" WIDE DETENTION DOORS SHALL BE (H) SECURITY TYPE HINGES. ALL 48" WIDE COMMERCIAL DOORS SHALL HAVE CONTINUOUS HINGES.
- JJ. ALL DOOR HARDWARE EXPOSED FASTENERS IN SECURITY AREA ARE TO BE SECURITY TYPE.
- KK. ALL EXPOSED STRUCTURE TO BE PRIMED AND PAINTED WITH HIGH PERFORMANCE PAINT.
- LL. NON-PREFINISHED INTERIOR SURFACES (MASONRY/DRYWALL/STEEL) IN DETENTION AREAS SHALL RECEIVE HIGH PERFORMANCE EPOXY COATING, AND SHOULD BE PROTECTED DURING CONSTRUCTION. ANY DAMAGE TO PREFINISHED SURFACES DURING CONSTRUCTION SHALL BE REPAIRED AT CONTRACTORS' EXPENSE.
- MM. ALL DOOR HARDWARE FASTENERS IN SECURITY AREAS ARE TO BE SECURITY TYPE.
- NN. PROVIDE SHOWER CURTAINS IN ALL SHOWER LOCATIONS.
- OO. PROVIDE STEEL COVER PLATES AT ALL EXPOSED COLUMNS IN THE DETENTION AREAS, SECURE UTILIZING SECURITY SCREWS AND SECURITY CALVING.
- PP. ALL WALLS TO DECKSTRUCTURE ARE TO HAVE SOUND ATTENUATION BLANKET STUFFED FULL DEPTH AND HEIGHT OF THE CAVITY BETWEEN TOP OF WALL AND BOTTOM OF DECKSTRUCTURE. AT RATED WALLS PROVIDE MINERAL WOOL INSULATION WITH METAL CLOSURE PLATES AND FIRE RESISTIVE JOINT SYSTEM.
- QQ. ALL ADA SHOWER UNITS ARE TO RECEIVE BUILT IN SHOWER SEAT AND CODE COMPLIANT GRAB BARS, UNLESS NOTED OTHERWISE.
- RR. PROVIDE CLOSURE TRIM AT ALL CMU TO PRE-ENGINEERED METAL BUILDING WALL EXTERIOR WALL TYPES.
- SS. ALL ELECTRICAL DEVICES TO BE COORDINATED WITH ALL CASEWORK LOCATION. ADJUST DEVICE LOCATIONS AS REQUIRED TO AVOID CONFLICT. ANY CONFLICT NEEDS TO BE DIRECTED AND APPROVED BY ARCHITECT/ENGINEER PRIOR TO INSTALLATION.
- TT. PROVIDE STEEL FINISH PANEL ABOVE ALL SECURITY SHOWER UNITS. EXTEND TO CEILING FLUSH ON ALL SIDES. SECURE AS REQUIRED WITH SECURITY FASTENERS.
- UU. PROVIDE WATER MANAGEMENT SYSTEM AT DETENTION PLUMBING FIXTURES INCLUDING BUT NOT LIMITED TO GENERAL POPULATION HOUSING, HOLDING, ISOLATION, MEDICAL, AND OBSERVATION CELLS. PROVIDE POVER TO ALL WATER MANAGEMENT DEVICES AS REQUIRED BY MANUFACTURER.
- VV. SECURITY PLUMBING FIXTURES ACCESSORIES. ALL SECURITY PLUMBING TOILETS/SINK COMBO UNITS ARE TO RECEIVE A SINGLE LIGATURE PROOF HOOK AND STAINLESS STEEL MIRROR. ALL SECURITY PLUMBING ADA TOILETS/SINK COMBO UNITS ARE TO RECEIVE A SINGLE LIGATURE PROOF HOOK, (2) STAINLESS STEEL MIRRORS, 42" HORIZONTAL AND 18" VERTICAL LIGATURE PROOF GRAB BARS, SECURITY TOILET PAPER HOLDER RECESSED IN THE ADJACENT WALL. ALL NON-ADA SECURITY SHOWERS ARE TO RECEIVE A SINGLE LIGATURE PROOF HOOK AND A SHOWER CURTAIN. ALL ADA SECURITY SHOWERS ARE TO RECEIVE A SINGLE LIGATURE PROOF HOOK, A SHOWER CURTAIN, AND ADA HORIZONTAL AND VERTICAL GRAB BARS. REVIEW PLANS FOR ADDITIONAL ACCESSORIES.
- WW. ALL HANDRAILS TO EXTEND 12" PAST THE TREAD EDGE AT TOP AND BOTTOM OF STAIRS. RAILING ARE NOT TO PROTRUDE INTO A WALKING PATH AND SHOULD TURN AT PERPENDICULAR WALL IF ONE IS AVAILABLE. ANY DISCREPANCIES ARE TO BE BROUGHT TO THE ATTENTION OF THE ARCHITECTS PRIOR TO FABRICATION AND INSTALLATION.
- XX. ALL COMMERCIAL HOLLOW METAL FRAMES IN STUD WALL CONSTRUCTION TO BE WRAP AROUND WALL DEPTH. ALL COMMERCIAL HOLLOW METAL FRAMES IN CMU CONSTRUCTION TO BE 5-3/4" DEEP CENTRALLY LOCATED IN THE WALL ASSEMBLY WITH BULLNOSE CMU CORNERS. ALL SECURITY HOLLOW METAL FRAMES IN CMUPRECAST WALLS TO BE 7-5/8" DEEP, CENTRALLY LOCATED OR AT EXTERIOR APPLICATION 3" FROM THE EXTERIOR FACE.
- YY. ALL STAIR ASSEMBLIES ARE TO BE ENGINEERED. STAIR SUPPLIER TO PROVIDE ADDITIONAL FRAMING AS REQUIRED FOR A FULLY WARRANTED SYSTEM.
- ZZ. PROVIDE ADDITIONAL ACCESS PANELS AT ALL LOCATIONS REQUIRED FOR MAINTENANCE. COORDINATE WITH MECHANICAL, ELECTRICAL, PLUMBING, AND FIRE PROTECTION CONTRACTOR. PROVIDE SECURITY ACCESS PANELS IN SECURITY AREAS. SEE A-010 AND A-014 FOR SECURITY AREAS.
- AAA. SECURITY SEALANT. PROVIDE SECURITY TYPE SEALANT AT ALL DISSIMILAR MATERIAL IN SECURITY AREAS. SEE A-0103 AND A-0104 FOR SECURITY AREAS. ALL MASONRY CONTROL JOINTS ARE TO RECEIVE SECURITY SEALANTS IN SECURITY AREAS. ALL RATED ASSEMBLIES ARE TO RECEIVE RATED SECURITY SEALANT FROM THE SAME MANUFACTURER. SECURITY SEALANT TO BE TO 10" ABOVE FINISH LEVEL WHERE WAINTS WILL BE PRESENT. @ 10 AFF PROVIDE COMMERCIAL GRADE JOINT SEALANT OR FIRE RATED JOINT SYSTEM.
- BBB. PROVIDE EXCEL 885 XLERATOR STAINLESS STEEL ANTIMICROBIAL WALL GUARD OR EQUAL AT ALL HAND DRYER LOCATIONS.
- CCC. ALL TOP OF MASONRY WALLS SHALL BE TO DECK AS INDICATED ON PLANS 2" SHORT OF DECK OR STRUCTURE ABOVE. FILL GAP WITH SOUND ATTENUATION BLANKET. AND PROVIDE JOINT SEALANT ON BOTH SIDES BETWEEN TOP OF WALL AND UNDERSIDE OF STRUCTURE/DECK. AT RATED WALL ASSEMBLIES PROVIDE FIRE RESISTIVE JOINT SYSTEM BETWEEN TOP OF WALL AND BOTTOM OF STRUCTURE/DECK.
- DDD. PROVIDE MOP/BROOM HOLDERS AT ALL MOP BASIN LOCATIONS. SEE SPECIFICATIONS FOR MANUFACTURER AND TYPE.
- EEE. REFERENCE STRUCTURAL DRAWINGS FOR ALL BEARING HEIGHTS.
- FFF. ALL DOORS SHOWN AT 45 DEGREES ARE EXISTING TO REMAIN. DOOR TAGS SHOWN FOR SECURITY ELECTRONICS SCOPE PURPOSES ONLY. SEE PLAN NOTES FOR ADDITIONAL SCOPE AT THE EXISTING DOORS.
- GGG. HATCHING WITHIN WALLS SHOWN IN PLANS AND SECTIONS INDICATES NEW CONSTRUCTION. SOLID HATCHING GRAY / OR HAFTONE INDICATES EXISTING CONSTRUCTION.
- HHH. ALL NEW DETENTION FIXTURES SHALL RECEIVE NEW DETENTION ACCESSORIES PER RESTROOM ACCESSORY SCHEDULE ON SHEET A-40.

**2A OVERALL SECOND FLOOR PLAN BUILDING 1**  
1/16" = 1'-0"




#	Revision	Date
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Project #: 20-700-151-2  
Designed By: LD/SP  
Drawn By: CP  
Checked By: LD/EV  
Date: 01.28.2022



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OVERALL FIRST FLOOR  
SECURITY PLAN  
BUILDING 1

AF 103

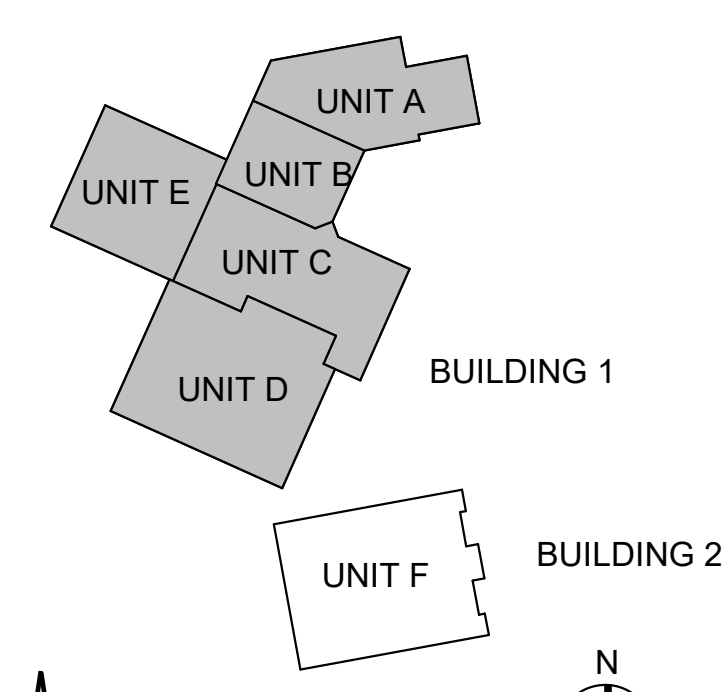GENERAL NOTES:  
1. ALL WALLS THAT LEAD TO FREEDOM TO BE **MAXIMUM** SECURITY ALL OTHER WALLS TO BE **MEDIUM** SECURITY UNLESS NOTED OTHERWISE.  
2. ALL MAX SECURITY WALLS WHICH CONTAIN ANY PENETRATIONS LARGER THAN 6" TO RECEIVE REBAR SECURITY PROTECTION. SEE DETAIL 201A-531.

SECURITY WALL LEGEND

	MAXIMUM SECURITY - #5 VERTICAL REINFORCING @ 16" O.C. AND #4 HORIZONTAL REINFORCING @ 96" O.C. FULLY GROUTED TO 10" A.F.F. (1ST OR MEZZANINE) AND MINIMUM SECURITY REINFORCING ABOVE 10'-0" TO DECK
	MEDIUM SECURITY - #5 VERTICAL REINFORCING @ 48" O.C. AND #4 HORIZONTAL REINFORCING @ 96" O.C. FULLY GROUTED TO 10" A.F.F. (1ST OR MEZZANINE) AND MINIMUM SECURITY REINFORCING ABOVE 10'-0" TO DECK
	SECURITY AREA- ALL THE ELECTRICAL LIGHTING FIXTURES AND PLUMBING, AND SPRINKLE HEAD FIXTURES TO BE SECURITY TYPE UNLESS NOTED OTHERWISE. PROVIDE SECURITY FASTENERS AND SECURITY CAULKING

2A OVERALL FIRST FLOOR SECURITY PLAN BUILDING 1  
1/16" = 1'-0"






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Project #: 20-700-151-2  
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Checked By: LD/EV  
Date: 01.28.2022



*Eric Wepler*

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OVERALL SECOND FLOOR SECURITY PLAN  
BUILDING 1


AF 104

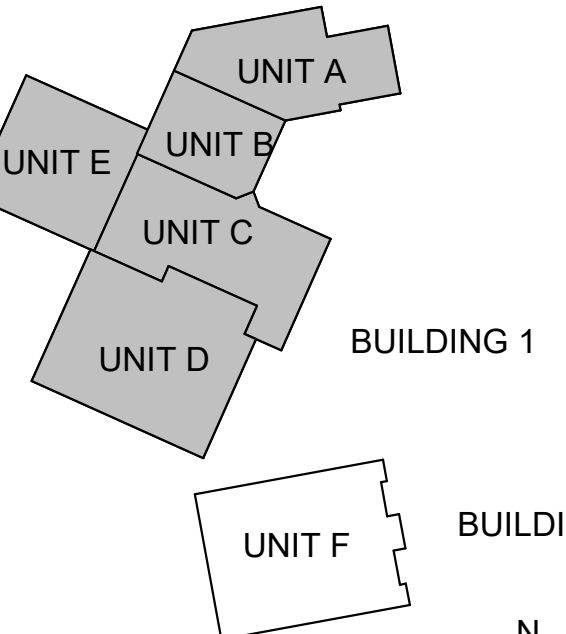GENERAL NOTES:  
1. ALL WALLS THAT LEAD TO FREEDOM TO BE **MAXIMUM** SECURITY ALL OTHER WALLS TO BE **MEDIUM** SECURITY UNLESS NOTED OTHERWISE.  
2. ALL MAX SECURITY WALLS WHICH CONTAIN ANY PENETRATIONS LARGER THAN 6" TO RECEIVE REBAR SECURITY PROTECTION. SEE DETAIL 201A-531.


### SECURITY WALL LEGEND

	MAXIMUM SECURITY - #5 VERTICAL REINFORCING @ 16" O.C. AND #4 HORIZONTAL REINFORCING @ 96" O.C. FULLY GROUTED TO 10" A.F.F. (1ST OR MEZZANINE) AND MINIMUM SECURITY REINFORCING ABOVE 10'-0" TO DECK
	MEDIUM SECURITY - #5 VERTICAL REINFORCING @ 48" O.C. AND #4 HORIZONTAL REINFORCING @ 96" O.C. FULLY GROUTED TO 10" A.F.F. (1ST OR MEZZANINE) AND MINIMUM SECURITY REINFORCING ABOVE 10'-0" TO DECK
	SECURITY AREA- ALL THE ELECTRICAL LIGHTING FIXTURES AND PLUMBING, AND SPRINKLE HEAD FIXTURES TO BE SECURITY TYPE UNLESS NOTED OTHERWISE. PROVIDE SECURITY FASTENERS AND SECURITY CAULKING

**3A** OVERALL SECOND FLOOR SECURITY PLAN BUILDING 1  
1/16" = 1'-0"

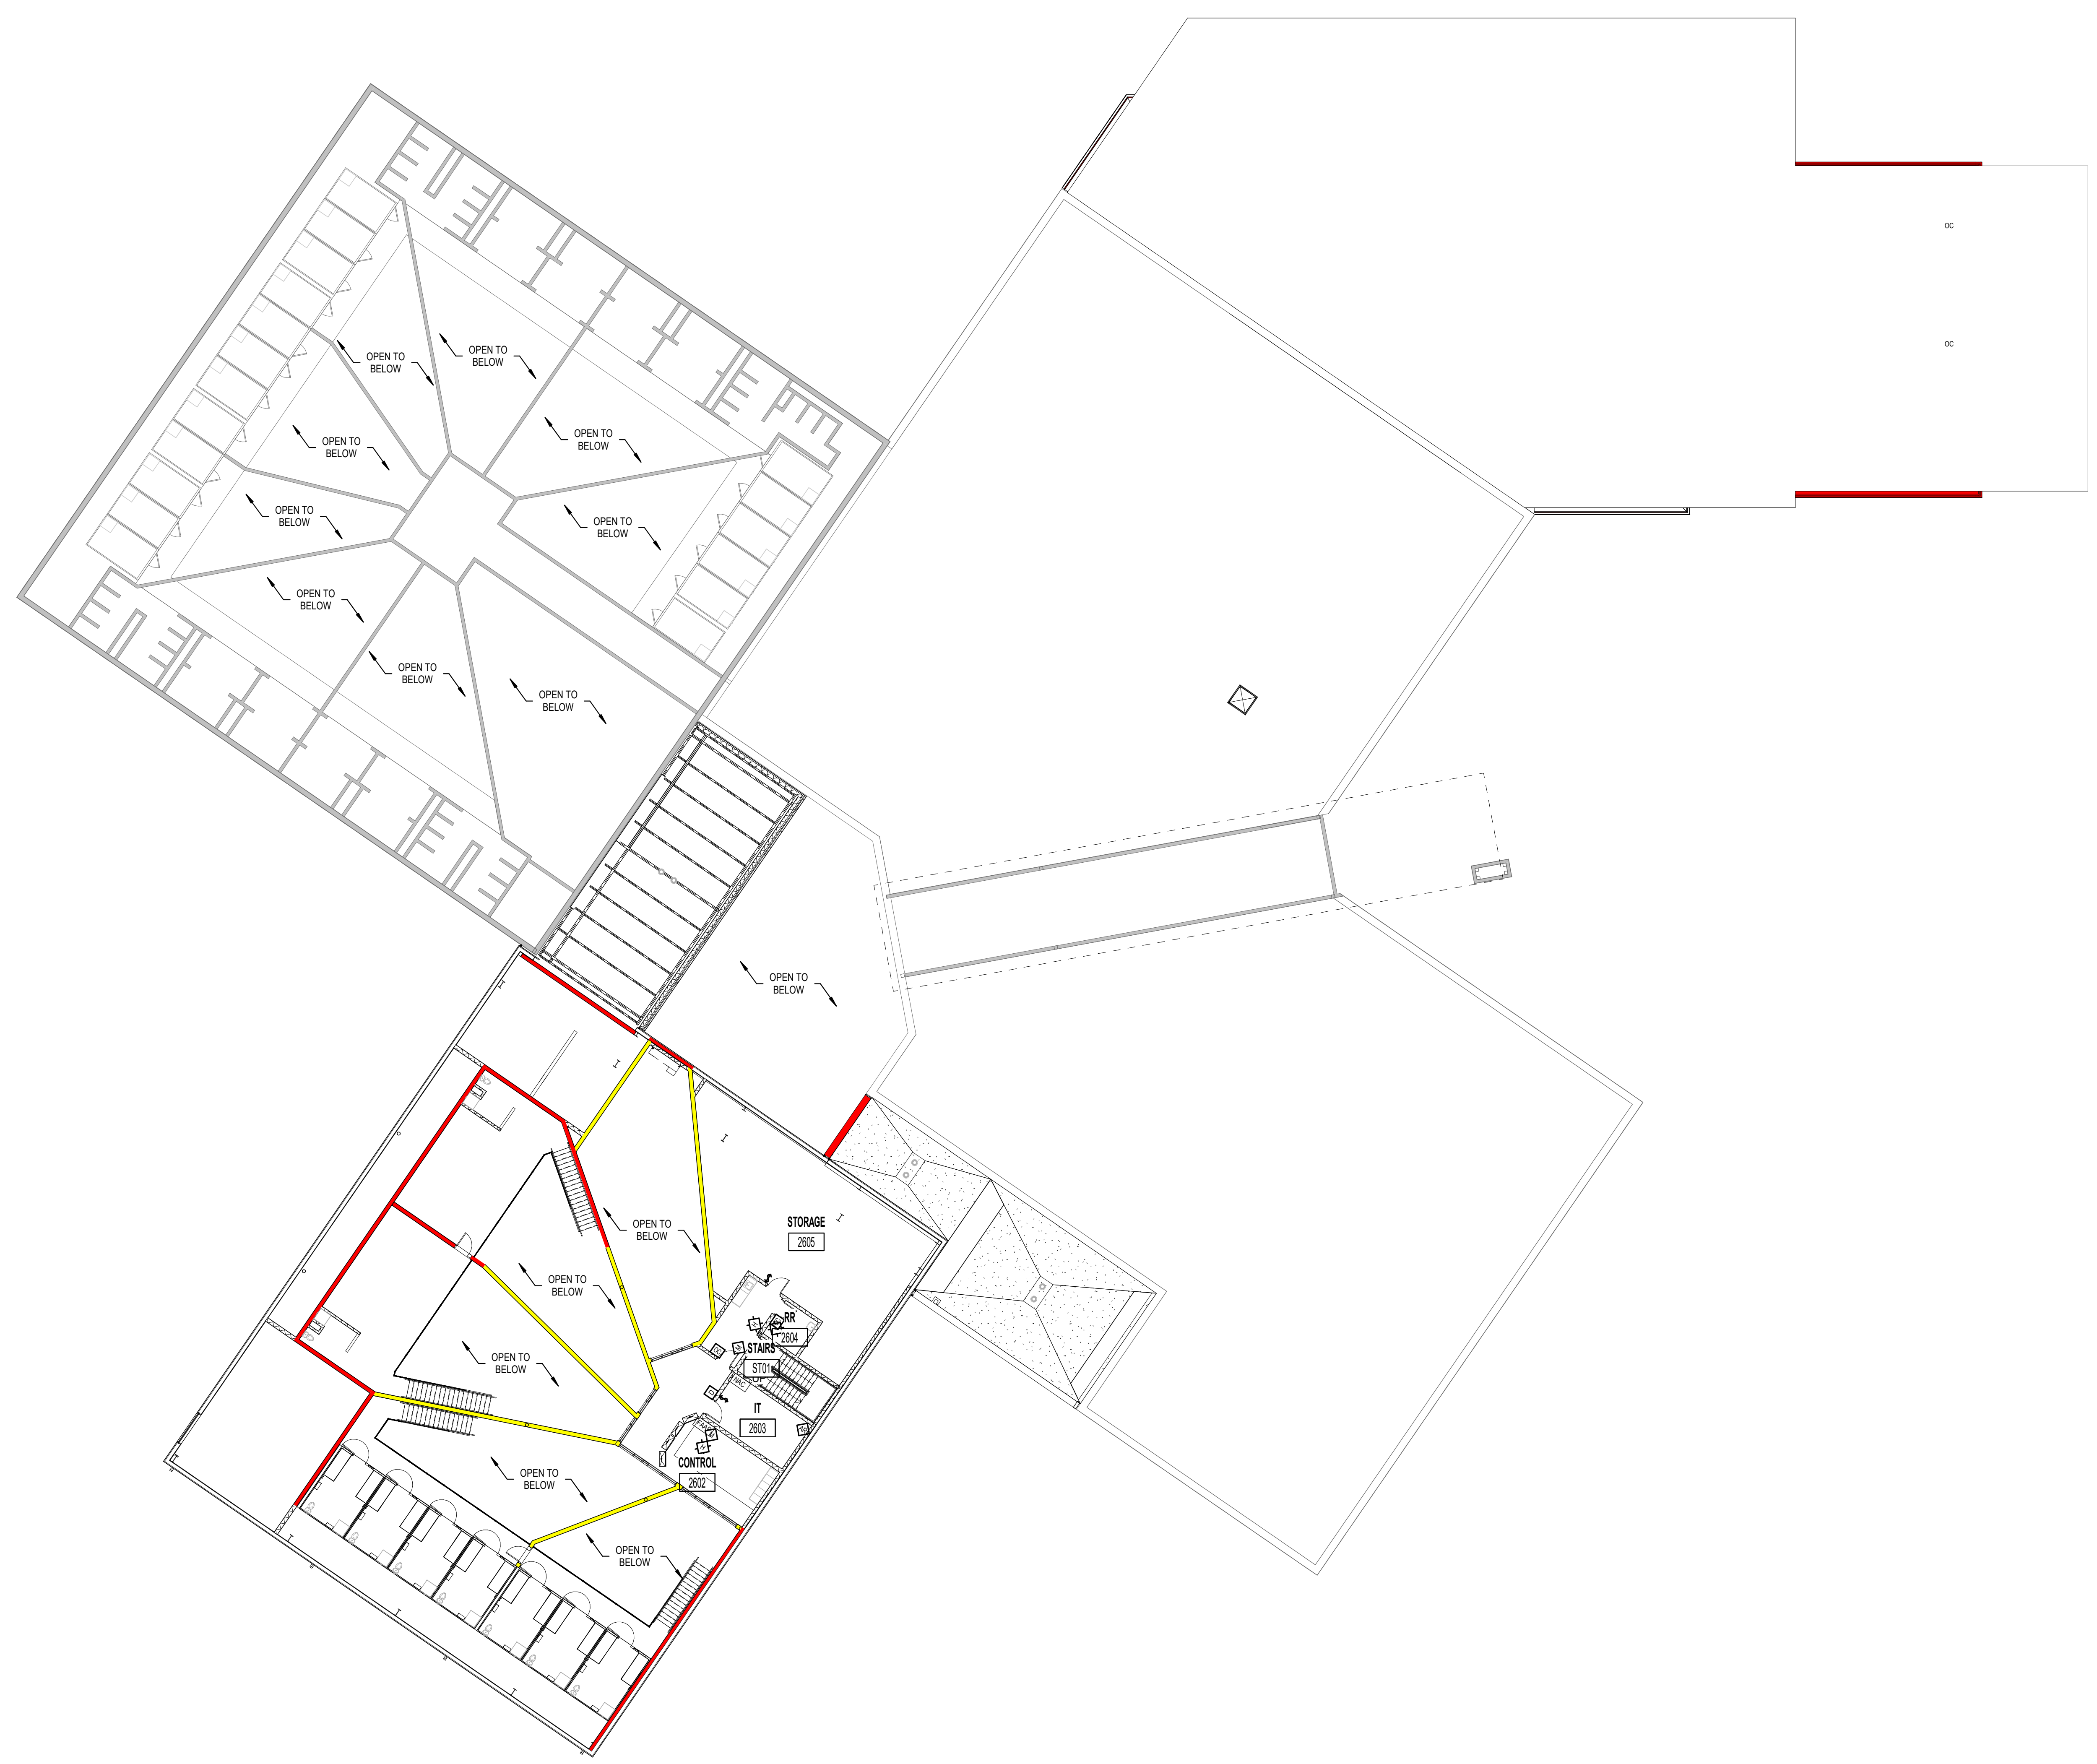



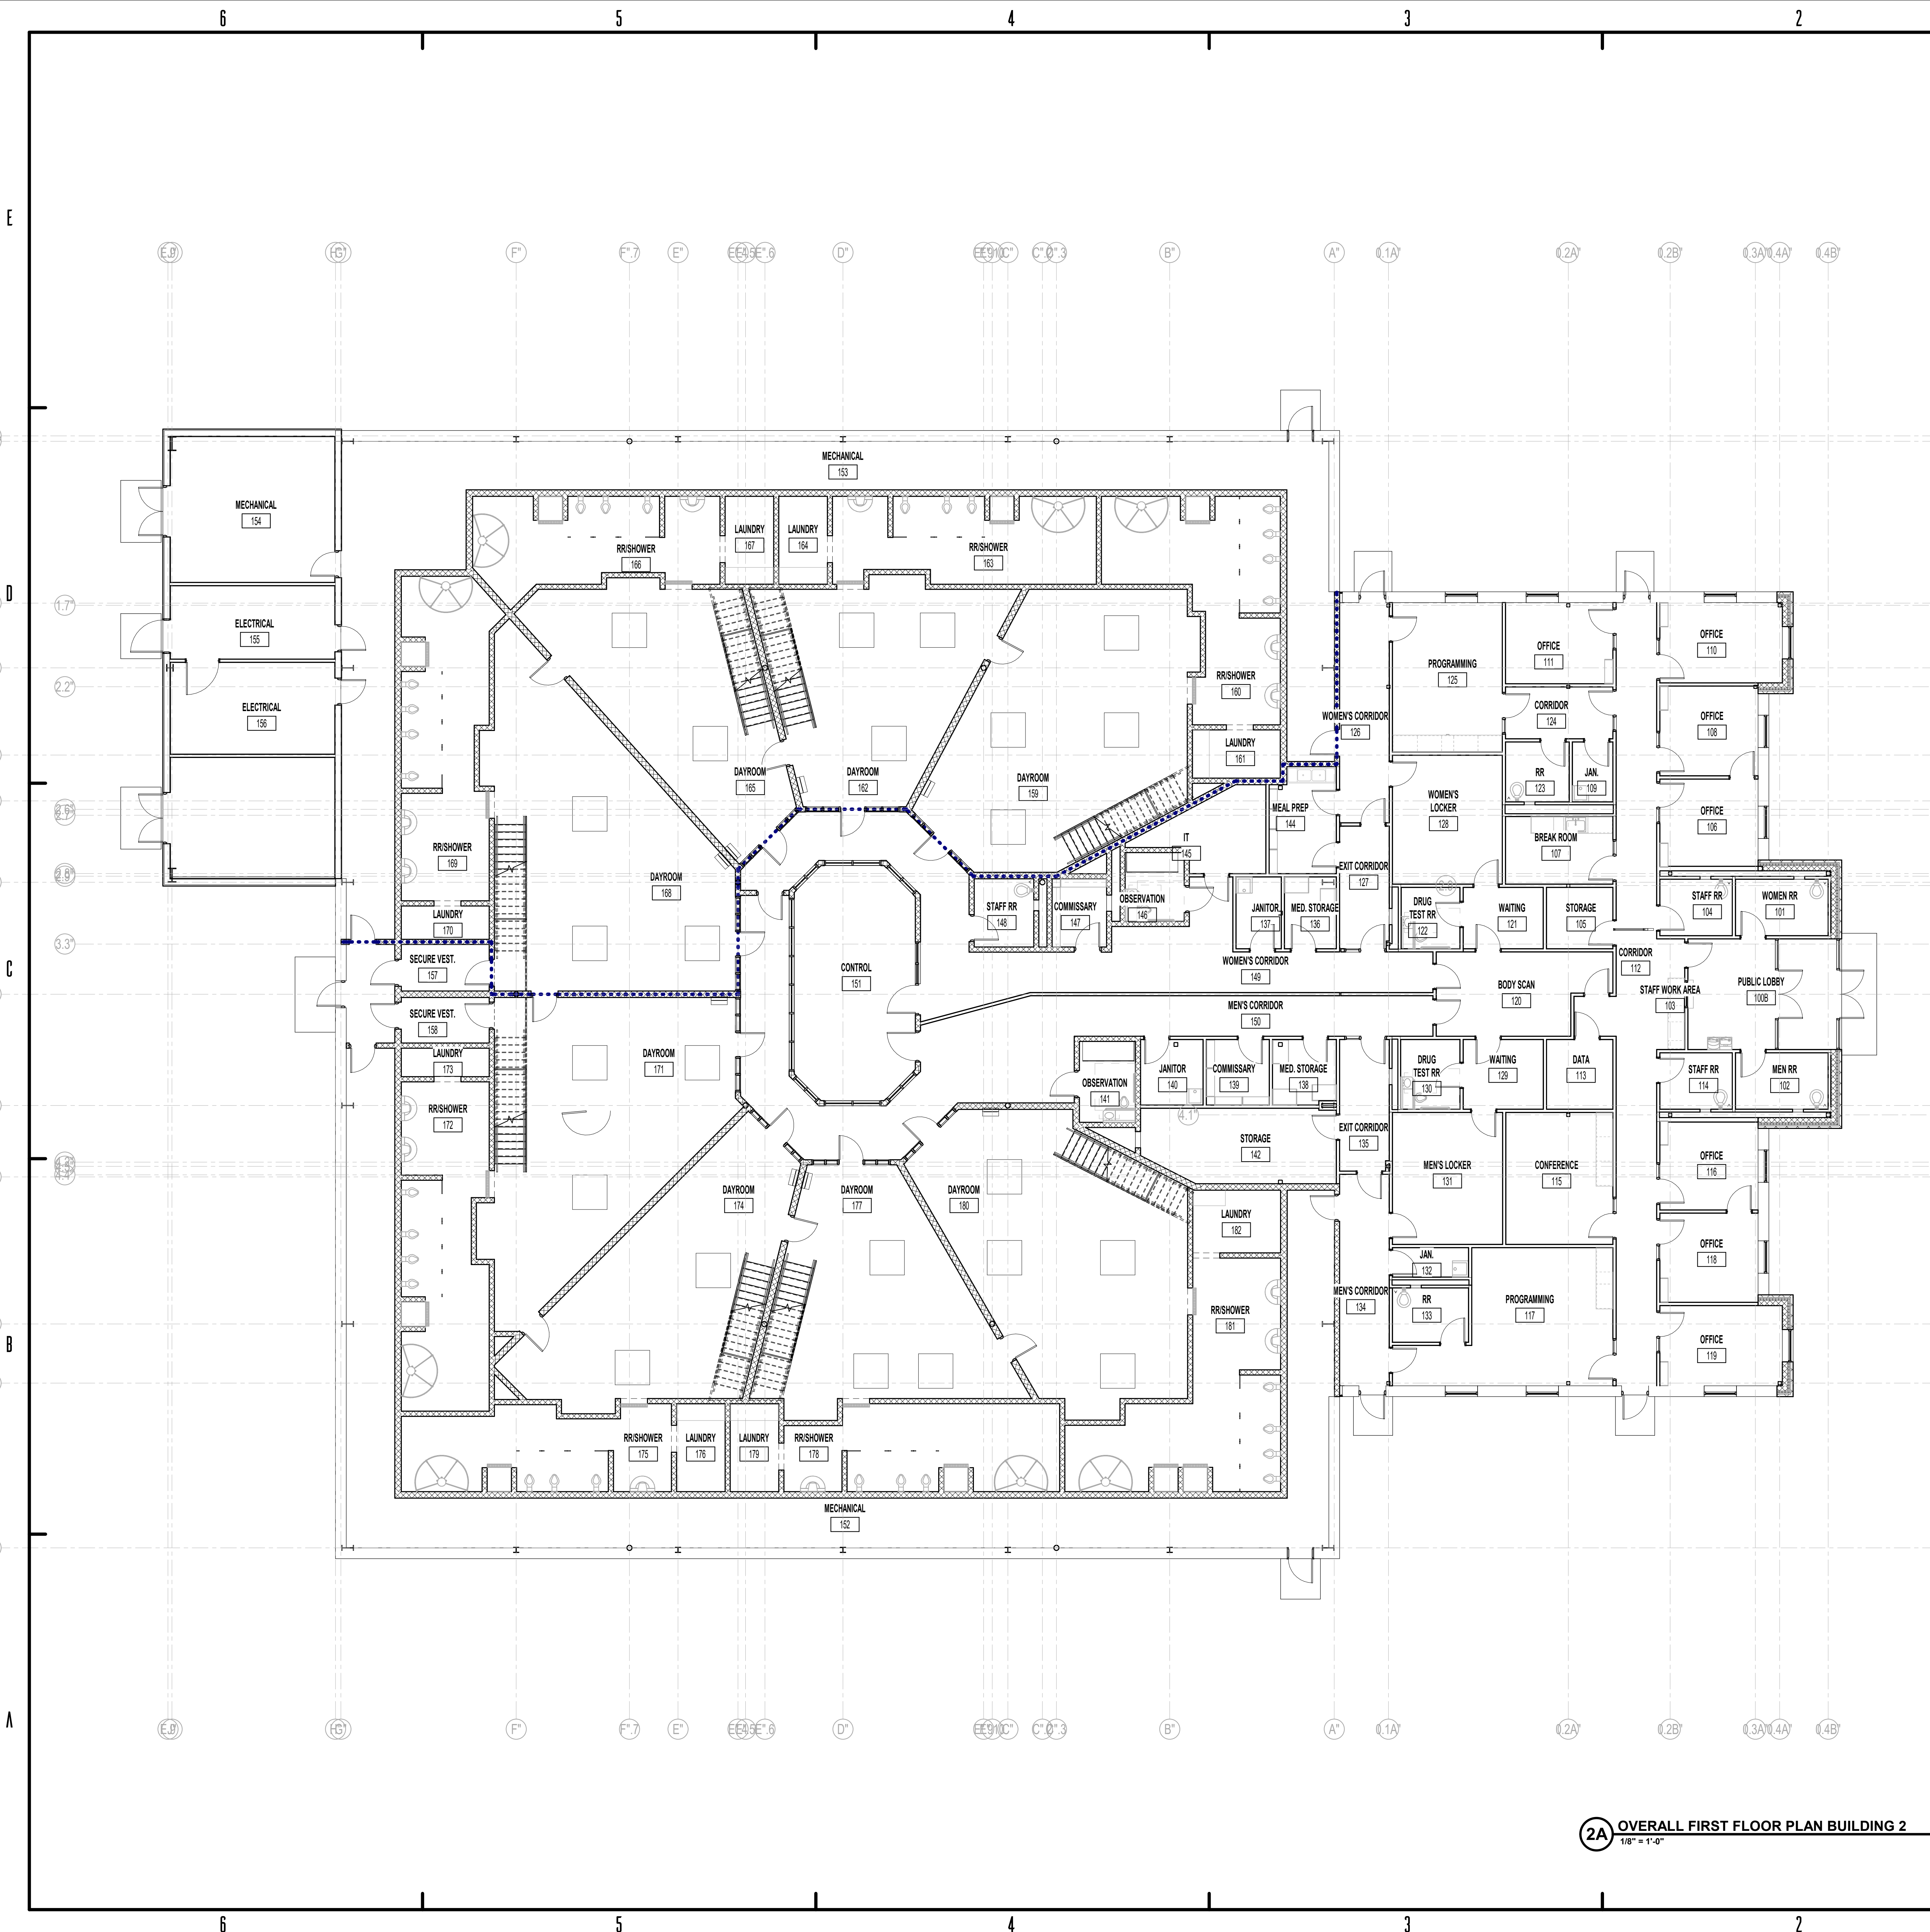

2A OVERALL FIRST FLOOR PLAN BUILDING 2  
1/8" = 1'-0"

General Plan Notes

- A. PLAN NOTES INDICATE ONE GRAPHIC REPRESENTATION TYPICAL. THE CONTRACTOR SHALL USE THE GRAPHIC REPRESENTATIONS FOR THE COUNT, NOT THE KEYED PLAN NOTES. THE ABSENCE OF A KEYED PLAN NOTE ON THE PLAN DOES NOT ABSOLVE THE CONTRACTOR FROM PROVIDING THE FEATURE GRAPHICALLY REPRESENTED ON THE DRAWINGS.
- B. ALL DIMENSIONS SHOWN ARE TO FACE OF STUD OR MASONRY, UNLESS NOTED OTHERWISE. DIMENSIONS DESIGNATED AS "CLR OR "CLEAR" INDICATE A CLEAR DIMENSION FROM FACE OF FINISH TO FACE OF FINISH. DIMENSIONS OF EXTERIOR WALLS ARE TO OUTSIDE EDGE OF FOUNDATION.
- C. DIMENSIONS FOR ALL OPENINGS FOR MECHANICAL, PLUMBING, FIRE PROTECTION AND ELECTRICAL SHALL BE FIRE STOPPED AT EACH FLOOR AND RATED WALL PENETRATION.
- D. PROVIDE BRACING AND BLOCKING AS REQUIRED IN WALLS SUPPORTING CASEWORK, TACKBOARDS, MARKERBOARDS, TELEVISIONS, RESTROOM ACCESSORIES, AND ANY ADDITIONAL WALL MOUNTED EQUIPMENT. COORDINATE WALL MOUNTED EQUIPMENT WITH MECHANICAL, ELECTRICAL, PLUMBING, AND FIRE PROTECTION DRAWINGS.
- E. ALL COMMERCIAL DOOR FRAMES ARE LOCATED 4" FROM ADJACENT WALL, UNLESS NOTED OTHERWISE. ALL DETENTION DOOR FRAMES ARE LOCATED 4" FROM ADJACENT WALL, UNLESS NOTED OTHERWISE.
- F. ALL EXPOSED OUTSIDE CORNERS OF CMU SHALL BE BULLNOSE.
- G. SEAL ALL JOINTS BETWEEN DISSIMILAR MATERIALS.
- H. ALL GYPSUM WALLBOARD IS 5/8" TYPE "X", UNLESS NOTED OTHERWISE.
- I. ALL EXTERIOR WALLS ARE TYPE "ES80" UNLESS NOTED OTHERWISE.
- J. ALL INTERIOR STUD WALLS ARE TYPE "S40" (3/8" METAL STUD TO DECK WITH SOUND ATTENUATION INSULATION TO UNDERSIDE OF ROOF DECK) UNLESS NOTED OTHERWISE. ALL INTERIOR MASONRY WALLS ARE M8-D (7/8" CMU TO DECK) UNLESS NOTED OTHERWISE.
- K. BASE ELEVATION IS AS INDICATED ON C200 - SITE LAYOUT PLAN (UNITED STATES GEOLOGICAL SURVEY DATA). COORDINATE WITH CIVIL DRAWINGS.
- L. ALL WALLS GOING TO DECK ARE TO BE SECURED TO DECK STRUCTURE ABOVE AS REQUIRED. PROVIDE ADDITIONAL BRACING AS REQUIRED.
- M. ALL WALLS THAT HAVE THE DESIGNATION "C", AND ARE IN A SPACE WITH NO CEILING WILL BE 10FT TALL.
- N. DRAWINGS ESTABLISH THE DESIGN INTENT OF WORK TO BE PERFORMED. ALL WORK SHALL BE PERFORMED IN ACCORDANCE WITH THE HIGHEST INDUSTRY STANDARDS. ALL PRODUCTS SHALL BE INSTALLED IN ACCORDANCE WITH THE MANUFACTURER'S RECOMMENDATIONS. ALL TRADES SHALL CAREFULLY COORDINATE WORK OF ALL OTHER TRADES. ANY DISCREPANCIES OR CONFLICTS SHALL BE BROUGHT TO THE IMMEDIATE ATTENTION OF THE ARCHITECT AND THE OWNER PRIOR TO FABRICATION OR INSTALLATION.
- O. CONTRACTORS SHALL BE RESPONSIBLE FOR CHECKING THE CONSTRUCTION DOCUMENTS FOR COORDINATION BETWEEN ARCHITECTURAL, STRUCTURAL, CIVIL, MECHANICAL, ELECTRICAL, PLUMBING, SECURITY AND LANDSCAPING. CONTRACTORS SHALL BE RESPONSIBLE FOR FIELD VERIFYING EXISTING CONDITIONS AND FOR VERIFYING WITH THE CONTRACT DOCUMENTS. ANY DISCREPANCY IN THE CONTRACT DRAWINGS AND SPECIFICATIONS SHALL BE BROUGHT TO THE NOTICE OF THE ARCHITECT PRIOR TO ANY FABRICATION OR CONSTRUCTION.
- P. ALL CORRIDOR SURFACES SHALL BE FLUSH AT JUNCTIONS OF MASONRY AND STUD WALLS. MASONRY WALL LOCATIONS SHALL HOLD TRUE AND MTL STUDS SHALL BE MOVED AS REQUIRED TO PROVIDE FLUSH CONNECTION BETWEEN GYP BD. AND MASONRY. VERIFY W/O. OF LAYERS OF GYP BD. W/ WALL TYPES. RELOCATION OF WALL SHALL BE APPROVED BY ARCHITECT PRIOR TO CONST. AT TRANSITIONS FROM 1 LAYER GYP BD. TO 2 LAYERS OF GYP. ON MTL STUDS A MIN. CORRIDOR WIDTH OF 5'-0" FROM FACE OF STUDS SHALL BE MAINTAINED.
- Q. ALL BUILDING MATERIALS (INCLUDING BUT NOT LIMITED TO METAL FLASHING, VAPOR BARRIERS, AIR/WATER RESISTANT BARRIERS, THRU-WALL FLASHING, ETC.) SHALL BE LAPPED TO SHED WATER TO THE OUTSIDE OF THE BUILDING ENVELOPE.
- R. SEE CODE COMPLIANCE PLAN G-101 AND G-102 FOR FIRE RATED WALLS.
- S. SEE WALL TYPE SHEET A-002 FOR WALLS AND CONSTRUCTION REQUIREMENTS. SEE A-003 FOR ADDITIONAL GENERAL WALL DETAILS.
- T. WHEREVER POSSIBLE KEEP MINIMUM SIZE OF CUT MASONRY TO 4" OR GREATER.
- U. ALL DIAGONAL WALLS SHALL BE AT 45° (U.N.O.).
- V. COORDINATE WITH STRUCTURAL DRAWINGS FOR CONTROL/EXPANSION JOINT LOCATIONS.
- W. SLOPE CONCRETE SLABS TO FLOOR DRAINS AT 1/8" MIN. PER FT.
- X. ALL CMU WALLS WITH EMBEDDED DETENTION EQUIP. TO HAVE WALLS GROUTED SOLID & REIN. W/ #4 BAR @ 16" O.C. FOR MIN. 4'-0" AROUND EMBEDDED EQUIPMENT OR USE STEEL BLOCKS.
- Y. ALL EXPOSED PIPES, DUCTS CONDUITS IN SECURITY AREAS SHALL BE ENCLOSED WITH SECURITY BULKHEAD/COVERPLATES. PROVIDE TAMPER RESISTANT ANCHORS.
- Z. ALL DOORS AND BORROWED LITE FRAMES IN SECURITY MASONRY WALLS TO BE FULLY GROUTED. ALL SECURITY DOORS AND BORROWED LITE FRAMES IN MASONRY WALLS TO BE FULLY GROUTED. ALL SECURITY DOORS AND BORROWED LITE FRAMES IN SECURITY STUD WALLS TO HAVE JAMBS FULLY GROUTED UNLESS NOTED OTHERWISE.
- AA. WHEREVER VOLUME DAMPERS (V.D.) ARE LOCATED ABOVE SECURITY CEILINGS, PROVIDE 2'-0"x2'-0" ACCESS PANELS IN THE CEILING. REFER TO MECHANICAL DRAWINGS FOR NUMBER AND LOCATION. COORDINATE WITH ELECTRICAL DRAWINGS. PANELS SHALL BE SECURITY TYPE TO MATCH ADJACENT CEILING.
- BB. ALL CHASE WALLS SHALL BE FULL HEIGHT UNLESS NOTED OTHERWISE.
- CC. ALL INTERIOR AND EXTERIOR EXPOSED STEEL TO BE PAINTED. COLOR TO BE SELECTED BY ARCHITECT.
- DD. PROVIDE (1) ONE 8'x12' GRAPHIC SITE CONSTRUCTION SIGNS. ARCHITECT TO PROVIDE GRAPHIC CONTRACTOR TO INSTALL.
- EE. ALL EXTERIOR WINDOWS ARE TYPE F3, UNLESS NOTED OTHERWISE.
- FF. SUFFICES WITHIN SPECIFICATION REFERENCES (i.e. 10 11 33 XX X 10 11 33 A1) IN THE DRAWINGS CAN BE IGNORED. THESE SUFFICES ARE A SORTING MECHANISM USED IN PREPARING THESE DRAWINGS.
- GG. ALL ROUGH OPENINGS (R.O.) SHALL BE VERIFIED WITH SELECTED WINDOW AND DOOR MANUFACTURER. ANY CHANGES FROM THE BASIS OF DESIGN WILL BE COORDINATED WITH ALL TRADES AND ROUGH OPENINGS ADJUSTED AS REQUIRED. ANY DISCREPANCIES FOUND WILL BE BROUGHT TO THE ATTENTION OF THE ARCHITECT PRIOR TO CONSTRUCTION. ANY CHANGES AND REVISIONS WILL BE AT CONTRACTORS' EXPENSE.
- HH. ALL CONSTRUCTION AROUND PLUMBING FIXTURES IS REQUIRED TO BE COORDINATED WITH SELECTED MANUFACTURERS. ADJUST WALLS AS REQUIRED TO ACCOMMODATE THE INSTALLATION OF THE SELECTED MANUFACTURERS PLUMBING FIXTURES. ANY CHANGES AND REVISIONS WILL BE DONE AT CONTRACTORS' EXPENSE. ALL COMMERCIAL TOILET FIXTURES ARE TO HAVE 6" CLEAR IN BOTH X AND Y DIRECTION. ALL TOILET FIXTURES TO SIT 17" TO 19" OF THE ADJACENT WALL TO CENTERLINE OF FIXTURE. ALL SINKS TO SIT 18" OFF THE FACE OF THE ADJACENT WALL TO CENTERLINE OF FIXTURE.
- II. ALL 48" WIDE DETENTION DOORS SHALL BE (4) SECURITY TYPE HINGES. ALL 48" WIDE COMMERCIAL DOORS SHALL HAVE CONTINUOUS HINGES.
- JJ. ALL DOOR HARDWARE EXPOSED FASTENERS IN SECURITY AREA ARE TO BE SECURITY TYPE.
- KK. ALL EXPOSED STRUCTURE TO BE PRIMED AND PAINTED WITH HIGH PERFORMANCE PAINT.
- LL. NON-PREFINISHED INTERIOR SURFACES (MASONRY/DRYWALL/STEEL) IN DETENTION AREAS SHALL RECEIVE HIGH PERFORMANCE EPOXY COATING AND SHOULD BE PROTECTED DURING CONSTRUCTION. ANY DAMAGE TO PREFINISHED SURFACES DURING CONSTRUCTION SHALL BE REPAIRED AT CONTRACTORS' EXPENSE.
- MM. ALL DOOR HARDWARE FASTENERS IN SECURITY AREAS ARE TO BE SECURITY TYPE.
- NN. PROVIDE SHOWER CURTAINS IN ALL SHOWER LOCATIONS.
- OO. PROVIDE STEEL COVER PLATES AT ALL EXPOSED COLUMNS IN THE DETENTION AREAS. SECURE UTILIZING SECURITY SCREWS AND SECURITY CHAIRING.
- PP. ALL WALLS TO DECK STRUCTURE ARE TO HAVE SOUND ATTENUATION BLANKET STUFFED FULL DEPTH AND HEIGHT OF THE CAVITY BETWEEN TOP OF WALL AND BOTTOM OF DECK STRUCTURE. AT RATED WALLS PROVIDE MINERAL WOOL INSULATION WITH METAL CLOSURE PLATES AND FIRE RESISTIVE JOINT SYSTEM.
- QQ. ALL ADA SHOWER UNITS ARE TO RECEIVE BUILT IN SHOWER SEAT AND CODE COMPLIANT GRAB BARS, UNLESS NOTED OTHERWISE.
- RR. PROVIDE CLOSURE TRIM AT ALL CMU TO PRE-ENGINEERED METAL BUILDING WALL EXTERIOR WALL TYPES.
- SS. ALL ELECTRICAL DEVICES TO BE COORDINATED WITH ALL CASEWORK LOCATION. ADJUST DEVICE LOCATIONS AS REQUIRED TO AVOID CONFLICT. ANY CONFLICT NEEDS TO BE DIRECTED AND APPROVED BY ARCHITECT/ENGINEER PRIOR TO INSTALLATION.
- TT. PROVIDE STEEL FINISH PANEL ABOVE ALL SECURITY SHOWER UNITS. EXTEND TO CEILING FLUSH ON ALL SIDES. SECURE AS REQUIRED WITH SECURITY FASTENERS.
- UU. PROVIDE WATER MANAGEMENT SYSTEM AT DETENTION PLUMBING FIXTURES INCLUDING BUT NOT LIMITED TO GENERAL POPULATION HOUSING, HOLDING, ISOLATION, MEDICAL, AND OBSERVATION CELLS. PROVIDE PUMP TO ALL WATER MANAGEMENT DEVICES AS REQUIRED BY MANUFACTURER.
- VV. SECURITY PLUMBING FIXTURES ACCESSORIES. ALL SECURITY PLUMBING TOILETS/INK COMBO UNITS ARE TO RECEIVE A SINGLE LIGATURE PROOF HOOK AND STAINLESS STEEL MIRROR. ALL SECURITY PLUMBING ADA TOILET/INK COMBO UNITS ARE TO RECEIVE A SINGLE LIGATURE PROOF HOOK, (2) STAINLESS STEEL MIRRORS, 42" HORIZONTAL AND 18" VERTICAL LIGATURE PROOF GRAB BARS, SECURITY TOILET PAPER HOLDER RECESSED IN THE ADJACENT WALL. ALL NON-ADA SECURITY SHOWERS ARE TO RECEIVE A SINGLE LIGATURE PROOF HOOK AND A SHOWER CURTAIN. ALL ADA TO SECURITY SHOWERS ARE TO RECEIVE A SINGLE LIGATURE PROOF HOOK, A SHOWER CURTAIN, AND ADA HORIZONTAL AND VERTICAL GRAB BARS. REVIEW PLANS FOR ADDITIONAL ACCESSORIES.
- WW. ALL HANDRAILS TO EXTEND 12" PAST THE TREAD EDGE AT TOP AND BOTTOM OF STAIRS. RAILING ARE NOT TO PROTRUDE INTO A WALKING PATH AND SHOULD TURN AT PERPENDICULAR WALL IF ONE IS AVAILABLE. ANY DISCREPANCIES ARE TO BE BROUGHT TO THE ATTENTION OF THE ARCHITECTS PRIOR TO FABRICATION AND INSTALLATION.
- XX. ALL COMMERCIAL HOLLOW METAL FRAMES IN STUD WALL CONSTRUCTION TO BE WRAP AROUND WALL DEPTH. ALL COMMERCIAL HOLLOW METAL FRAMES IN CMU CONSTRUCTION TO BE 5-3/4" DEEP CENTRALLY LOCATED IN THE WALL ASSEMBLY WITH BULLNOSE CMU CORNERS. ALL SECURITY HOLLOW METAL FRAMES IN CMU/PRECAST WALLS TO BE 7-5/8" DEEP, CENTRALLY LOCATED OR AT EXTERIOR APPLICATION 3" FROM THE EXTERIOR FACE.
- YY. ALL STAIR ASSEMBLIES ARE TO BE ENGINEERED. STAIR SUPPLIER TO PROVIDE ADDITIONAL FRAMING AS REQUIRED FOR A FULLY WARRANTED SYSTEM.
- ZZ. PROVIDE ADDITIONAL ACCESS PANELS AT ALL LOCATIONS REQUIRED FOR MAINTENANCE. COORDINATE WITH MECHANICAL, ELECTRICAL, PLUMBING, AND FIRE PROTECTION CONTRACTOR. PROVIDE SECURITY ACCESS PANELS IN SECURITY AREAS. SEE A-010 AND A-014 FOR SECURITY AREAS.
- AAA. SECURITY SEALANT: PROVIDE SECURITY TYPE SEALANT AT ALL DISSIMILAR MATERIAL IN SECURITY AREAS. SEE A-010 AND A-014 FOR SECURITY AREAS. ALL MASONRY CONTROL JOINTS ARE TO RECEIVE SECURITY SEALANTS IN SECURITY AREAS. ALL RATED ASSEMBLIES ARE TO RECEIVE RATED SECURITY SEALANT FROM THE SAME MANUFACTURER. SECURITY SEALANT TO BE TO 10' ABOVE FINISH LEVEL WHERE WANTS WILL BE PRESENT. @ 10' AFF PROVIDE COMMERCIAL GRADE JOINT SEALANT OR FIRE RATED JOINT SYSTEM.
- BBB. PROVIDE EXCEL. BBS XLERATOR STAINLESS STEEL ANTIMICROBIAL WALL GUARD OR EQUAL AT ALL HAND DRYER LOCATIONS.
- CCC. ALL TOP OF MASONRY WALLS SHALL BE TO DECK AS INDICATED ON PLANS 2" SHORT OF DECK OR STRUCTURE ABOVE. FILL GAP WITH SOUND ATTENUATION BLANKET. PROVIDE JOINT SEALANT ON BOTH SIDES BETWEEN TOP OF WALL AND UNDERSIDE OF STRUCTURE/DECK. AT RATED WALL ASSEMBLIES PROVIDE FIRE RESISTIVE JOINT SYSTEM BETWEEN TOP OF WALL AND BOTTOM OF STRUCTURE/DECK.
- DDD. PROVIDE MOP/BROOM HOLDERS AT ALL MOP BASIN LOCATIONS. SEE SPECIFICATIONS FOR MANUFACTURER AND TYPE.
- EEE. REFERENCE STRUCTURAL DRAWINGS FOR ALL BEARING HEIGHTS.
- FFF. ALL DOORS SHOWN AT 45 DEGREES ARE EXISTING TO REMAIN. DOOR TAGS SHOWN FOR SECURITY ELECTRONICS SCOPE PURPOSES ONLY. SEE PLAN NOTES FOR ADDITIONAL SCOPE AT THE EXISTING DOORS.
- GGG. HATCHING WITHIN WALLS SHOWN IN PLANS AND SECTIONS INDICATES NEW CONSTRUCTION. SOLID HATCHING GRAY / OR HATCHING INDICATES EXISTING CONSTRUCTION.
- HHH. ALL NEW DETENTION FIXTURES SHALL RECEIVE NEW DETENTION ACCESSORIES PER RESTROOM ACCESSORY SCHEDULE ON SHEET A-401.

RQAW

ARCHITECTURE

BID SET

KNOX COUNTY BOARD OF COMMISSIONERS

KNOX COUNTY JUSTICE CAMPUS

2375 OLD DECKER RD. VINCENNES, IN 47591

#	Revision	Date
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Project #:

20-700-151-2

Designed By:

LD

Drawn By:

WD

Checked By:

LD/IV

Date:

01.28.2022

ENG. S. WELLEN

REGISTERED

No. A015600196

STATE OF INDIANA

ARCHITECT

Eric Welfen

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UNIT A

UNIT B

UNIT C

UNIT D

UNIT E

UNIT F

BUILDING 1

BUILDING 2

N

OVERALL FIRST FLOOR PLAN BUILDING 2


AF 105



## General Plan Notes

- A. PLAN NOTES INDICATE ONE GRAPHIC REPRESENTATION TYPICAL. THE CONTRACTOR SHALL USE THE GRAPHIC REPRESENTATIONS FOR THE COUNT. NOT THE KEYED PLAN NOTES. THE ABSENCE OF A KEYED PLAN NOTE ON THE PLAN DOES NOT ABSOLVE THE CONTRACTOR FROM PROVIDING THE FEATURE GRAPHICALLY REPRESENTED ON THE DRAWINGS.
- B. ALL DIMENSIONS SHOWN ARE TO FACE OF STUD OR MASONRY, UNLESS NOTED OTHERWISE. DIMENSIONS DESIGNATED AS "CLR OR "CLEAR" INDICATE A CLEAR DIMENSION FROM FACE OF FINISH TO FACE OF FINISH. DIMENSIONS OF EXTERIOR WALLS ARE TO OUTSIDE EDGE OF FOUNDATION.
- C. DIMENSIONS FOR ALL OPENINGS FOR MECHANICAL, PLUMBING, FIRE PROTECTION AND ELECTRICAL SHALL BE FIRE STOPPED AT EACH FLOOR AND RATED WALL PENETRATION.
- D. PROVIDE BRACING AND BLOCKING AS REQUIRED IN WALLS SUPPORTING CASEWORK, TACKBOARDS, MARKERBOARDS, TELEVISIONS, RESTROOM ACCESSORIES, AND ANY ADDITIONAL WALL MOUNTED EQUIPMENT. COORDINATE WALL MOUNTED EQUIPMENT WITH MECHANICAL, ELECTRICAL, PLUMBING, AND FIRE PROTECTION DRAWINGS.
- E. ALL COMMERCIAL DOOR FRAMES ARE LOCATED 4" FROM ADJACENT WALL, UNLESS NOTED OTHERWISE. ALL DETENTION DOOR FRAMES ARE LOCATED 4" FROM ADJACENT WALL, UNLESS NOTED OTHERWISE.
- F. ALL EXPOSED OUTSIDE CORNERS OF CMU SHALL BE BULLNOSE.
- G. SEAL ALL JOINTS BETWEEN DISSIMILAR MATERIALS.
- H. ALL GYPSUM WALLBOARD IS 5/8" TYPE "X", UNLESS NOTED OTHERWISE.
- I. ALL EXTERIOR WALLS ARE TYPE "ESB" UNLESS NOTED OTHERWISE.
- J. ALL INTERIOR STUD WALLS ARE TYPE "S40" (3/8" METAL STUD TO DECK WITH SOUND ATTENUATION INSULATION TO UNDERSIDE OF ROOF DECK) UNLESS NOTED OTHERWISE. ALL INTERIOR MASONRY WALLS ARE M8-B (7/8" CMU TO DECK) UNLESS NOTED OTHERWISE.
- K. BASE ELEVATION IS AS INDICATED ON C200 - SITE LAYOUT PLAN (UNITED STATES GEOLOGICAL SURVEY DATA). COORDINATE WITH CIVIL DRAWINGS.
- L. ALL WALLS GOING TO DECK ARE TO BE SECURED TO DECK STRUCTURE ABOVE AS REQUIRED. PROVIDE ADDITIONAL BRACING AS REQUIRED.
- M. ALL WALLS THAT HAVE THE DESIGNATION "C", AND ARE IN A SPACE WITH NO CEILING WILL BE 10FT TALL.
- N. DRAWINGS ESTABLISH THE DESIGN INTENT OF WORK TO BE PERFORMED. ALL WORK SHALL BE PERFORMED IN ACCORDANCE WITH THE HIGHEST INDUSTRY STANDARDS. ALL PRODUCTS SHALL BE INSTALLED IN ACCORDANCE WITH THE MANUFACTURER'S RECOMMENDATIONS. ALL TRADES SHALL CAREFULLY COORDINATE WORK OF ALL OTHER TRADES. ANY DISCREPANCIES OR CONFLICTS SHALL BE BROUGHT TO THE IMMEDIATE ATTENTION OF THE ARCHITECT AND THE OWNER PRIOR TO FABRICATION OR INSTALLATION.
- O. CONTRACTORS SHALL BE RESPONSIBLE FOR CHECKING THE CONSTRUCTION DOCUMENTS FOR COORDINATION BETWEEN ARCHITECTURAL, STRUCTURAL, CIVIL, MECHANICAL, ELECTRICAL, PLUMBING, SECURITY AND LANDSCAPING. CONTRACTORS SHALL BE RESPONSIBLE FOR FIELD VERIFYING EXISTING CONDITIONS AND FOR VERIFYING WITH THE CONTRACT DOCUMENTS. ANY DISCREPANCY IN THE CONTRACT DRAWINGS AND SPECIFICATIONS SHALL BE BROUGHT TO THE NOTICE OF THE ARCHITECT PRIOR TO ANY FABRICATION OR CONSTRUCTION.
- P. ALL CORRIDOR SURFACES SHALL BE FLUSH AT JUNCTIONS OF MASONRY AND STUD WALLS. MASONRY WALL LOCATIONS SHALL HOLD TRUE AND MTL STUDS SHALL BE MOVED AS REQUIRED TO PROVIDE FLUSH CONNECTION BETWEEN GYP. BD. AND MASONRY. VERIFY NO. OF LAYERS OF GYP. BD. W/ WALL TYPES. RELOCATION OF WALL SHALL BE APPROVED BY ARCHITECT PRIOR TO CONST. AT TRANSITIONS FROM 1 LAYER GYP. BD. TO 2 LAYERS OF GYP. ON MTL STUDS A MIN. CORRIDOR WIDTH OF 5'-0" FROM FACE OF STUDS SHALL BE MAINTAINED.
- Q. ALL BUILDING MATERIALS (INCLUDING BUT NOT LIMITED TO METAL FLASHING, VAPOR BARRIERS, AIRWATER RESISTANT BARRIERS, THRU-WALL FLASHING, ETC.) SHALL BE LAPPED TO SHED WATER TO THE OUTSIDE OF THE BUILDING ENVELOPE.
- R. SEE CODE COMPLIANCE PLAN G-101 AND G-102 FOR FIRE RATED WALLS.
- S. SEE WALL TYPE SHEET A-002 FOR WALLS AND CONSTRUCTION REQUIREMENTS. SEE A-003 FOR ADDITIONAL GENERAL WALL DETAILS.
- T. WHEREVER POSSIBLE KEEP MINIMUM SIZE OF CUT MASONRY TO 4" OR GREATER.
- U. ALL DIAGONAL WALLS SHALL BE AT 45° (U.N.O.).
- V. COORDINATE WITH STRUCTURAL DRAWINGS FOR CONTROL/EXPANSION JOINT LOCATIONS.
- W. SLOPE CONCRETE SLABS TO FLOOR DRAINS AT 1/8" MIN. PER FT.
- X. ALL CMU WALLS WITH EMBEDDED DETENTION EQUIP. TO HAVE WALLS GROUTED SOLID & REINF. W/ 1 #4 BAR @ 16" O.C. FOR MIN. 4'-0" AROUND EMBEDDED EQUIPMENT OR USE STEEL BLOCKS.
- Y. ALL EXPOSED PIPES, DUCTS/CONDUITS IN SECURITY AREAS SHALL BE ENCLOSED WITH SECURITY BULKHEAD/COVERPLATES. PROVIDE TAMPER RESISTANT ANCHORS.
- Z. ALL DOORS AND BORROWED LITE FRAMES IN SECURITY MASONRY WALLS TO BE FULLY GROUTED. ALL SECURITY DOORS AND BORROWED LITE FRAMES IN MASONRY WALLS TO BE FULLY GROUTED. ALL SECURITY DOORS AND BORROWED LITE FRAMES IN SECURITY STUD WALLS TO HAVE JAMBS FULLY GROUTED UNLESS NOTED OTHERWISE.
- AA. WHEREVER VOLUME DAMPERS (V.D.) ARE LOCATED ABOVE SECURITY CEILINGS, PROVIDE 2'-0"x2'-0" ACCESS PANELS IN THE CEILING. REFER TO MECHANICAL DRAWINGS FOR NUMBER AND LOCATION. COORDINATE WITH ELECTRICAL DRAWINGS. PANELS SHALL BE SECURITY TYPE TO MATCH ADJACENT WALLS.
- AB. ALL CHASE WALLS SHALL BE FULL HEIGHT UNLESS NOTED OTHERWISE.
- AC. ALL INTERIOR AND EXTERIOR EXPOSED STEEL TO BE PAINTED. COLOR TO BE SELECTED BY ARCHITECT.
- AD. PROVIDE (1) ONE 8'x12' GRAPHIC SITE CONSTRUCTION SIGNS. ARCHITECT TO PROVIDE GRAPHIC CONTRACTOR TO INSTALL.
- AE. ALL EXTERIOR WINDOWS ARE TYPE F2, UNLESS NOTED OTHERWISE.
- AF. SUFFIXES WITHIN SPECIFICATION REFERENCES (i.e. 10 11 33 XX or 10 11 33 A1) IN THE DRAWINGS CAN BE IGNORED. THESE SUFFIXES ARE A SORTING MECHANISM USED IN PREPARING THESE DRAWINGS.
- AG. ALL ROUGH OPENINGS (R.O.) SHALL BE VERIFIED WITH SELECTED WINDOW AND DOOR MANUFACTURER. ANY CHANGES FROM THE BASIS OF DESIGN WILL BE COORDINATED WITH ALL TRADES AND ROUGH OPENINGS ADJUSTED AS REQUIRED. ANY DISCREPANCIES FOUND WILL BE BROUGHT TO THE ATTENTION OF THE ARCHITECT PRIOR TO CONSTRUCTION. ANY CHANGES AND REVISIONS WILL BE AT CONTRACTORS EXPENSE.
- AH. ALL CONSTRUCTION AROUND PLUMBING FIXTURES IS REQUIRED TO BE COORDINATED WITH SELECTED MANUFACTURERS. ADJUST WALLS AS REQUIRED TO ACCOMMODATE THE INSTALLATION OF THE SELECTED MANUFACTURERS PLUMBING FIXTURES. ANY CHANGES AND REVISIONS WILL BE DONE AT CONTRACTORS EXPENSE. ALL COMMERCIAL TOILET FIXTURES ARE TO HAVE 6" CLEAR IN BOTH X AND Y DIRECTION. ALL TOILET FIXTURES TO SIT 17" TO 19" OF THE ADJACENT WALL TO CENTERLINE OF FIXTURE. ALL SINKS TO SIT 18" OFF THE FACE OF THE ADJACENT WALL TO CENTERLINE OF FIXTURE.
- AI. ALL 48" WIDE DETENTION DOORS SHALL BE (4) SECURITY TYPE HINGES. ALL 48" WIDE COMMERCIAL DOORS SHALL HAVE CONTINUOUS HINGES.
- AJ. ALL DOOR HARDWARE EXPOSED FASTENERS IN SECURITY AREA ARE TO BE SECURITY TYPE.
- AK. ALL EXPOSED STRUCTURE TO BE PRIMED AND PAINTED WITH HIGH PERFORMANCE PAINT.
- AL. NON-PREFINISHED INTERIOR SURFACES (MASONRY/DRYWALL/STEEL) IN DETENTION AREAS SHALL RECEIVE HIGH PERFORMANCE EPOXY COATING, AND SHOULD BE PROTECTED DURING CONSTRUCTION. ANY DAMAGE TO PREFINISHED SURFACES DURING CONSTRUCTION SHALL BE REPAIRED AT CONTRACTORS EXPENSE.
- AM. ALL DOOR HARDWARE FASTENERS IN SECURITY AREAS ARE TO BE SECURITY TYPE.
- AN. PROVIDE SHOWER CURTAINS IN ALL SHOWER LOCATIONS.
- AO. PROVIDE STEEL COVER PLATES AT ALL EXPOSED COLUMNS IN THE DETENTION AREAS, SECURE UTILIZING SECURITY SCREWS AND SECURITY CHAINING.
- AP. ALL WALLS TO DECK STRUCTURE ARE TO HAVE SOUND ATTENUATION BLANKET STUFFED FULL DEPTH AND HEIGHT OF THE CAVITY BETWEEN TOP OF WALL AND BOTTOM OF DECK STRUCTURE. AT RATED WALLS PROVIDE MINERAL WOOL INSULATION WITH METAL CLOSURE PLATES AND FIRE RESISTIVE JOINT SYSTEM.
- AQ. ALL ADA SHOWER UNITS ARE TO RECEIVE BUILT IN SHOWER SEAT AND CODE COMPLIANT GRAB BARS, UNLESS NOTED OTHERWISE.
- AR. PROVIDE CLOSURE TRIM AT ALL CMU TO PRE-ENGINEERED METAL BUILDING WALL EXTERIOR WALL TYPES.
- AS. ALL ELECTRICAL DEVICES TO BE COORDINATED WITH ALL CASEWORK LOCATION. ADJUST DEVICE LOCATIONS AS REQUIRED TO AVOID CONFLICT. ANY CONFLICT NEEDS TO BE DIRECTED AND APPROVED BY ARCHITECT/ENGINEER PRIOR TO INSTALLATION.
- AT. PROVIDE STEEL FINISH PANEL ABOVE ALL SECURITY SHOWER UNITS. EXTEND TO CEILING FLUSH ON ALL SIDES. SECURE AS REQUIRED WITH SECURITY FASTENERS.
- AU. PROVIDE WATER MANAGEMENT SYSTEM AT DETENTION PLUMBING FIXTURES INCLUDING BUT NOT LIMITED TO GENERAL POPULATION HOUSING, HOLDING, ISOLATION, MEDICAL, AND OBSERVATION CELLS. PROVIDE POWER TO ALL WATER MANAGEMENT DEVICES AS REQUIRED BY MANUFACTURER.
- AV. SECURITY PLUMBING FIXTURES ACCESSORIES. ALL SECURITY PLUMBING TOILET/SINK COMBO UNITS ARE TO RECEIVE A SINGLE LIGATURE PROOF HOOK AND STAINLESS STEEL MIRROR. ALL SECURITY PLUMBING ADA TOILET/SINK COMBO UNITS ARE TO RECEIVE A SINGLE LIGATURE PROOF HOOK, (2) STAINLESS STEEL MIRRORS, 42" HORIZONTAL AND 18" VERTICAL LIGATURE PROOF GRAB BARS, SECURITY TOILET PAPER HOLDER RECESSED IN THE ADJACENT WALL. ALL NON ADA SECURITY SHOWERS ARE TO RECEIVE A SINGLE LIGATURE PROOF HOOK AND A SHOWER CURTAIN. ALL ADA SECURITY SHOWERS ARE TO RECEIVE A SINGLE LIGATURE PROOF HOOK, A SHOWER CURTAIN, AND ADA HORIZONTAL AND VERTICAL GRAB BARS. REVIEW PLANS FOR ADDITIONAL ACCESSORIES.
- AW. ALL HANDRAILS TO EXTEND 12" PAST THE TREAD EDGE AT TOP AND BOTTOM OF STAIRS. RAILING ARE NOT TO PROTRUDE INTO A WALKING PATH AND SHOULD TURN AT PERPENDICULAR WALL IF ONE IS AVAILABLE. ANY DISCREPANCIES ARE TO BE BROUGHT TO THE ATTENTION OF THE ARCHITECTS PRIOR TO FABRICATION AND INSTALLATION.
- AX. ALL COMMERCIAL HOLLOW METAL FRAMES IN STUD WALL CONSTRUCTION TO BE WRAP AROUND WALL DEPTH. ALL COMMERCIAL HOLLOW METAL FRAMES IN CMU CONSTRUCTION TO BE 5-3/4" DEEP CENTRALLY LOCATED IN THE WALL ASSEMBLY WITH BULLNOSE CMU CORNERS. ALL SECURITY HOLLOW METAL FRAMES IN CMU/PRECAST WALLS TO BE 7-5/8" DEEP, CENTRALLY LOCATED OR AT EXTERIOR APPLICATION 3" FROM THE EXTERIOR FACE.
- AY. ALL STAIR ASSEMBLIES ARE TO BE ENGINEERED. STAIR SUPPLIER TO PROVIDE ADDITIONAL FRAMING AS REQUIRED FOR A FULLY WARRANTED SYSTEM.
- AZ. PROVIDE ADDITIONAL ACCESS PANELS AT ALL LOCATIONS REQUIRED FOR MAINTENANCE. COORDINATE WITH MECHANICAL, ELECTRICAL, PLUMBING, AND FIRE PROTECTION CONTRACTOR. PROVIDE SECURITY ACCESS PANELS IN SECURITY AREAS. SEE A-010 AND A-014 FOR SECURITY AREAS.
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- BBB. PROVIDE EXCEL B95 XLERATOR STAINLESS STEEL ANTIMICROBIAL WALL GUARD OR EQUAL AT ALL HAND DRYER LOCATIONS.
- CCC. ALL TOP OF MASONRY WALLS SHALL BE TO DECK AS INDICATED ON PLANS 2" SHORT OF DECK OR STRUCTURE ABOVE. FILL GAP WITH SOUND ATTENUATION BLANKET. AND PROVIDE JOINT SEALANT ON BOTH SIDES BETWEEN TOP OF WALL AND UNDERSIDE OF STRUCTURE/DECK. AT RATED WALL ASSEMBLIES PROVIDE FIRE RESISTIVE JOINT SYSTEM BETWEEN TOP OF WALL AND BOTTOM OF STRUCTURE/DECK.
- DDD. PROVIDE MOP/BROOM HOLDERS AT ALL MOP BASIN LOCATIONS. SEE SPECIFICATIONS FOR MANUFACTURER AND TYPE.
- EEE. REFERENCE STRUCTURAL DRAWINGS FOR ALL BEARING HEIGHTS.
- FFF. ALL DOORS SHOWN AT 45 DEGREES ARE EXISTING TO REMAIN. DOOR TAGS SHOWN FOR SECURITY ELECTRONICS SCOPE PURPOSES ONLY. SEE PLAN NOTES FOR ADDITIONAL SCOPE AT THE EXISTING DOORS.
- GGG. HATCHING WITH IN WALLS SHOWN IN PLANS AND SECTIONS INDICATES NEW CONSTRUCTION. SOLID HATCHING GRAY / OR HAFTONE INDICATES EXISTING CONSTRUCTION.
- HHH. ALL NEW DETENTION FIXTURES SHALL RECEIVE NEW DETENTION ACCESSORIES PER RESTROOM ACCESSORY SCHEDULE ON SHEET A-401.


2A OVERALL SECOND FLOOR PLAN BUILDING 2  
1/8" = 1'-0"

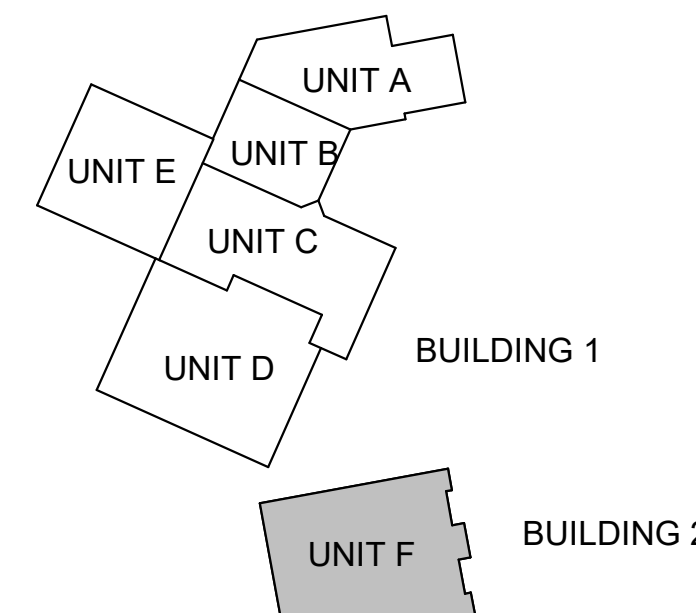

OVERALL SECOND  
FLOOR PLAN BUILDING 2

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2C FIRST FLOOR PLAN - UNIT A  
1/8" = 1'-0"

5.4.110 - FLOOR PLAN NOTES

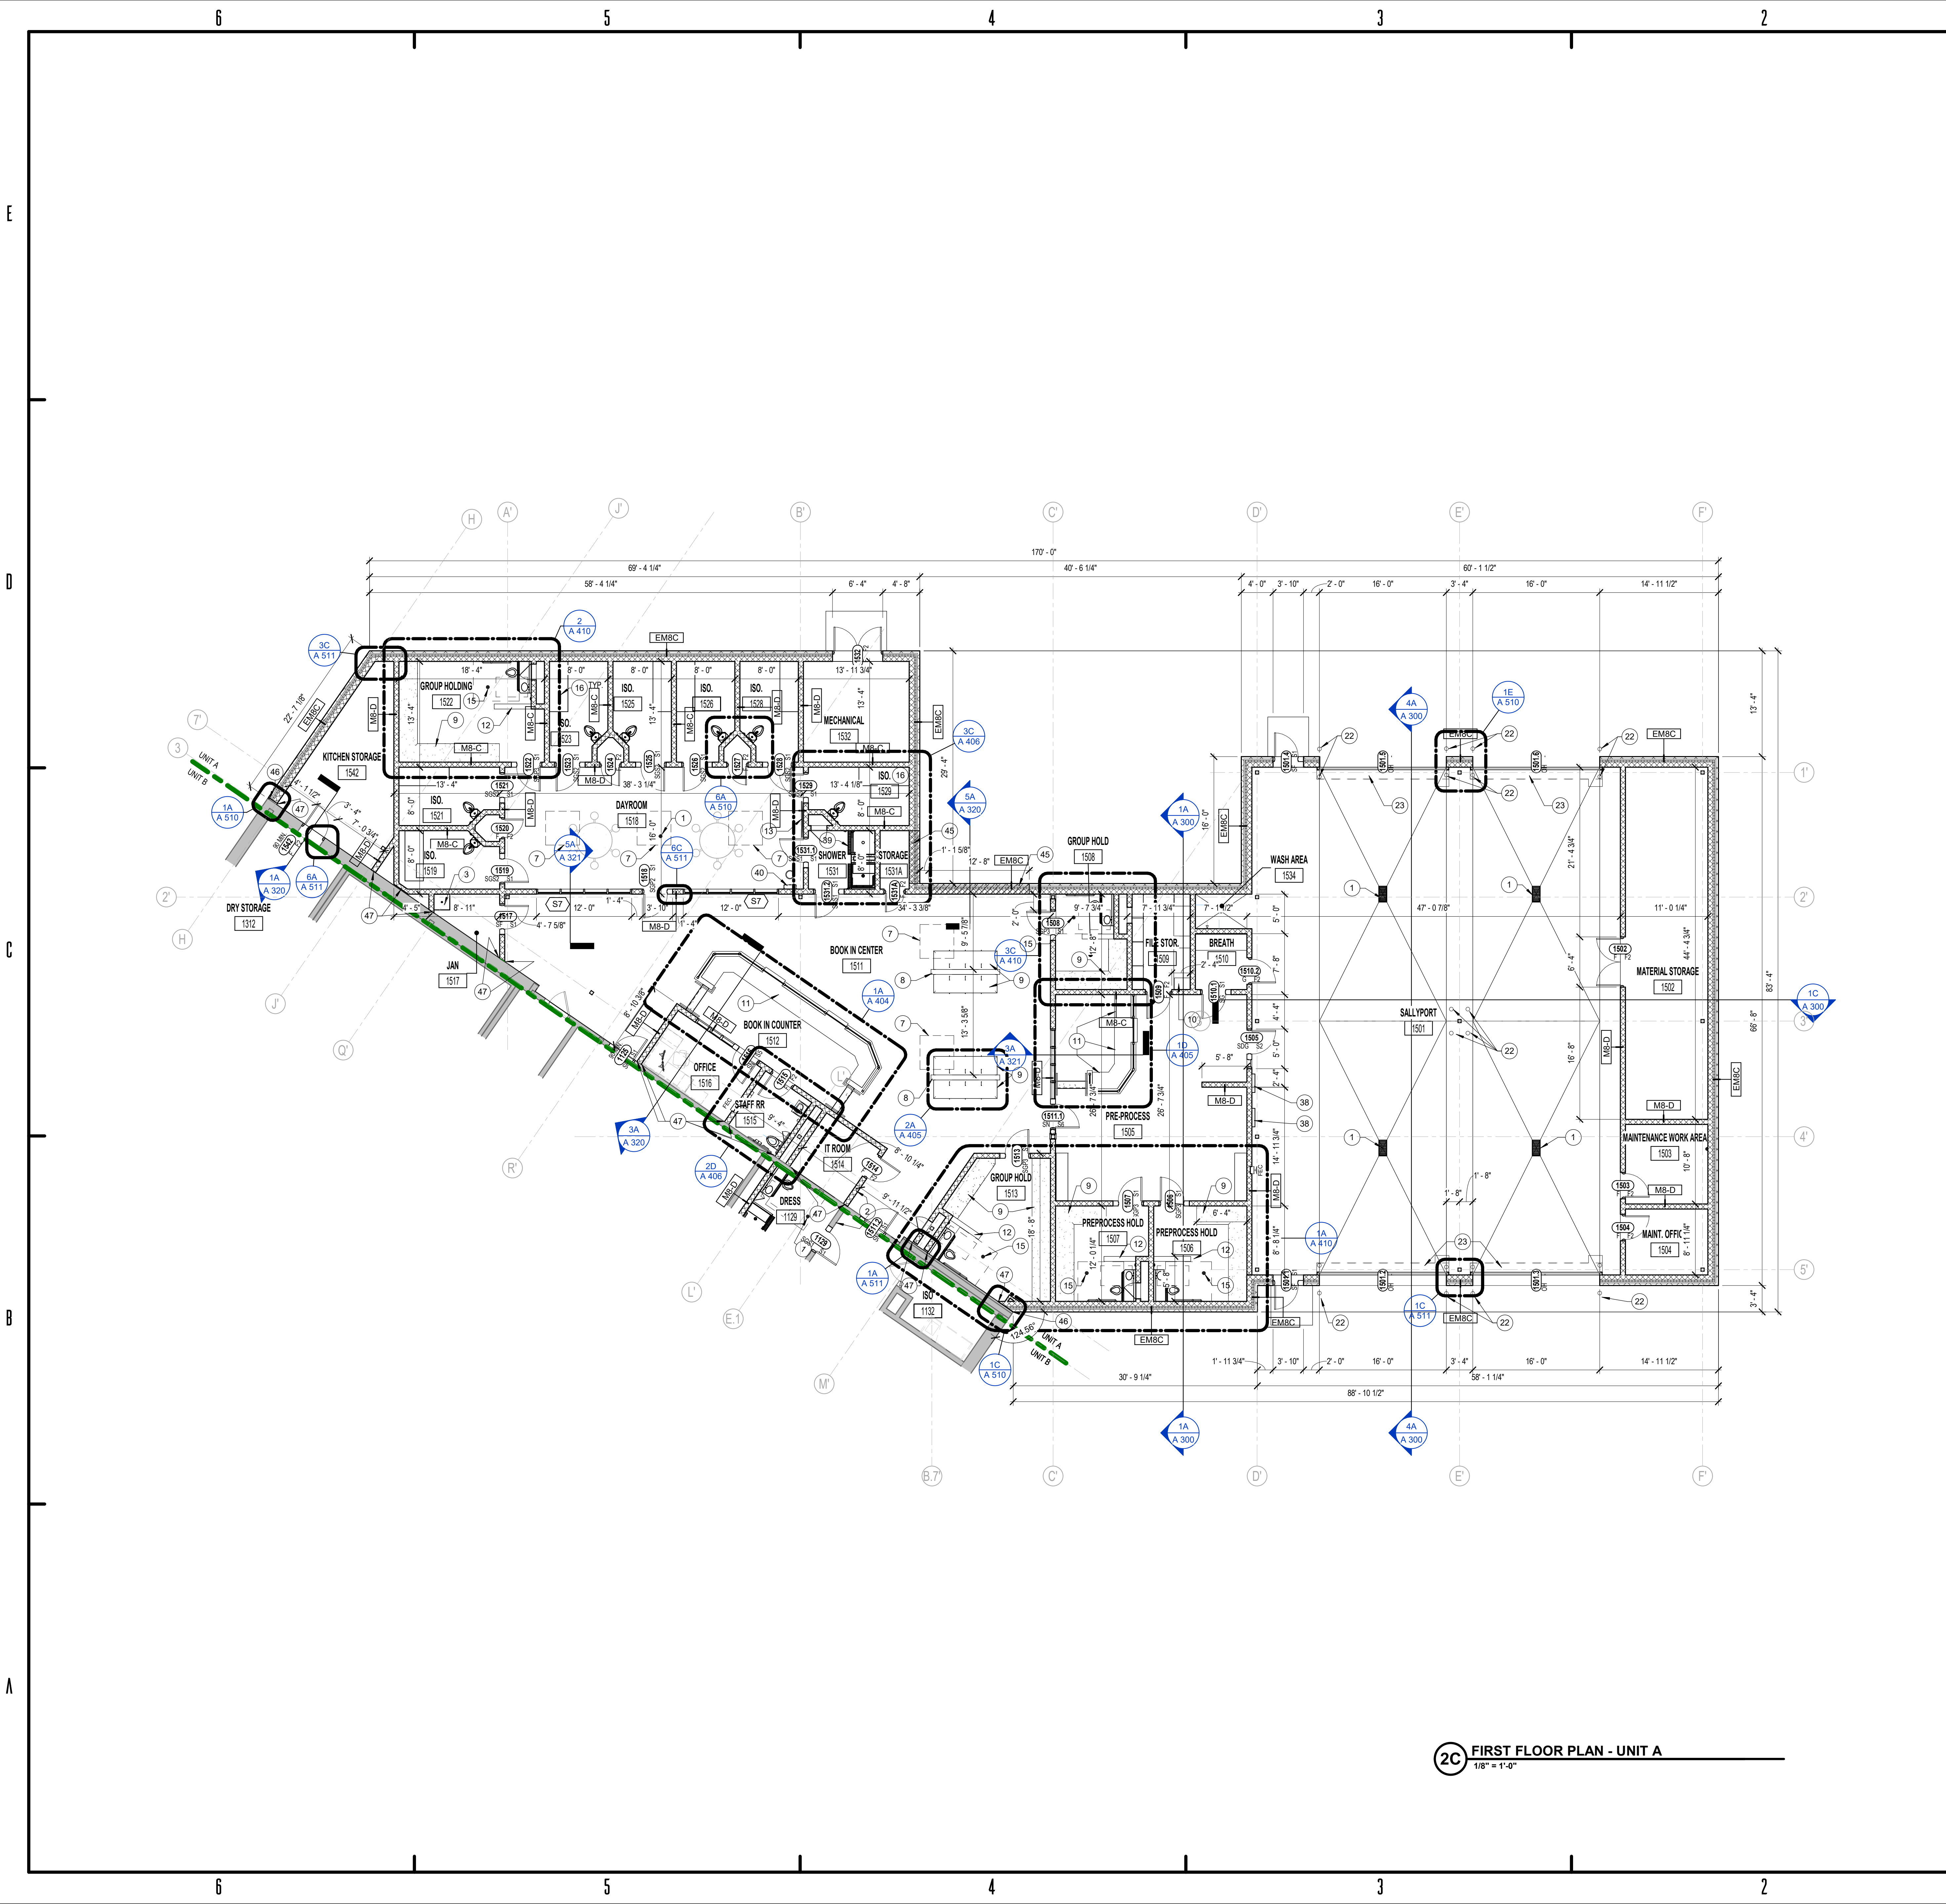
Key	Note
1	FLOOR DRAIN, SEE PLUMBING DRAWINGS. SLOPE ALL NEW FLOOR TO DRAIN AT 1/16" PER 12"
2	ALIGN NEW WALL CONSTRUCTION WITH EXISTING. COORDINATE WITH ALL TRADES.
3	TOP BASIN, SEE PLUMBING DRAWINGS. PROVIDE A 48" TALL STAINLESS STEEL BACKSPLASH 24" PAST BASIN EDGE.
4	MANUFACTURED SIX COMPARTMENT GUN LOCKER
5	INFILL EXISTING OPENING WITH NEW WALL ASSEMBLY TO MATCH EXISTING. TOOTH IN NEW CMU INTO EXISTING.
6	EXPOSED STRUCTURAL STEEL TO BE PRIMED AND PAINTED
7	LINE OF OVERHEAD SKYLIGHT, SEE CEILING AND ROOF PLANS FOR SCOPE
8	HALF HEIGHT WALL, PROVIDE DOUBLE BULLNOSE CORNER UNIT ON TOP
9	CONCRETE BENCH SEE DETAIL 10A 500
10	BUILT IN CASEWORK AND COUNTERTOP, SEE INTERIOR DRAWINGS FOR SCOPE AND MATERIAL
11	BOOK IN COUNTER BUILT-IN SEE A-401 FOR DETAILS
12	HALF HEIGHT WALL @ 47" A.F.F. WALL TYPE MB-C
13	FLAT SCREEN TV MOUNTING BRACKET @ 6'-0" A.F.F.
14	OWNER PROVIDED MARKER BOARD
15	FLOOR DRAIN, REFERENCE PLUMBING DRAWINGS
16	MANUFACTURED FULLY WELDED SECURITY BUNK SYSTEM - DOUBLE BUNK. BASIS OF DESIGN WORK MODEL, BS10-222 OR EQUAL
20	OWNER PROVIDED SECURITY-TYPE WALL-MOUNTED PHONE KIOSK. COORDINATE POWER/DATA LOCATIONS W/ OWNER.
21	WOVEN WIRE SECURITY SCREEN AND FRAME. PREFINISHED AS SELECTED BY ARCHITECT
22	6" STEEL SOLLARD, CONCRETE FILLED. TO BE PRIMED AND PAINTED SAFETY YELLOW
23	OVERHEAD COILING DOOR OPERATOR AND MOTOR
31	OWNER PROVIDED STACKABLE WASHER & DRYER UNIT.
32	OWNER PROVIDED VENDING MACHINES.
33	NEW 2-HIGH BUNK STACK, REFER TO SPEC. 11.19.10
34	NEW 15"W x 18"D x 6-7/8" LOCKER, REFER TO SPEC. #####
35	NEW 36"W x 12"D x 6-7/8" (3) WIDE LOCKERS, REFER TO SPEC. #####
36	EXISTING 24"W x 24"D x 6-7/8" LOCKER
37	EXISTING 2-HIGH BUNK STACK
38	MANUFACTURED METAL 6 COMPARTMENT GUN LOCKER SURFACE MOUNTED
39	TRENCH DRAIN, SEE PLUMBING DRAWINGS
40	DETENTION VIDEO VISITATION STATION, CONTRACTOR TO PROVIDE ROUGH-INS. EQUIPMENT BY OWNER
41	ENGINEERED MANUFACTURED METAL OPEN GRATE SECURITY GRADE STAIR. OPEN RISER. STRINGERS TO BE PRIMED AND PAINTED. TREADS TO BE GALVANIZED. ALL CUT "SHARP" EDGES TO BE REMOVED OR PROVIDE AN ANGLE TO COVER CUT EDGES, TYPICAL.
42	MANUFACTURED METAL PAN STAIR, CONCRETE FILLED
43	ELEVATED CONTROL ROOM FLOOR SYSTEM, 7" PROVIDE PLASTIC LAMINATE FLOOR AS SELECTED BY ARCHITECT. PROVIDE TIE GUARD AT THE ENTIRE PERIMETER
44	STEEL COVER PLATE, SECURE WITH SECURITY FASTENERS AND SECURITY CAULKING, AT ALL CELL LOCATIONS
45	KNOCK OUT MASONRY PANEL CONSTRUCTION TO MATCH ADJACENT WALL CONSTRUCTION. TO LIMITS INDICATED TO 7'-4" AFF. PROVIDE MASONRY UNTELS PER STRUCTURAL UNTEL SCHEDULE
46	EXTERIOR WALL TO WALL 2" EXPANSION JOINT COVER. PROVIDE AIRWEATHER BARRIER AND STUFF CAVITY WITH BATT INSULATION RATED
47	INTERIOR WALL TO WALL 2" EXPANSION JOINT COVER. PROVIDE 12 GA SECURITY TYPE COVERS IN DETENTION SPACES
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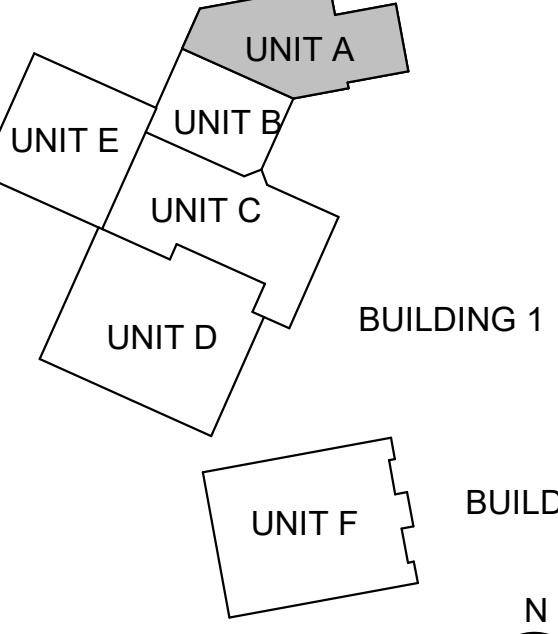
#	Revision	Date
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Project #: 20-700-151-2  
Designed By: LD/SP  
Drawn By: CW  
Checked By: LD/IV  
Date: 01.28.2022



Eric Wepler

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FIRST FLOOR PLAN UNIT A

AF 1A1

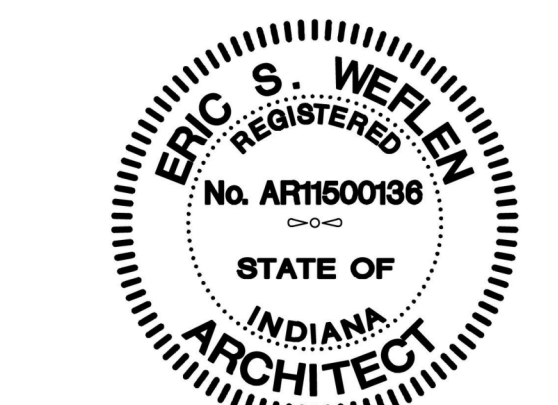



2B FIRST FLOOR PLAN - UNIT B  
1/8" = 1'-0"

5.4.110 - FLOOR PLAN NOTES	
Key	Note
1	FLOOR DRAIN, SEE PLUMBING DRAWINGS. SLOPE ALL NEW FLOOR TO DRAIN AT 1/16" PER 12"
2	ALIGN NEW WALL CONSTRUCTION WITH EXISTING. COORDINATE WITH ALL TRADES.
3	NOV. BASKIN, SEE PLUMBING DRAWINGS. PROVIDE A 48" TALL STAINLESS STEEL BACKSPLASH 24" PAST BASIN EDGE.
4	MANUFACTURED SIX COMPARTMENT GUN LOCKER
5	INFILL EXISTING OPENING WITH NEW WALL ASSEMBLY TO MATCH EXISTING. TOOTH IN NEW CMU INTO EXISTING.
6	EXPOSED STRUCTURAL STEEL TO BE PRIMED AND PAINTED.
7	LINE OF OVERHEAD SKYLIGHT, SEE CEILING AND ROOF PLANS FOR SCOPE.
8	HALF HEIGHT WALL, PROVIDE DOUBLE BULLNOSE CORNER UNIT ON TOP.
9	CONCRETE BENCH SEE DETAIL 10A 500
10	BUILT IN CASEWORK AND COUNTERTOP, SEE INTERIOR DRAWINGS FOR SCOPE AND MATERIAL.
11	BOOK IN COUNTER BUILT-IN SEE A-401 FOR DETAILS.
12	HALF HEIGHT WALL @ 47" A.F.F. WALL TYPE M8-C
13	FLAT SCREEN TV MOUNTING BRACKET @ 6'-0" A.F.F.
14	OWNER PROVIDED MARKER BOARD
15	FLOOR DRAIN, REFERENCE PLUMBING DRAWINGS
16	MANUFACTURED FULLY WELDED SECURITY BUNK SYSTEM - DOUBLE BUNK. BASIS OF DESIGN NOKX MODEL, B510-222 OR EQUAL.
20	OWNER PROVIDED SECURITY-TYPE WALL-MOUNTED PHONE KIOSK. COORDINATE POWER/DATA LOCATIONS W/ OWNER.
21	WOVEN WIRE SECURITY SCREEN AND FRAME. PREFINISHED AS SELECTED BY ARCHITECT
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44	STEEL COVER PLATE, SECURE WITH SECURITY FASTENERS AND SECURITY CAULKING, AT ALL CELL LOCATIONS.
45	KNOCK OUT MASONRY PANEL CONSTRUCTION TO MATCH ADJACENT WALL CONSTRUCTION. TO LIMITS INDICATED TO 7'-4" AFF. PROVIDE MASONRY UNTELS PER STRUCTURAL UNTEL SCHEDULE.
46	EXTERIOR WALL TO WALL 2" EXPANSION JOINT COVER. PROVIDE AIRWEATHER BARRIER AND STUFF CAVITY WITH BATT INSULATION RATED.
47	INTERIOR WALL TO WALL 2" EXPANSION JOINT COVER. PROVIDE 12 GA SECURITY TYPE COVERS IN DETENTION SPACES.
48	EXTERIOR WALL TO WALL 4" EXPANSION JOINT COVER. PROVIDE AIRWEATHER BARRIER AND STUFF CAVITY WITH BATT INSULATION RATED.
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KNOX COUNTY JUSTICE CAMPUS

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#	Revision	Date
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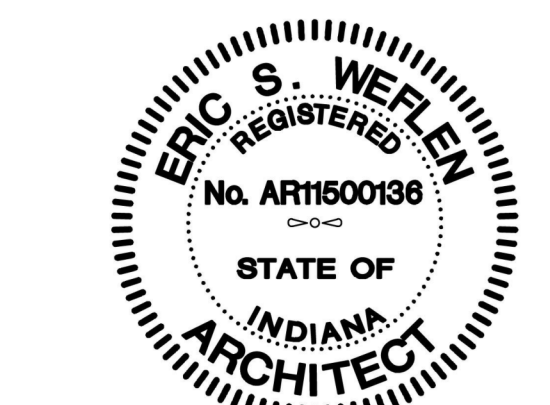
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Designed By: LD/SP


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Checked By: LD

Date: 01.28.2022




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FIRST FLOOR PLAN UNIT B

AF 1B1

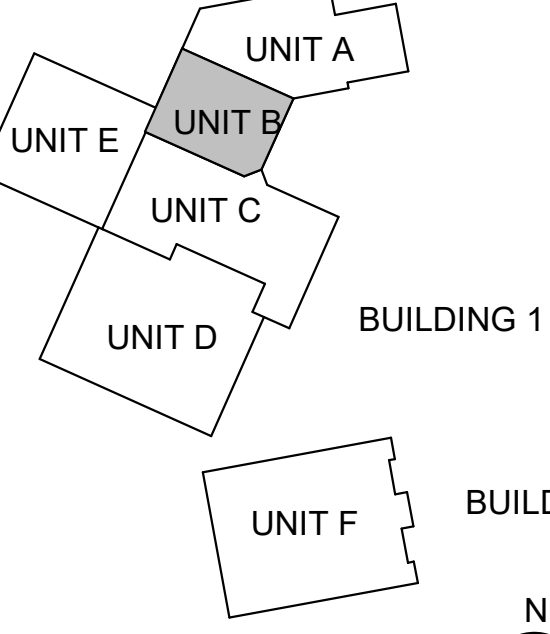



5.4.110 - FLOOR PLAN NOTES	
Key	Note
1	FLOOR DRAIN, SEE PLUMBING DRAWINGS. SLOPE ALL NEW FLOOR TO DRAIN AT 1/16" PER 12"
2	ALIGN NEW WALL CONSTRUCTION WITH EXISTING. COORDINATE WITH ALL TRADES.
3	NOV. BASIN, SEE PLUMBING DRAWINGS. PROVIDE A 48" TALL STAINLESS STEEL BACKSPLASH 24" PAST BASIN EDGE.
4	MANUFACTURED SIX COMPARTMENT GUN LOCKER
5	INFILL EXISTING OPENING WITH NEW WALL ASSEMBLY TO MATCH EXISTING. TOOTH IN NEW CMU INTO EXISTING.
6	EXPOSED STRUCTURAL STEEL TO BE PRIMED AND PAINTED
7	LINE OF OVERHEAD SKYLIGHT, SEE CEILING AND ROOF PLANS FOR SCOPE
8	HALF HEIGHT WALL, PROVIDE DOUBLE BULLNOSE CORNER UNIT ON TOP
9	CONCRETE BENCH SEE DETAIL 10A 500
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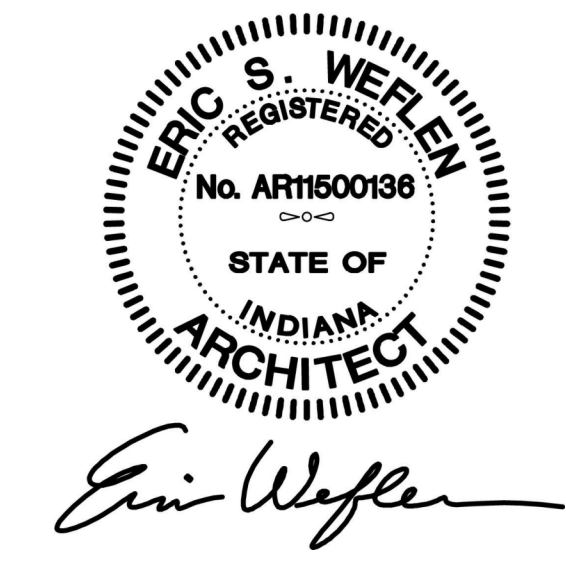
2B FIRST FLOOR PLAN - UNIT C  
1/8" = 1'-0"

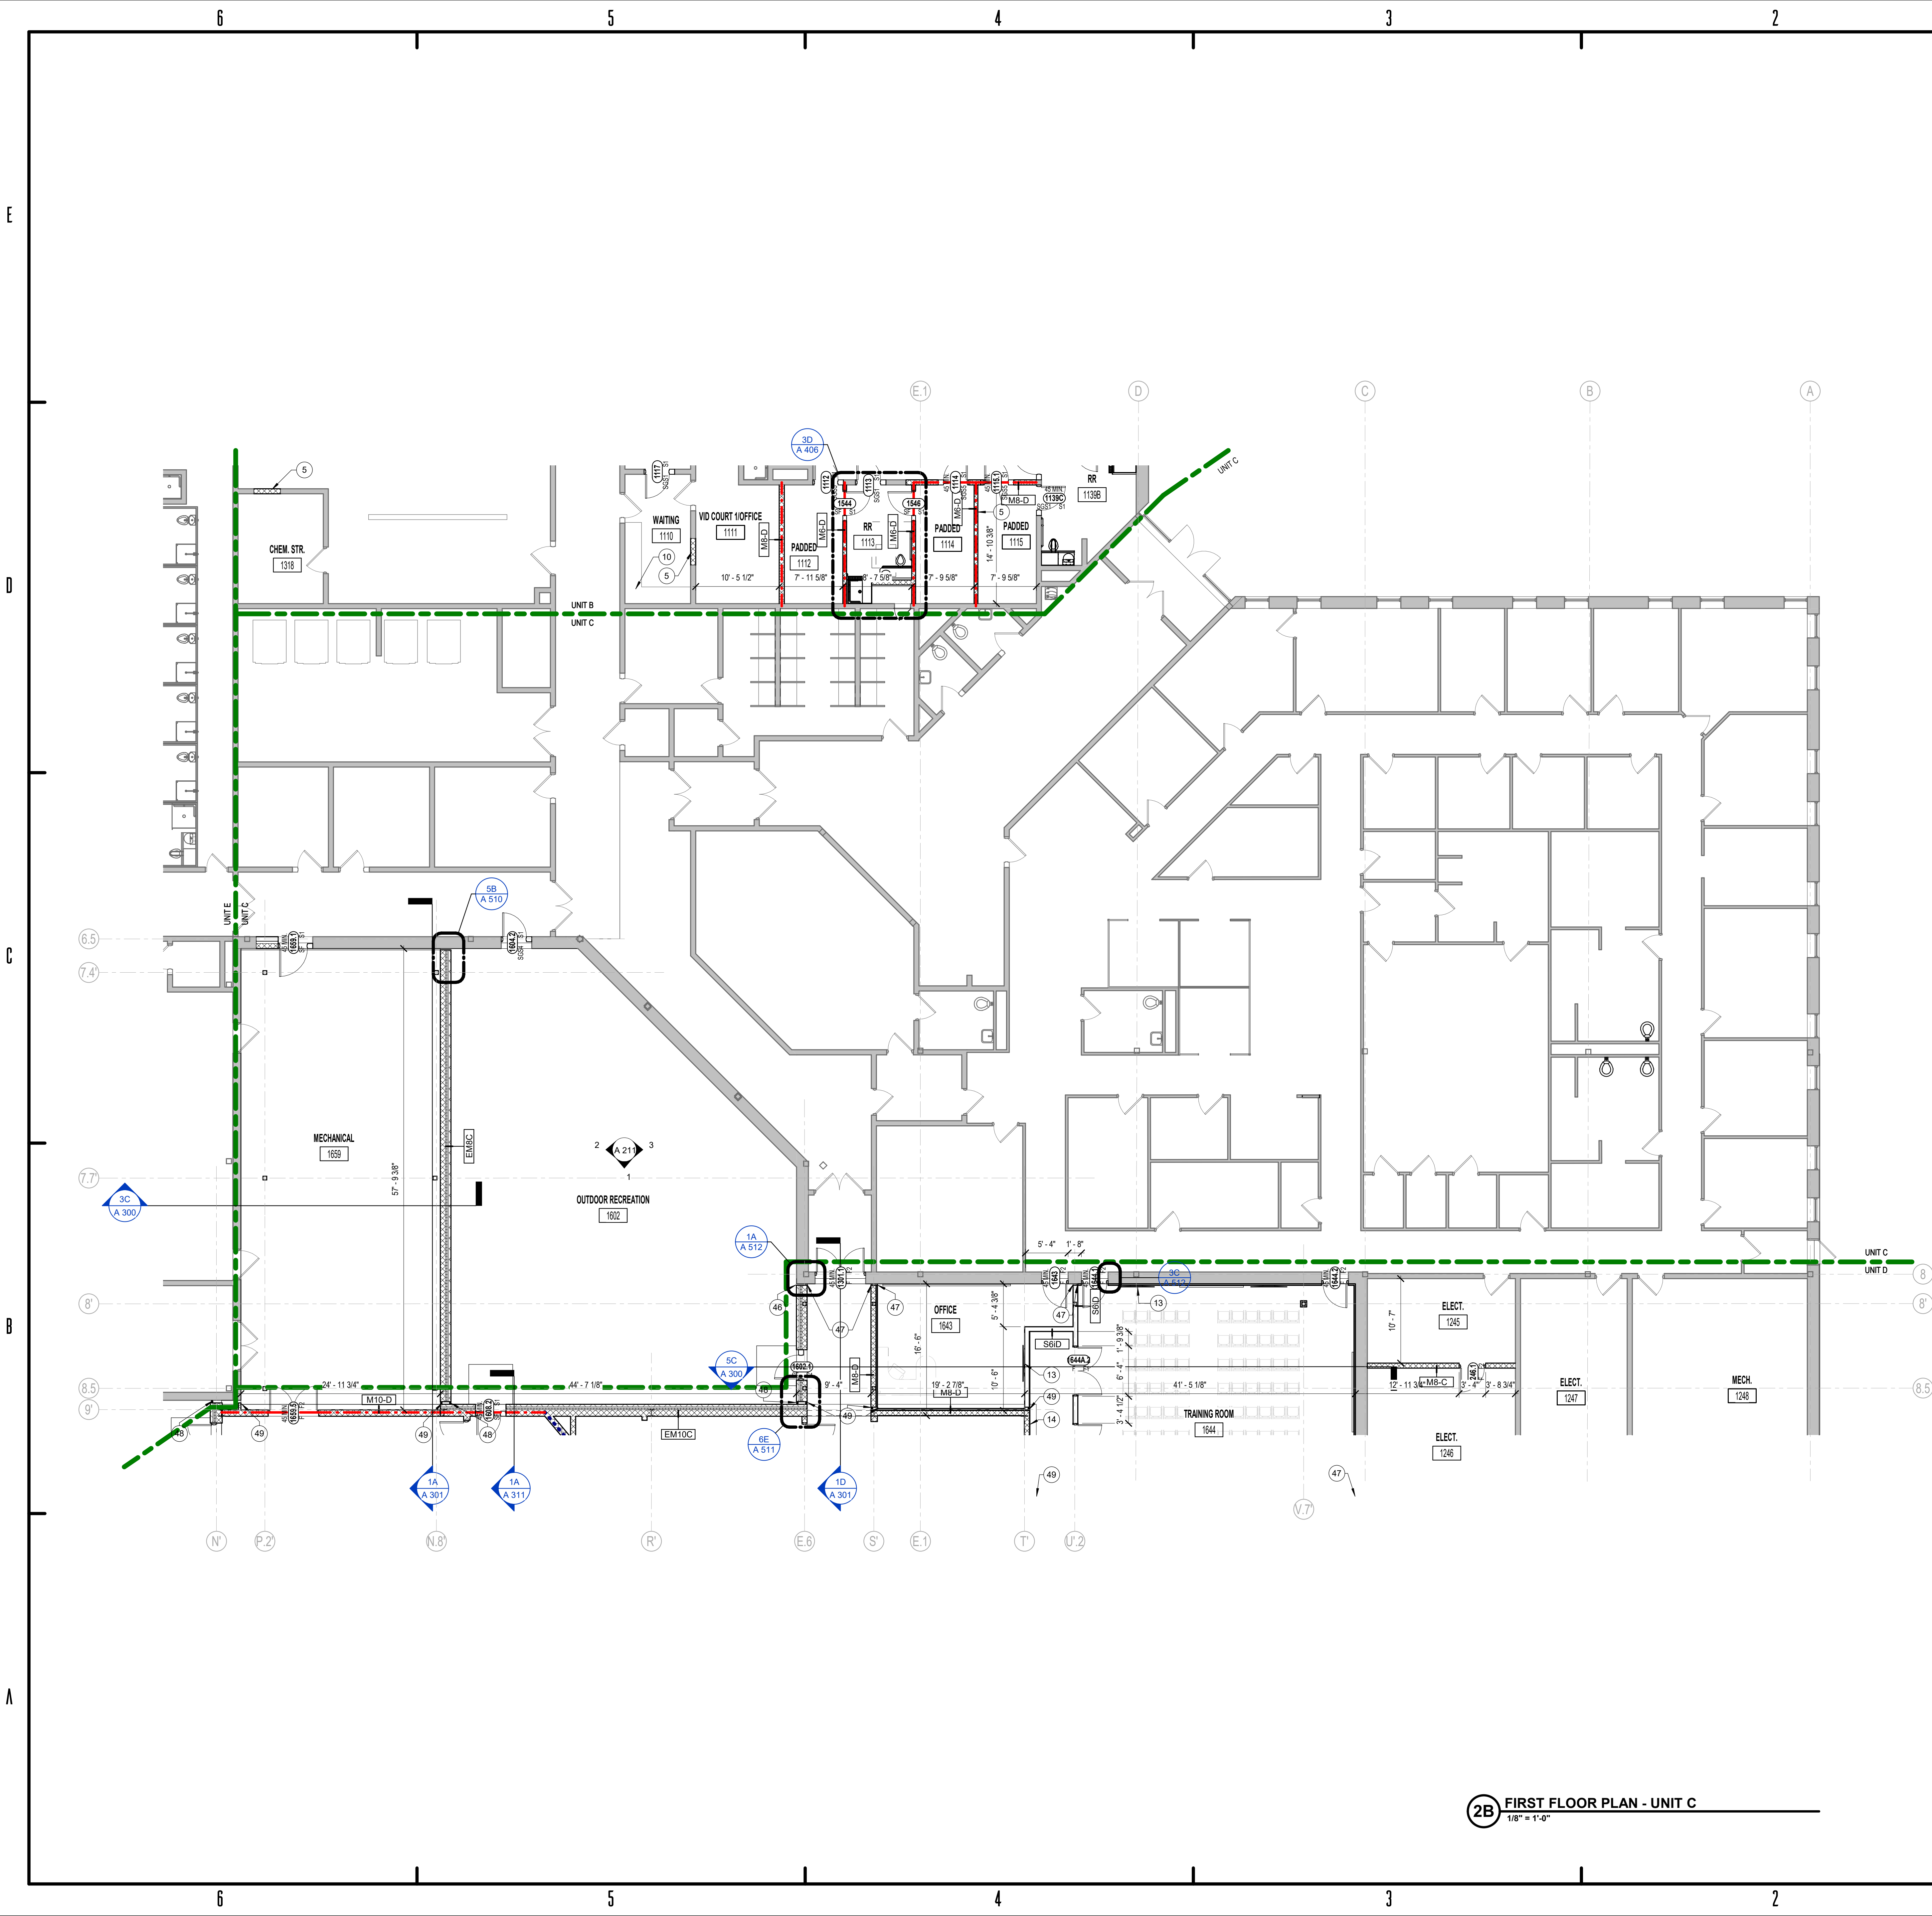


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KNOX COUNTY JUSTICE CAMPUS  
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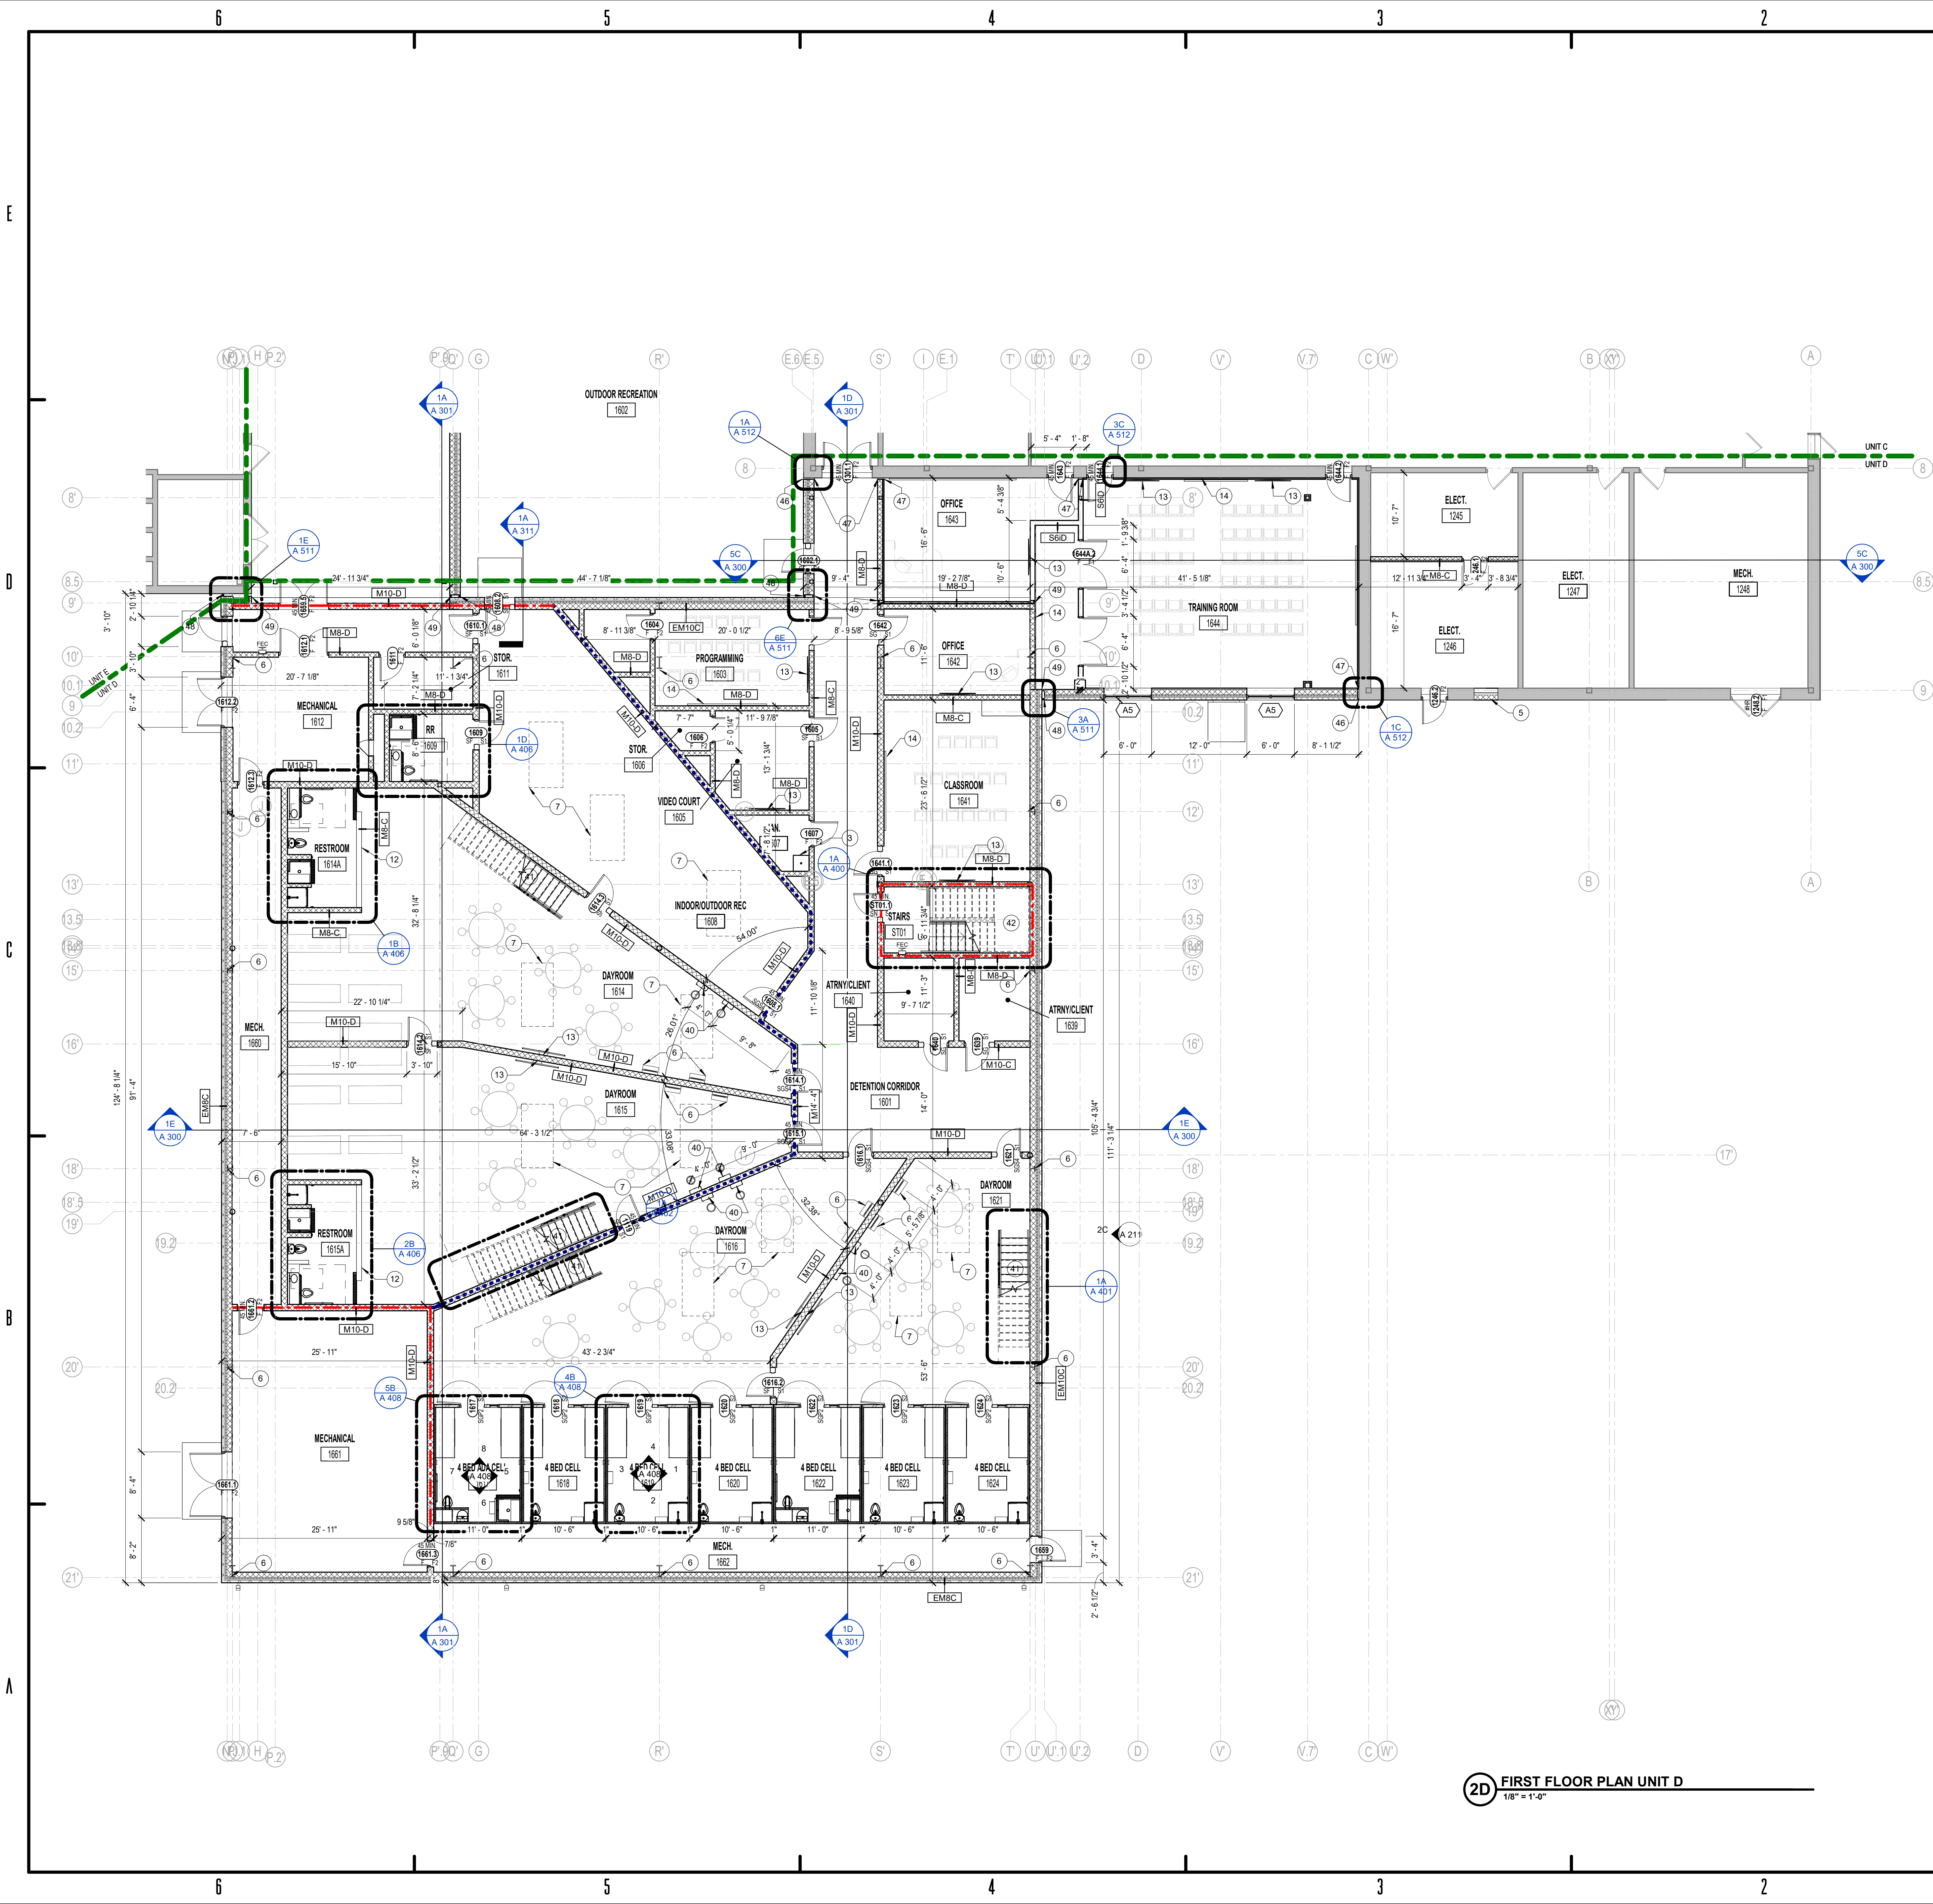
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FIRST FLOOR PLAN UNIT C

AF 1C1





2D FIRST FLOOR PLAN UNIT D  
1/8" = 1'-0"

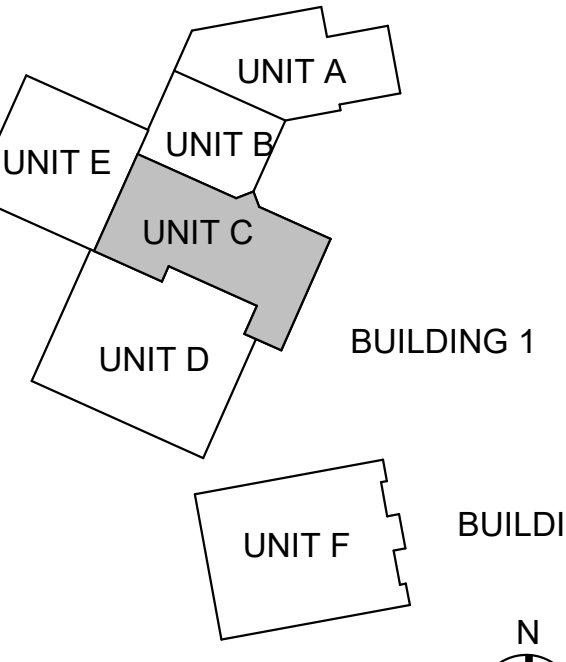5.4.110 - FLOOR PLAN NOTES

Key	Note
1	FLOOR DRAIN, SEE PLUMBING DRAWINGS. SLOPE ALL NEW FLOOR TO DRAIN AT 1/16" PER 12"
2	ALIGN NEW WALL CONSTRUCTION WITH EXISTING. COORDINATE WITH ALL TRADES.
3	MOP BASIN, SEE PLUMBING DRAWINGS. PROVIDE A 48" TALL STAINLESS STEEL BACKSPLASH 24" PAST BASIN EDGE.
4	MANUFACTURED SIX COMPARTMENT GUN LOCKER
5	INFILL EXISTING OPENING WITH NEW WALL ASSEMBLY TO MATCH EXISTING. TOOTH IN NEW CMU INTO EXISTING.
6	EXPOSED STRUCTURAL STEEL TO BE PRIMED AND PAINTED
7	LINE OF OVERHEAD SKYLIGHT, SEE CEILING AND ROOF PLANS FOR SCOPE
8	HALF HEIGHT WALL, PROVIDE DOUBLE BULLNOSE CORNER UNIT ON TOP
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11	BOOK IN COUNTER BUILT-IN SEE A-401 FOR DETAILS
12	HALF HEIGHT WALL @ 47" A.F.F. WALL TYPE M8-C
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20	OWNER PROVIDED SECURITY-TYPE WALL-MOUNTED PHONE KIOSK. COORDINATE POWER/DATA LOCATIONS W/ OWNER.
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49	INTERIOR WALL TO WALL 4" EXPANSION JOINT COVER



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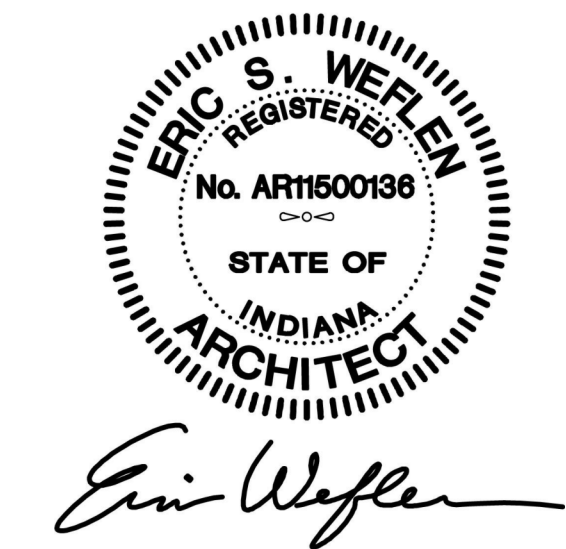
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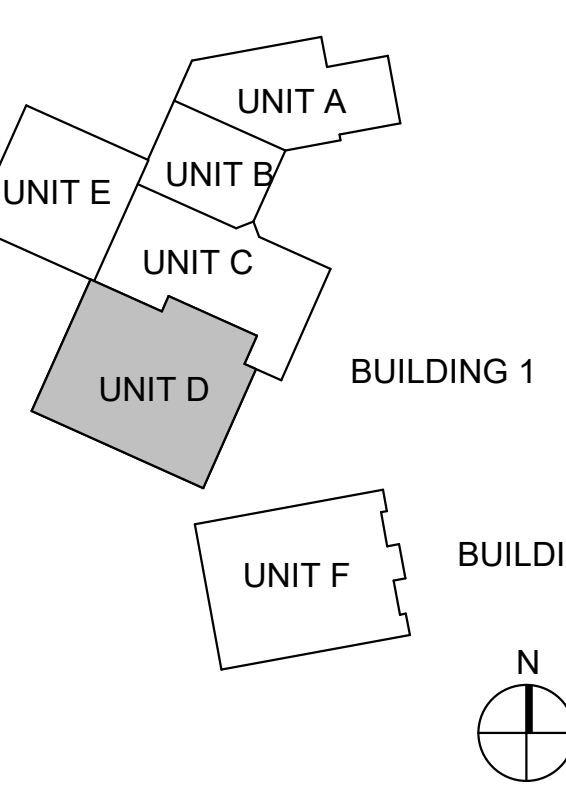
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Project #: 20-700-151-2  
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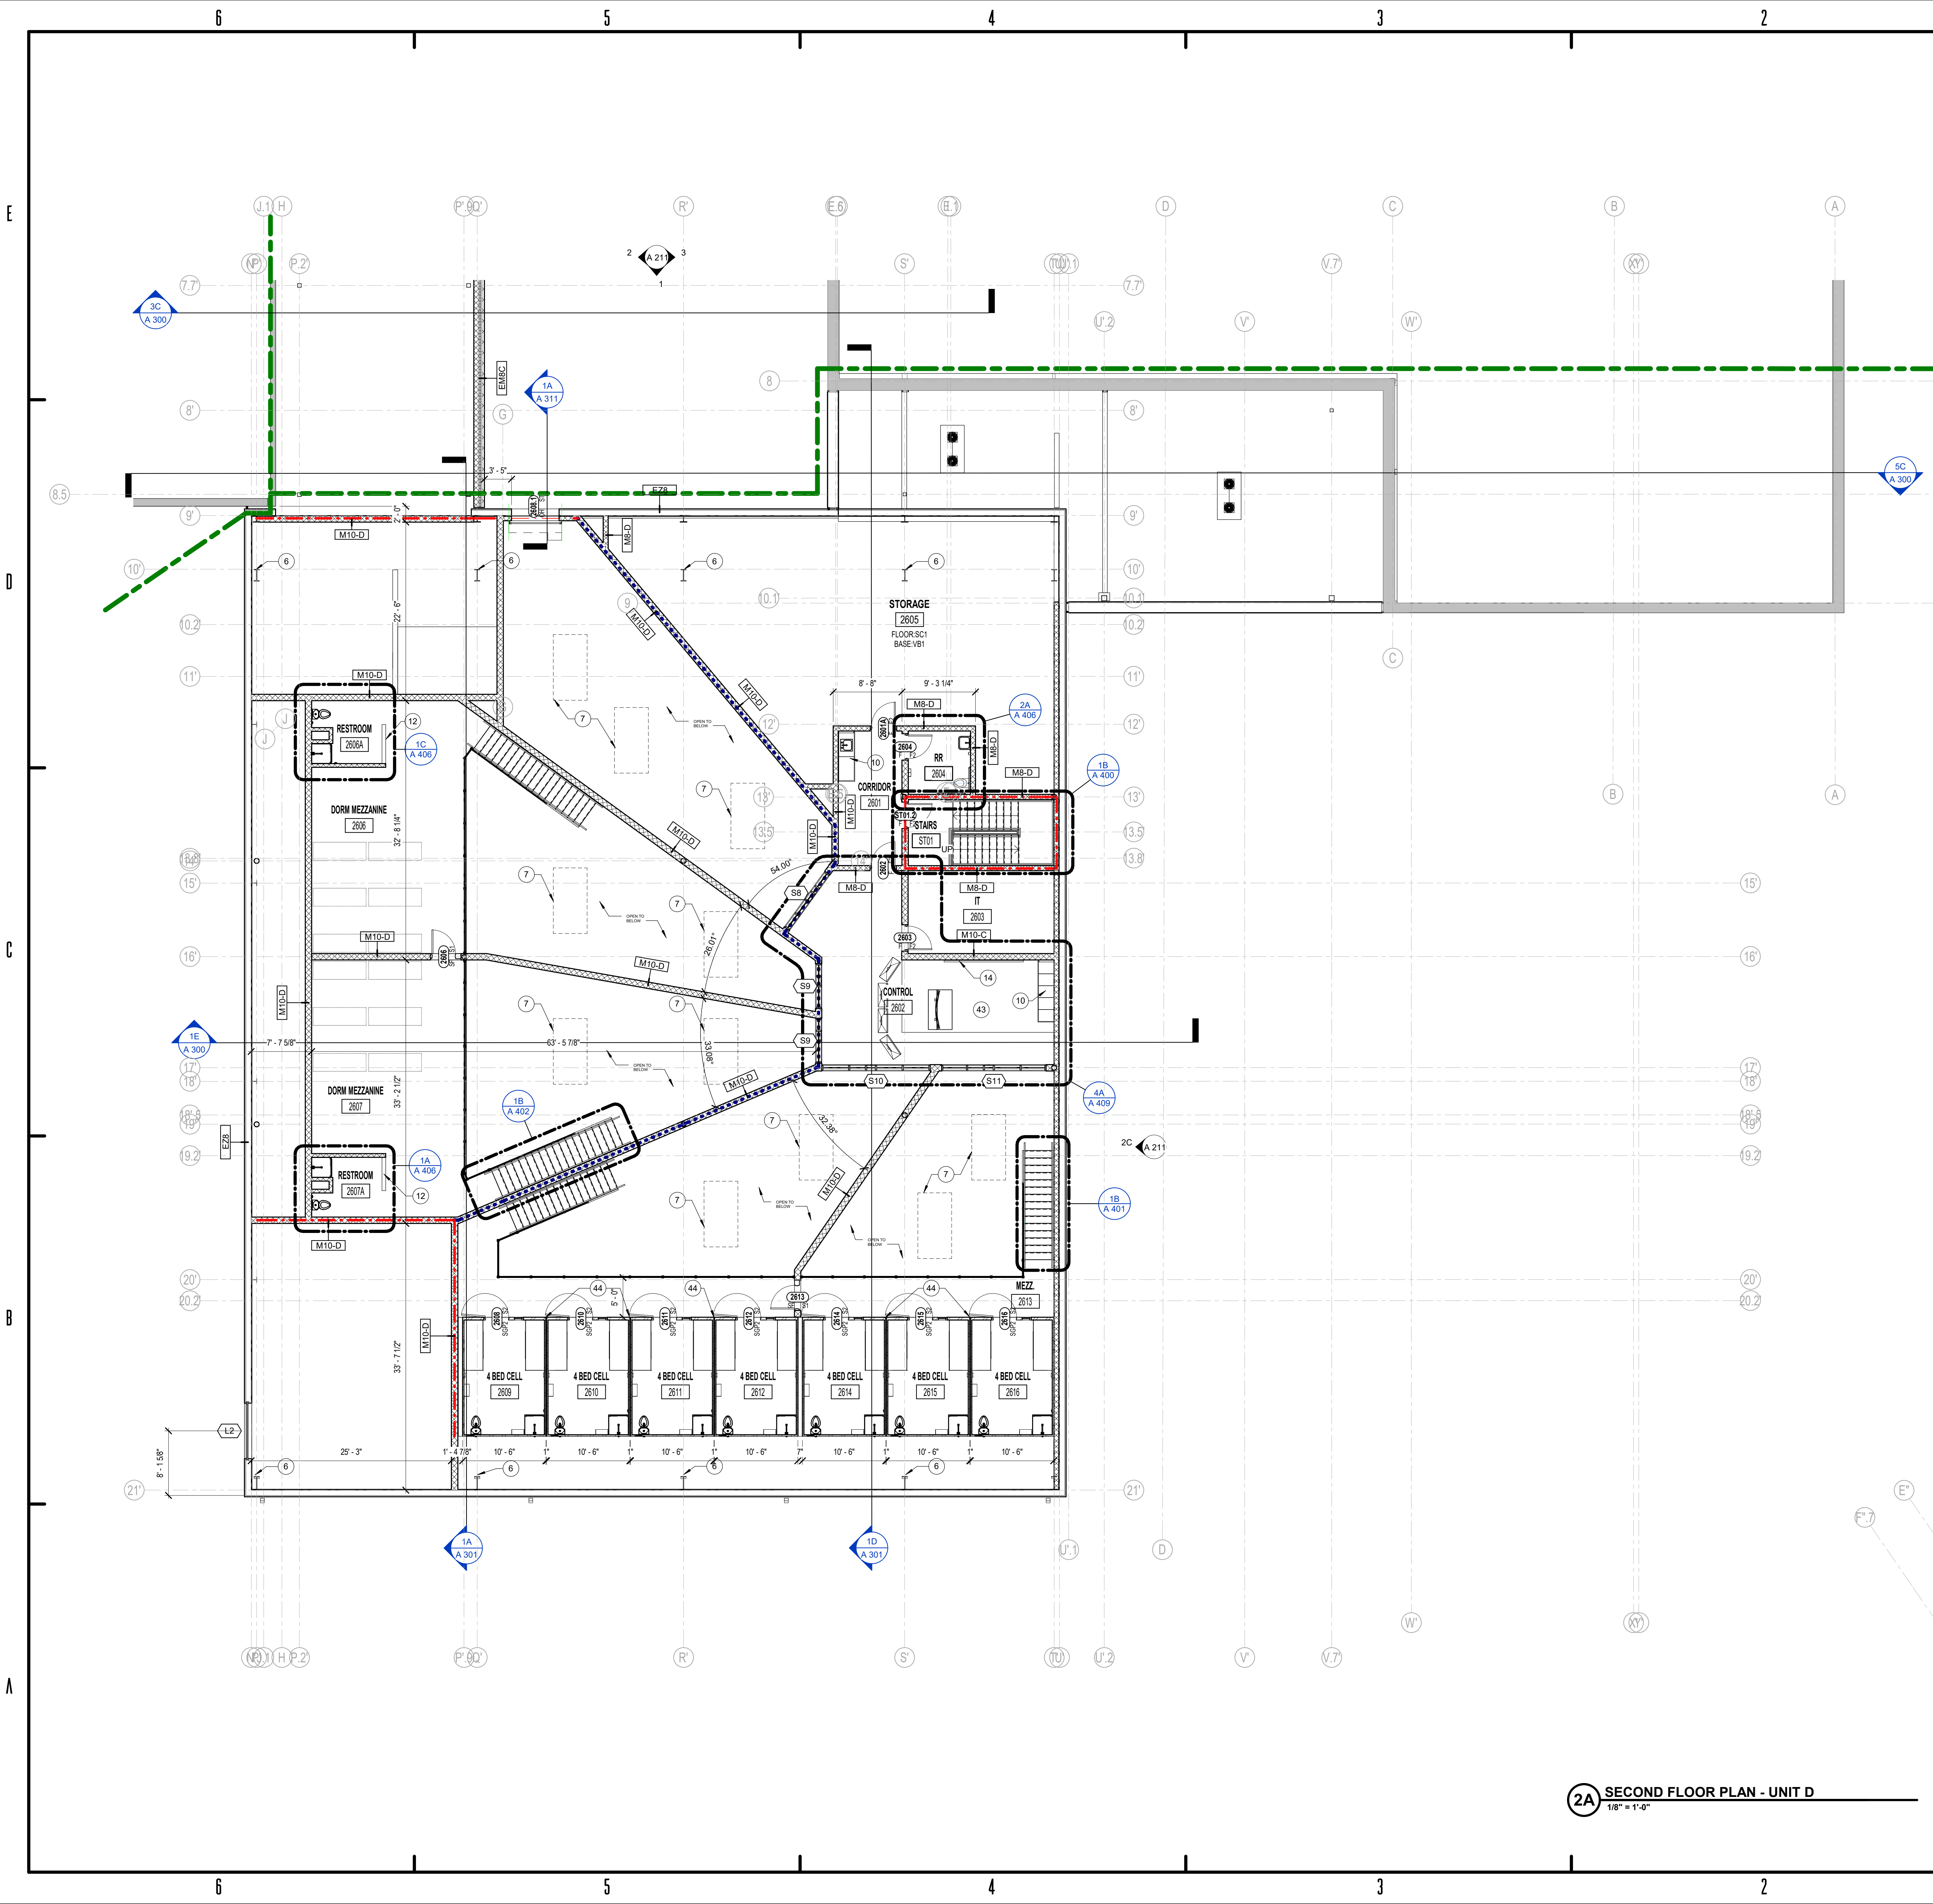
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FIRST FLOOR PLAN UNIT D

AF 1D1





5.4.110 - FLOOR PLAN NOTES	
Key	Note
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3	TOP BASIN, SEE PLUMBING DRAWINGS. PROVIDE A 48" TALL STAINLESS STEEL BACKSPLASH 24" PAST BASIN EDGE.
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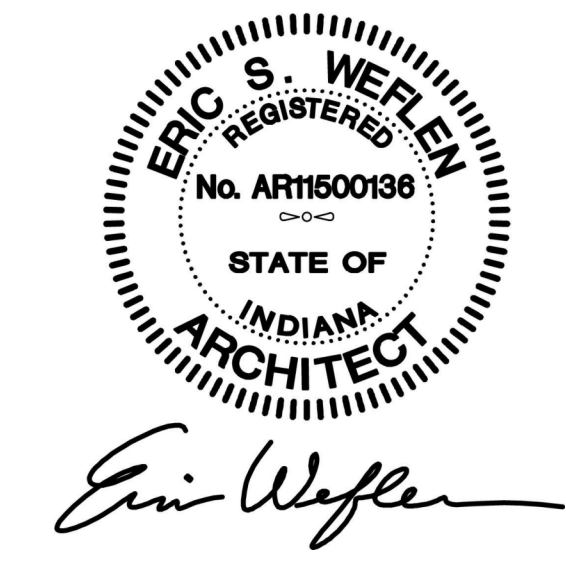
2A SECOND FLOOR PLAN - UNIT D  
1/8" = 1'-0"




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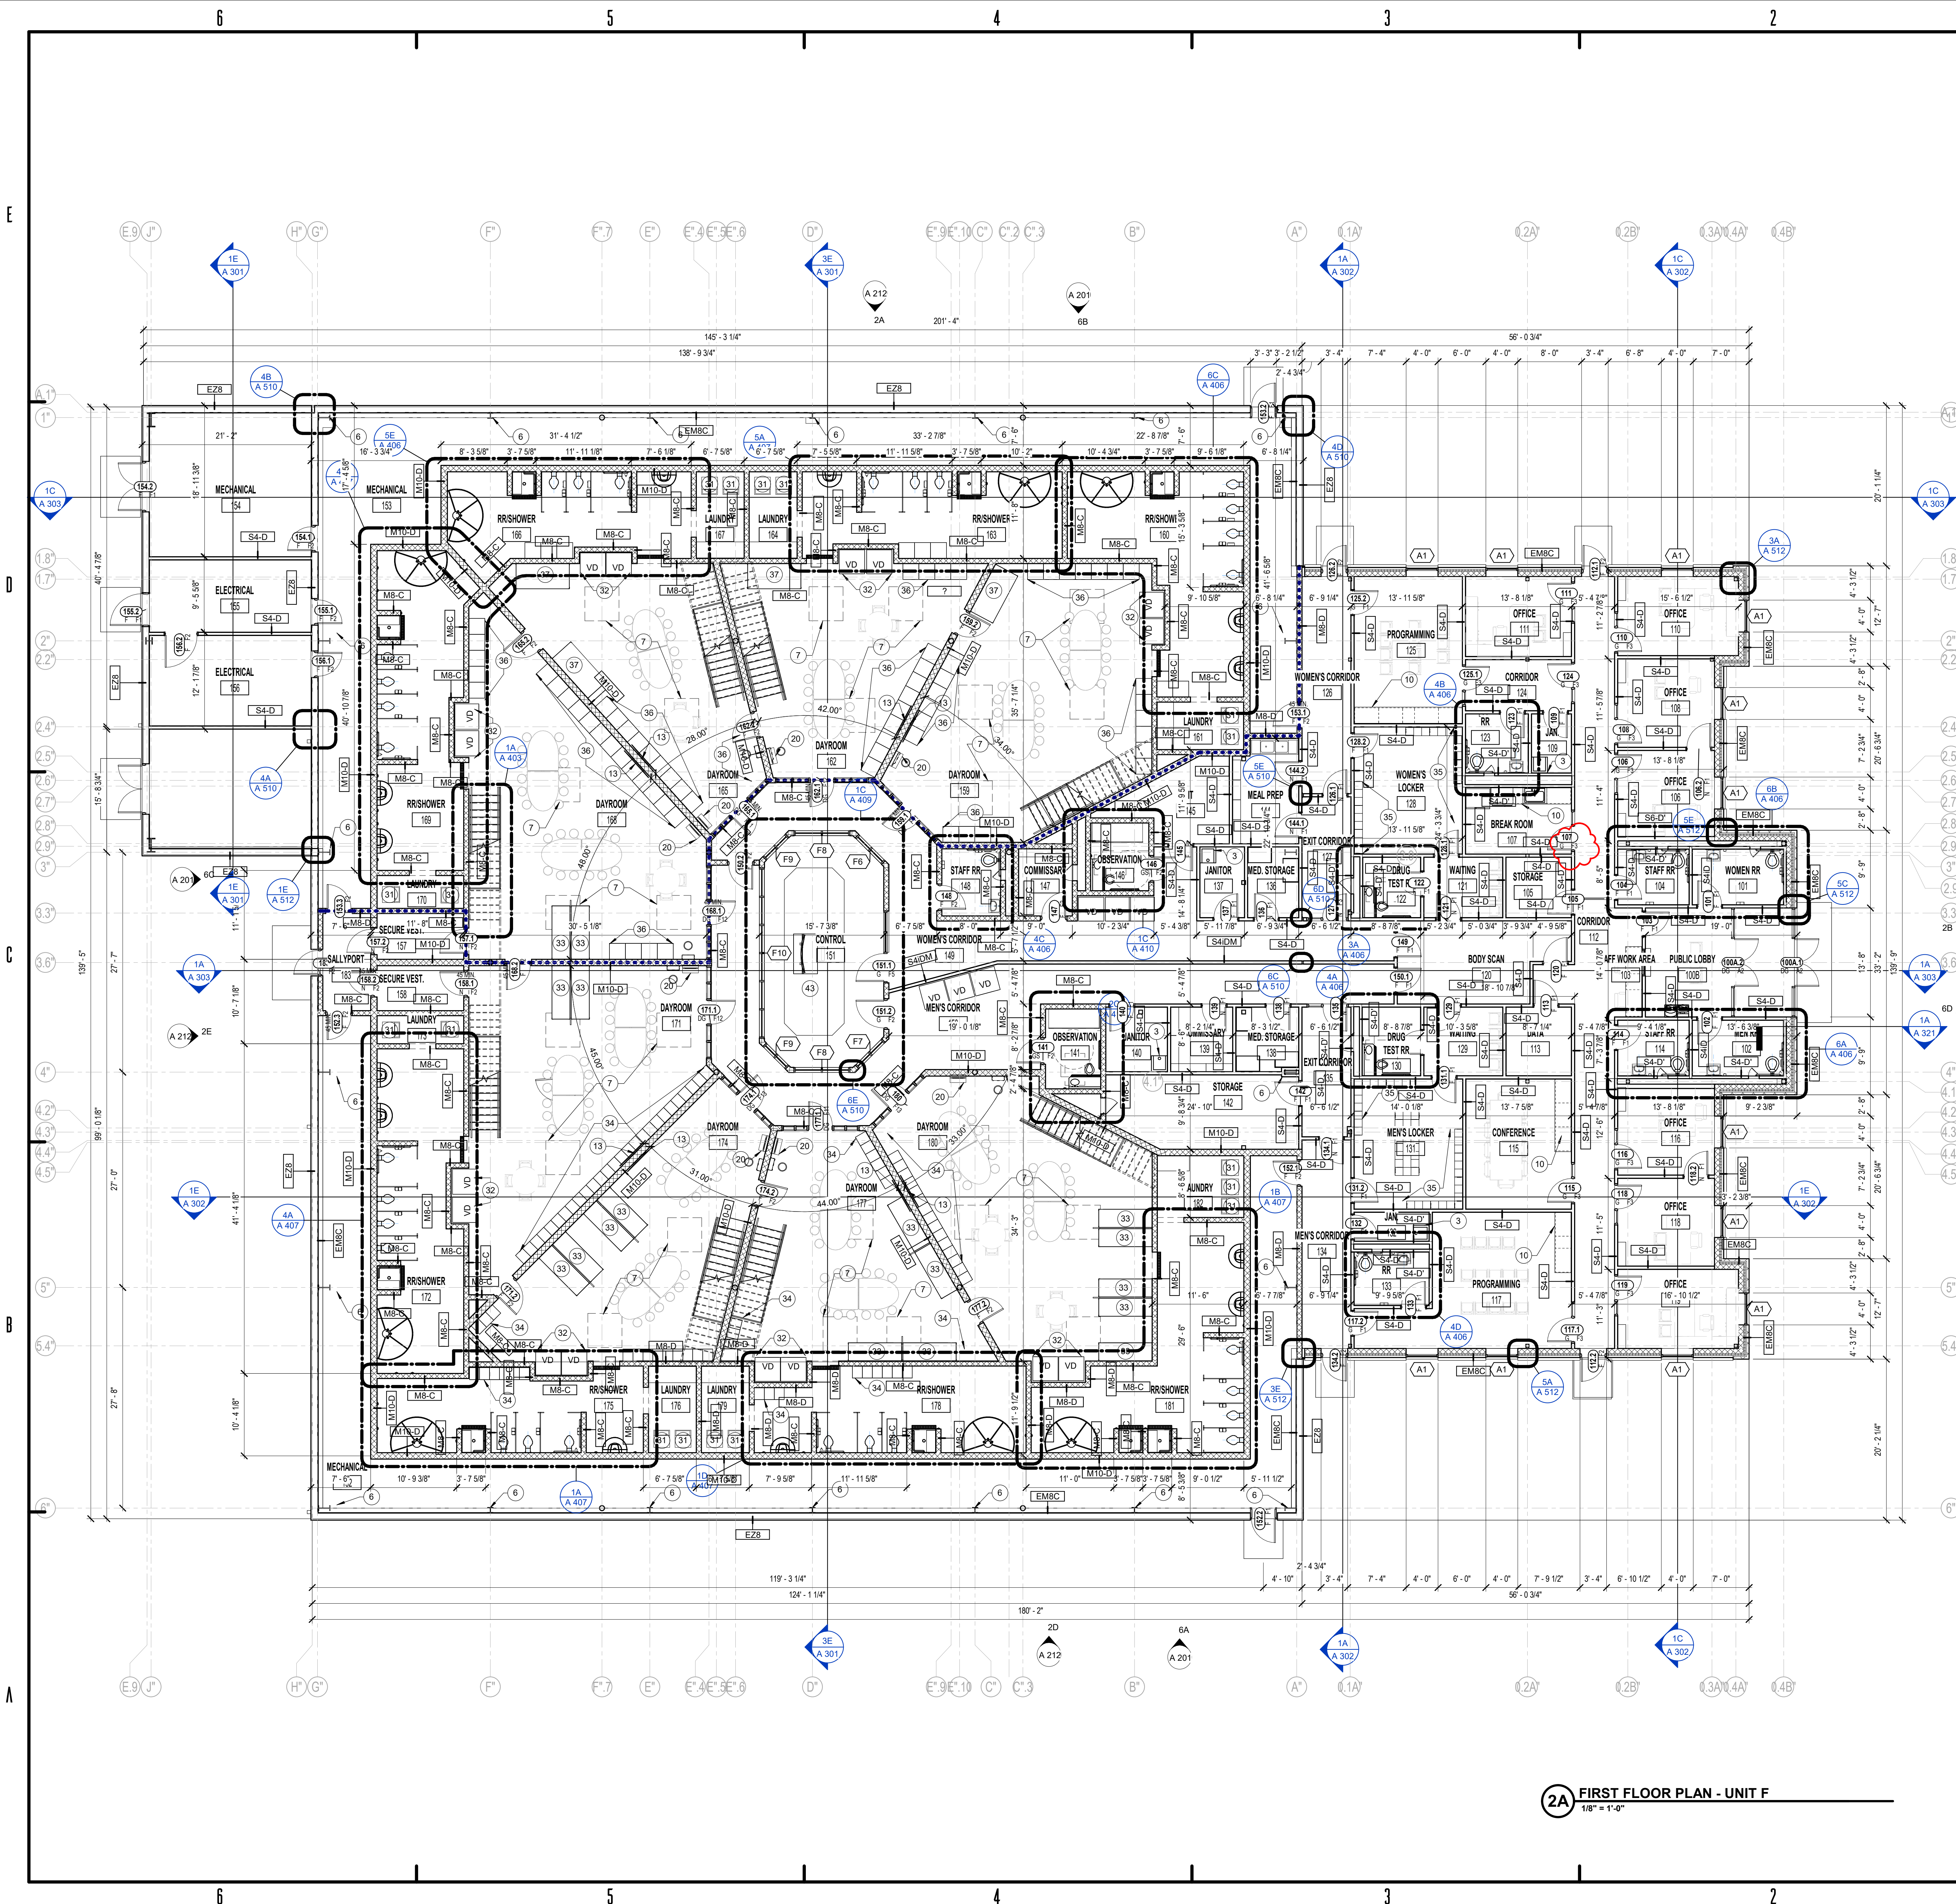
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SECOND FLOOR PLAN  
UNIT D

AF 1D2





5.4.110 - FLOOR PLAN NOTES	
Key	Note
1	FLOOR DRAIN, SEE PLUMBING DRAWINGS. SLOPE ALL NEW FLOOR TO DRAIN AT 1/16" PER 12"
2	ALIGN NEW WALL CONSTRUCTION WITH EXISTING. COORDINATE WITH ALL TRADES.
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10	BUILT IN CASEWORK AND COUNTERTOP, SEE INTERIOR DRAWINGS FOR SCOPE AND MATERIAL
11	BOOK IN COUNTER BUILT-IN SEE A-401 FOR DETAILS
12	HALF HEIGHT WALL @ 40" A.F.F. WALL TYPE MB-C
13	FLAT SCREEN TV MOUNTING BRACKET @ 6'-0" A.F.F.
14	OWNER PROVIDED MARKER BOARD
15	FLOOR DRAIN, REFERENCE PLUMBING DRAWINGS
16	MANUFACTURED FULLY WELDED SECURITY BUNK SYSTEM - DOUBLE BUNK. BASIS OF DESIGN WORK MODEL B510-222 OR EQUAL
20	OWNER PROVIDED SECURITY-TYPE WALL-MOUNTED PHONE KIOSK. COORDINATE POWER/DATA LOCATIONS W/ OWNER.
21	WOVEN WIRE SECURITY SCREEN AND FRAME. PREFINISHED AS SELECTED BY ARCHITECT
22	6" STEEL SOLLARD, CONCRETE FILLED. TO BE PRIMED AND PAINTED SAFETY YELLOW
23	OVERHEAD COILING DOOR OPERATOR AND MOTOR
31	OWNER PROVIDED STACKABLE WASHER & DRYER UNIT.
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33	NEW 2-HIGH BUNK STACK. REFER TO SPEC. 11.19.10
34	NEW 15"W x 18"D x 6-0"H LOCKER. REFER TO SPEC. #####
35	NEW 36"W x 12"D x 6-0"H (3) WIDE LOCKERS. REFER TO SPEC. #####
36	EXISTING 24"W x 24"D x 6-0"H LOCKER
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38	MANUFACTURED METAL 6 COMPARTMENT GUN LOCKER SURFACE MOUNTED
39	TRENCH DRAIN, SEE PLUMBING DRAWINGS
40	DETENTION VIDEO VISITATION STATION, CONTRACTOR TO PROVIDE ROUGH-INS. EQUIPMENT BY OWNER
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BID SET

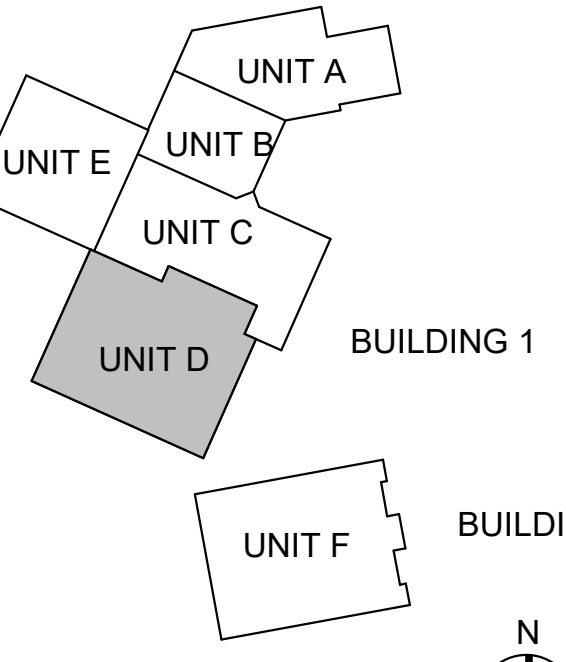KNOX COUNTY BOARD OF COMMISSIONERS

KNOX COUNTY JUSTICE CAMPUS

2375 OLD DECKER RD. VINCENNES, IN 47591

#	Revision	Date
1	Revision 1	Date 1

Project #: 20-700-151-2  
Designed By: LD  
Drawn By: WD  
Checked By: LD/IV  
Date: 01.28.2022


Eric Weflan

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FIRST FLOOR PLAN UNIT F

AF 2F1



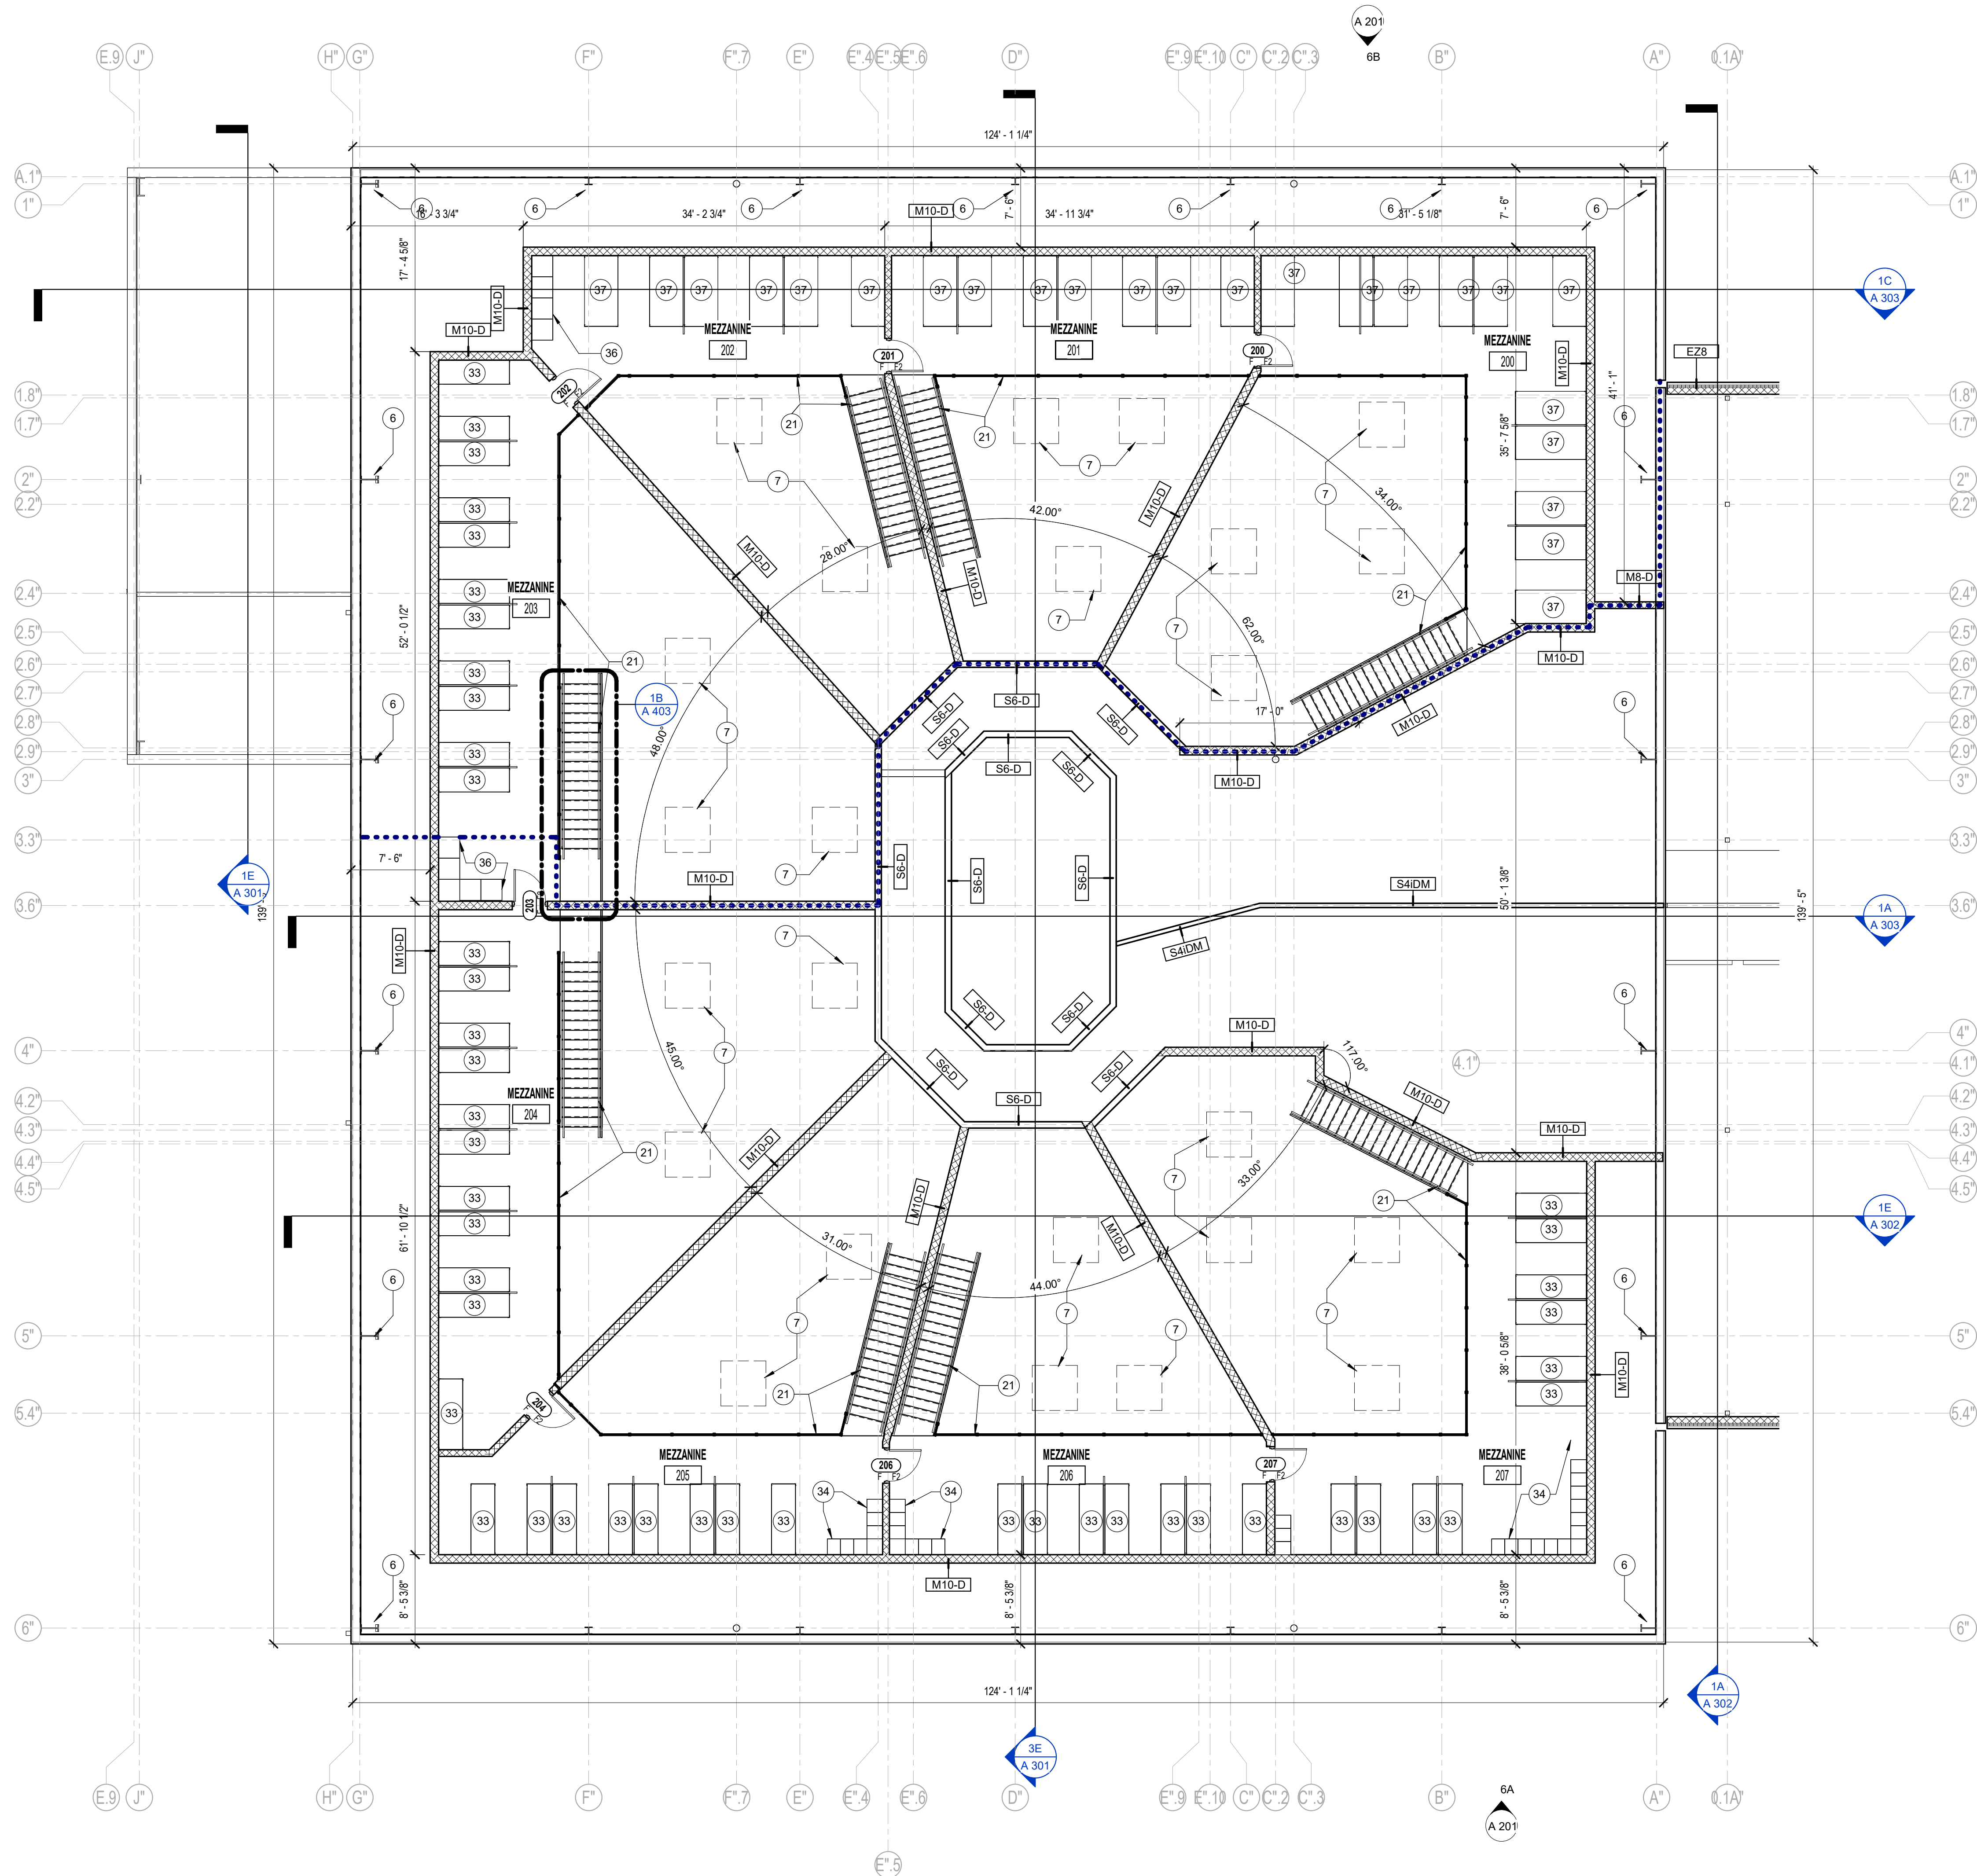

3A SECOND FLOOR PLAN - UNIT F  
1/8" = 1'-0"

5.4.110 - FLOOR PLAN NOTES


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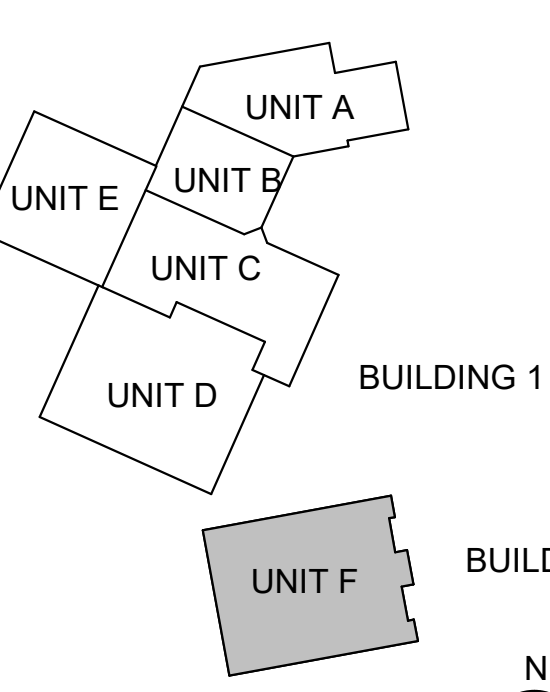
BID SET  
KNOX COUNTY BOARD OF COMMISSIONERS  
KNOX COUNTY JUSTICE CAMPUS  
2375 OLD DECKER RD. VINCENNES, IN 47591

#	Revision	Date
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Project #: 20-700-151-2  
Designed By: LD  
Drawn By: WD  
Checked By: LD/IEV  
Date: 01.28.2022



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SECOND FLOOR PLAN  
UNIT F

AF 2F2

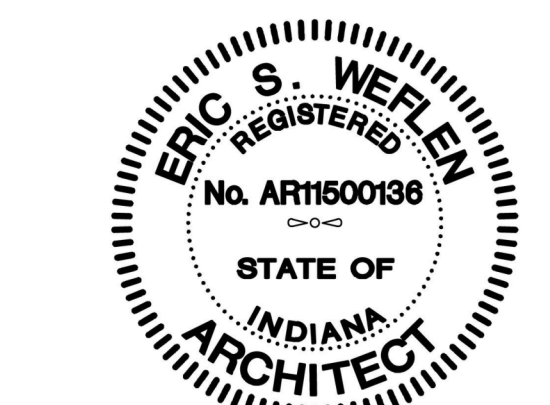




**RQAW**  
ARCHITECTURE

#	Revision	Date
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ERIC S. WEFLEN  
REGISTERED  
No. AR1500136  
STATE OF  
INDIANA  
ARCHITECT

AF ALT A1



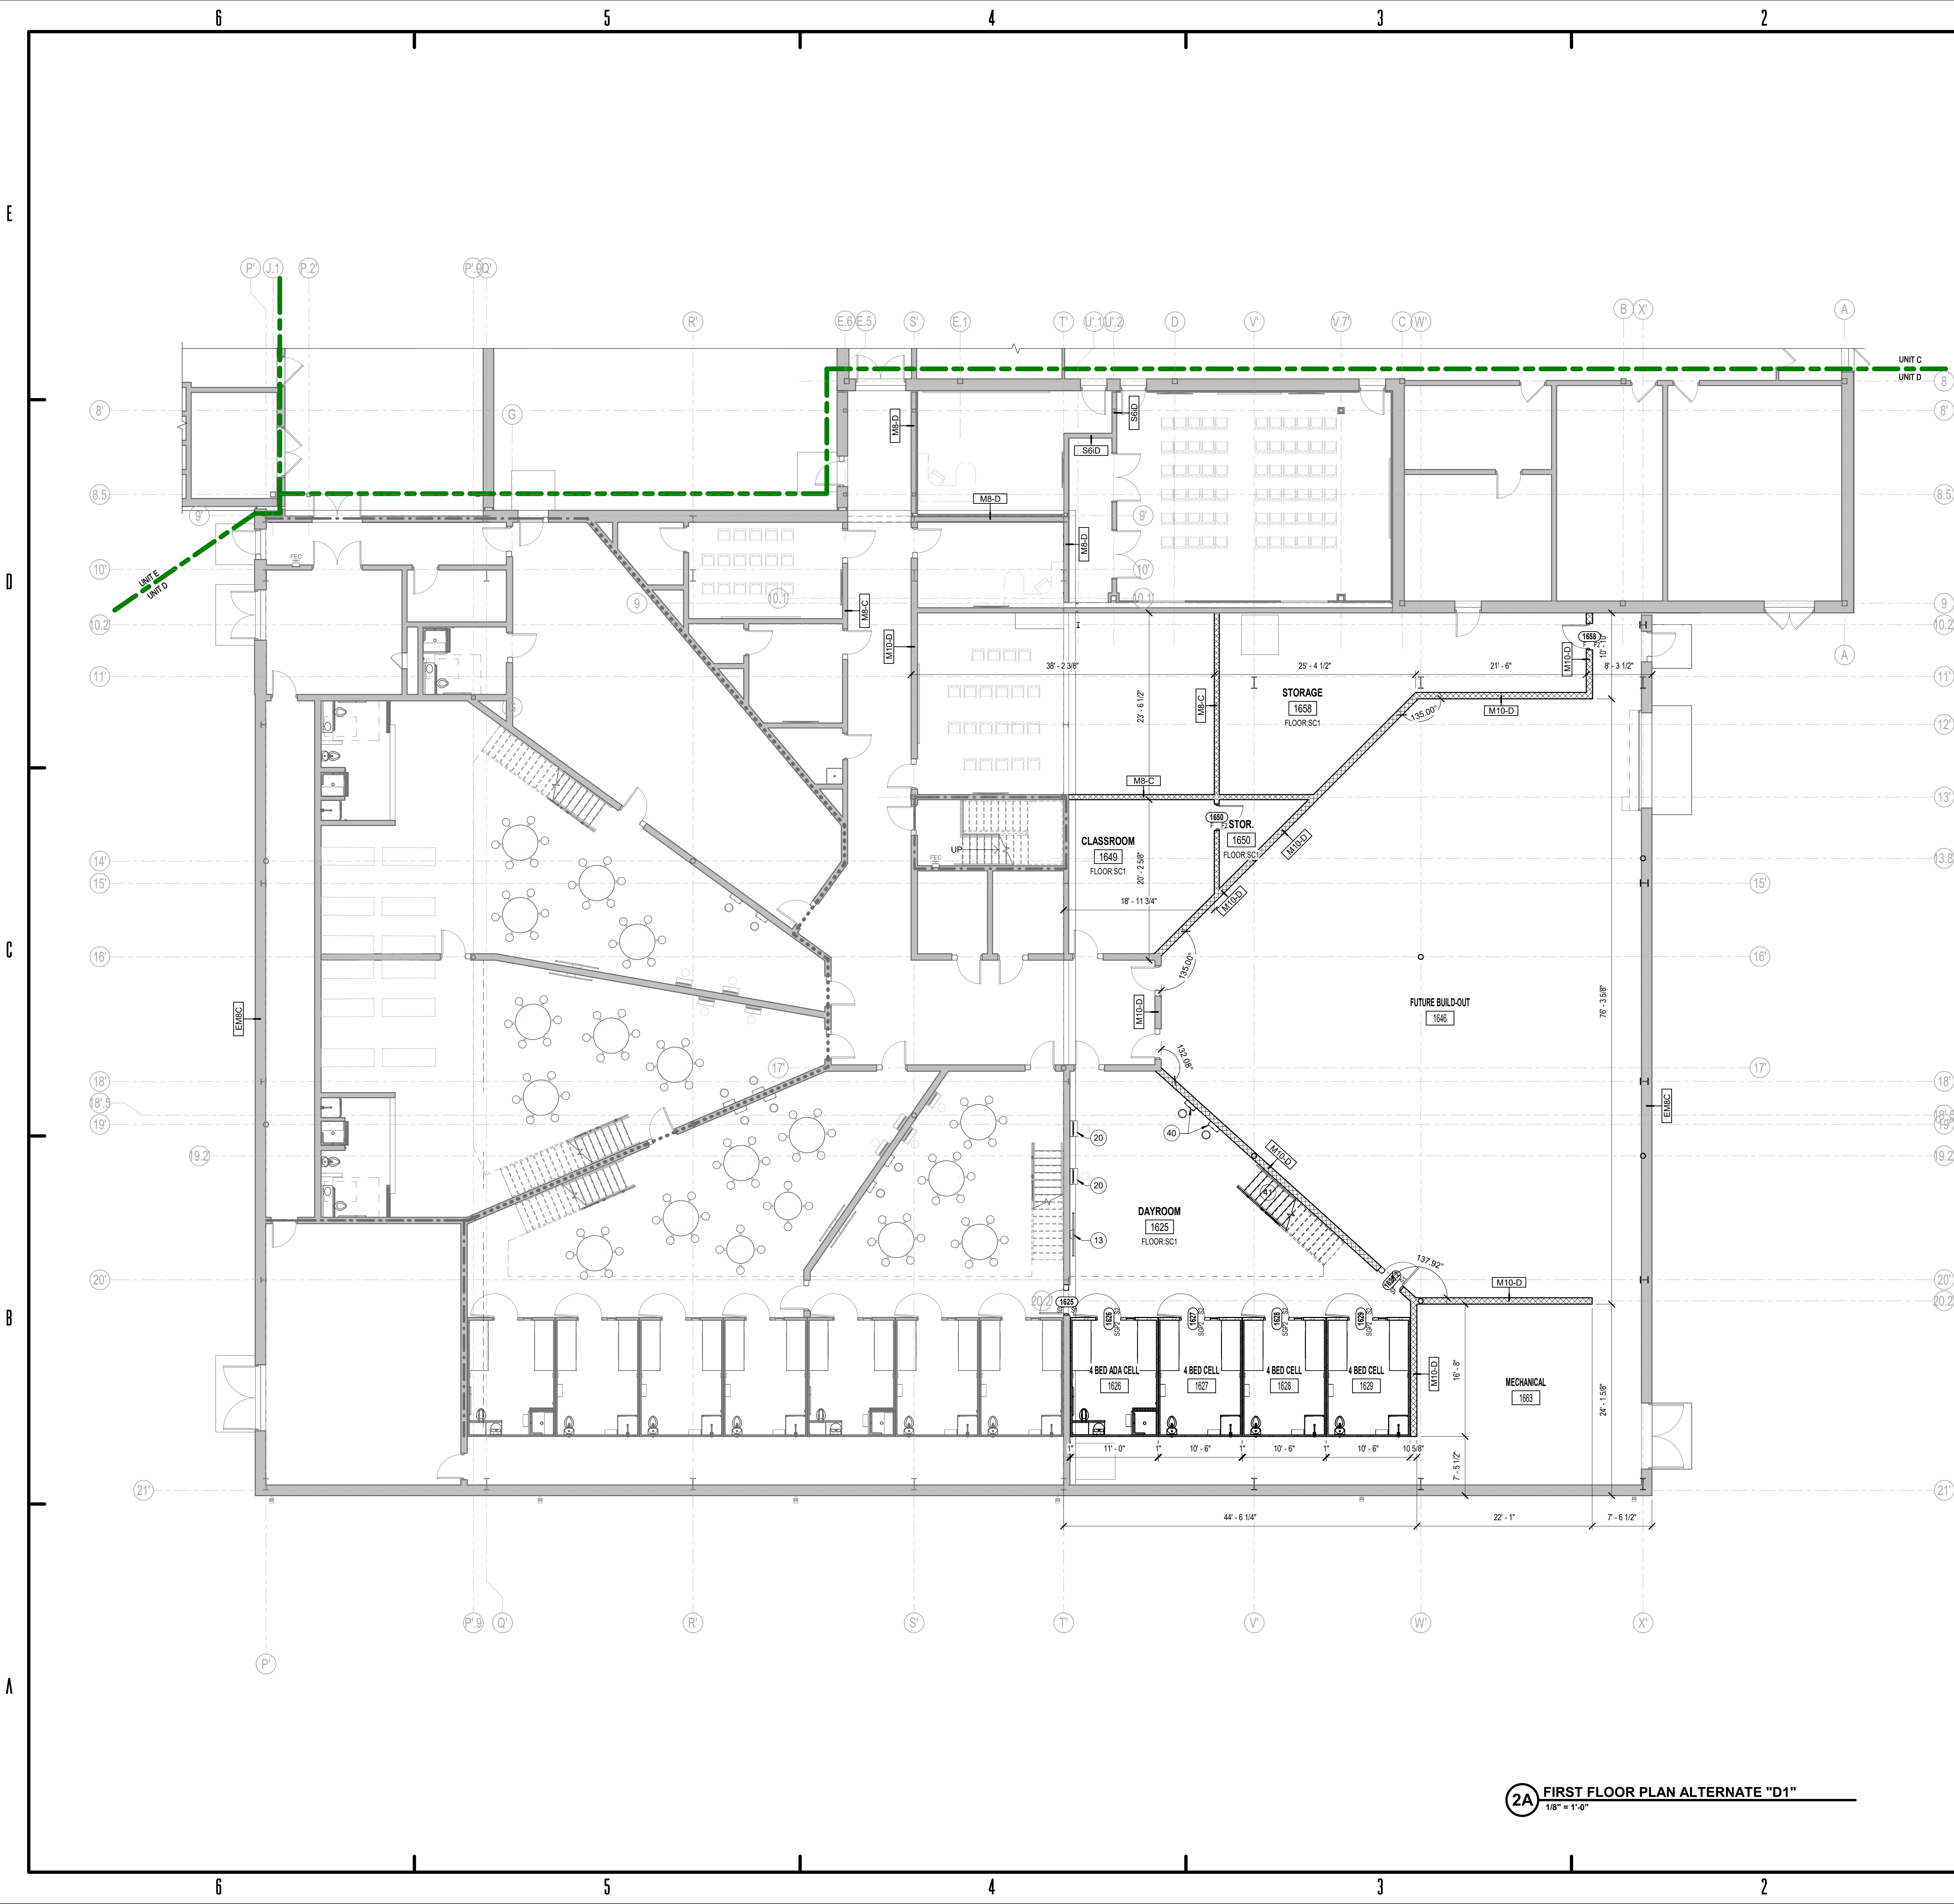

5.4.110 - FLOOR PLAN NOTES	
Key	Note
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KNOX COUNTY BOARD OF COMMISSIONERS

KNOX COUNTY JUSTICE CAMPUS

2375 OLD DECKER RD. VINCENNES, IN 47591

#	Revision	Date
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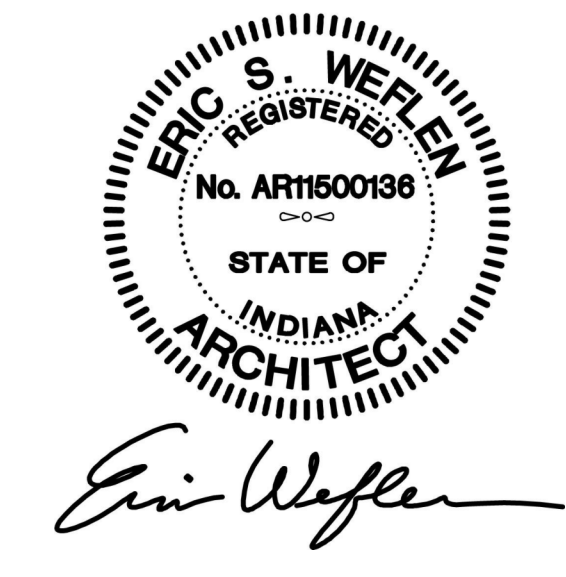
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Designed By: LD/SP


Drawn By: JW

Checked By: LD/EV

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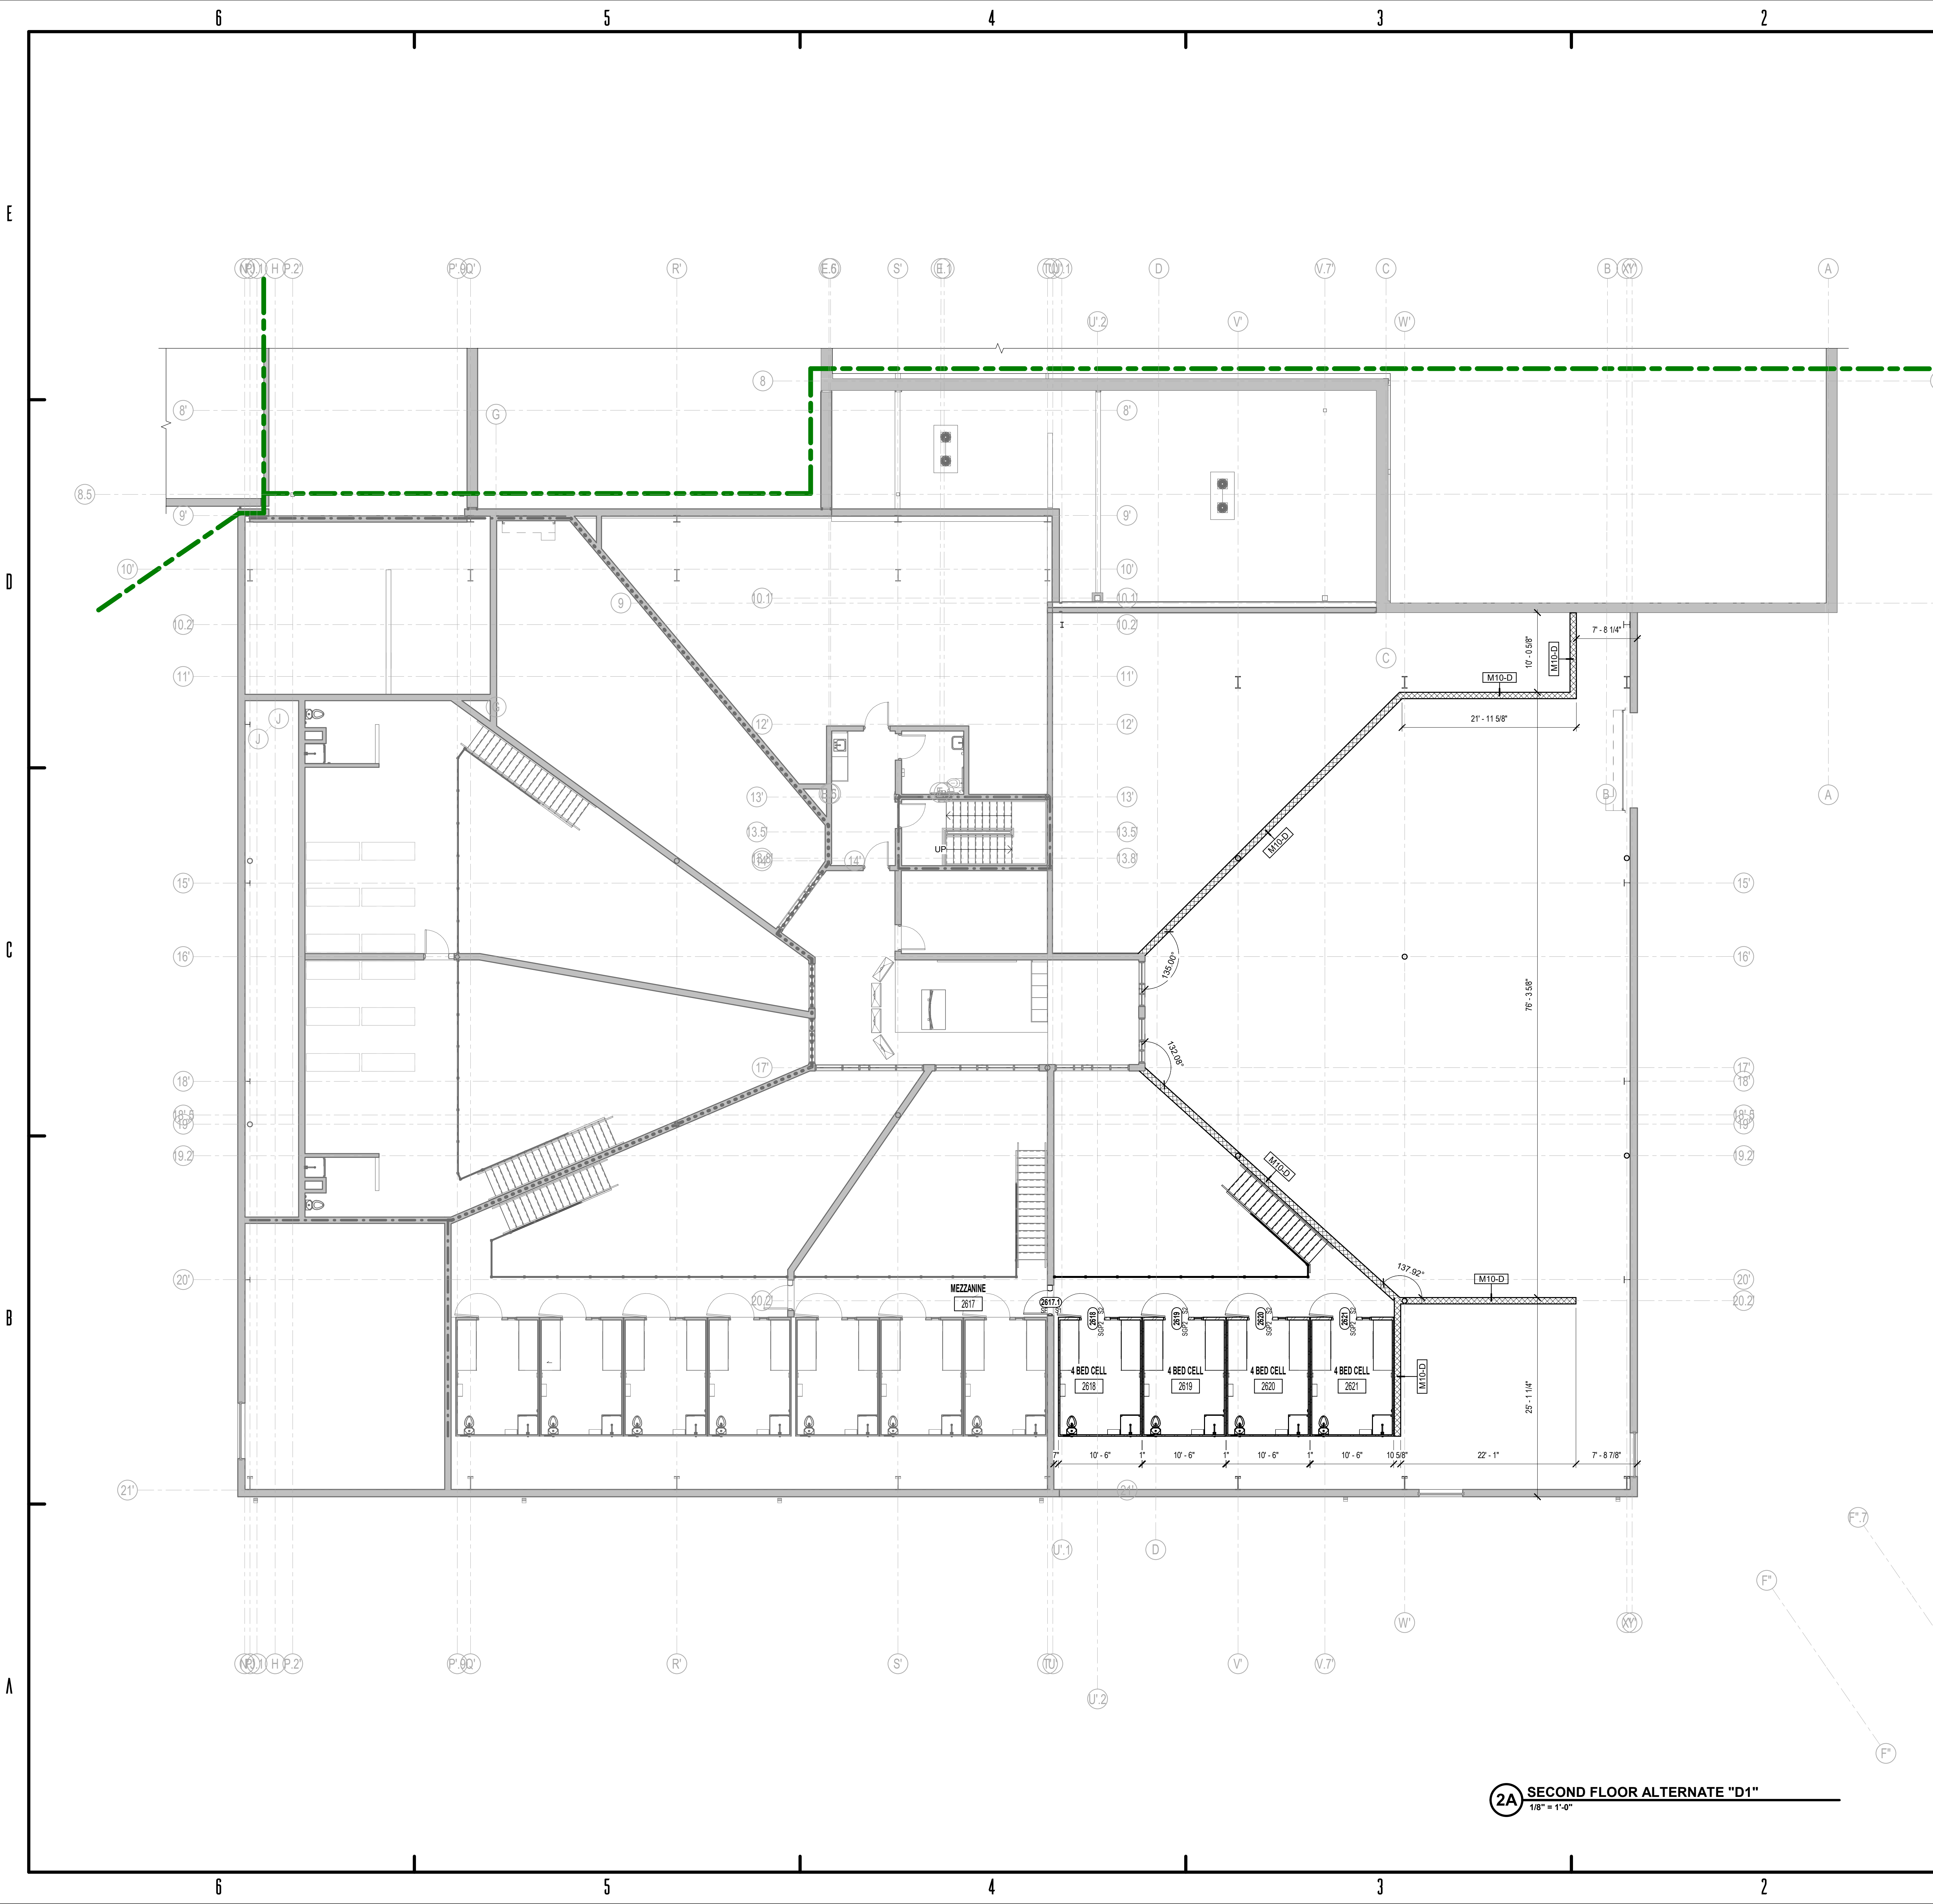


FIRST FLOOR PLAN  
ALTERNATE "D1"

AF ALT D1-1

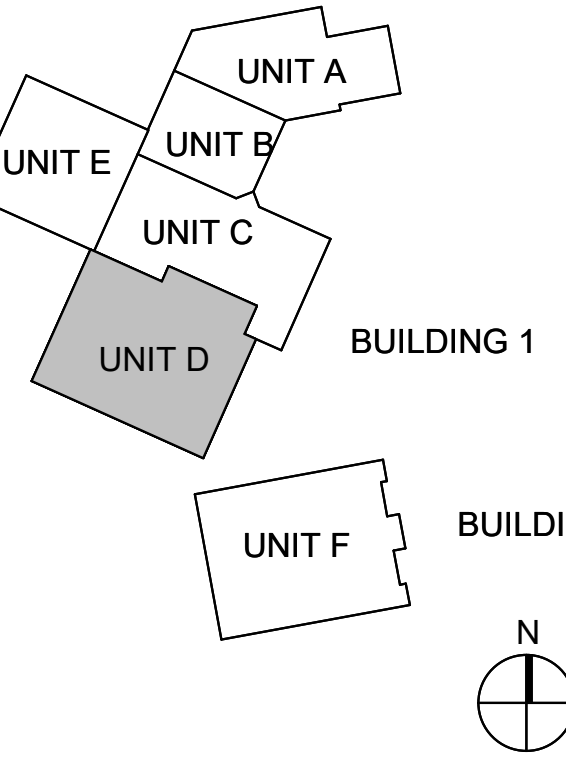2A FIRST FLOOR PLAN ALTERNATE "D1"  
1/8" = 1'-0"





5.4.110 - FLOOR PLAN NOTES	
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BID SET

KNOX COUNTY BOARD OF COMMISSIONERS

KNOX COUNTY JUSTICE CAMPUS

2375 OLD DECKER RD. VINCENNES, IN 47591

#	Revision	Date
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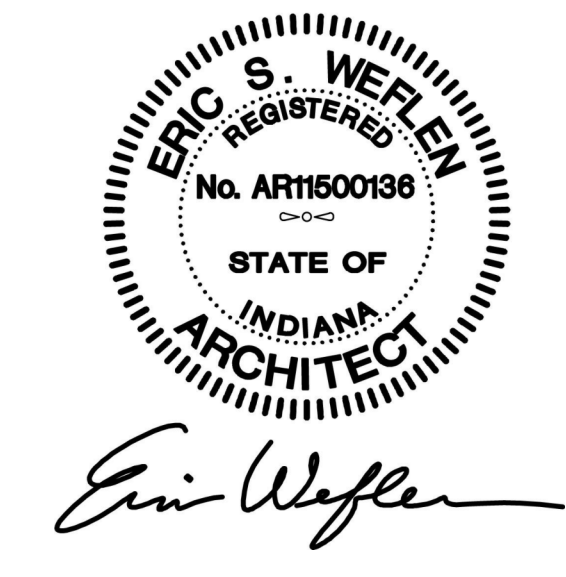
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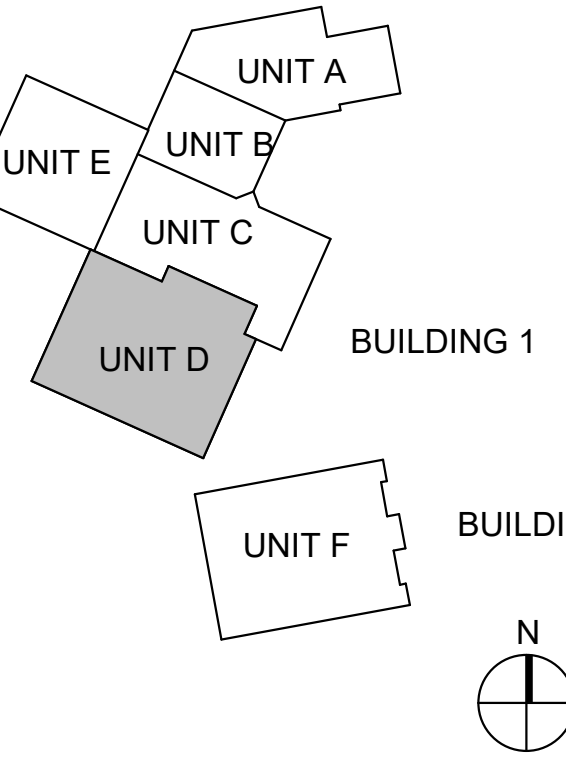
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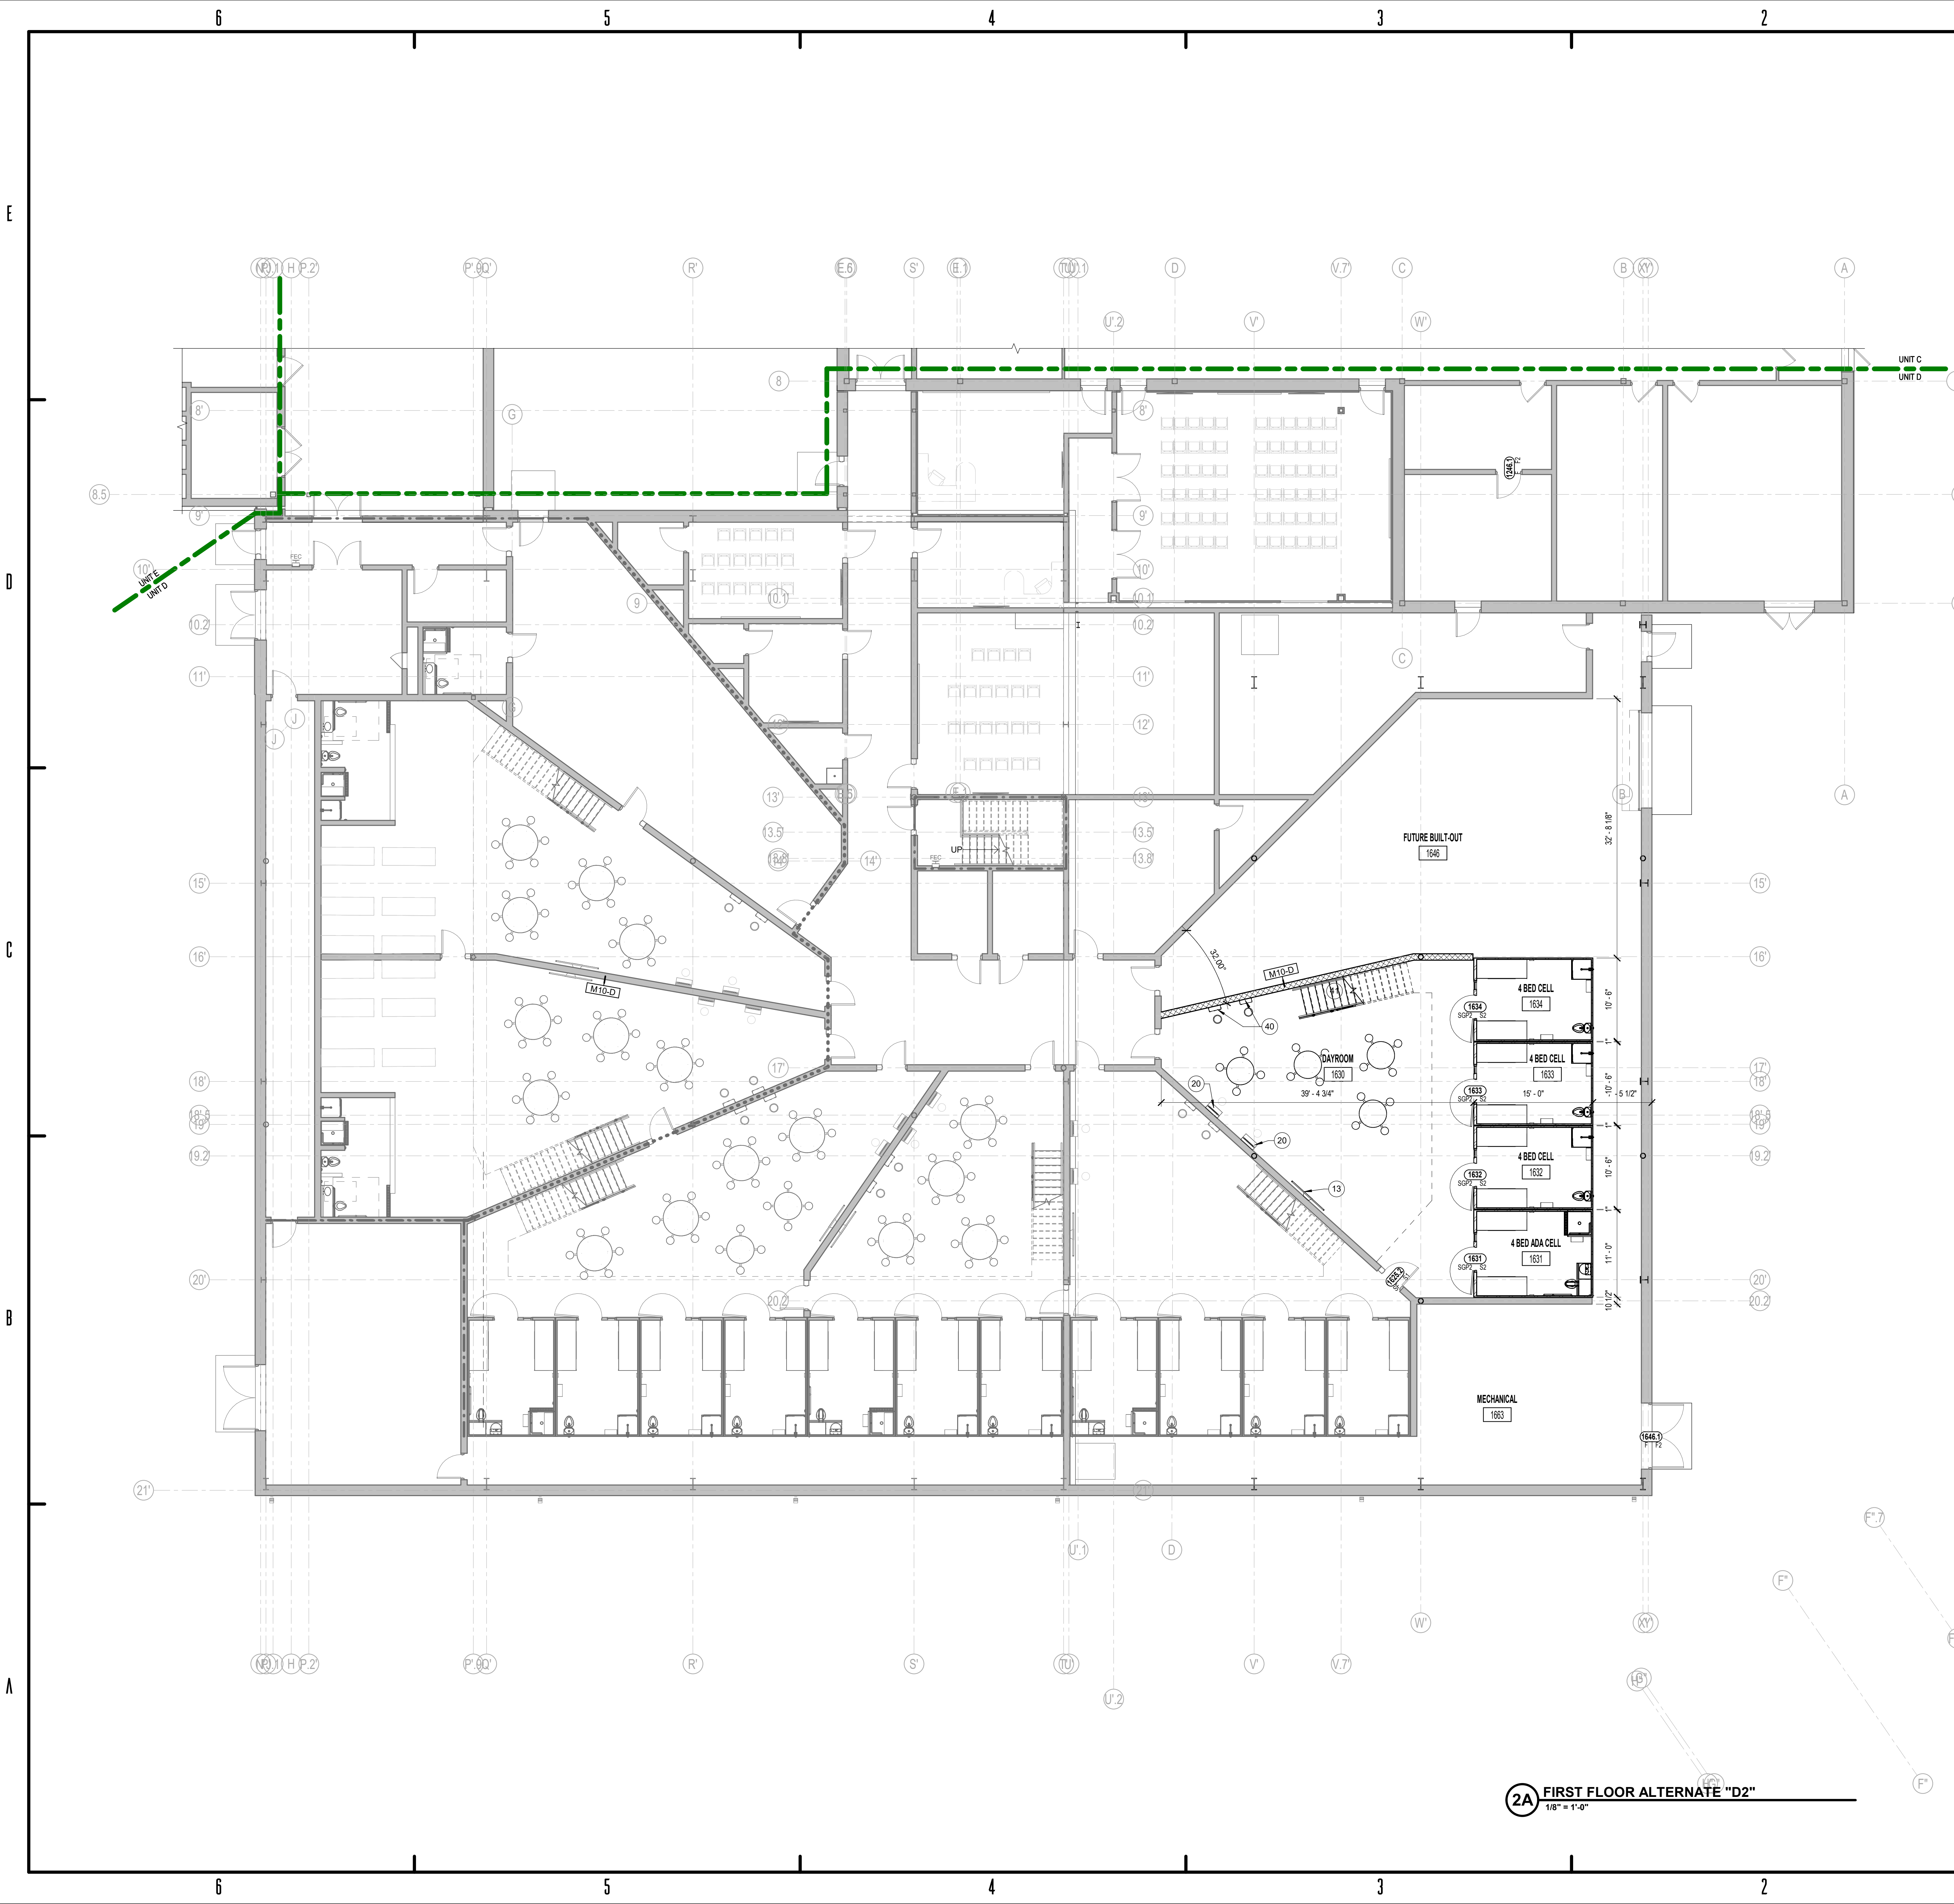
SECOND FLOOR  
ALTERNATE "D1"

AF ALT D1-2

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5.4.110 - FLOOR PLAN NOTES	
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RQAW

ARCHITECTURE

BID SET

KNOX COUNTY BOARD OF COMMISSIONERS

KNOX COUNTY JUSTICE CAMPUS

2375 OLD DECKER RD. VINCENNES, IN 47591

#	Revision	Date

Project # 20-700-151-2

Designed By: LD/SP

Drawn By: JW

Checked By: LD/IV

Date: 01.28.2022

ERIC S. WELLEN

REGISTERED

No. AR1500196

STATE OF INDIANA

ARCHITECT

*Eric Wellen*

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UNIT A

UNIT B

UNIT C

UNIT D

UNIT E

UNIT F

BUILDING 1


BUILDING 2

N

FIRST FLOOR ALTERNATE "D2"

AF ALT D2-1



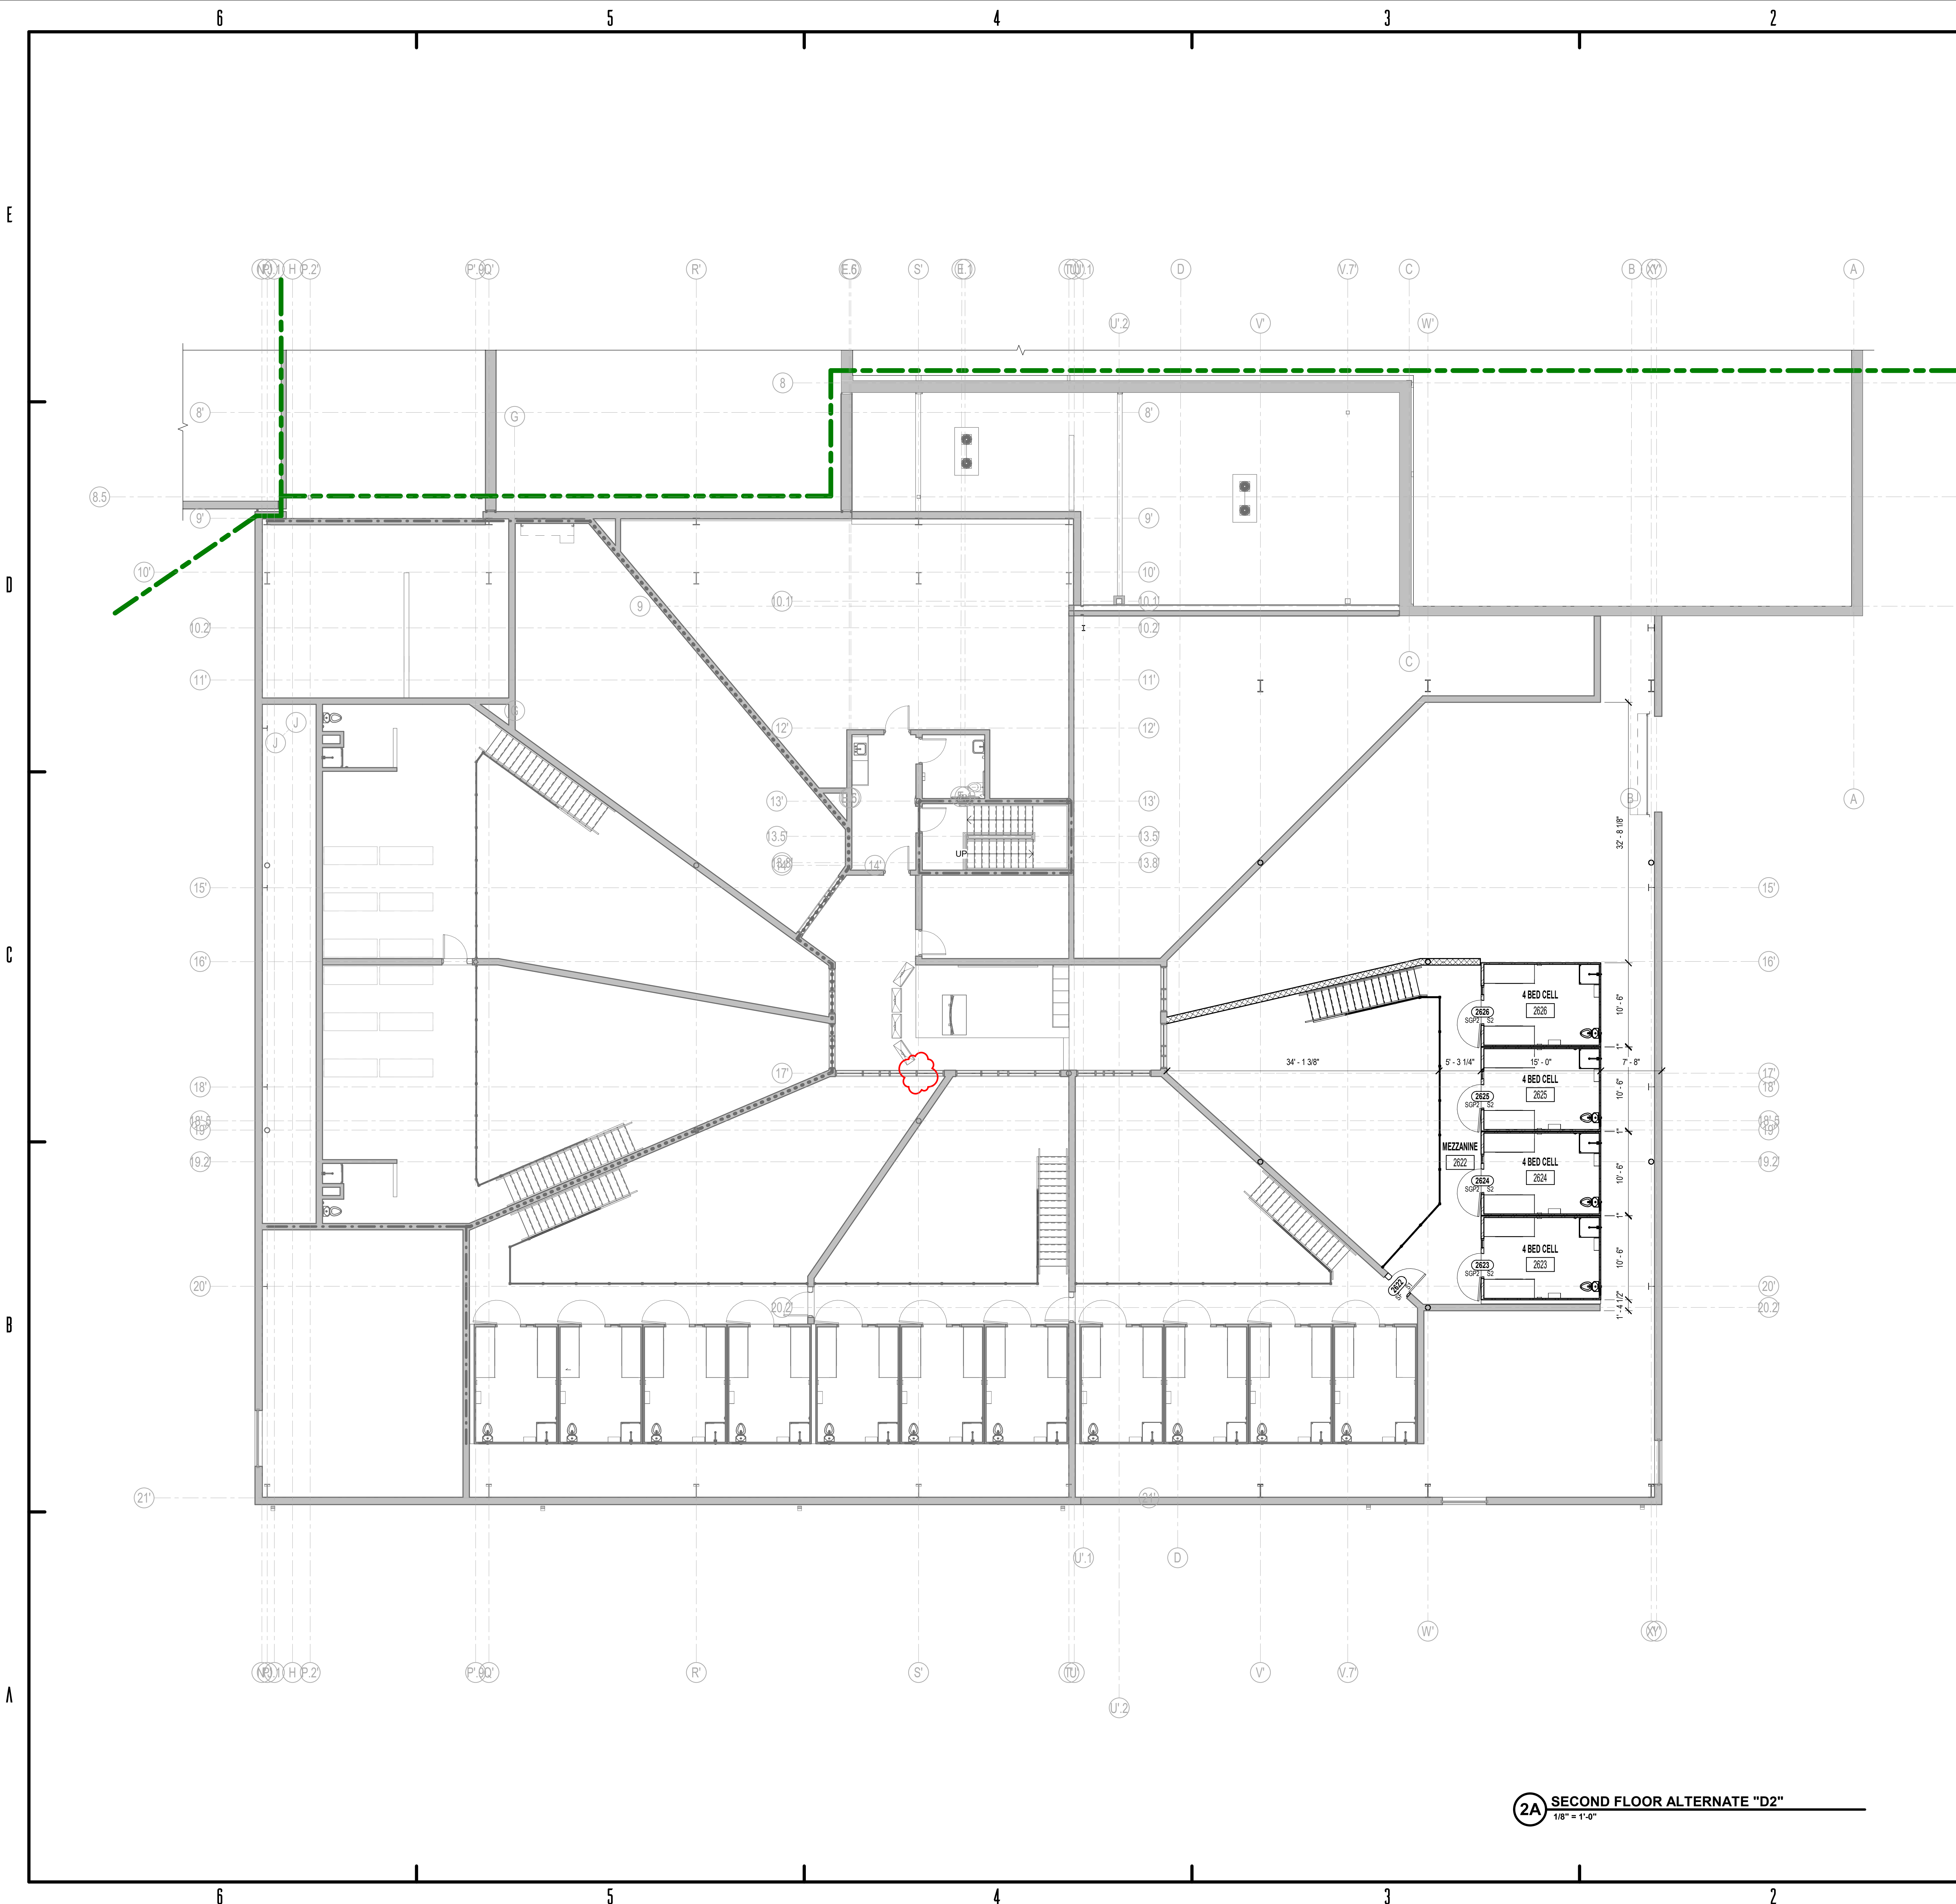

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4	MANUFACTURED SIX COMPARTMENT GUN LOCKER
5	INFILL EXISTING OPENING WITH NEW WALL ASSEMBLY TO MATCH EXISTING. TOOTH IN NEW CMU INTO EXISTING.
6	EXPOSED STRUCTURAL STEEL TO BE PRIMED AND PAINTED
7	LINE OF OVERHEAD SKYLIGHT, SEE CEILING AND ROOF PLANS FOR SCOPE
8	HALF HEIGHT WALL, PROVIDE DOUBLE BULLNOSE CORNER UNIT ON TOP
9	CONCRETE BENCH SEE DETAIL ICA 500
10	BUILT IN CASEWORK AND COUNTERTOP, SEE INTERIOR DRAWINGS FOR SCOPE AND MATERIAL
11	BOOK IN COUNTER BUILT-IN SEE A-401 FOR DETAILS
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13	FLAT SCREEN TV MOUNTING BRACKET @ 6'-0" A.F.F.
14	OWNER PROVIDED MARKER BOARD
15	FLOOR DRAIN, REFERENCE PLUMBING DRAWINGS
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21	WOVEN WIRE SECURITY SCREEN AND FRAME. PREFINISHED AS SELECTED BY ARCHITECT
22	6" STEEL SOLLARD, CONCRETE FILLED. TO BE PRIMED AND PAINTED SAFETY YELLOW
23	OVERHEAD COILING DOOR OPERATOR AND MOTOR
37	OWNER PROVIDED STACKABLE WASHER & DRYER UNIT.
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35	NEW 36"W x 12"D x 6" H (S) WIDE LOCKERS. REFER TO SPEC. #####
36	EXISTING 24"W x 24"D x 6" H LOCKER
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BID SET

KNOX COUNTY BOARD OF COMMISSIONERS

KNOX COUNTY JUSTICE CAMPUS

2375 OLD DECKER RD. VINCENNES, IN 47591

#	Revision	Date
1	Revision 1	Date 1

Project # 20-700-151-2

Designed By: LD/SP

Drawn By: JW

Checked By: LD/EV


Date: 01.28.2022

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SECOND FLOOR  
ALTERNATE "D2"

AF ALT D2-2



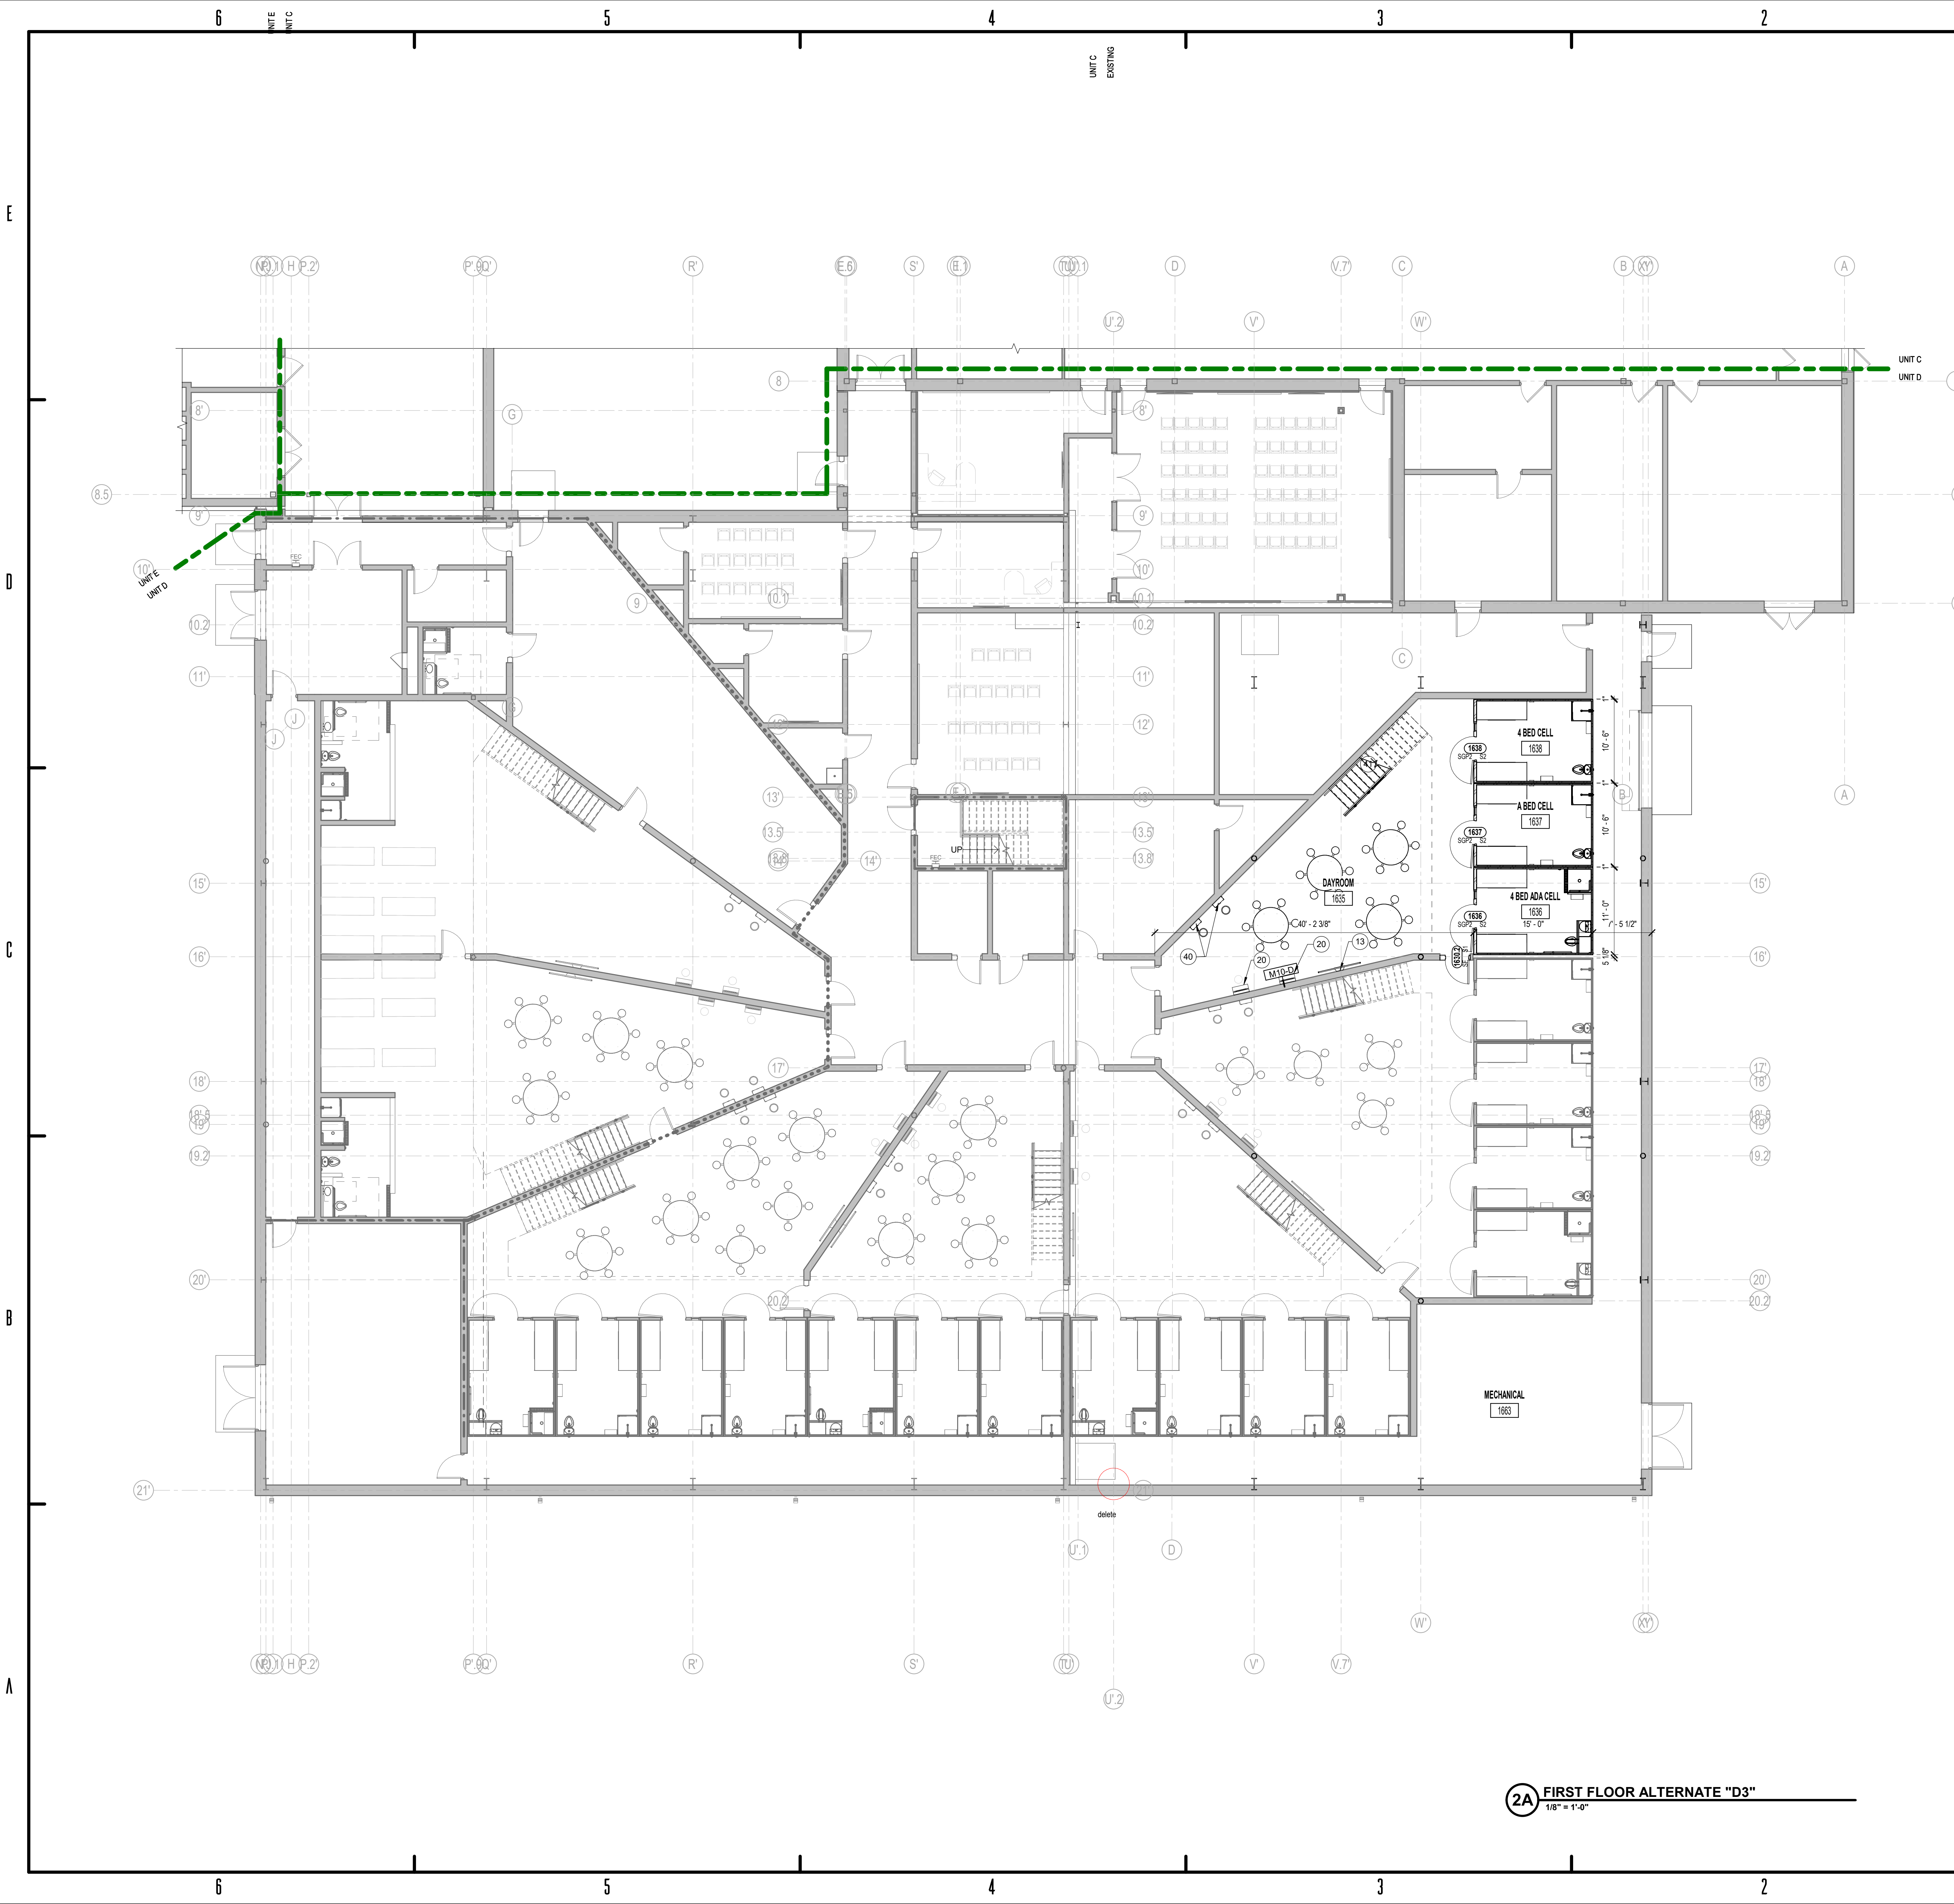

5.4.110 - FLOOR PLAN NOTES	
Key	Note
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RQAW

ARCHITECTURE

BID SET

KNOX COUNTY BOARD OF COMMISSIONERS

KNOX COUNTY JUSTICE CAMPUS

2375 OLD DECKER RD. VINCENNES, IN 47591

#	Revision	Date

Project # 20-700-151-2

Designed By: LD/SP

Drawn By: JW

Checked By: LD/IEV

Date: 01.28.2022

ERIC S. WELLEN

REGISTERED

No. AR1500196

STATE OF INDIANA

ARCHITECT

*Eric Wellen*

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UNIT A

UNIT B

UNIT C

UNIT D

UNIT E

UNIT F

BUILDING 1

BUILDING 2

N

FIRST FLOOR ALTERNATE "D3"

AF ALT D3-1





**BID SET**

**KNOX COUNTY BOARD OF COMMISSIONERS**

**KNOX COUNTY JUSTICE CAMPUS**

2375 OLD DECKER RD., VINCENNES, IN 47591

Project #: 20-700-151-2

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Designed By: LD/SP

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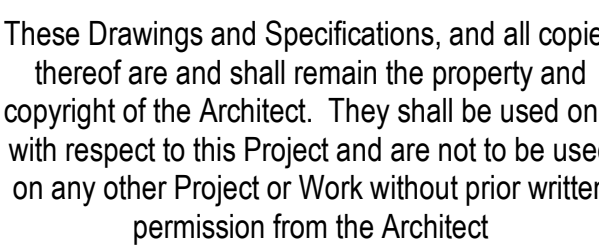
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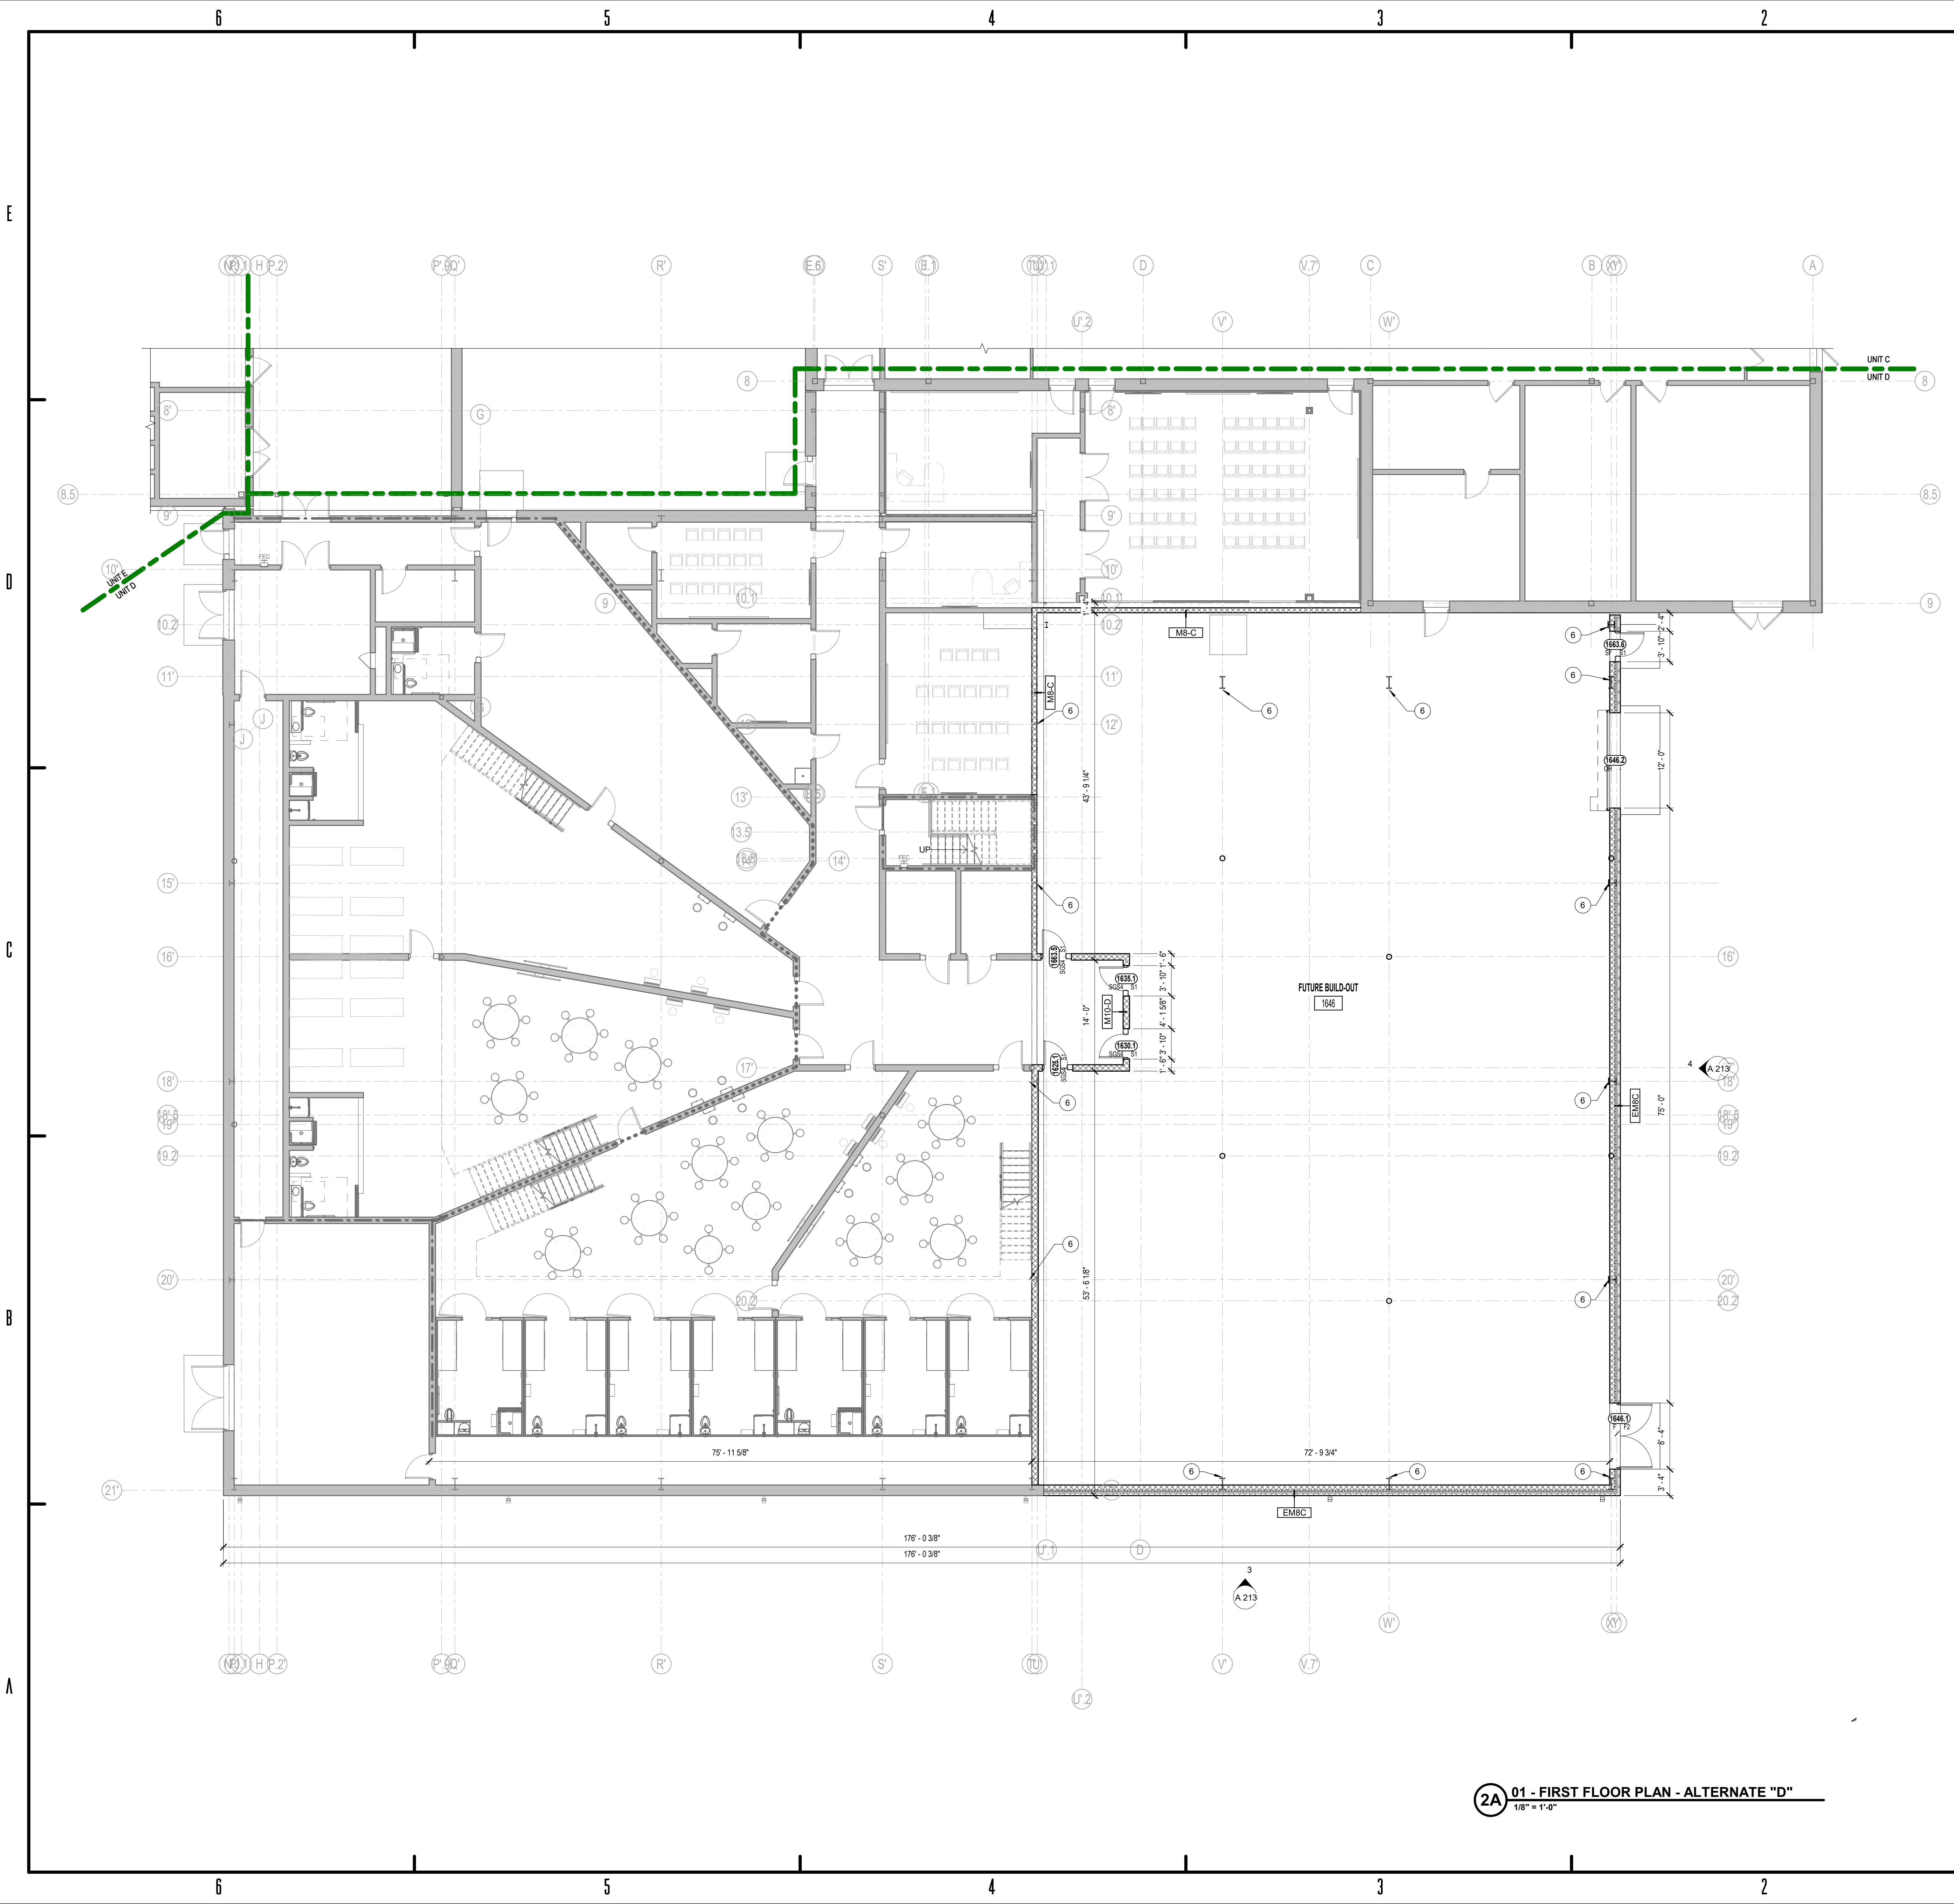
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AF ALT D3-2





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KNOX COUNTY JUSTICE CAMPUS

2375 OLD DECKER RD. VINCENNES, IN 47591

#	Revision	Date
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Project # 20-700-151-2

Designed By: LD/SP

Drawn By: JW

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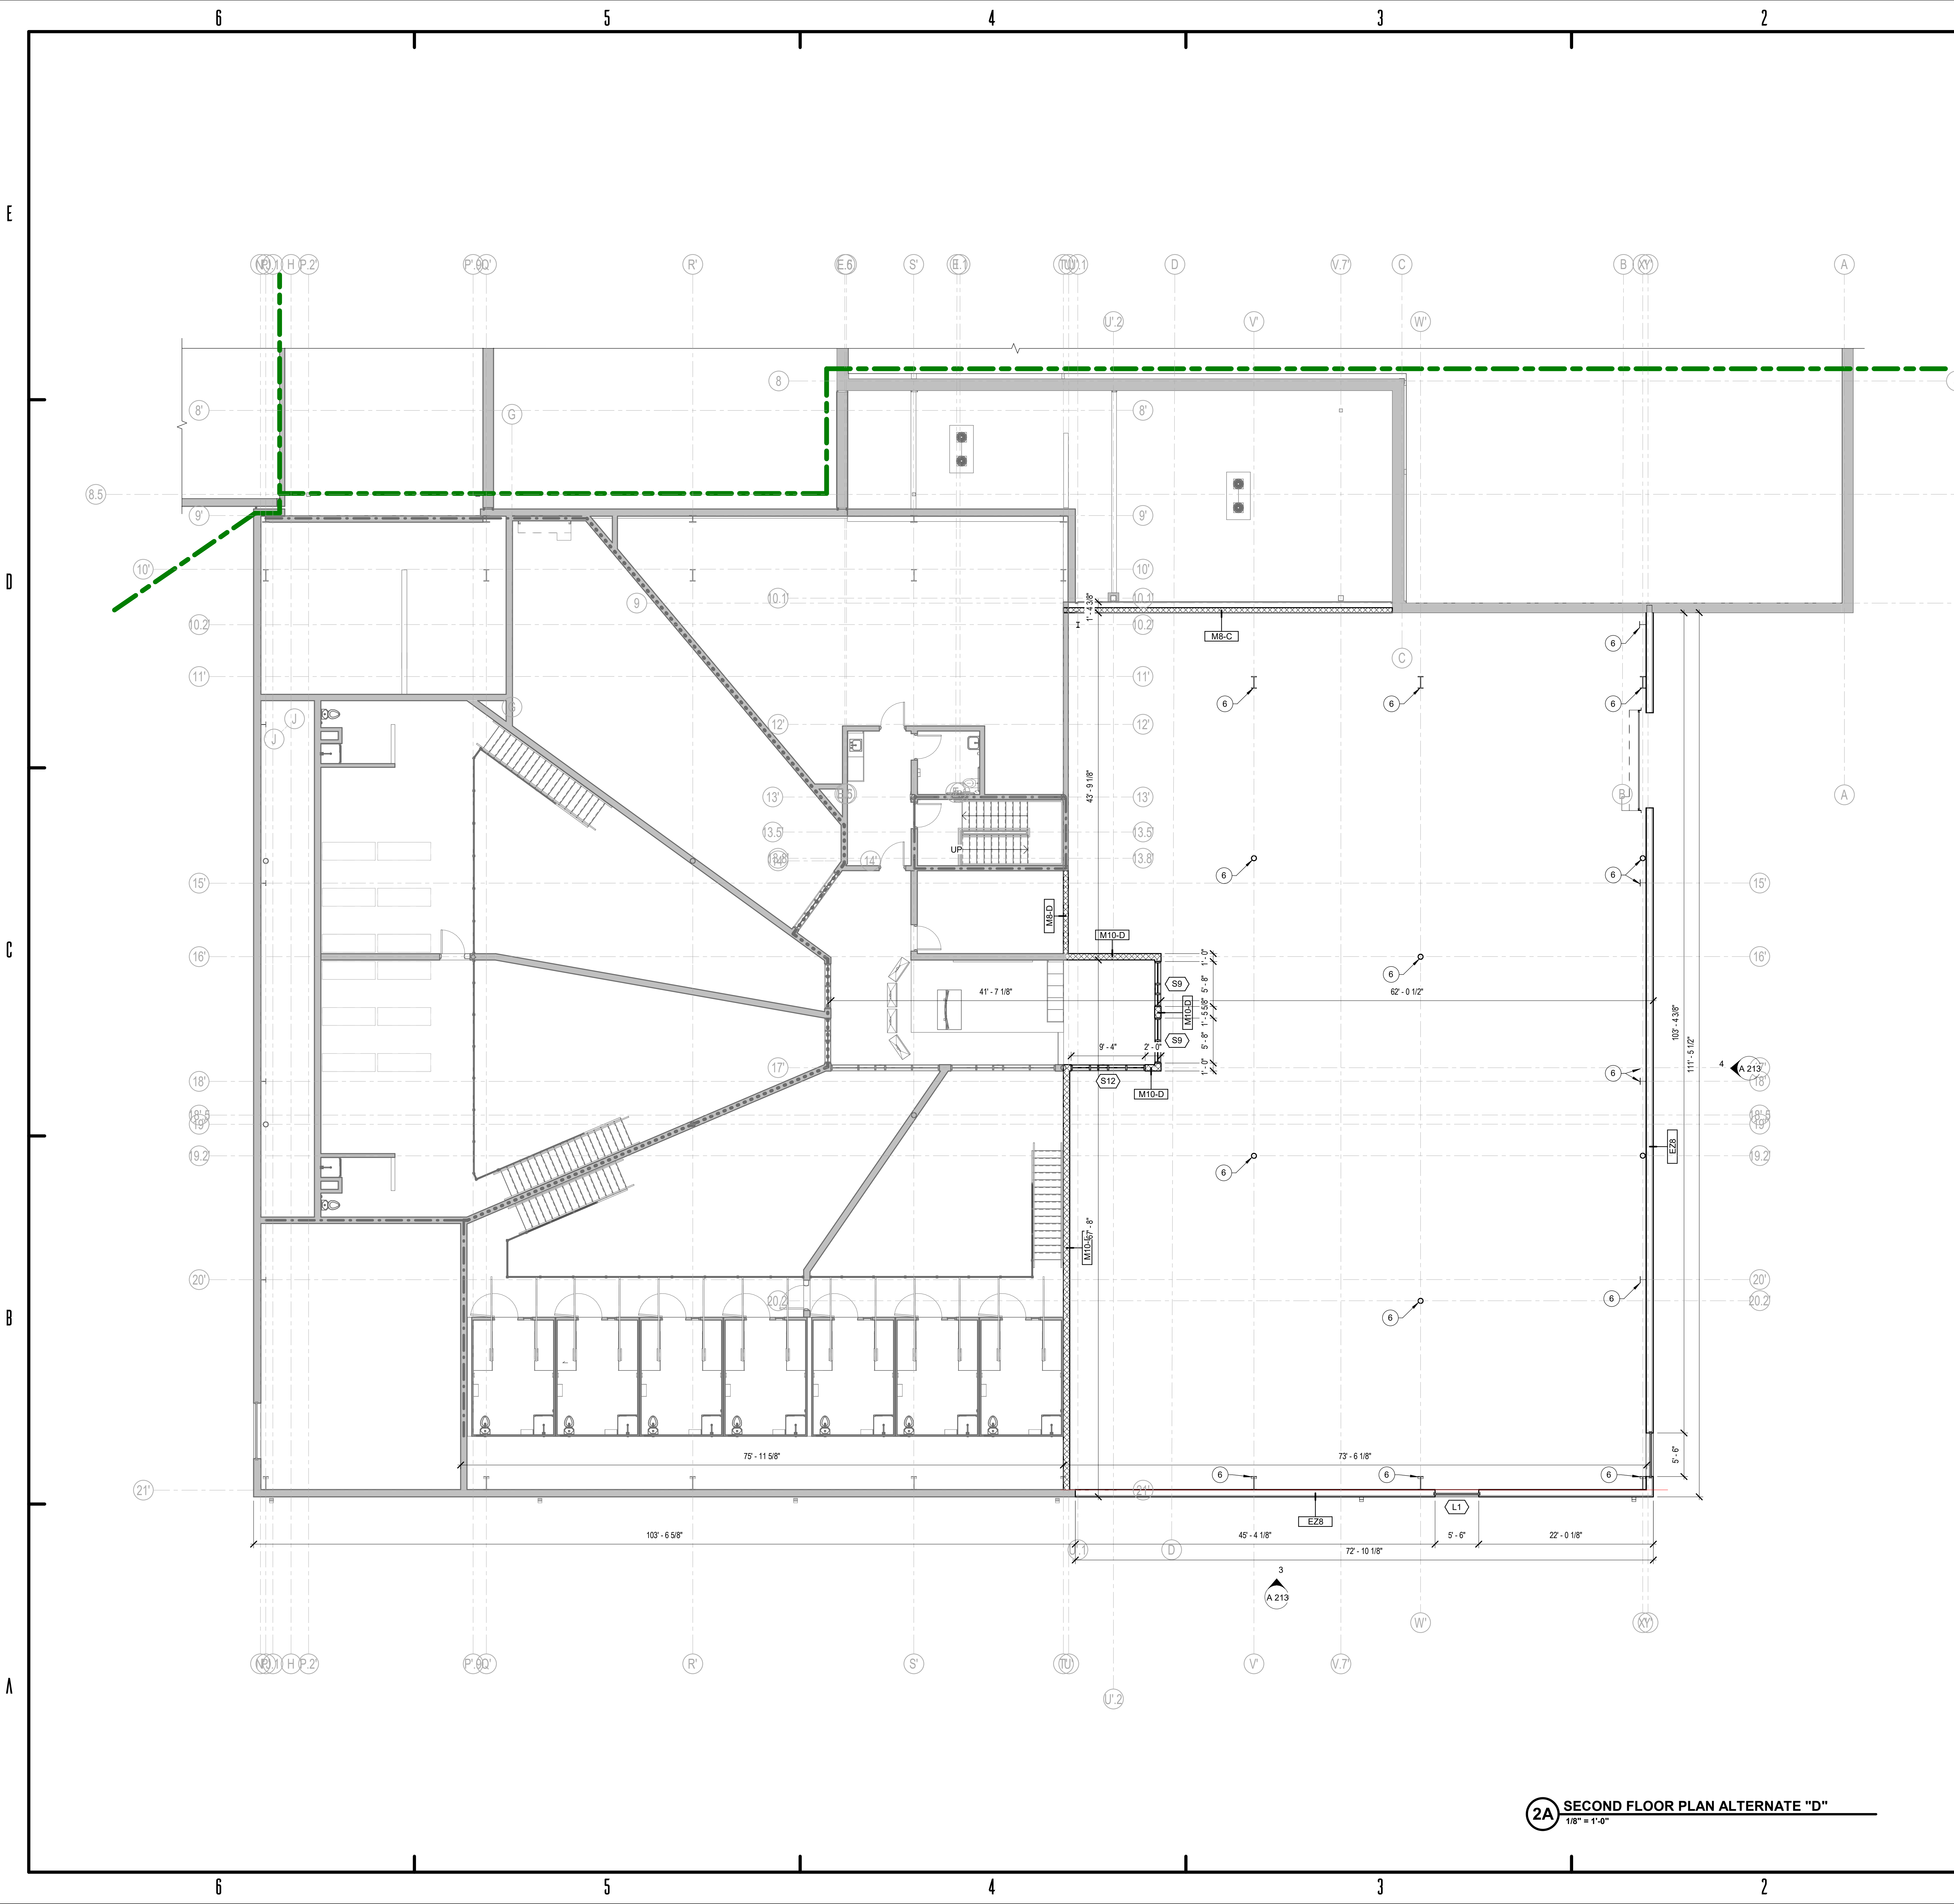
FIRST FLOOR PLAN

ALTERNATE "D"

AF ALT D-1

2A 01 - FIRST FLOOR PLAN - ALTERNATE "D"  
1/8" = 1'-0"





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BID SET

KNOX COUNTY BOARD OF COMMISSIONERS

KNOX COUNTY JUSTICE CAMPUS

2375 OLD DECKER RD. VINCENNES, IN 47591

#	Revision	Date
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Project # 20-700-151-2

Designed By: LD/SP

Drawn By: JW

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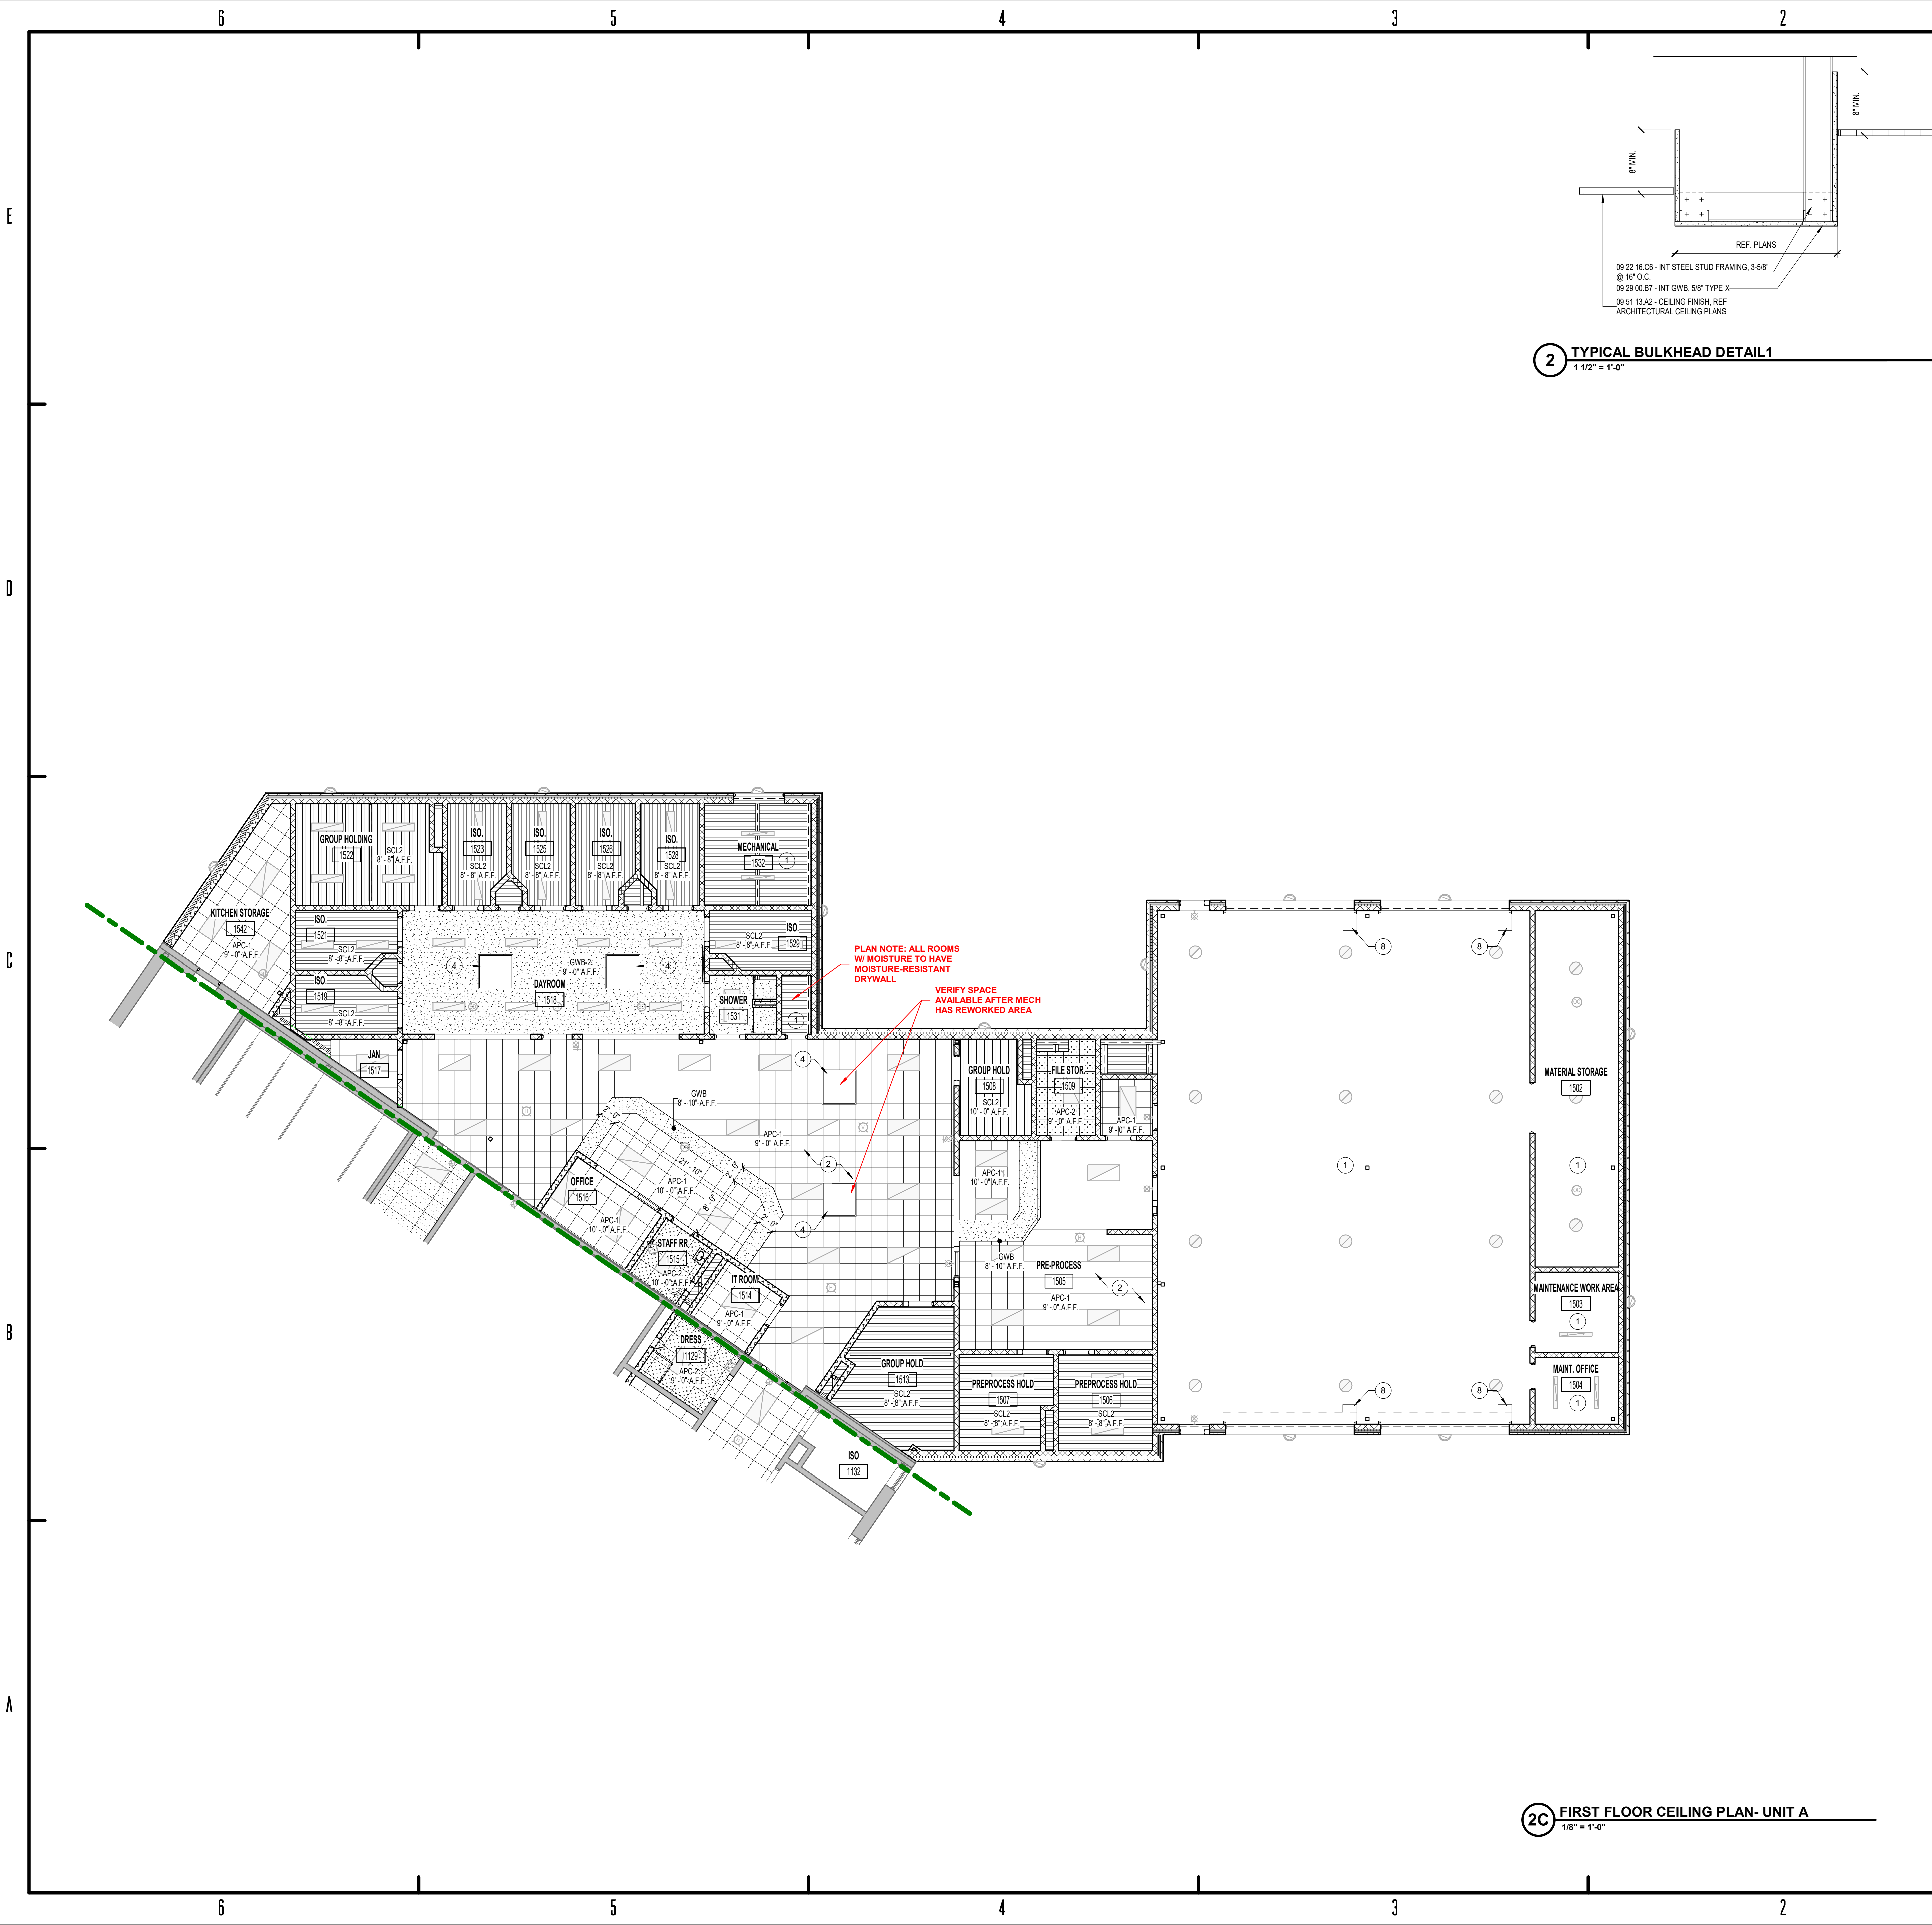
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SECOND FLOOR PLAN  
ALTERNATE "D"

AF ALT D-2

2A SECOND FLOOR PLAN ALTERNATE "D"  
1/8" = 1'-0"





REFL. CEILING PLAN NOTES

1. All grids are centered in rooms, unless noted otherwise.
2. Coordinate bulkhead sizes w/ mechanical ductwork.
3. Refer to MEP drawings for ceiling fixtures/equipment and coordinate w/ all trades.
4. All exposed ductwork, piping etc. shall be painted. Color selected by Architect.
5. Locate sprinkler heads in center of ceiling panel - where applicable.
6. All ceilings are at 9'-0" AFF, unless noted otherwise.
7. All bulkheads are at 8'-10" AFF, unless noted otherwise.
8. All new grid shall be APC-1 unless noted otherwise

5.4.120 - CEILING PLAN NOTES

Key	Note
1	OPEN TO STRUCTURE
2	RETENTION CLIPS, 2 PER EACH CEILING TILE
3	EXISTING CEILING TO REMAIN
4	SKYLIGHT WITH SECURITY BARS, DUCTED SHAFT (INTERIOR TO BE PAINTED)
5	POLYCARBONATE LENS AT CEILING LEVEL. SEE ROOF PLAN FOR SKYLIGHT SIZE, FINAL SKYLIGHT LOCATION TO ADJUST AS REQUIRED TO COORDINATE WITH STRUCTURAL AND MEP SYSTEMS
6	18 IN CEILING MOUNTED DOMED MIRROR
7	PROVIDE A 5-1/4" SLAB ON TOP OF CELLULAR METAL DECK TO ACHIEVE 1-HR RATED LID ASSEMBLY
8	OVERHEAD COILING DOOR ASSEMBLY WITH ELECTRICALLY MOTORIZED OPERATOR
9	CEILING MOUNTED 42" MONITORS. FINAL INSTALLATION TO BE COORDINATED WITH CONTROL STATION INSTALLATION

REFLECTED CEILING PLAN LEGEND

APC-1	2' x 2' Acoustical Panel Ceiling (09 51 13)	Light Fixture (Reference E-Series Dwgs)	Emergency Light Fixture (Reference E-Series Dwgs)
APC-2	2' x 2' Washable Acoustical Panel Ceiling (09 51 13)	Return Air (Reference M-Series Dwgs)	
APC-3	2' x 2' High Humidity Ceiling Panel with Aluminum Grid	Supply Air (Reference M-Series Dwgs)	
APC-4	2' x 2' Special NRC (0.7 min.) Ceiling Panel with Aluminum Grid	Exit Light (Reference E-Series Dwgs)	
APC-5	2' x 4' Washable Acoustical Panel Ceiling (09 51 13)		
SCL1	2' x 2' Security metal lay-in with hold down clips	Recessed Light Fixture Suspended Fixture in Areas with Exposed Ceilings (Reference E-Series Dwgs)	
SCL2	Cellular Metal Deck, see Structural	SOUND SYSTEM SPEAKER (REFERENCE E-SERIES/T-SERIES DWGS)	
SCL3	Concrete Slab on Cellular Metal Deck, total depth of 5-1/4" Cap to achieve 1-HR rating, see Structural	Walls to Deck	
GWB	Gypsum Wall Board, 5/8" on 3-5/8" Metal Stud (09 29 00)	PLASTER	Plaster on metal wire mesh lathe on 3-5/8" metal stud
GWB-2	5/8" High-Impact drywall on metal wire mesh lathe on 3-5/8" metal stud	MTL	1/4" Steel Plate on engineered framing



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KNOX COUNTY BOARD OF COMMISSIONERS  
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2375 OLD DECKER RD. VINCENNES, IN 47591


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Project #: 20-700-151-2  
Designed By: LD/SP  
Drawn By: CW  
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Eric Wepler


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FIRST FLOOR CEILING PLAN UNIT A

AC 1A1



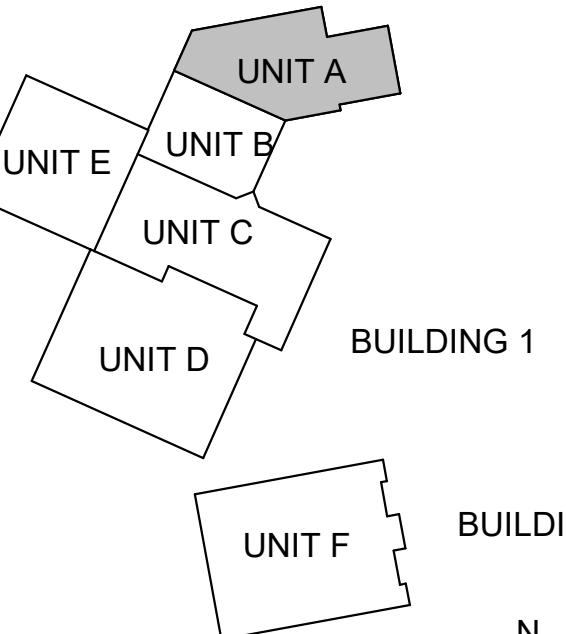

2C FIRST FLOOR CEILING PLAN- UNIT B  
1/8" = 1'-0"
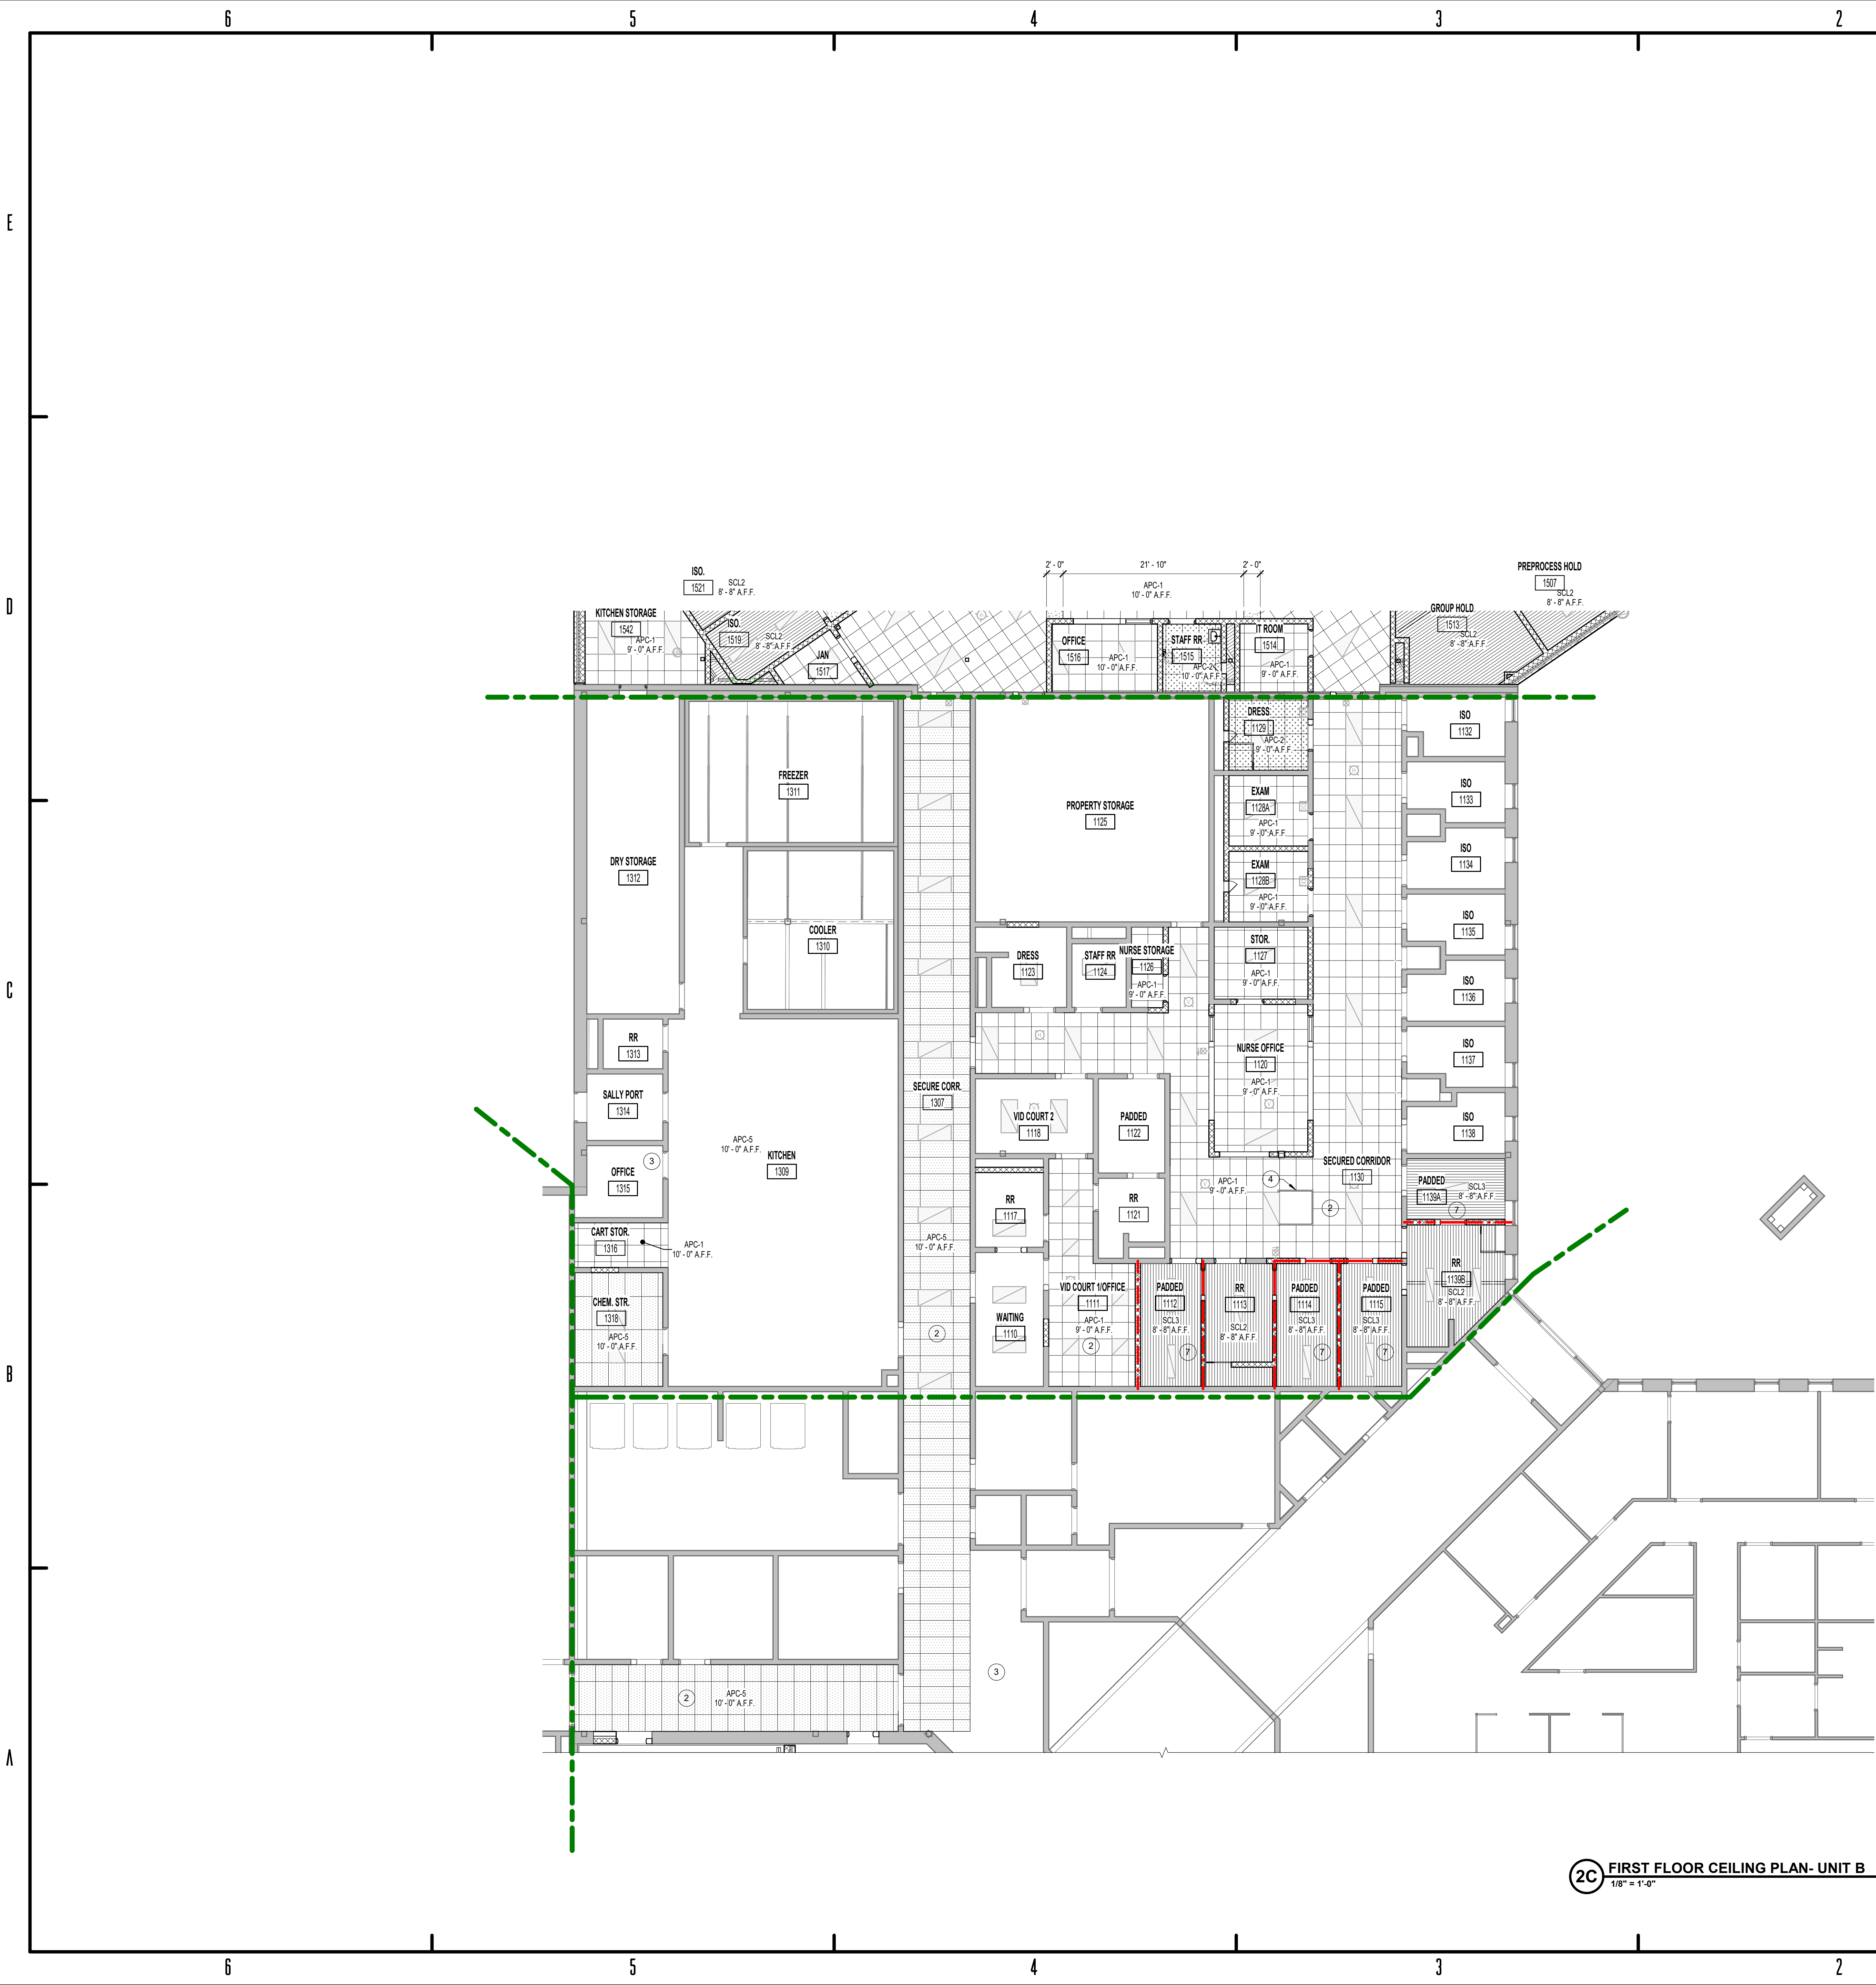
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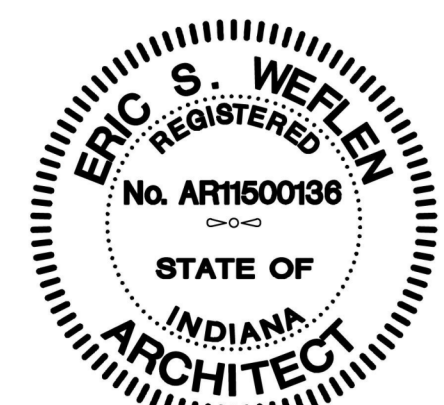
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REFLECTED CEILING  
PLAN LEGEND


APC-1	2' X 2' Acoustical Panel Ceiling (09 51 13)	Light Fixture (Reference E-Series Dwg)	
APC-2	2' X 2' Washable Acoustical Panel Ceiling (09 51 13)	Emergency Light Fixture (Reference E-Series Dwg)	
APC-3	2' x 2' High Humidity Ceiling Panel with Aluminum Grid	Return Air (Reference M-Series Dwg)	
APC-4	2' x 2' Special NRC (0.7 min.) Ceiling Panel with Aluminum Grid	Supply Air (Reference M-Series Dwg)	
APC-5	2' X 4' Washable Acoustical Panel Ceiling (09 51 13)	Exit Light (Reference E-Series Dwg)	
SCL1	2' X 2' Security metal lay-in with hold down clips	Recessed Light Fixture Suspended Fixture in Areas with Exposed Ceilings (Reference E-Series Dwg)	
SCL2	Cellular Metal Deck, see Structural	SOUND SYSTEM SPEAKER (REFERENCE E-SERIES DWS)	
SCL3	Concrete Slab on Cellular Metal Deck, total depth of 5-1/4" Cap to achieve 1-HR rating, see Structural	Walls to Deck	
GWB	Gypsum Wall Board, 5/8" on 3-5/8" Metal Stud (09 29 00)	PLASTER	Plaster on metal wire mesh lathe on 3-5/8" metal stud
GWB-2	5/8" High-Impact drywall on metal wire mesh lathe on 3-5/8" metal stud	MTL	1/4" Steel Plate on engineered framing

#	Revision	Date
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Project #: 20-700-151-2  
Designed By: LD/SP  
Drawn By: CW  
Checked By: LD/EV  
Date: 01.28.2022




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FIRST FLOOR CEILING  
PLAN UNIT B



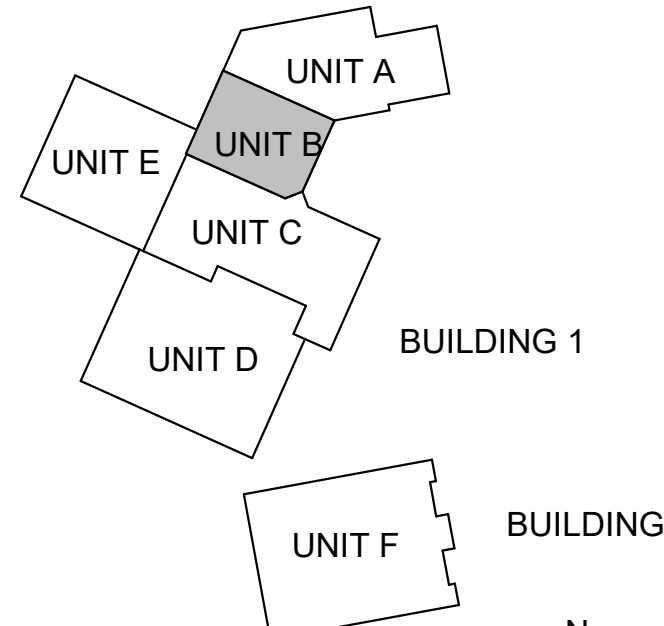

- REFL. CEILING PLAN NOTES
1. All grids are centered in rooms, unless noted otherwise.
  2. Coordinate bulkhead sizes w/ mechanical ductwork.
  3. Refer to MEP drawings for ceiling fixtures/equipment and coordinate w/ all trades.
  4. All exposed ductwork, piping etc. shall be painted. Color selected by Architect.
  5. Locate sprinkler heads in center of ceiling panel - where applicable.
  6. All ceilings are at 9'-0" AFF, unless noted otherwise.
  7. All bulkheads are at 8'-10" AFF, unless noted otherwise.
  8. All new grid shall be APC-1 unless noted otherwise

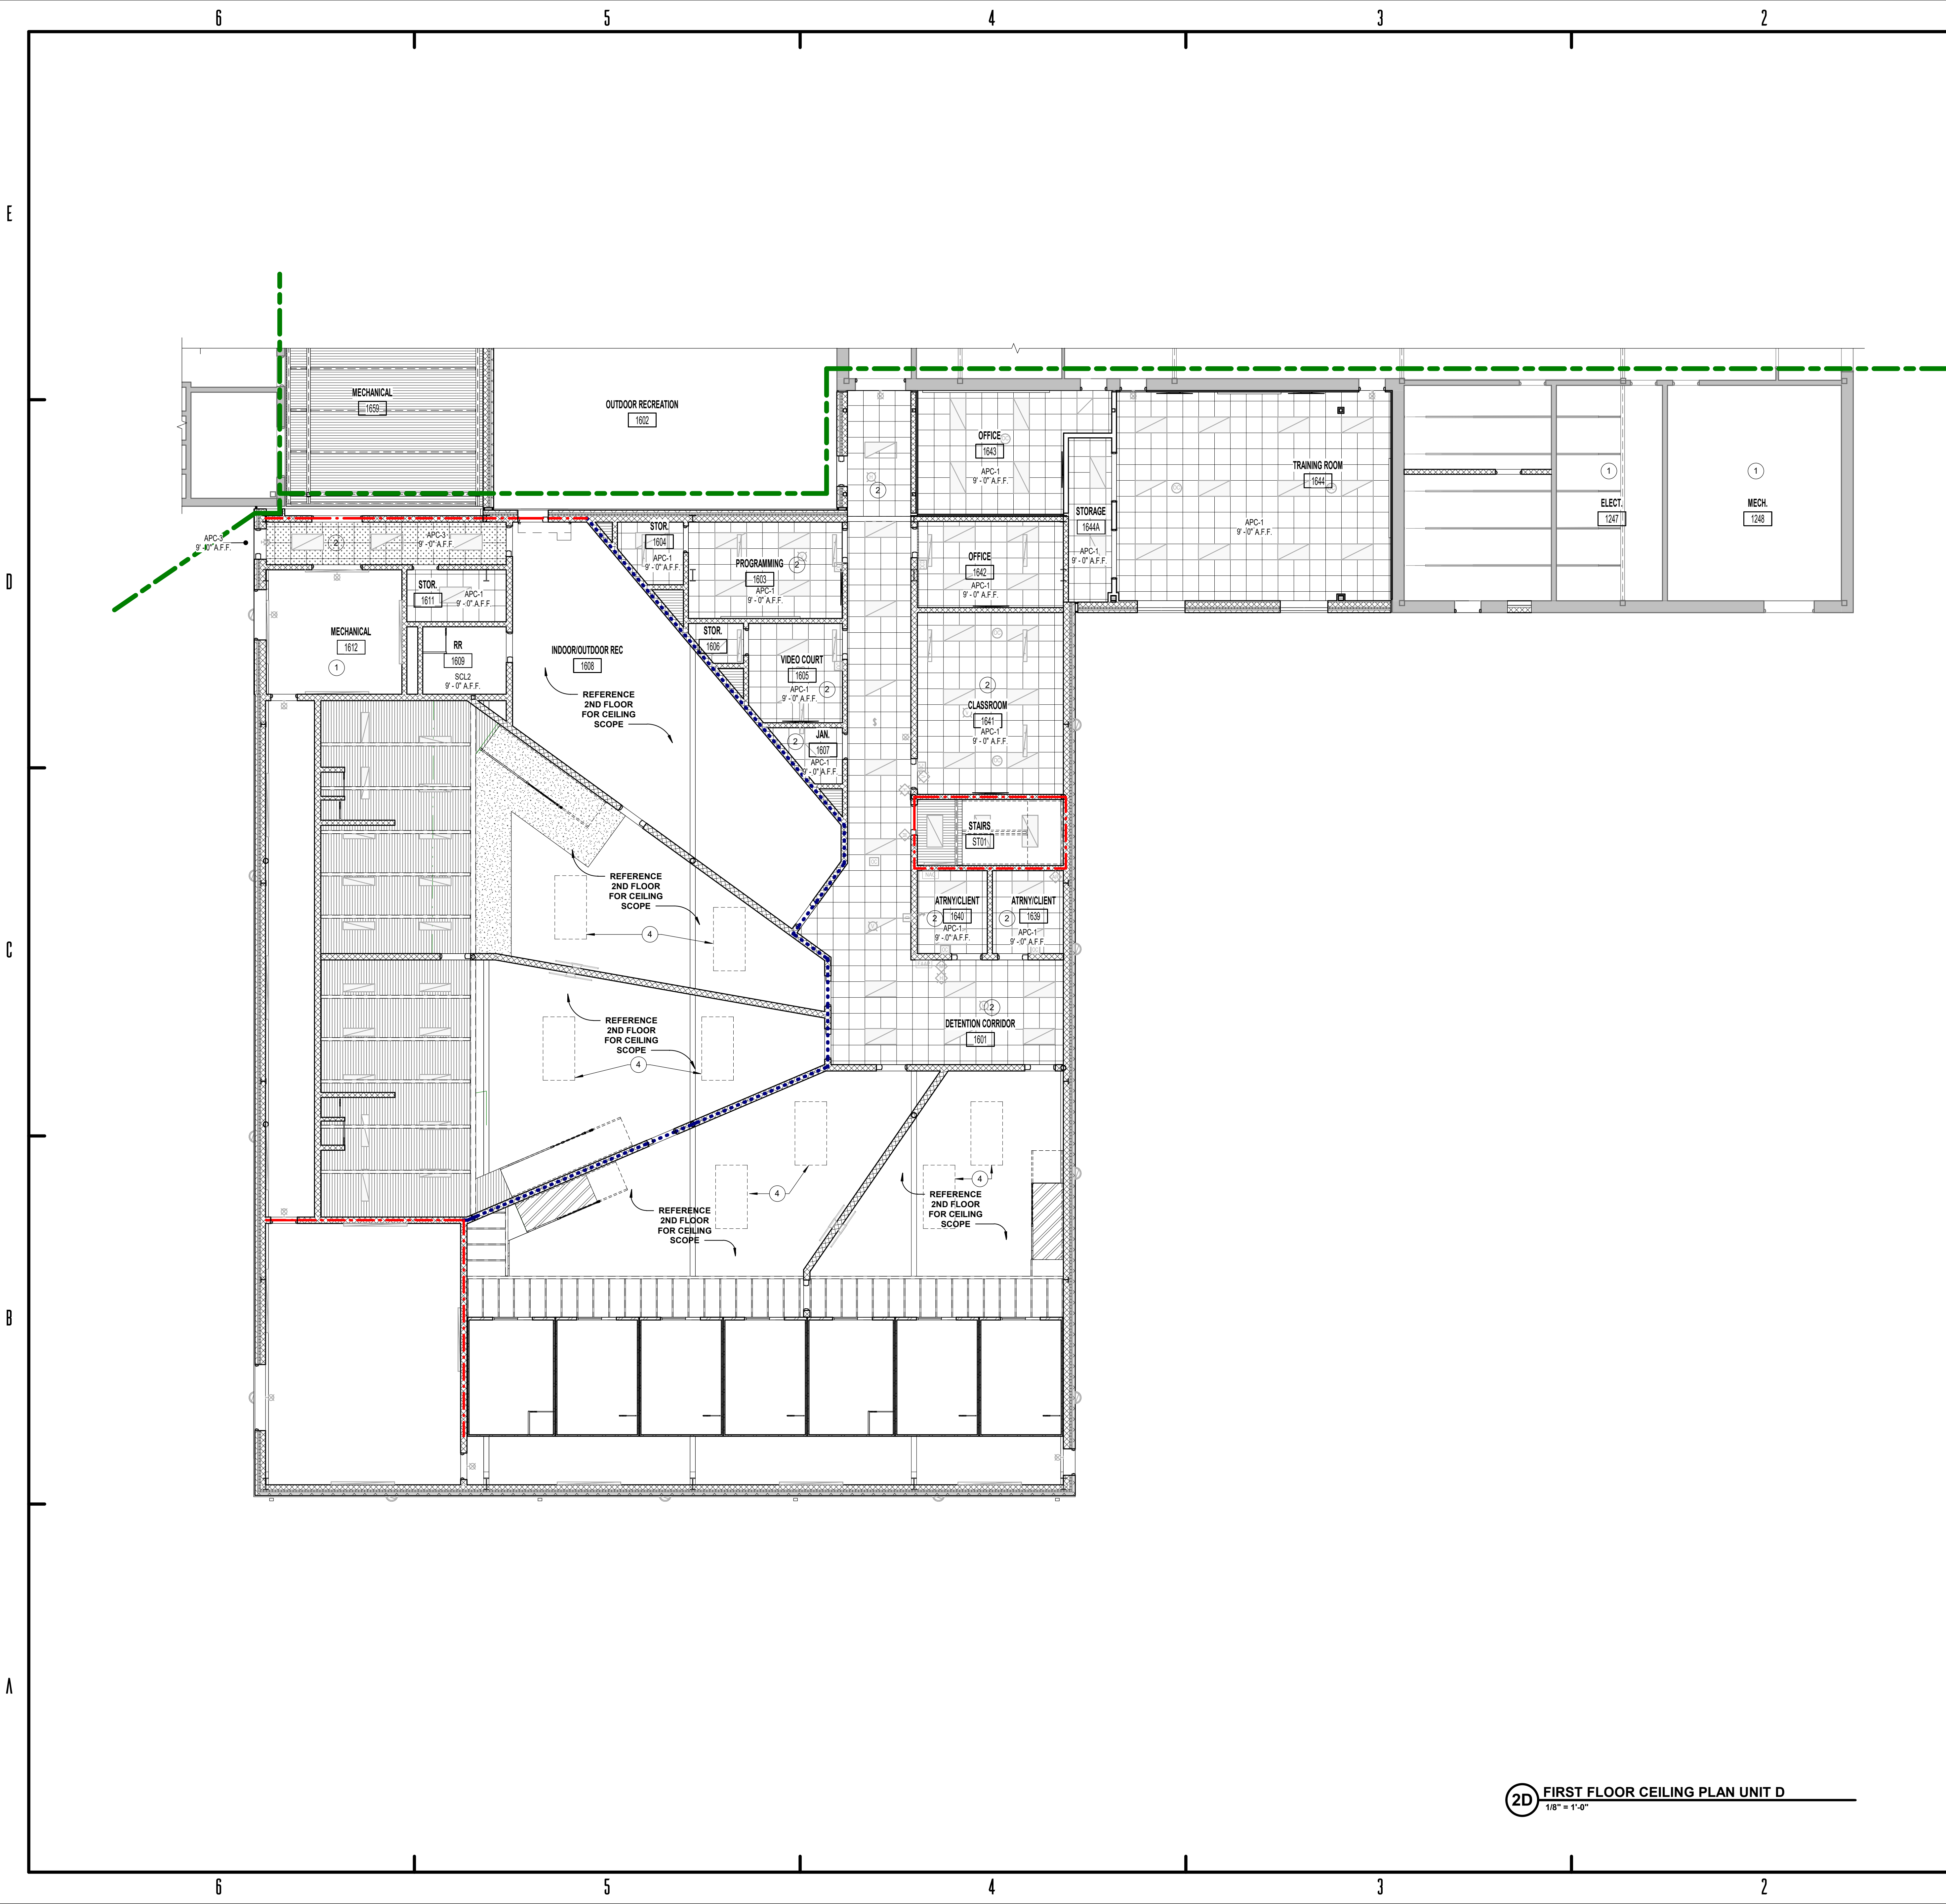5.4.120 - CEILING PLAN NOTES

Key	Note
1	OPEN TO STRUCTURE
2	RETENTION CLIPS, 2 PER EACH CEILING TILE
3	EXISTING CEILING TO REMAIN
4	SKYLIGHT WITH SECURITY BARS, DUCTED SHAFT (INTERIOR TO BE PAINTED). POLYCARBONATE LENS AT CEILING LEVEL. SEE ROOF PLAN FOR SKYLIGHT SIZE, FINAL SKYLIGHT LOCATION TO ADJUST AS REQUIRED TO COORDINATE WITH STRUCTURAL AND MEP SYSTEMS
5	18 IN CEILING MOUNTED DOMED MIRROR
6	PROVIDE A 5-1/4" SLAB ON TOP OF CELLULAR METAL DECK TO ACHIEVE 1-HR RATED LID ASSEMBLY
7	OVERHEAD CEILING DOOR ASSEMBLY WITH ELECTRICALLY MOTORIZED OPERATOR
8	CEILING MOUNTED 42" MONITORS. FINAL INSTALLATION TO BE COORDINATED WITH CONTROL STATION INSTALLATION

REFLECTED CEILING PLAN LEGEND

APC-1	2' x 2' Acoustical Panel Ceiling (09 51 13)	Light Fixture (Reference E-Series Dwgs)	Emergency Light Fixture (Reference E-Series Dwgs)
APC-2	2' x 2' Washable Acoustical Panel Ceiling (09 51 13)	Return Air (Reference M-Series Dwgs)	
APC-3	2' x 2' High Humidity Ceiling Panel with Aluminum Grid	Supply Air (Reference M-Series Dwgs)	
APC-4	2' x 2' Special NRC (0.7 min.) Ceiling Panel with Aluminum Grid	Exit Light (Reference E-Series Dwgs)	
APC-5	2' x 4' Washable Acoustical Panel Ceiling (09 51 13)		
SCL1	2' x 2' Security metal lay-in with hold down clips	Recessed Light Fixture Suspended Fixture in Areas with Exposed Ceilings (Reference E-Series Dwgs)	
SCL2	Cellular Metal Deck, see Structural	SOUND SYSTEM SPEAKER (REFERENCE E-SERIES/T-SERIES DWGS)	
SCL3	Concrete Slab on Cellular Metal Deck, total depth of 5-1/4" Cap to achieve 1-HR rating, see Structural	Walls to Deck	
GWB	Gypsum Wall Board, 5/8" on 3-5/8" Metal Stud (09 29 00)	PLASTER Plaster on metal wire mesh lathe on 3-5/8" metal stud	
GWB-2	5/8" High-Impact drywall on metal wire mesh lathe on 3-5/8" metal stud	MTL 1/4" Steel Plate on engineered framing	

2D FIRST FLOOR CEILING PLAN UNIT D  
1/8" = 1'-0"

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KNOX COUNTY JUSTICE CAMPUS  
2375 OLD DECKER RD. VINCENNES, IN 47591

BID SET

#	Revision	Date

Project #: 20-700-151-2  
Designed By: LD/SP  
Drawn By: CW  
Checked By: LD/EV  
Date: 01.28.2022

Eric S. Wepler


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BUILDING 1  
BUILDING 2

FIRST FLOOR CEILING PLAN UNIT D

AC 1D1



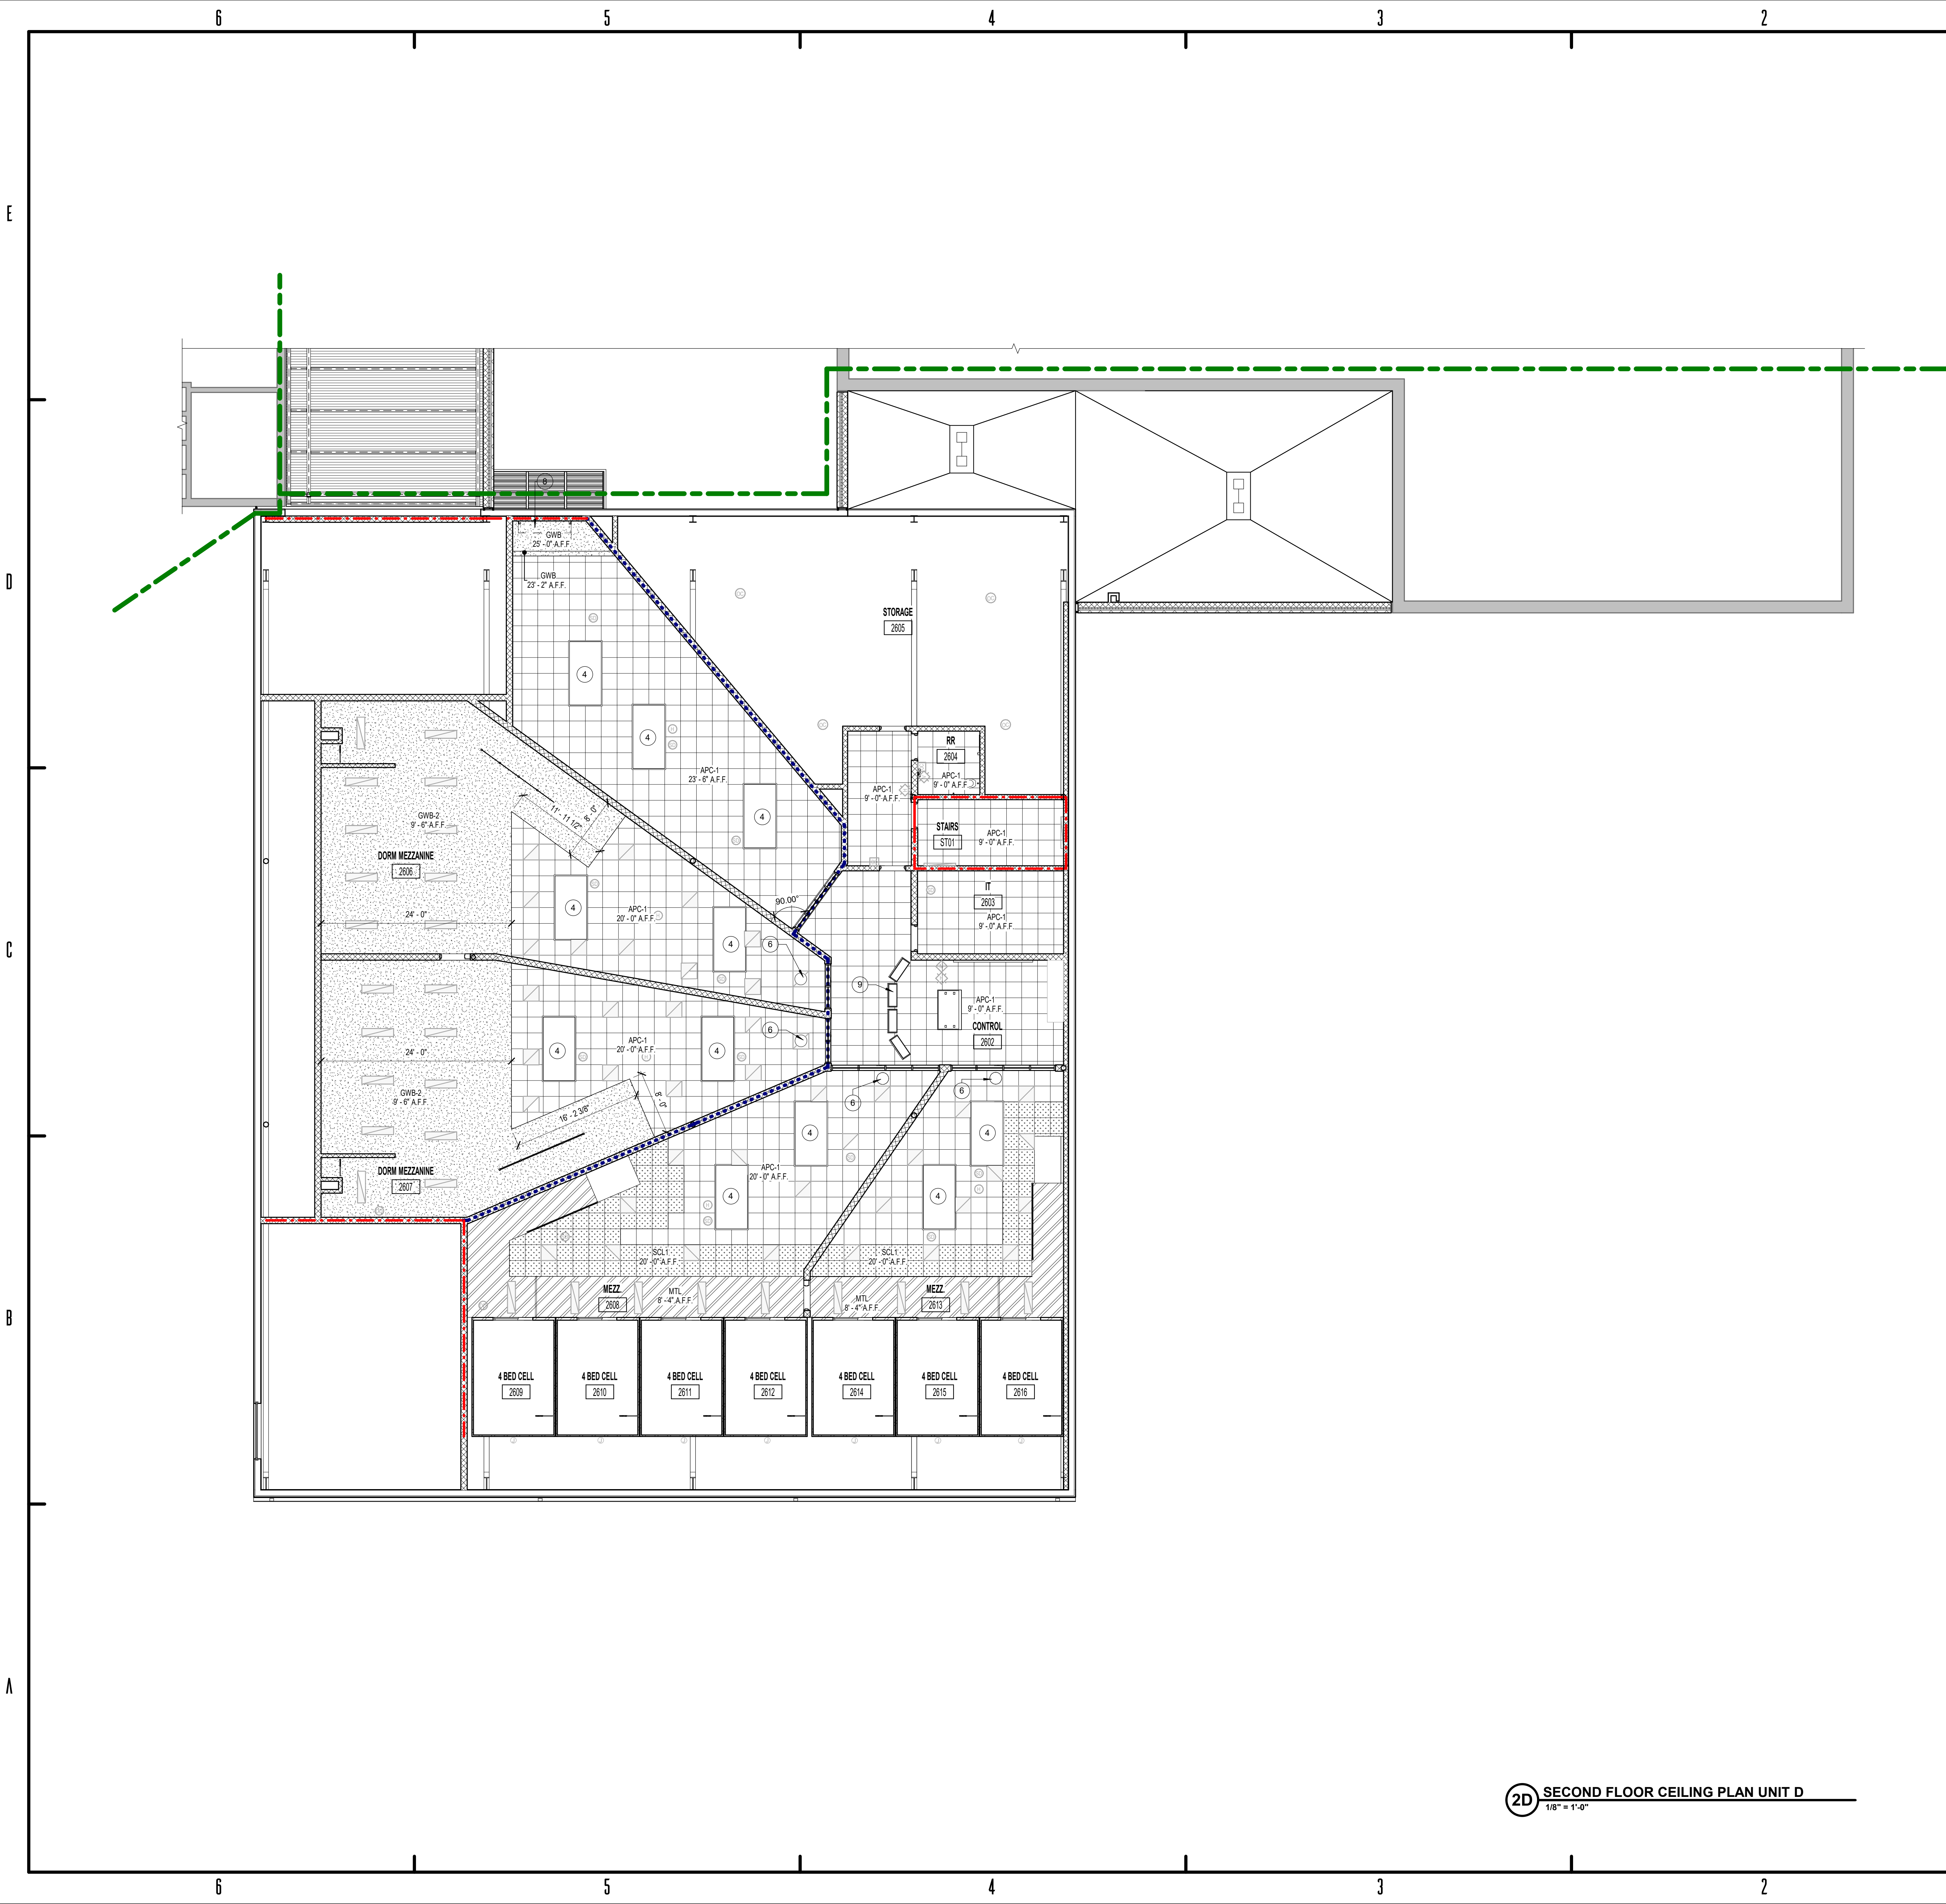

2D SECOND FLOOR CEILING PLAN UNIT D  
1/8" = 1'-0"

REFL. CEILING PLAN NOTES

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5.4.120 - CEILING PLAN NOTES

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REFLECTED CEILING  
PLAN LEGEND

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GWB-2	5/8" High-Impact drywall on metal wire mesh lathe on 3-5/8" metal stud	MTL	1/4" Steel Plate on engineered framing



BID SET  
KNOX COUNTY BOARD OF COMMISSIONERS  
KNOX COUNTY JUSTICE CAMPUS  
2375 OLD DECKER RD. VINCENNES, IN 47591


#	Revision	Date
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Project #: 20-700-151-2  
Designed By: LD/SP  
Drawn By: CW  
Checked By: LD/IV  
Date: 01.28.2022



Eric Wepler


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SECOND FLOOR CEILING  
PLAN UNIT D

AC 1D2

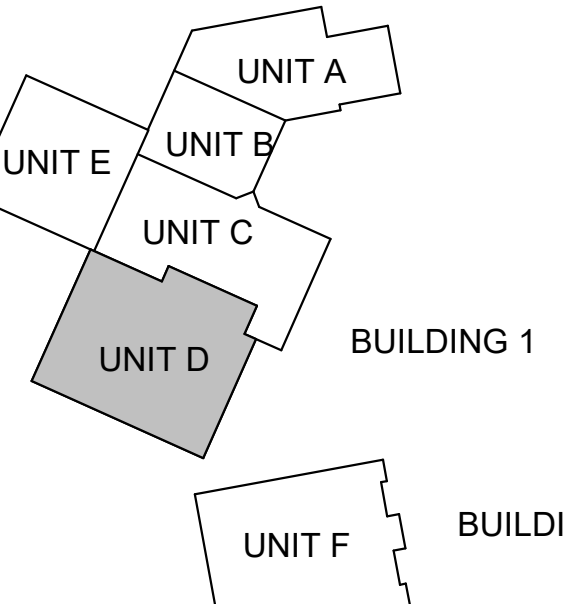



6A FIRST FLOOR CEILING PLAN UNIT F  
1/8" = 1'-0"

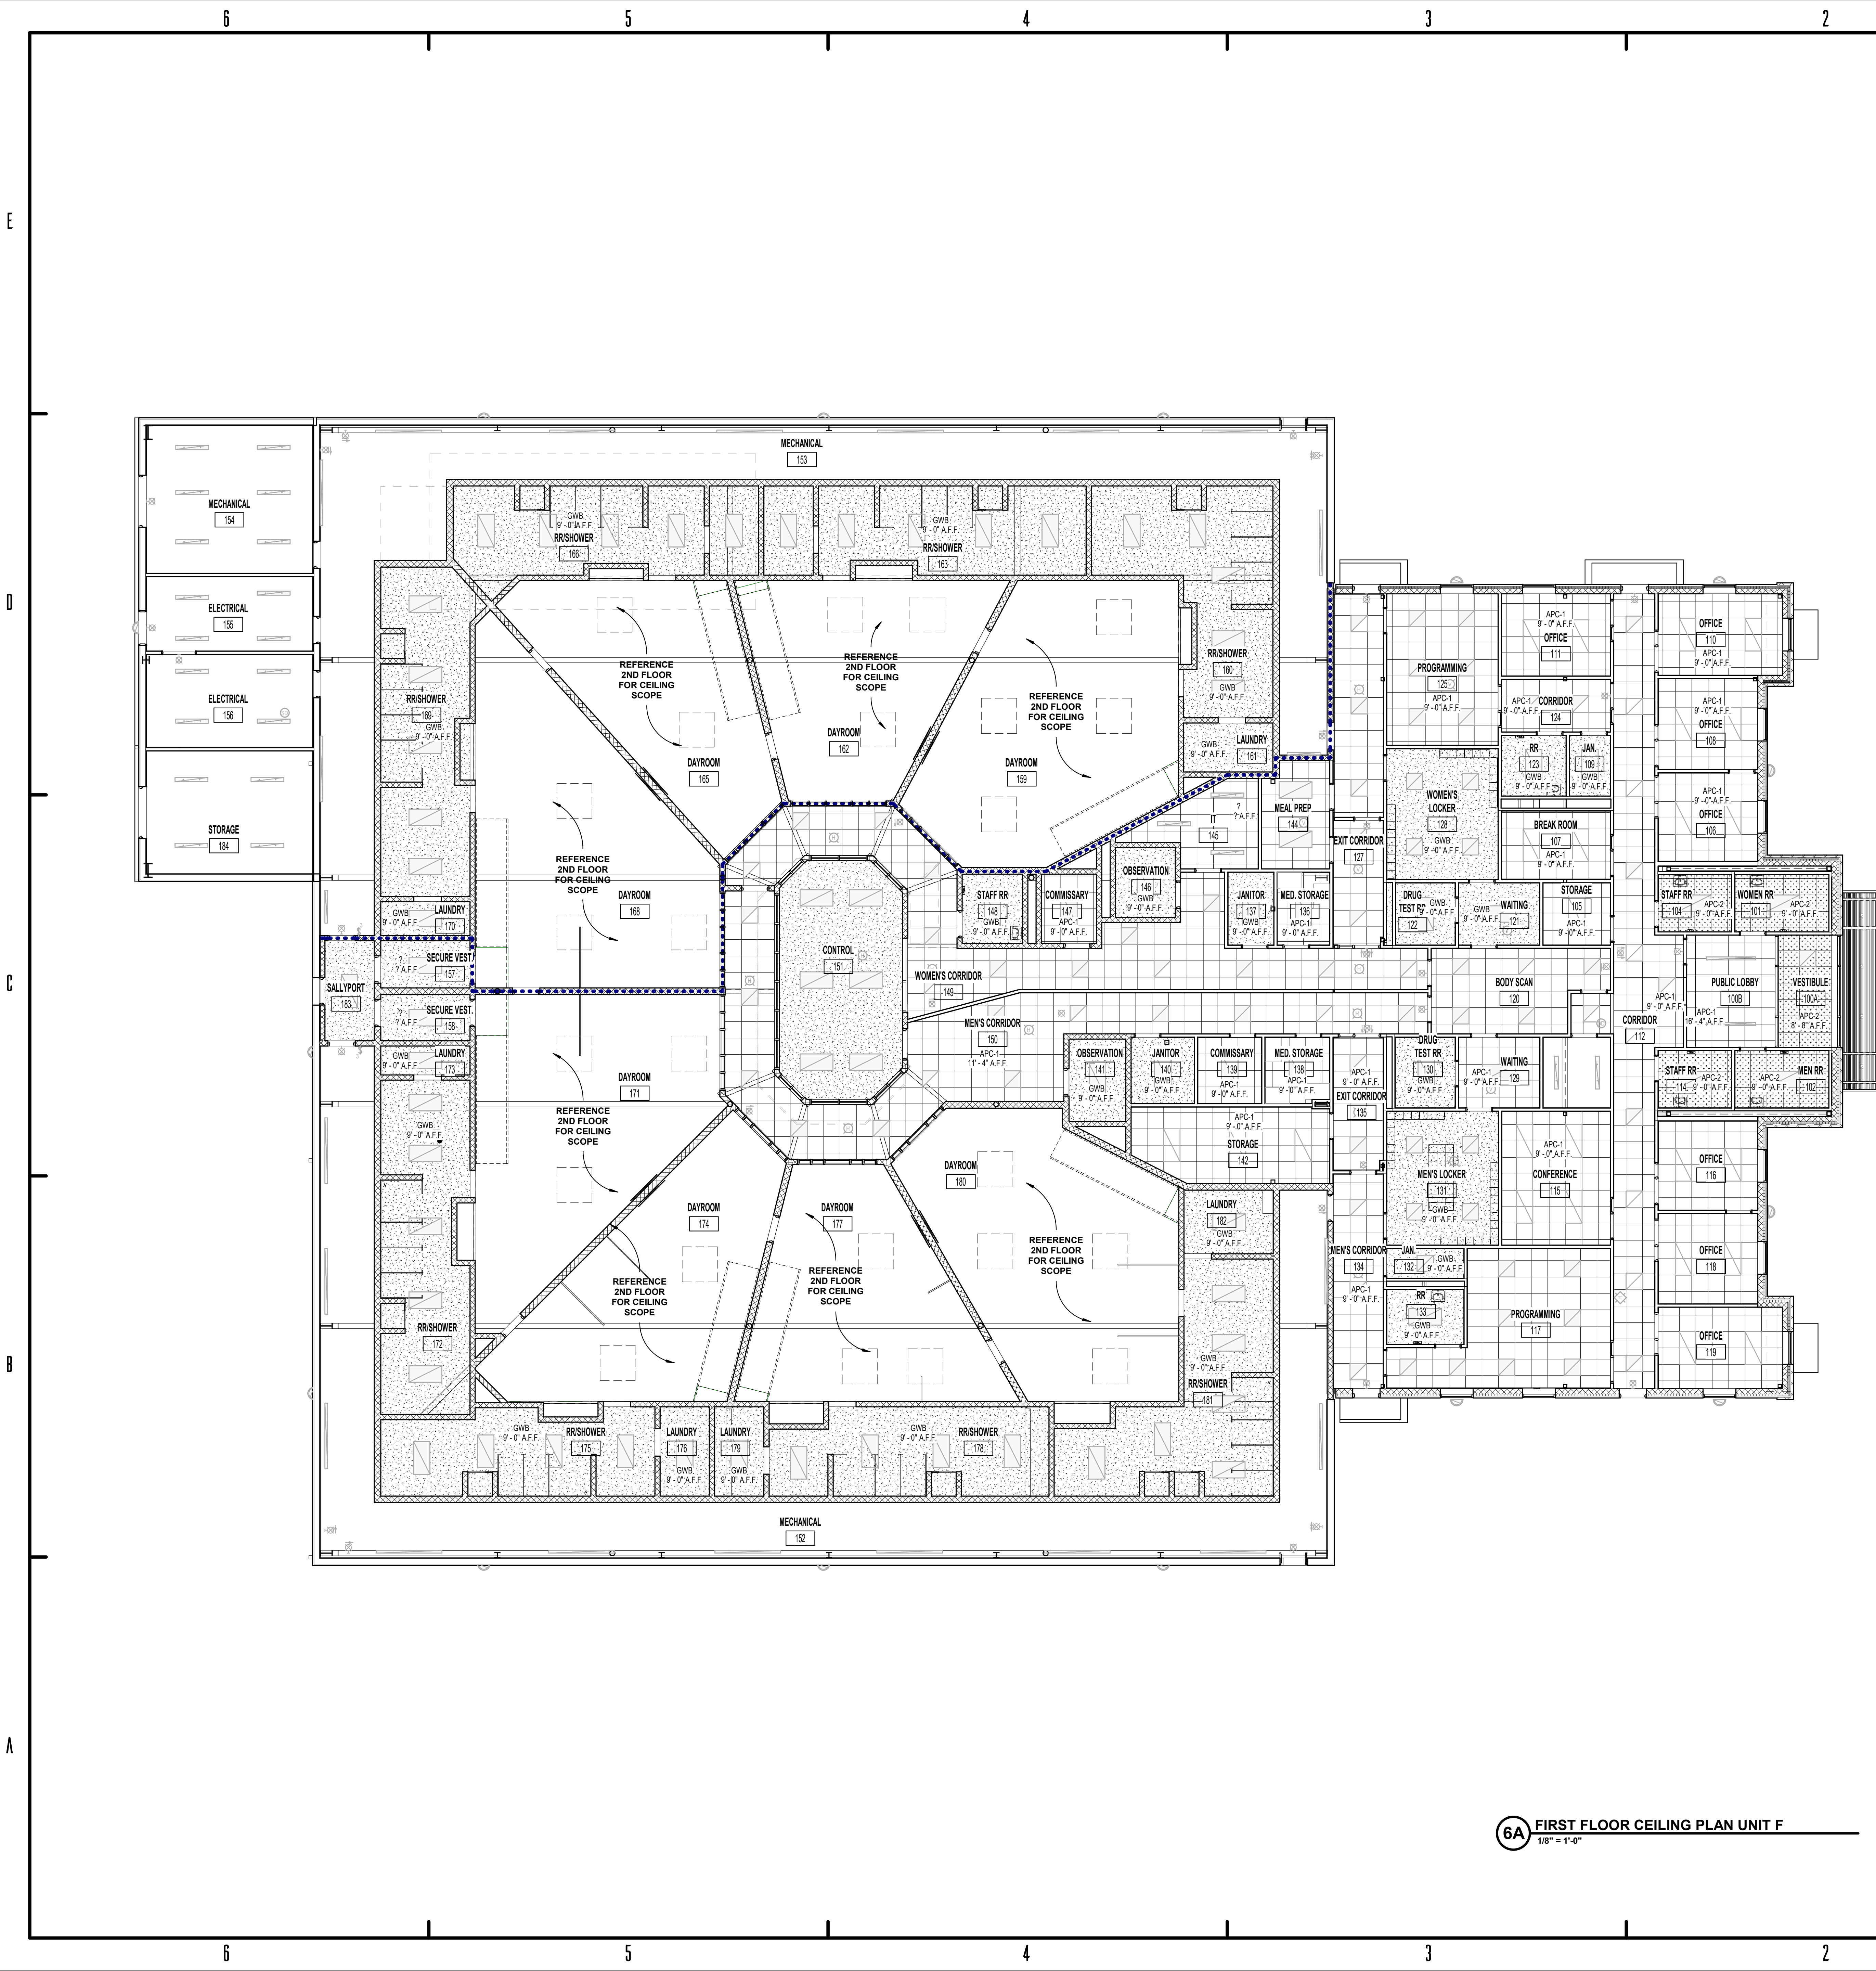REFL. CEILING PLAN NOTES

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7. All bulkheads are at 8'-10" AFF, unless noted otherwise.
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5.4.120 - CEILING PLAN NOTES

Key	Note
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PLAN LEGEND

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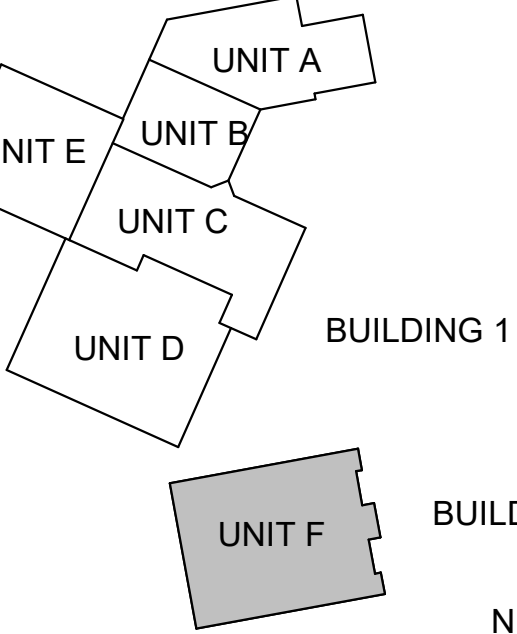
#	Revision	Date
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Project #: 20-700-151-2  
Designed By: LD/SP  
Drawn By: WD  
Checked By: LD  
Date: 01.28.2022



Eric Wehlen


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FIRST FLOOR CEILING  
PLAN UNIT F

AC 2F1





REFL. CEILING PLAN NOTES
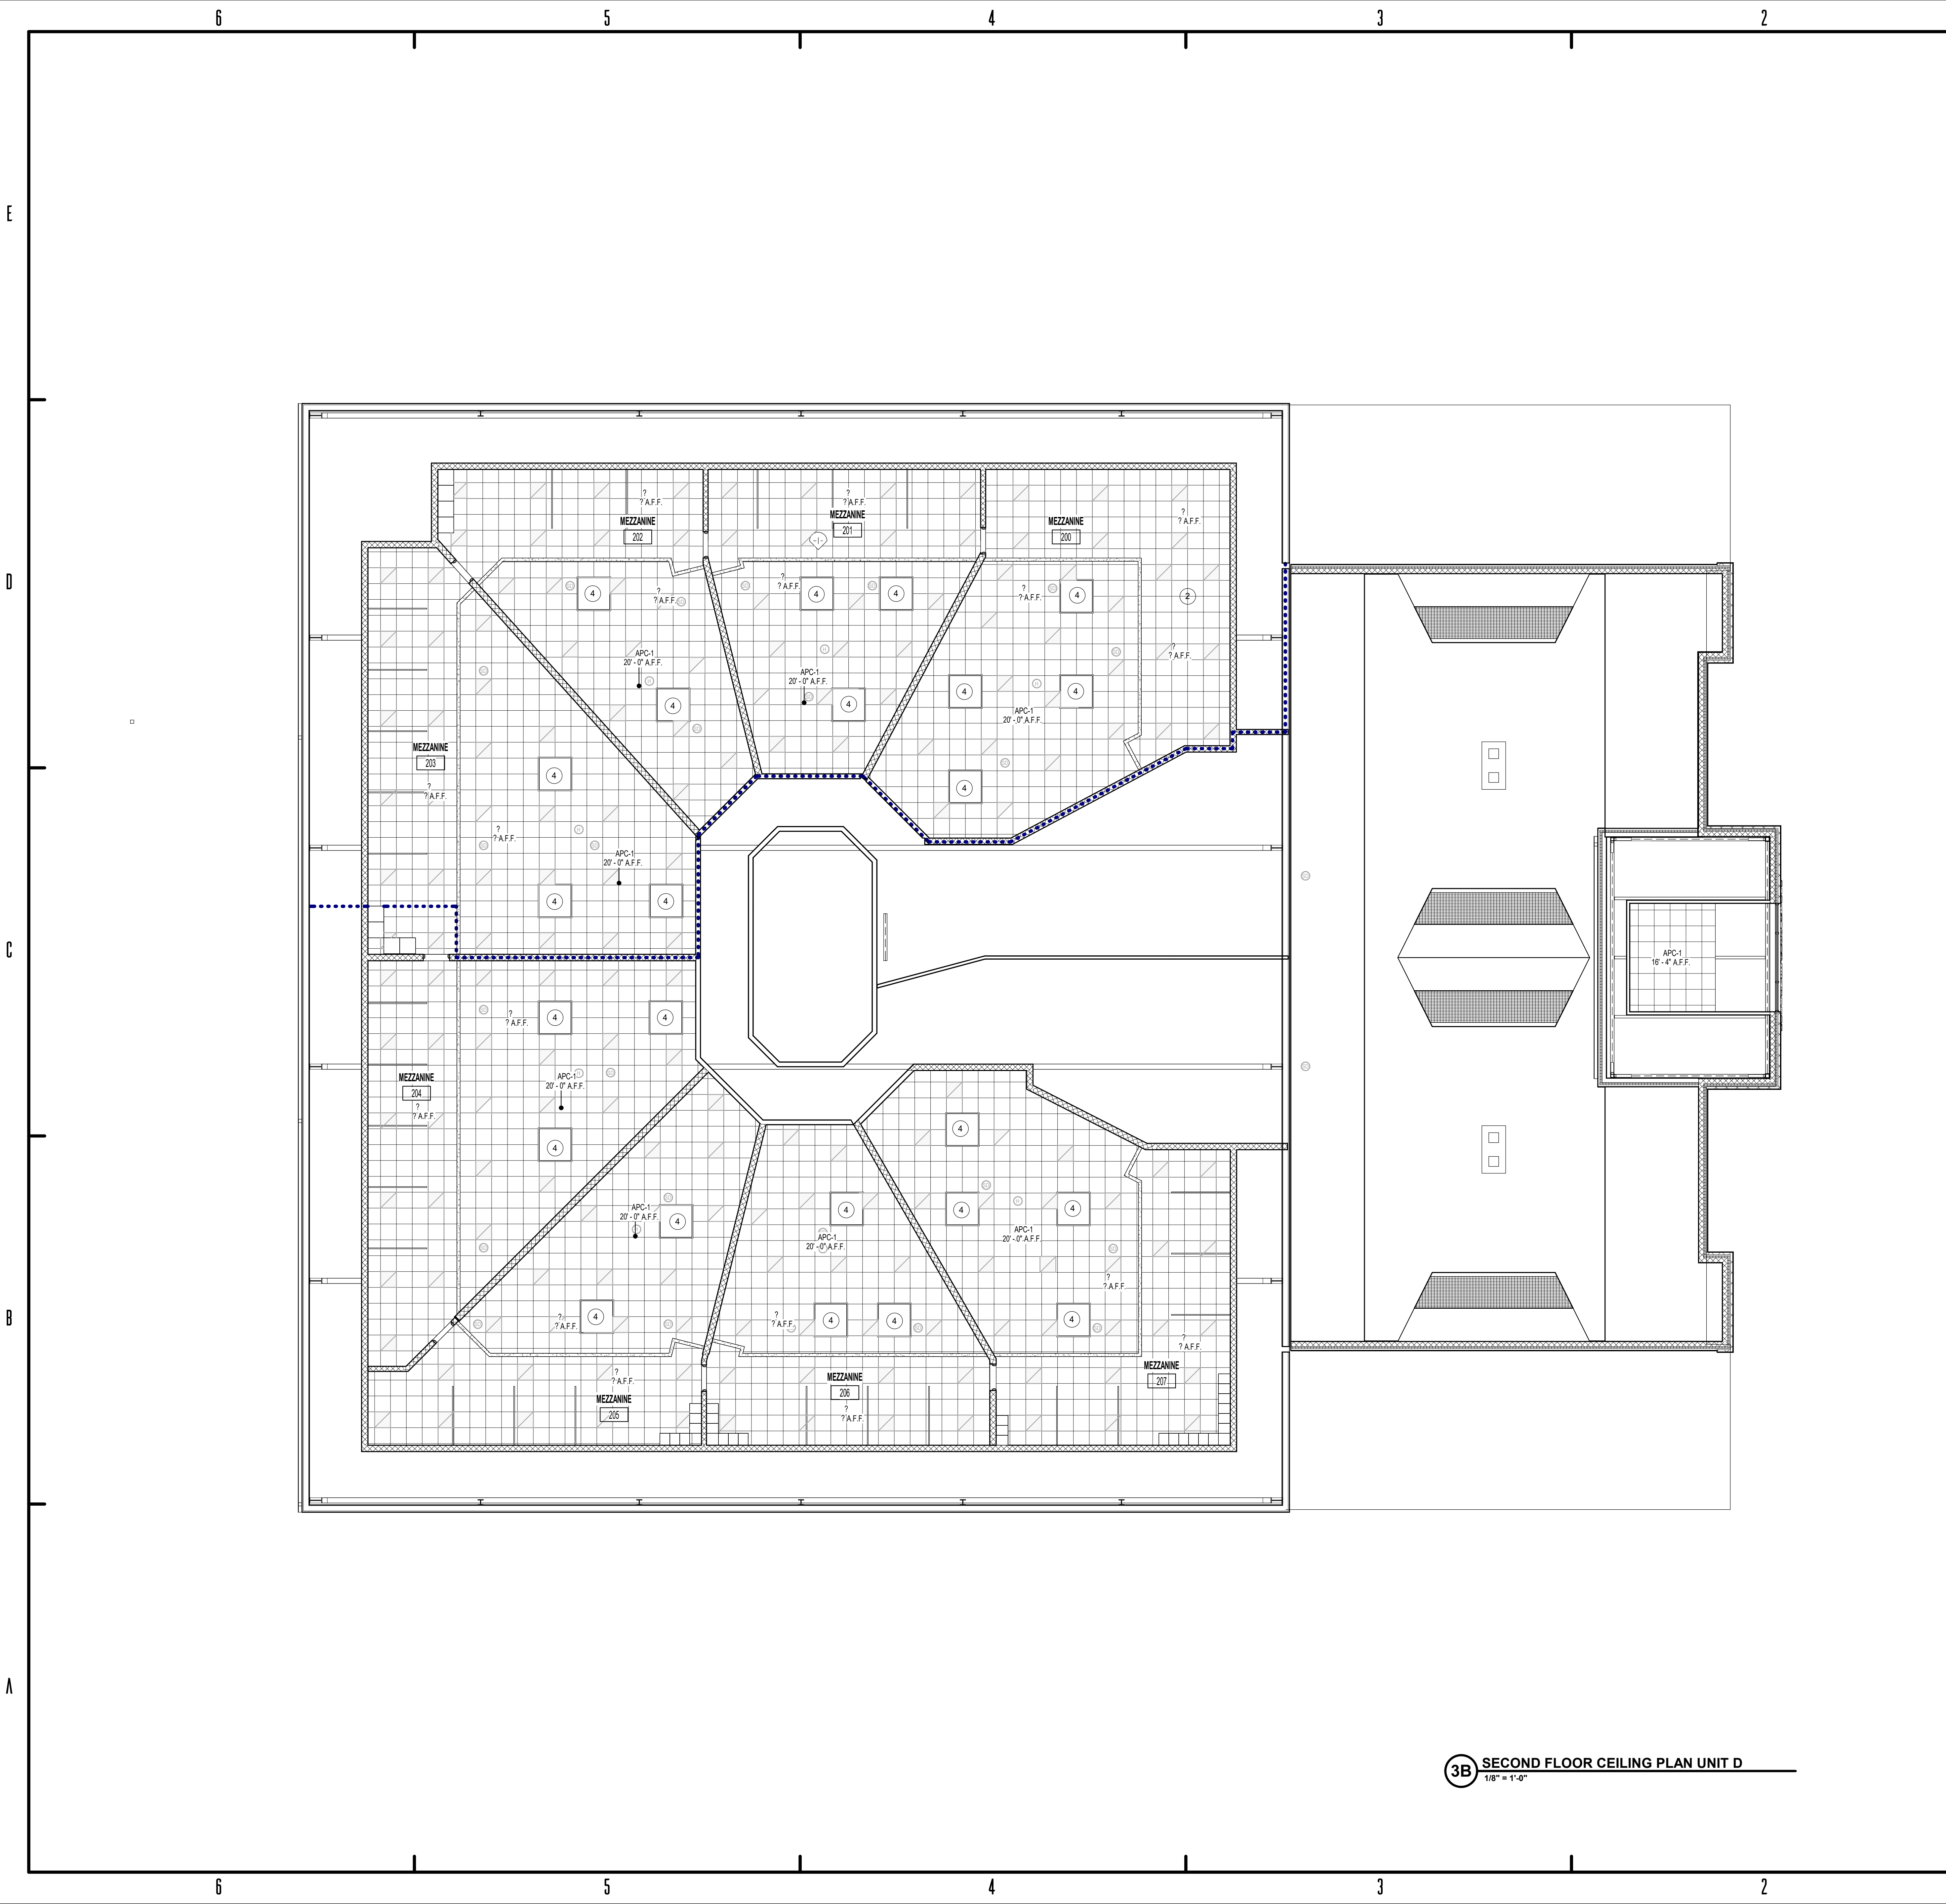
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5.4.120 - CEILING PLAN NOTES

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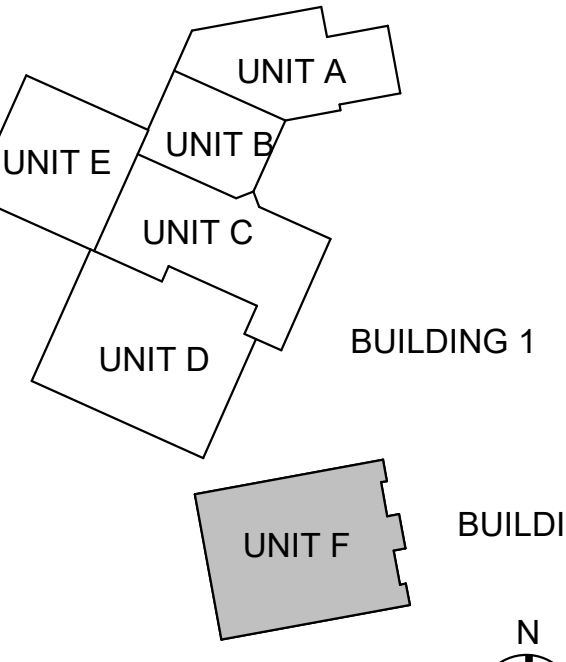
KNOX COUNTY BOARD OF COMMISSIONERS  
KNOX COUNTY JUSTICE CAMPUS  
2375 OLD DECKER RD. VINCENNES, IN 47591

#	Revision	Date
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Project #: 20-700-151-2  
Designed By: LD  
Drawn By: WD  
Checked By: LD/IV  
Date: 01.28.2022



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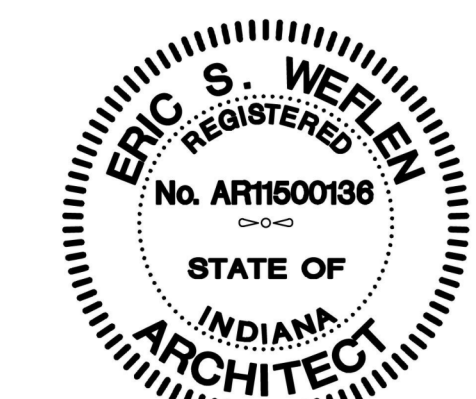
SECOND FLOOR CEILING PLAN UNIT F

AC 2F2




#	Revision	Date
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Project #: 20-700-151-2  
Designed By: LD/SP  
Drawn By: CP  
Checked By: CP  
Date: 01.28.2022



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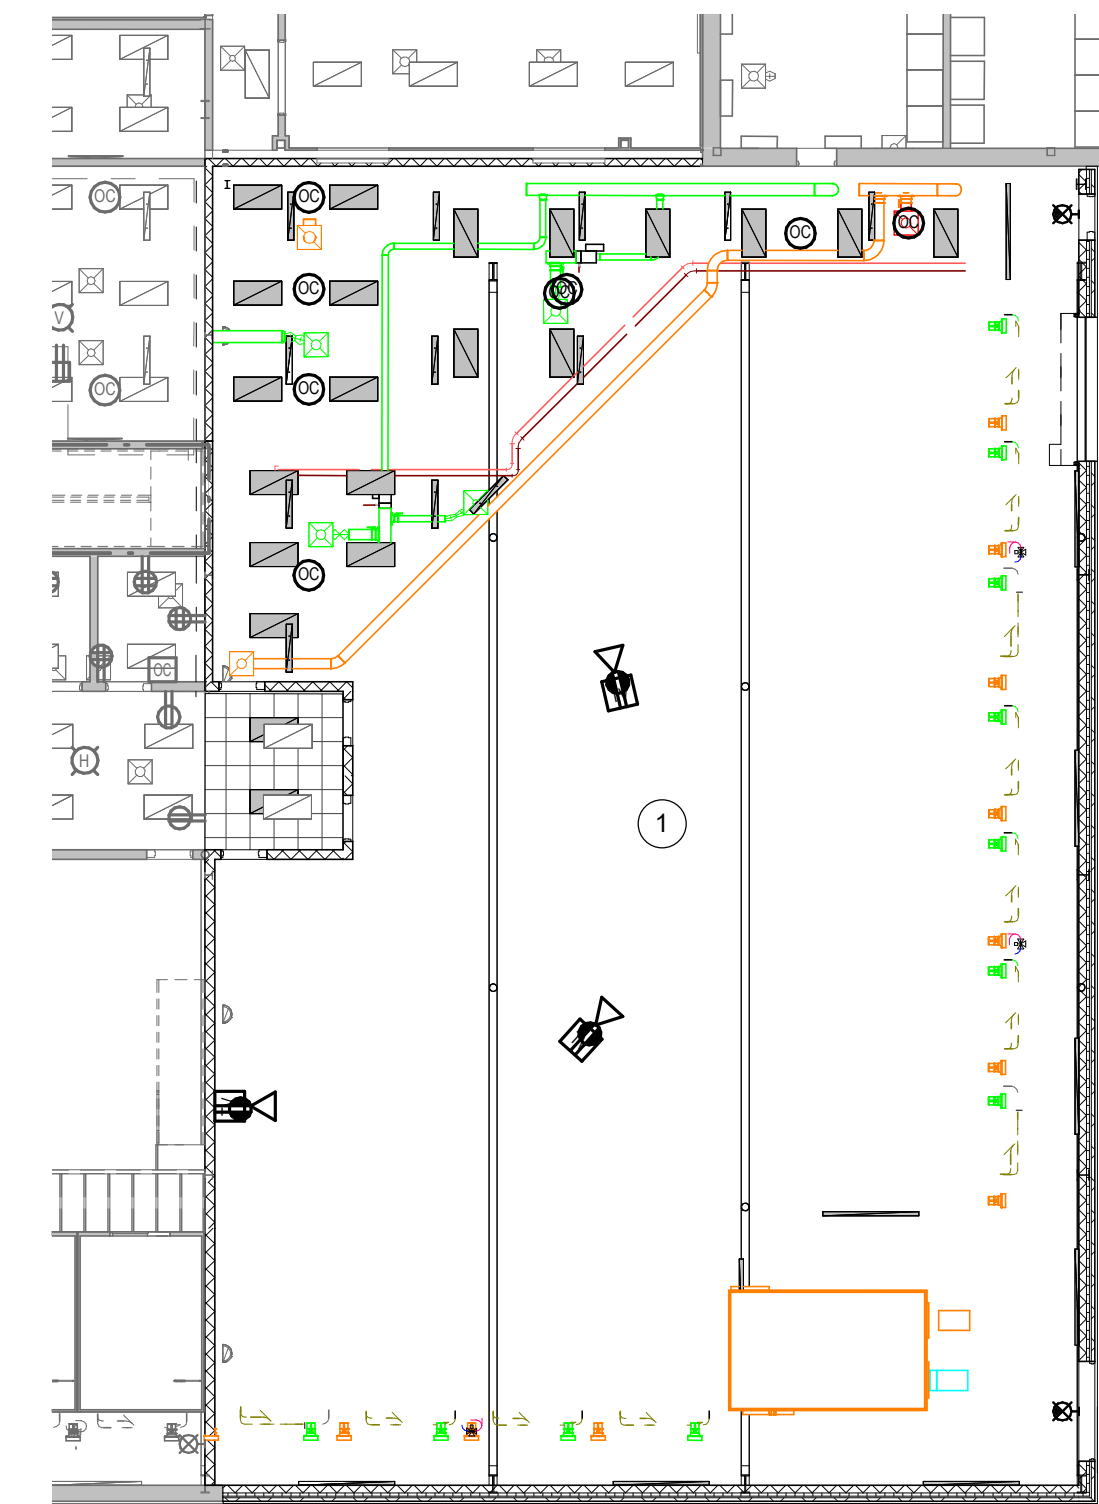


ALTERNATE FIRST FLOOR  
CEILING PLAN

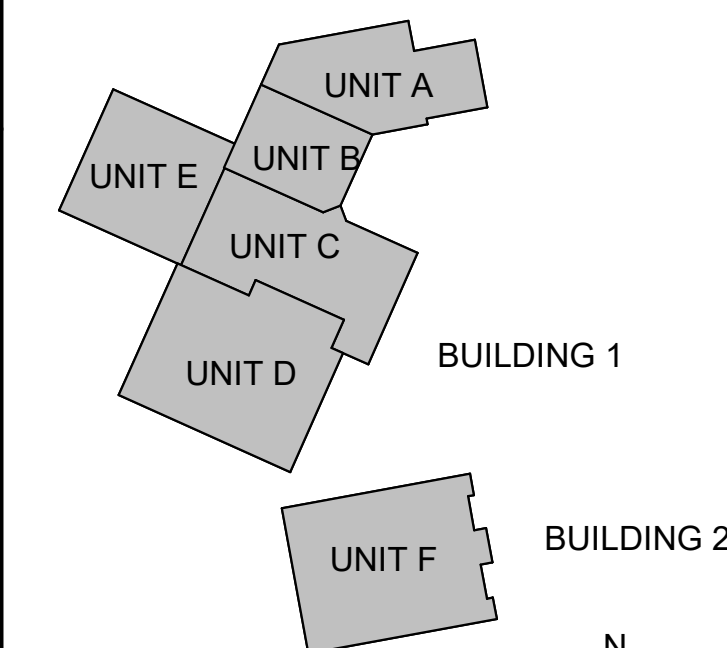
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5.4.120 - CEILING PLAN NOTES


Key	Note
1	OPEN TO STRUCTURE
2	RETENTION CLIPS, 2 PER EACH CEILING TILE
3	EXISTING CEILING TO REMAIN
4	SKYLIGHT WITH SECURITY BARS, DUCTED SHAFT (INTERIOR TO BE PAINTED) POLYCARBONATE LENS AT CEILING LEVEL. SEE ROOF PLAN FOR SKYLIGHT SIZE. FINAL SKYLIGHT LOCATION TO ADJUST AS REQUIRED TO COORDINATE WITH STRUCTURAL AND MEFP SYSTEMS
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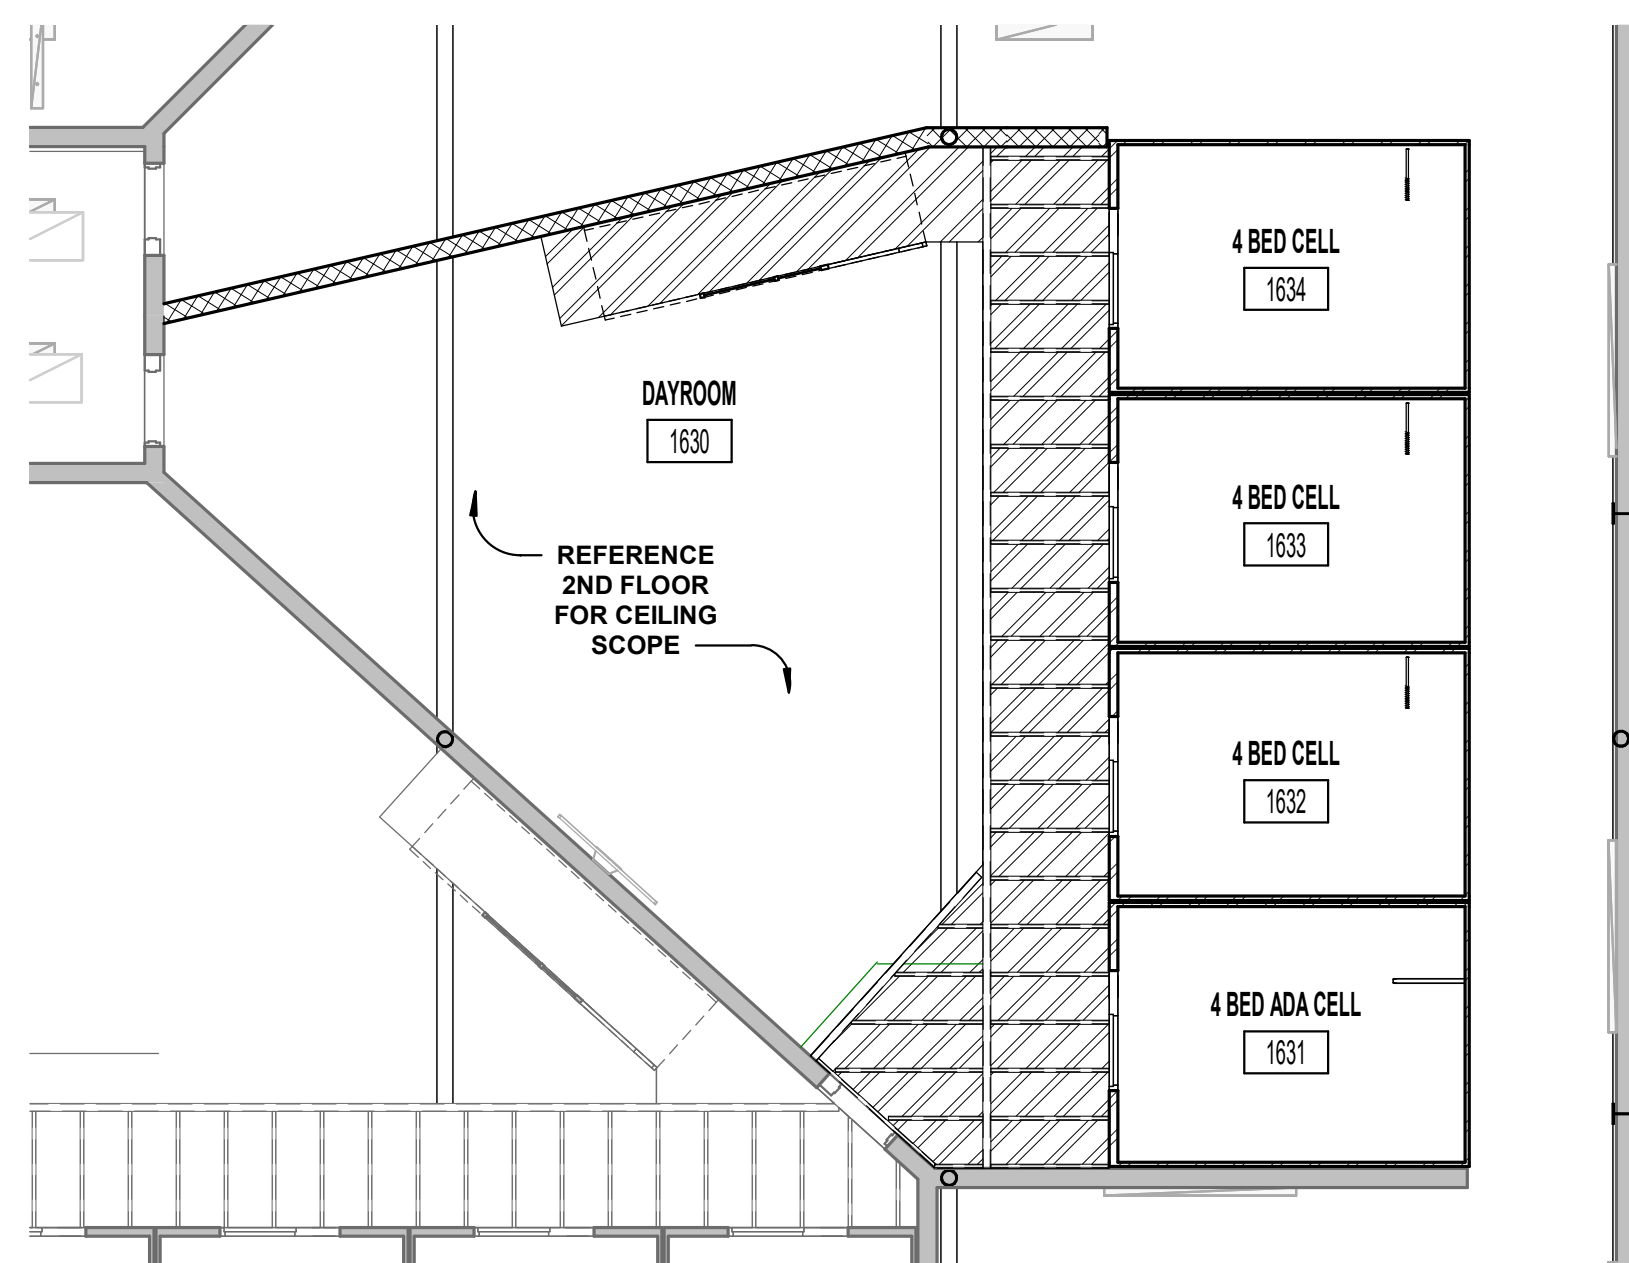
**2D** FIRST FLOOR REFLECTED CEILING PLAN BUILDING 1 - UNIT D ALTERNATE "D"  
1/16" = 1'-0"




**2A** FIRST FLOOR REFLECTED CEILING PLAN BUILDING 1 - UNIT D ALTERNATE "D1"  
1/8" = 1'-0"

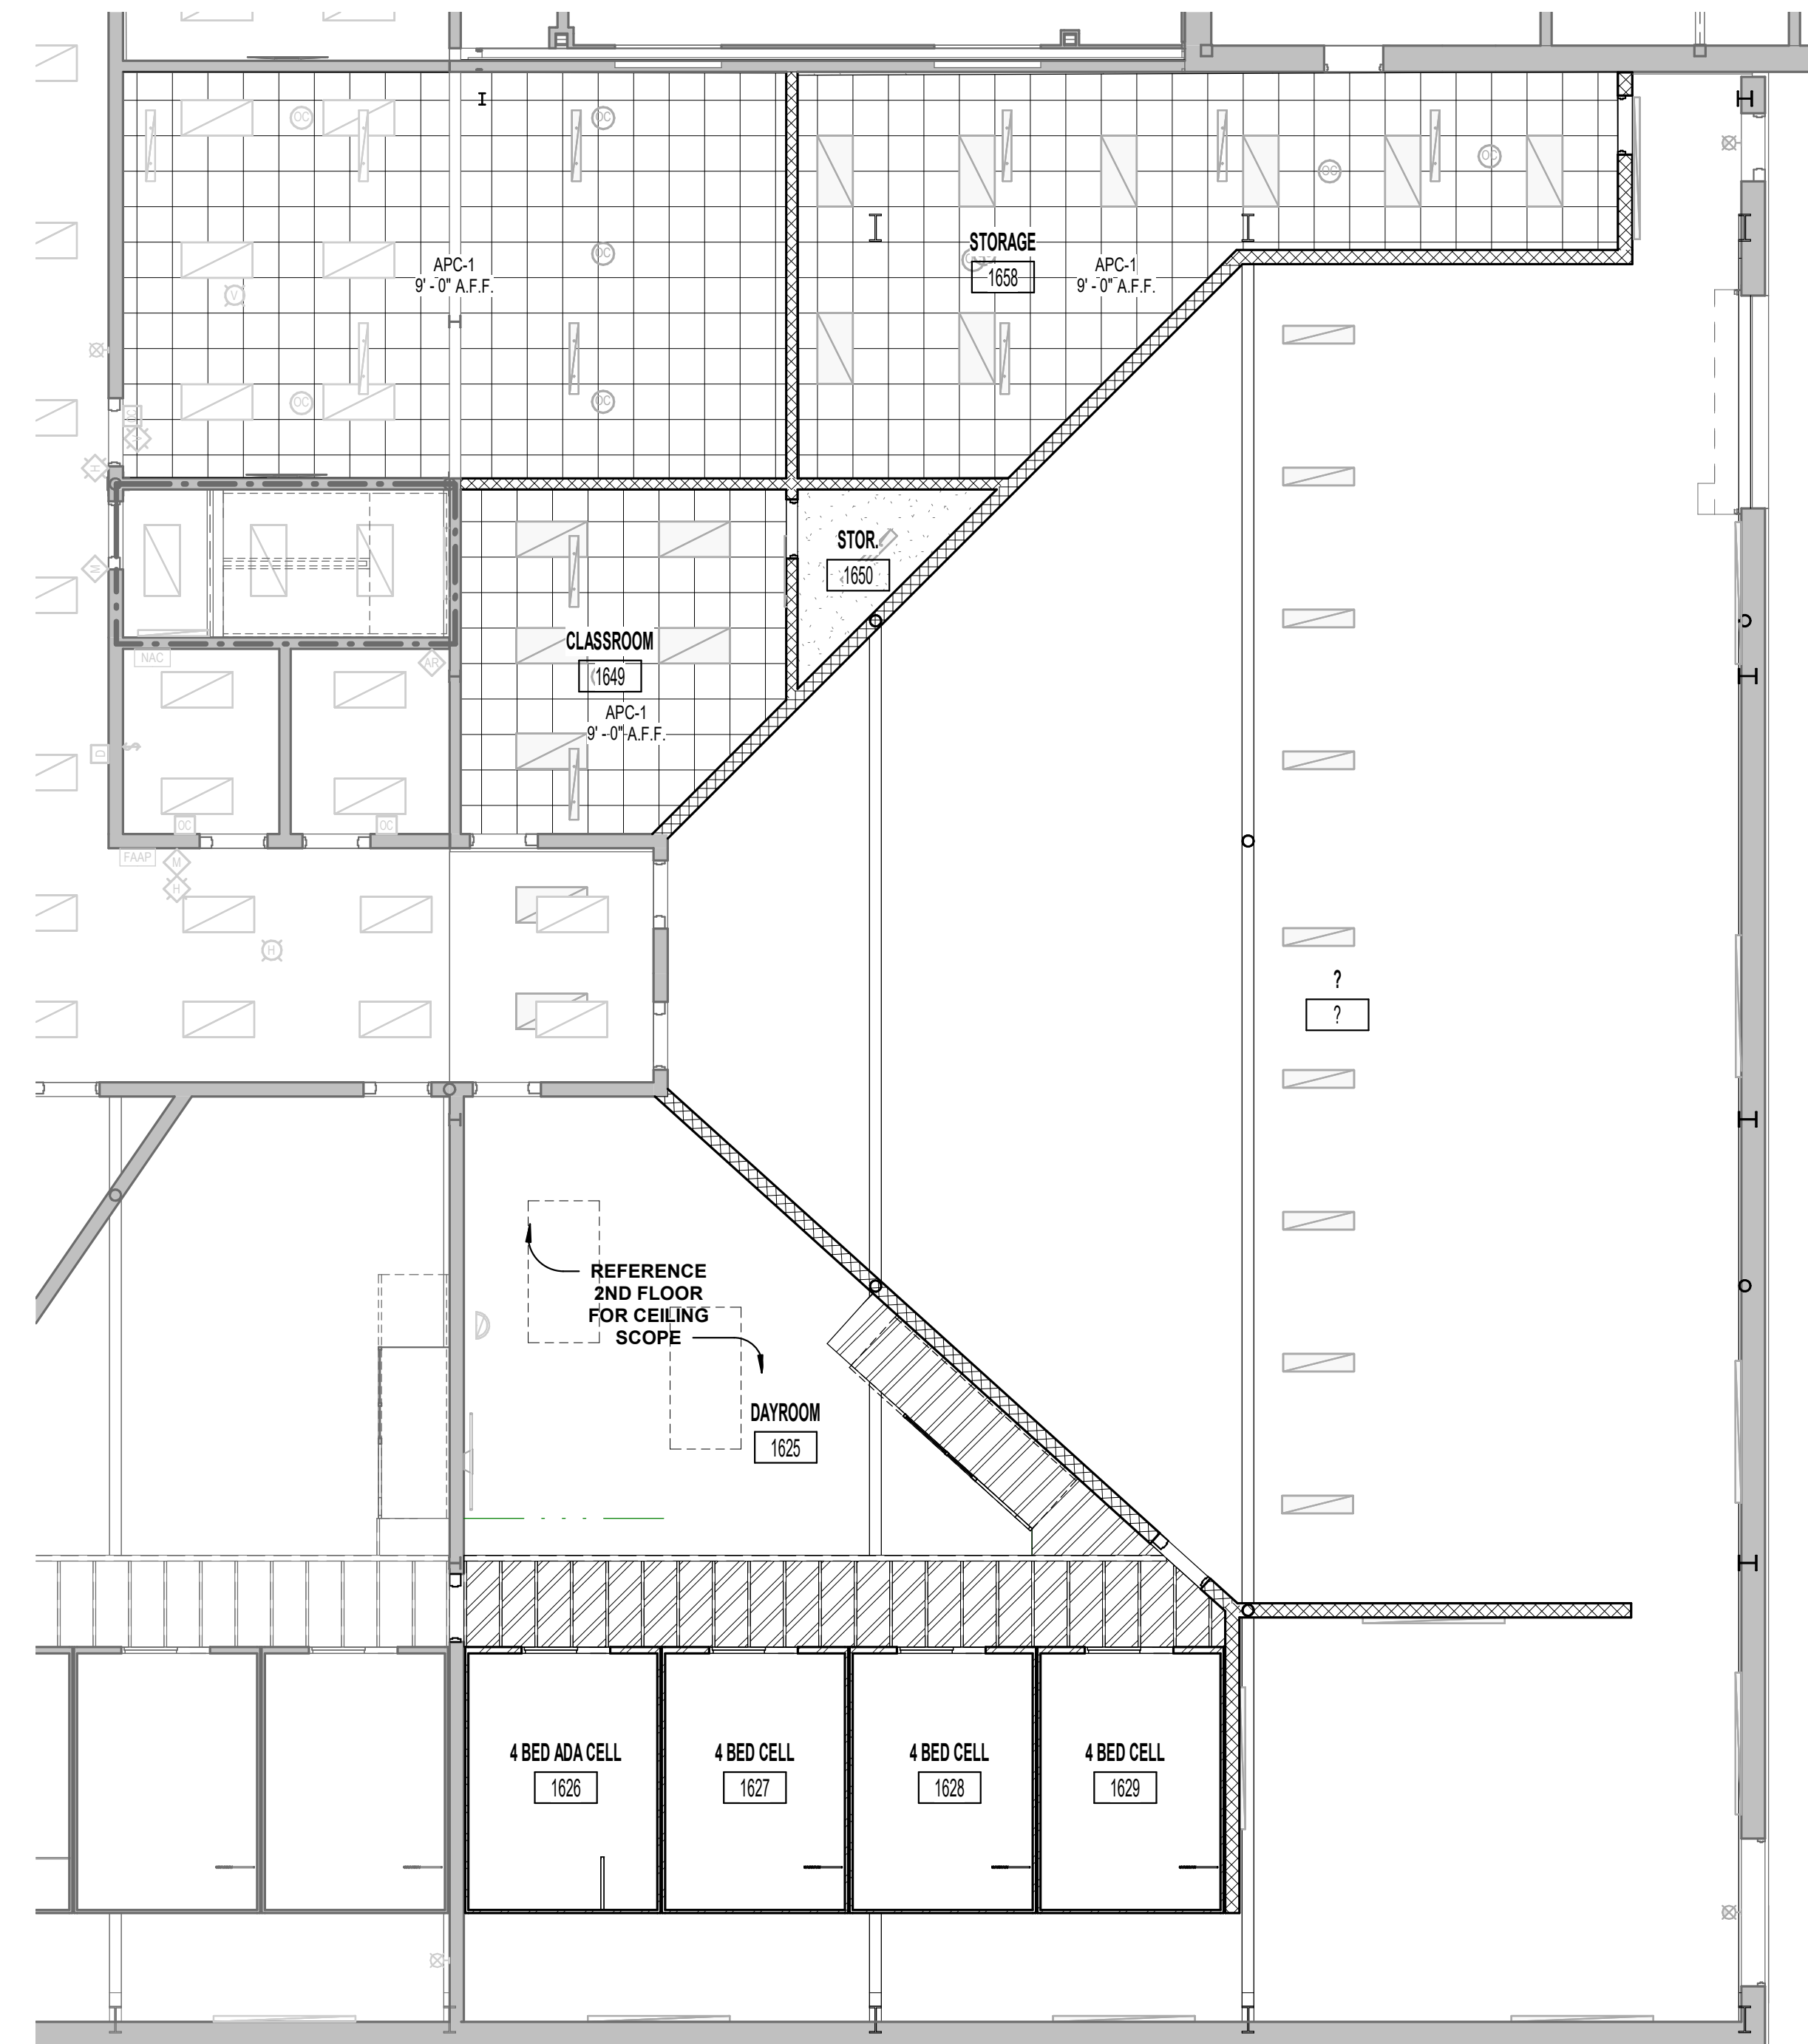

**5E** FIRST FLOOR REFLECTED CEILING PLAN BUILDING 1 - UNIT A ALTERNATE "A"  
1/8" = 1'-0"

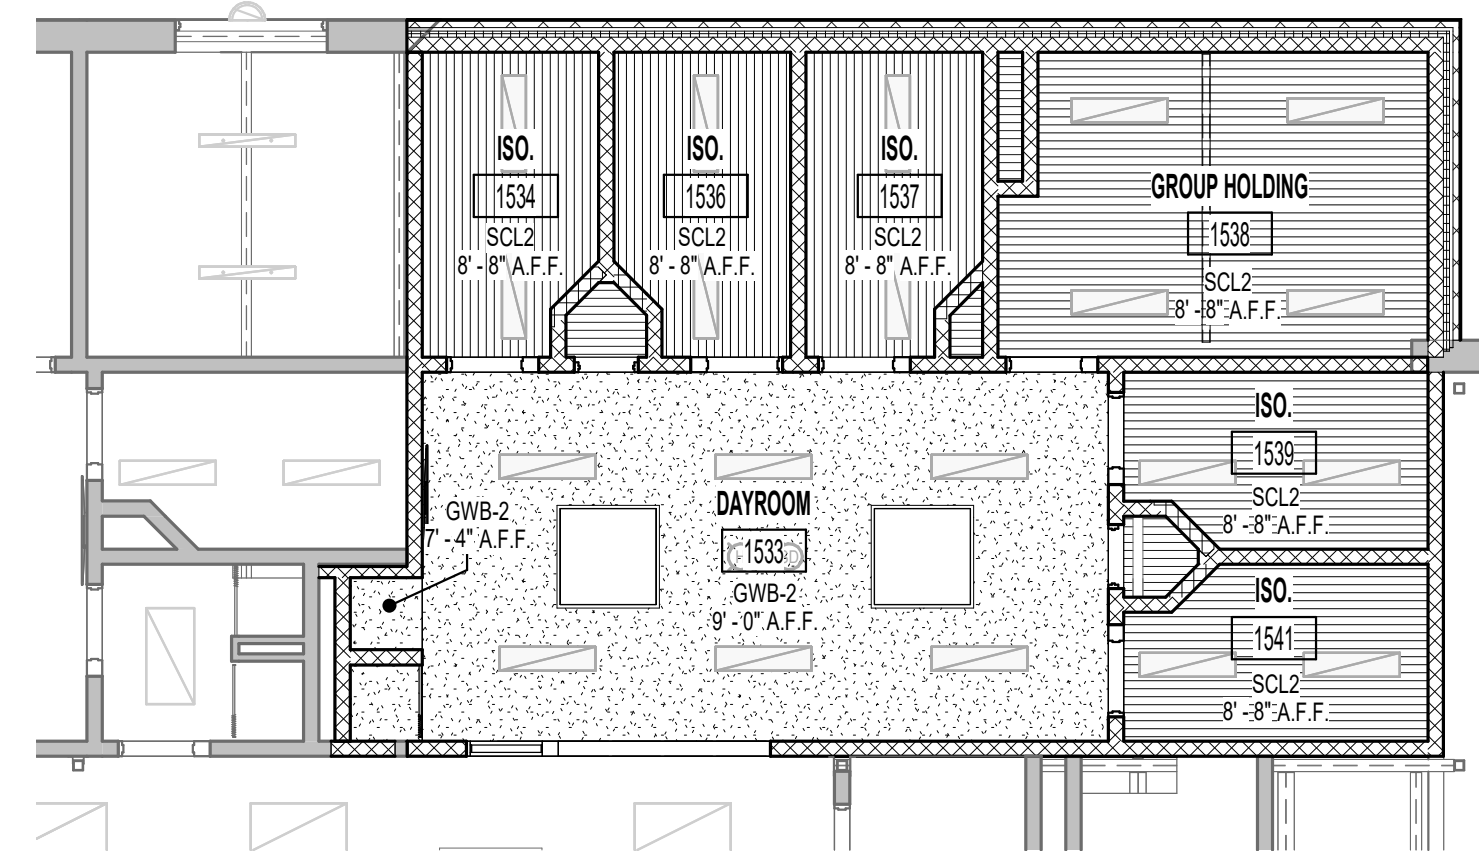

**5C** FIRST FLOOR REFLECTED CEILING PLAN BUILDING 1 - UNIT D ALTERNATE "D2"  
1/8" = 1'-0"

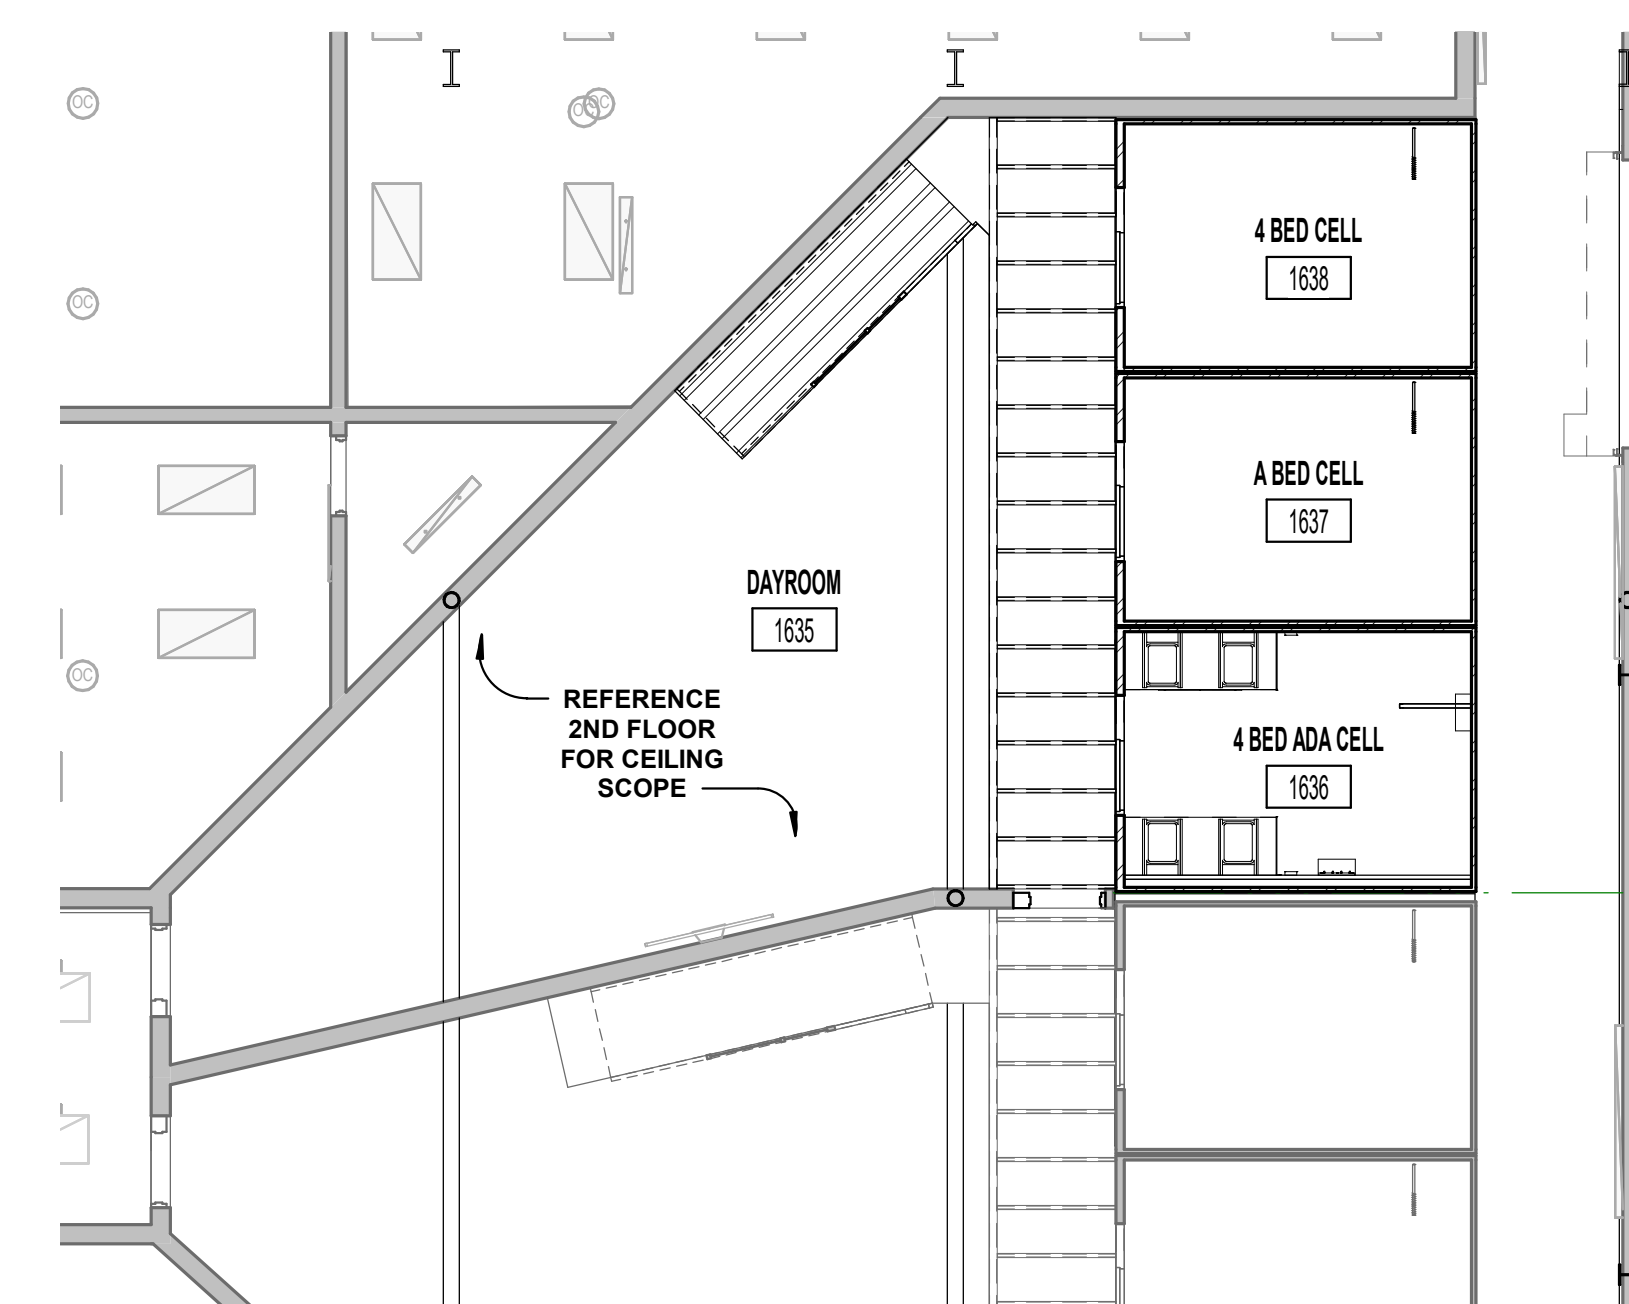

**5A** FIRST FLOOR REFLECTED CEILING PLAN BUILDING 1 - UNIT D ALTERNATE "D3"  
1/8" = 1'-0"




#	Revision	Date
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Project #: 20-700-151-2  
Designed By: LD/SP  
Drawn By: CP  
Checked By: CP  
Date: 01.28.2022



*Eric Wepler*


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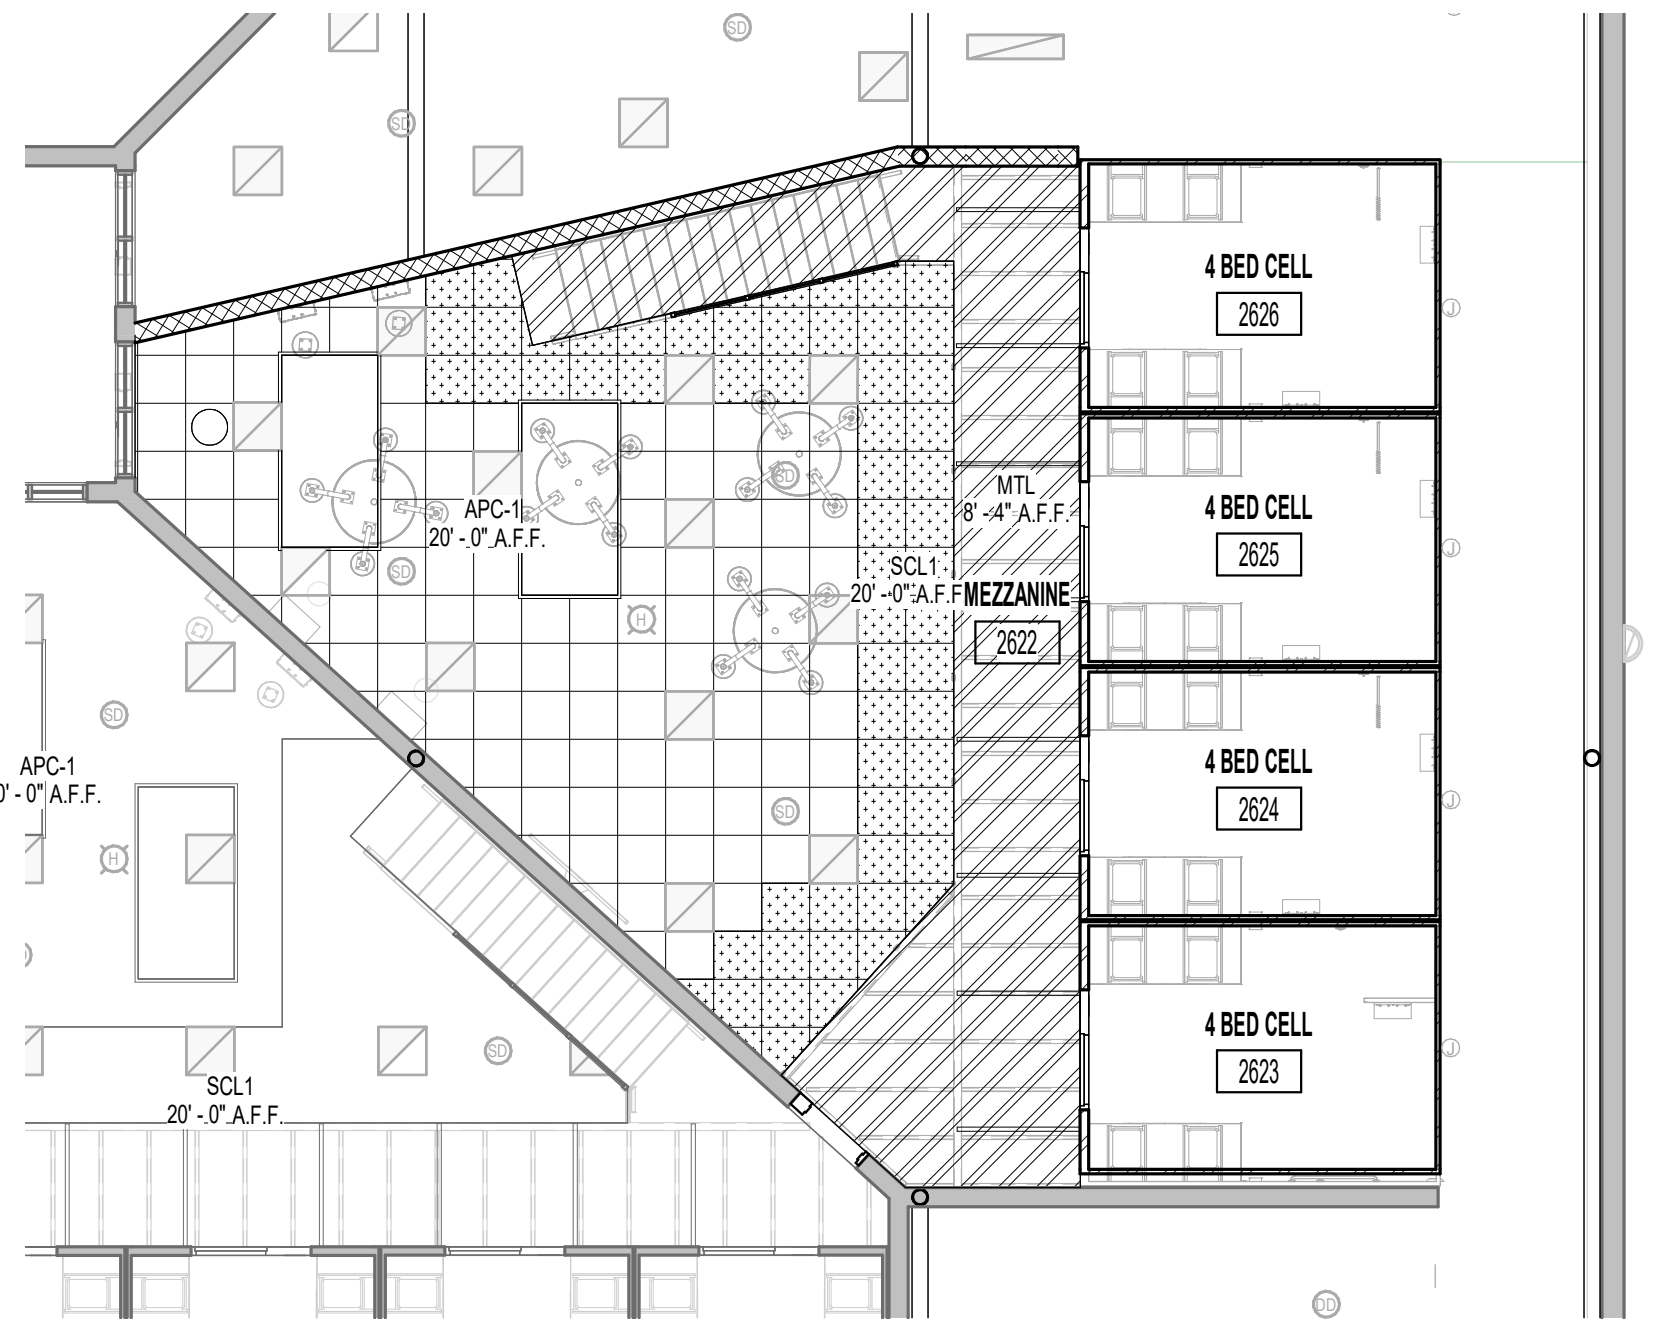
ALTERNATE SECOND  
FLOOR CEILING PLAN

AC ALT  
D1-D3

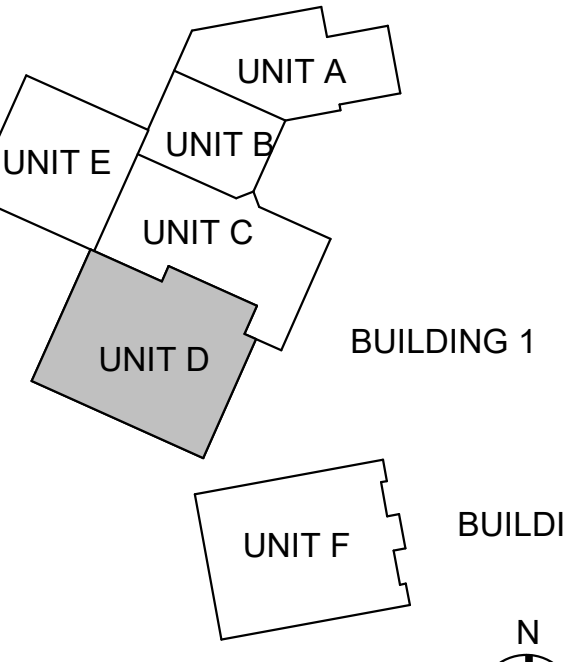
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2C SECOND FLOOR REFLECTED CEILING PLAN - UNIT D ALTERNATE "D1"  
1/8" = 1'-0"




2A SECOND FLOOR REFLECTED CEILING PLAN - UNIT D ALTERNATE "D2"  
1/8" = 1'-0"

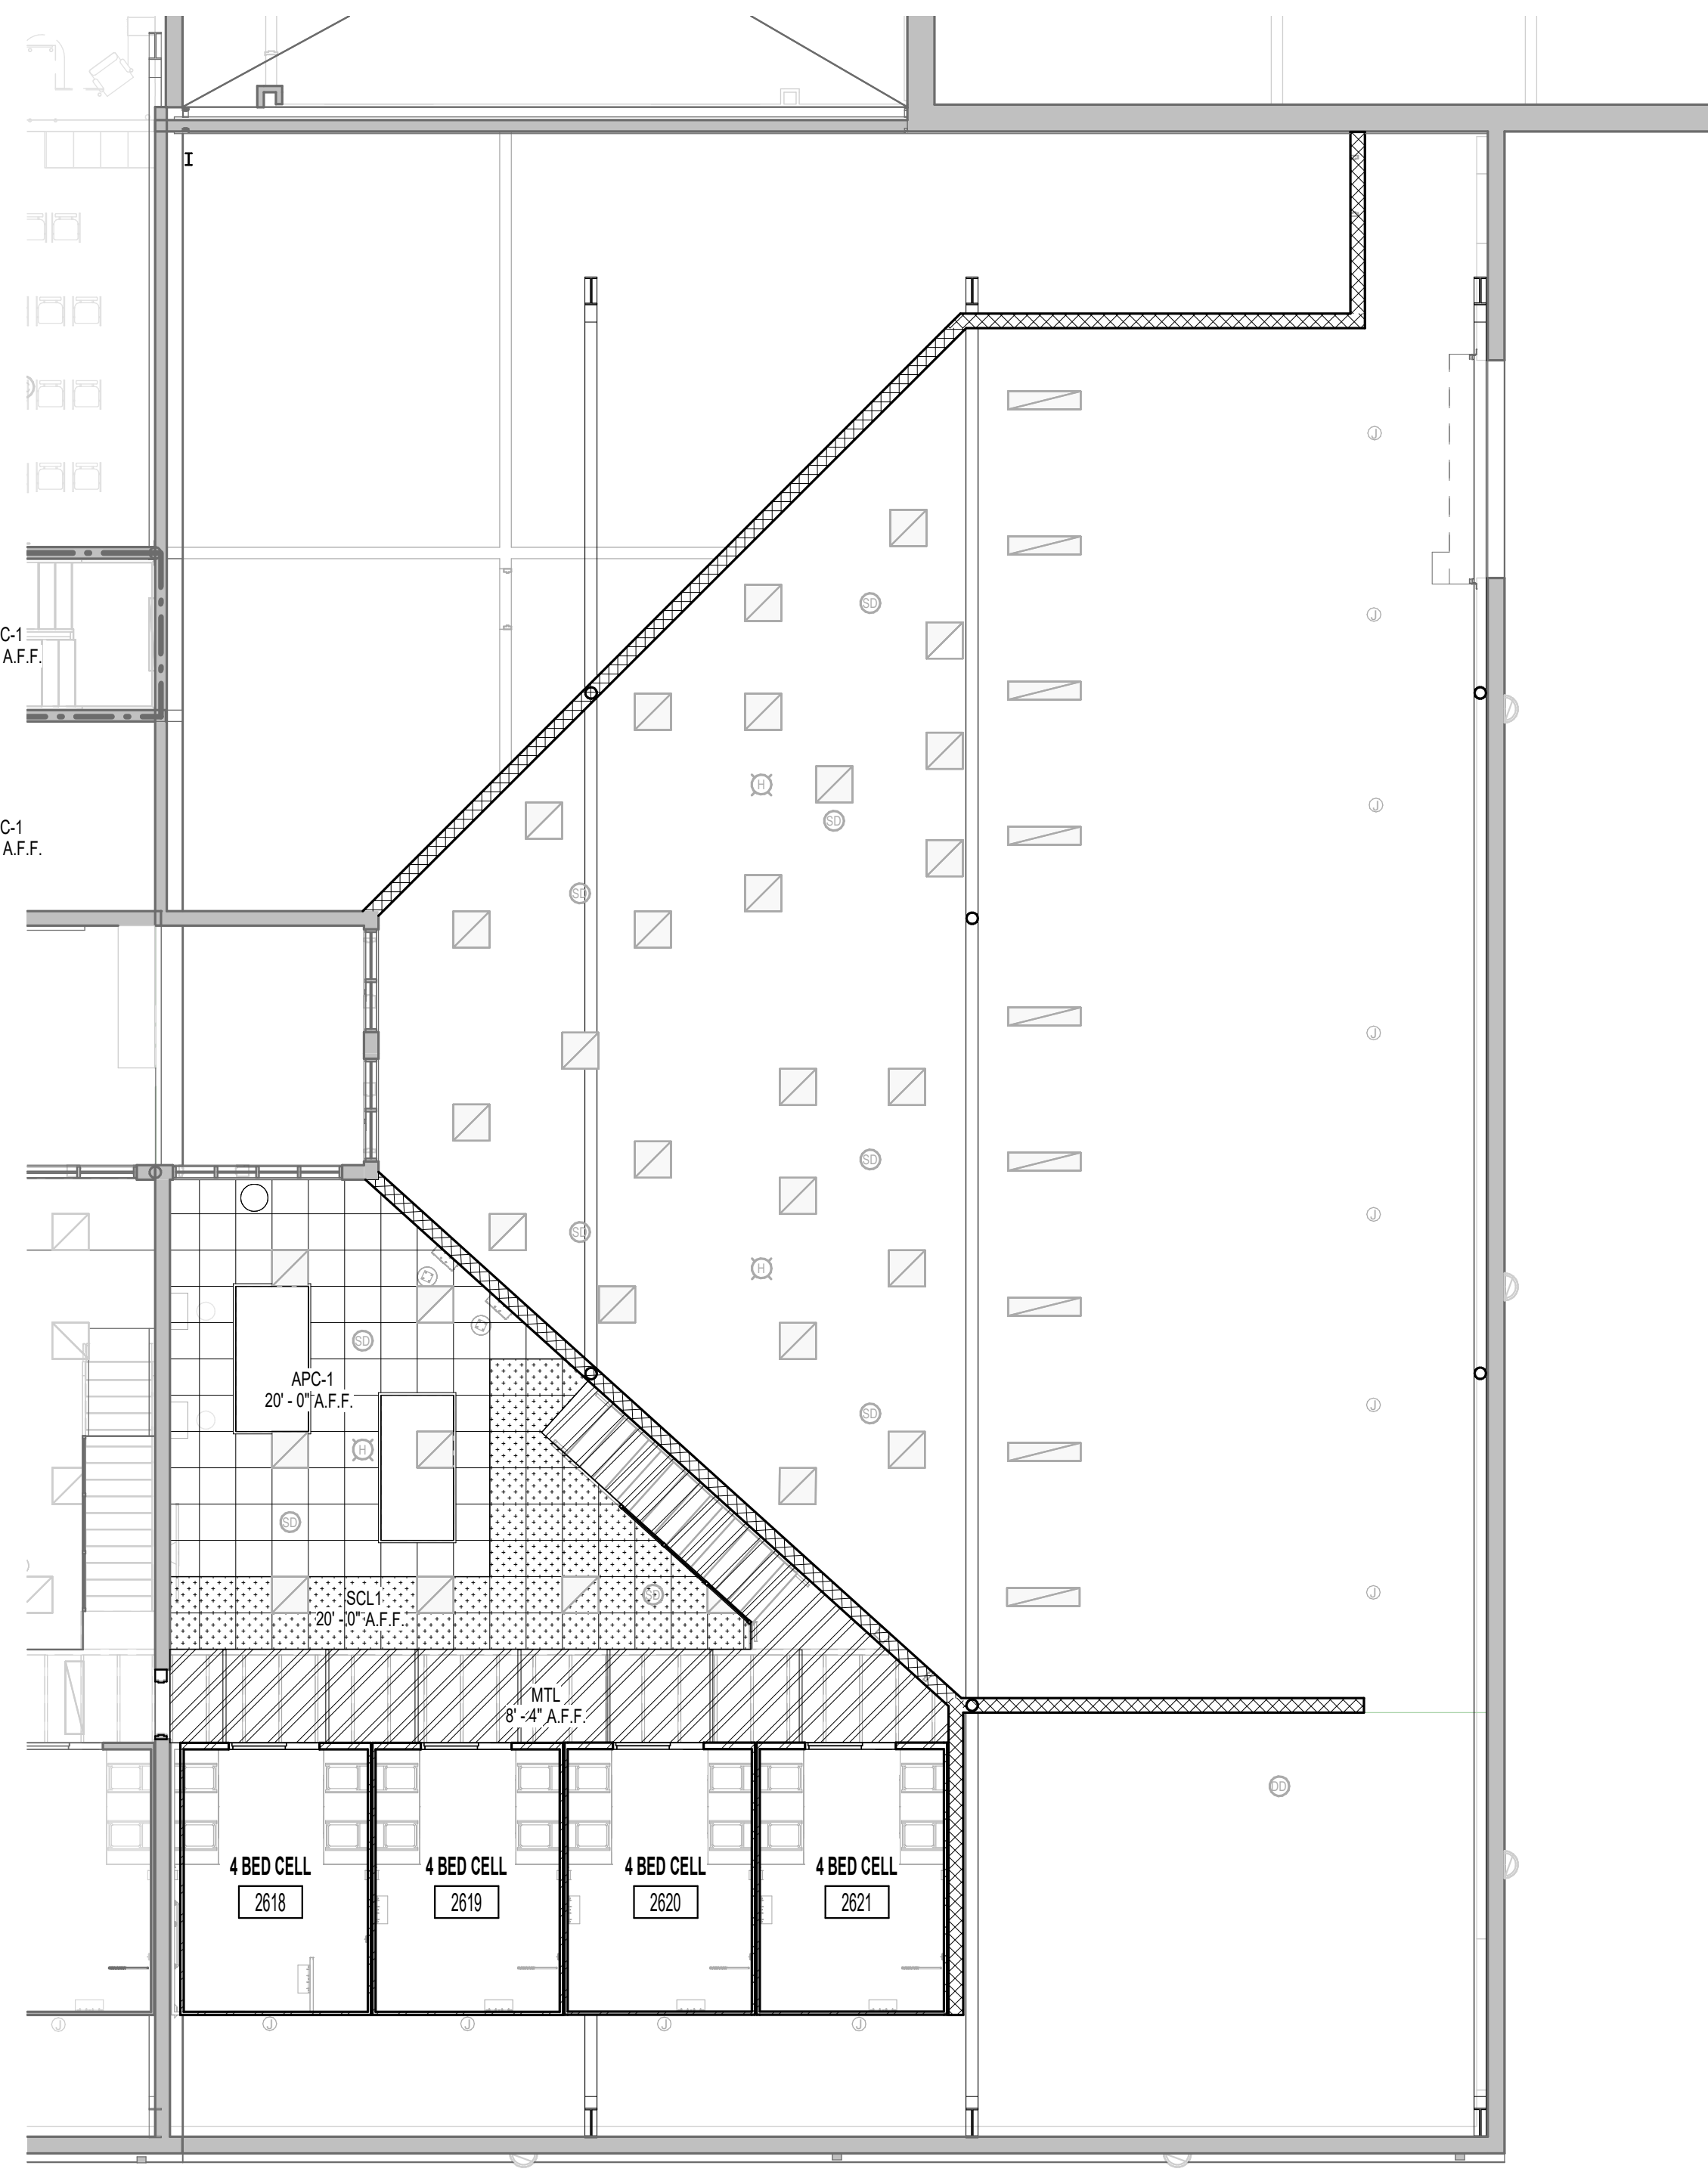

5A SECOND FLOOR REFLECTED CEILING PLAN - UNIT D ALTERNATE "D3"  
1/8" = 1'-0"

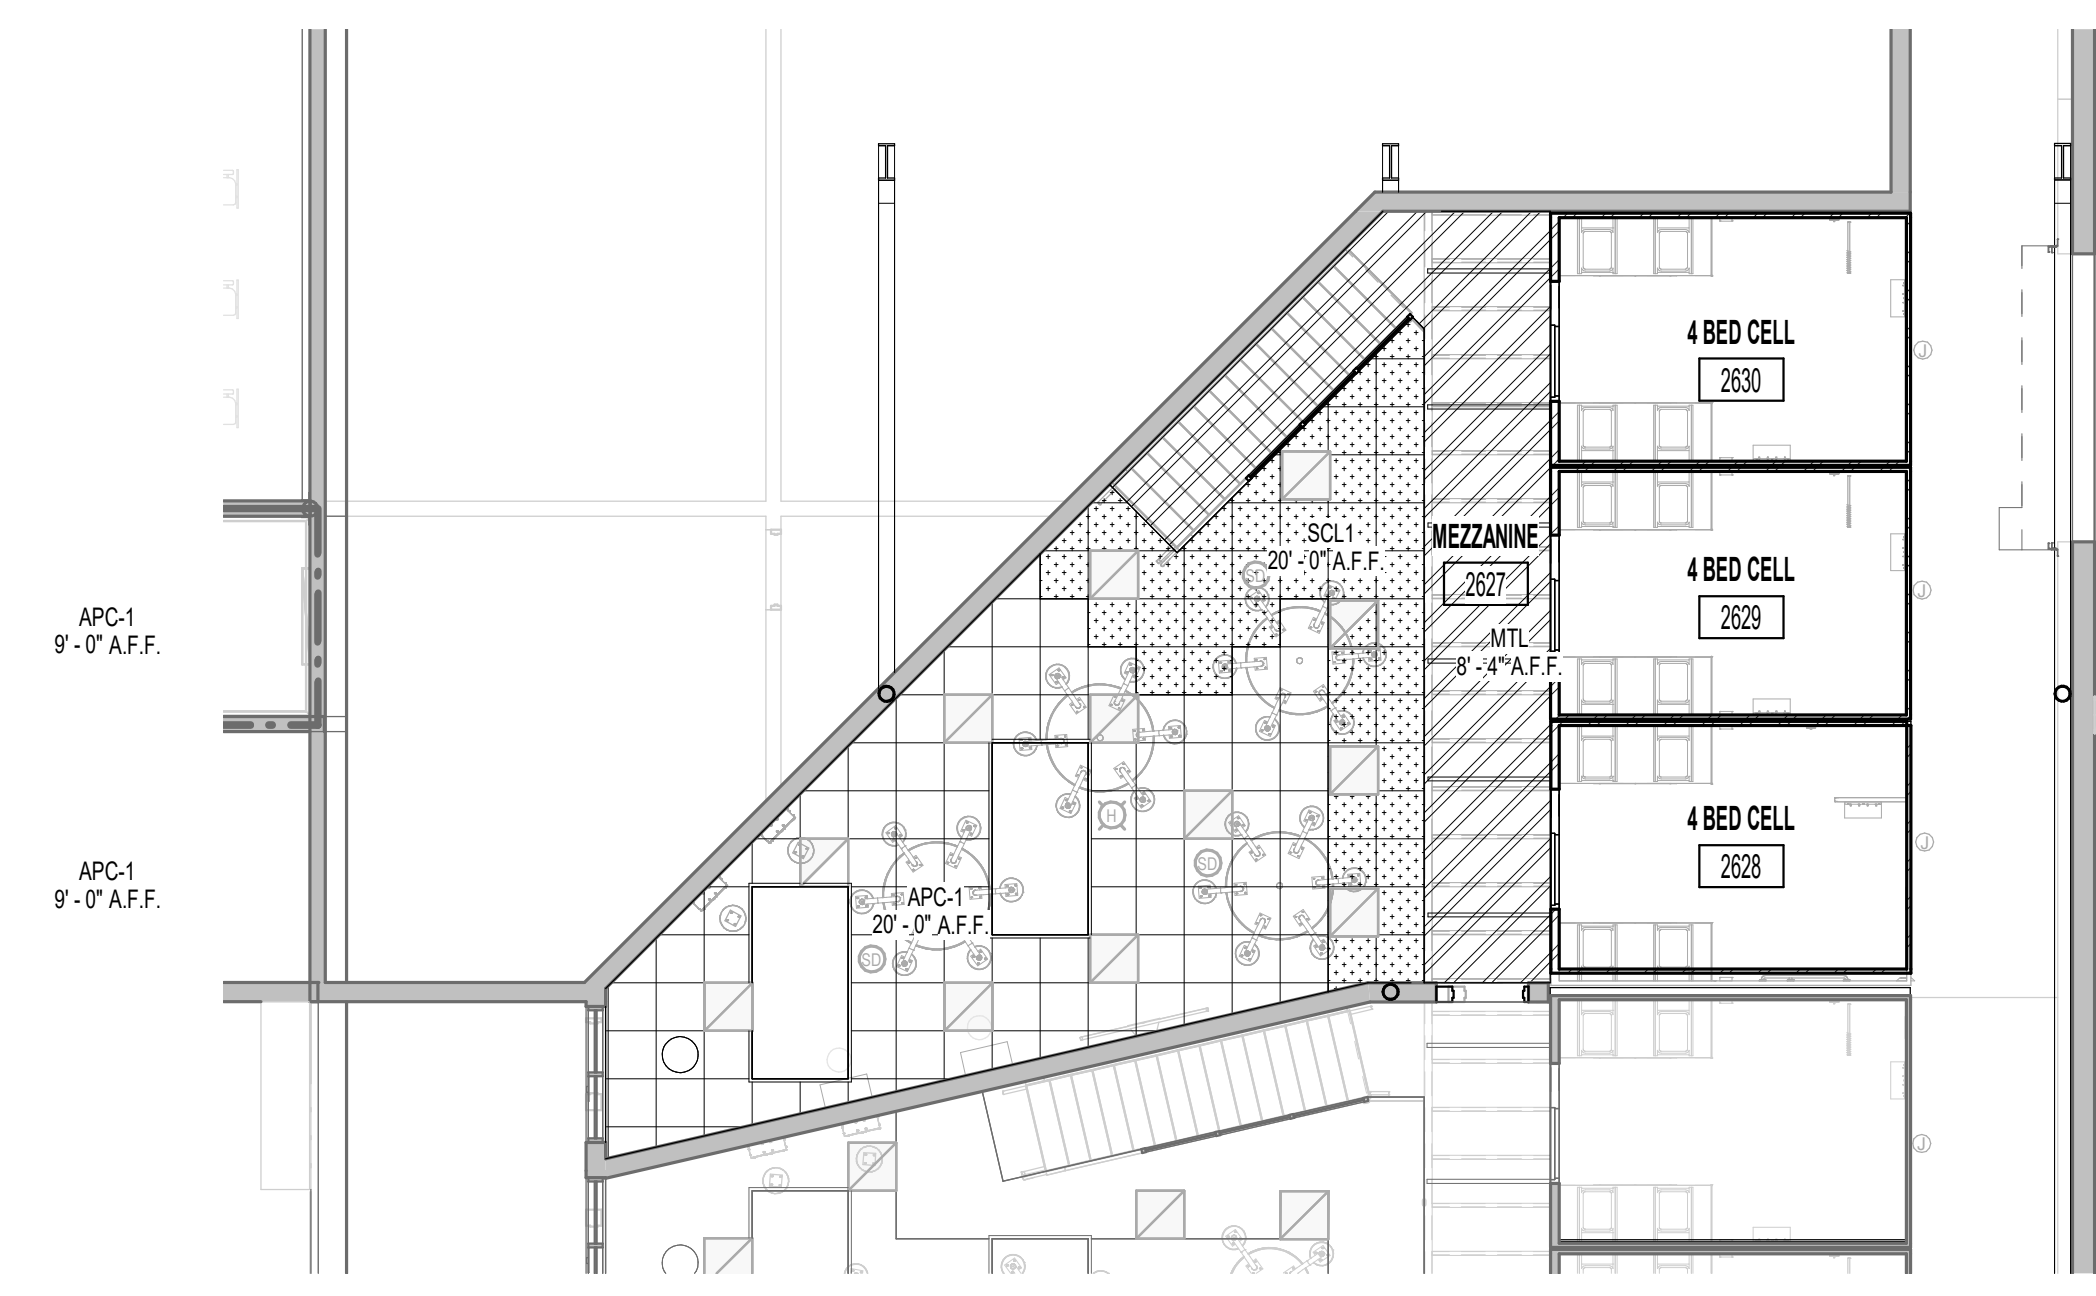

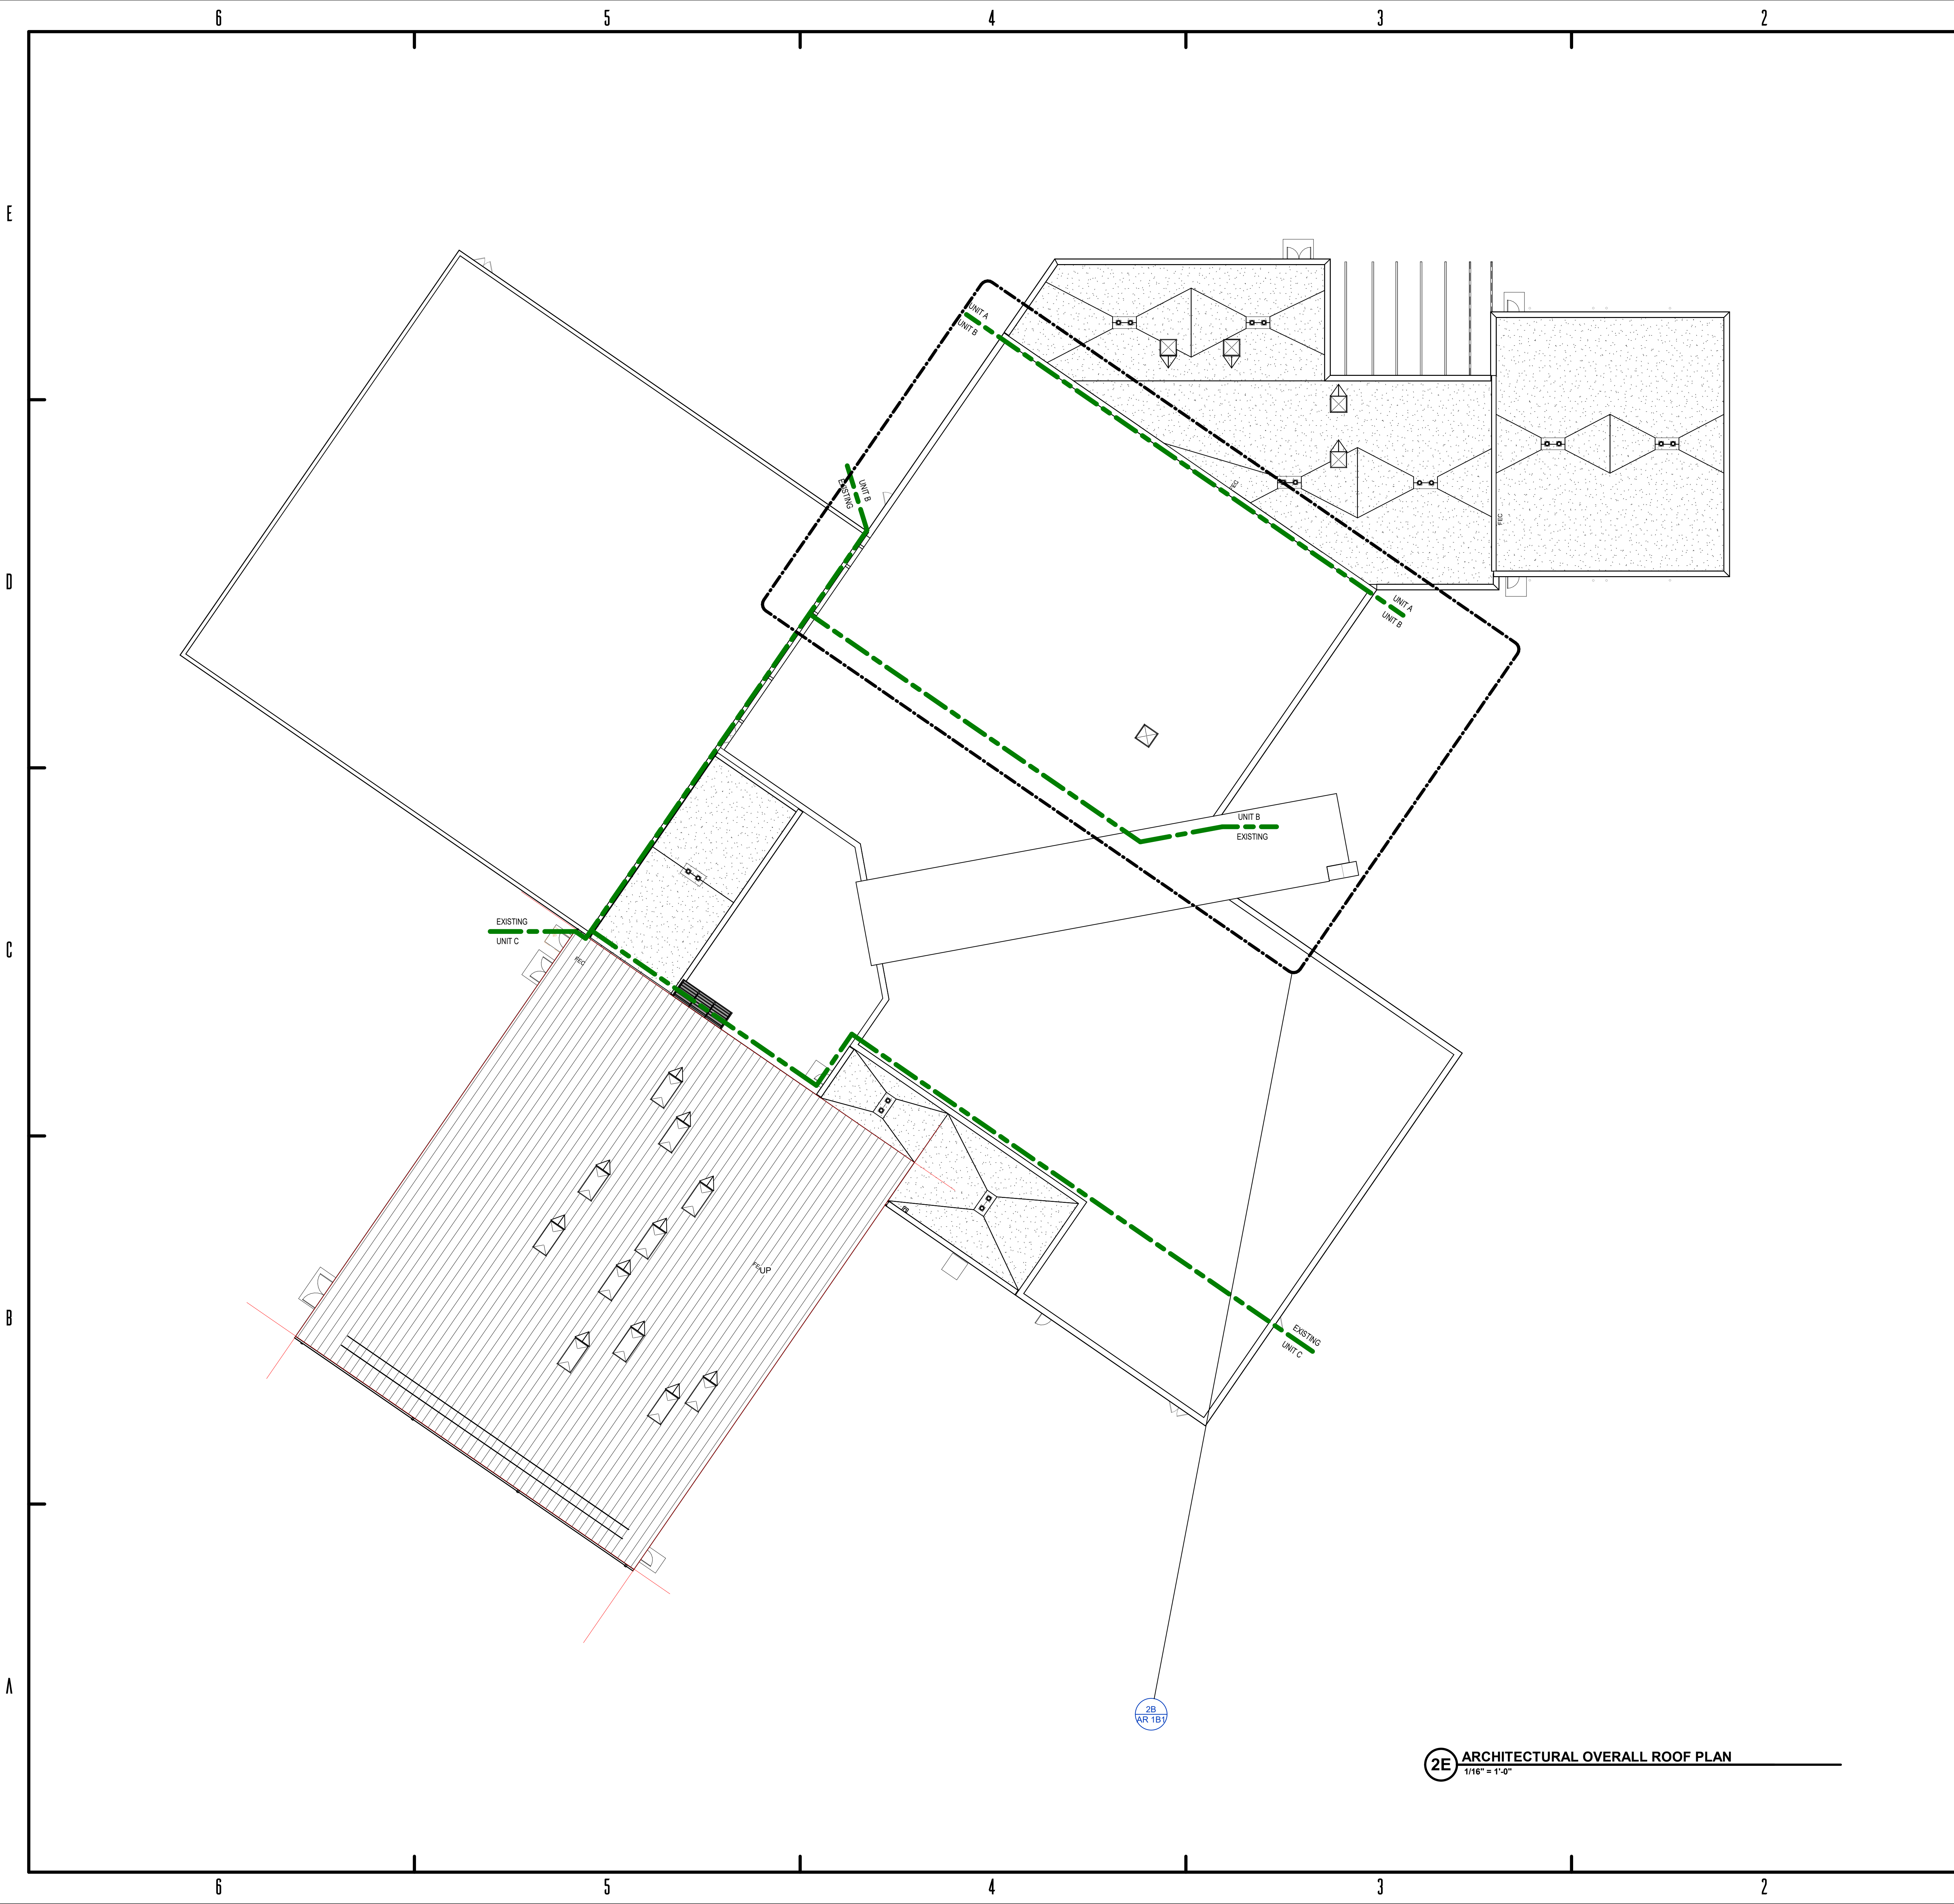

2E ARCHITECTURAL OVERALL ROOF PLAN  
1/16" = 1'-0"

GENERAL ROOF PLAN NOTES

1. Roof to be installed to achieve positive drainage with a minimum resultant slope of 1/4" per foot, unless indicated otherwise. Provide "crickets or saddles" at all roof curbs to allow for positive drainage.
2. Low slope roof areas shall have a minimum of 4" rigid insulation over roof deck. Saddles, crickets, and slope portions of flat roof deck shall be formed by tapered insulation. Areas where tapered insulation is anticipated have been indicated, but shall not be considered all inclusive. It is Contractor's responsibility to provide sloped surfaces to achieve proper drainage.
3. Roof penetrations and equipment shown shall not be considered all inclusive. Coordinate with Mechanical, Plumbing and Electrical Documents to confirm penetrations and equipment locations. Flash all roof penetrations in accordance with roofing manufacturer's recommendations. Provide crickets to allow for proper drainage around units.
4. Roof walkway pads or blocks shall be installed in accordance with roofing manufacturer's recommendation where indicated and around entire perimeter of rooftop equipment.
5. All roof systems are "Roof Type A" except where noted otherwise.

5.4.140 - ROOF PLAN NOTES


Key	Note
1	MANUFACTURED METAL COPING, FINISH AS SELECTED BY ARCHITECT
2	13 34 49 - PREENGINEERED METAL BUILDING 4'-0" X 4'-0" SKYLIGHT, SEE DETAIL
3	13 34 49 - PREENGINEERED METAL TYPICAL DOWNSPOUT
4	13 34 49 - PREENGINEERED METAL BUILDING 8'-0" X 4'-0" SKYLIGHT, SEE DETAIL
5	13 34 49 - PREENGINEERED METAL BUILDING TYPICAL GUTTER
6	ENGINEERED MANUFACTURED METAL CANOPY, MAPES STYLE OR EQUAL
7	ICE AND SNOW GUARDS BY ROOF MANUFACTURER, TWO ROWS
8	PREENGINEERED CUSTOM CANOPY FINISH AS SELECTED BY ARCHITECT
9	ENGINEERED METAL CANOPY/LOUVER SUN SHADES
10	MANUFACTURED METAL CANOPY MAPES STYLE OR EQUAL
11	MANUFACTURED ROOF TO WALL EXPANSION JOINT, 4"
12	MANUFACTURED ROOF TO WALL EXPANSION JOINT, 2"
13	CONCRETE BENCH, SEE DETAIL ###




BID SET  
KNOX COUNTY BOARD OF COMMISSIONERS  
KNOX COUNTY JUSTICE CAMPUS  
2375 OLD DECKER RD. VINCENNES, IN 47591

#	Revision	Date
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Project #: 20-700-151-2  
Designed By: LD/SP  
Drawn By: JW/CW  
Checked By: LD/EV  
Date: 01.28.2022

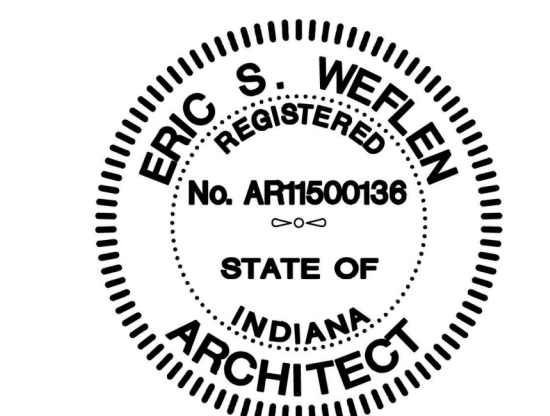


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ARCHITECTURAL ROOF PLAN

AR 100

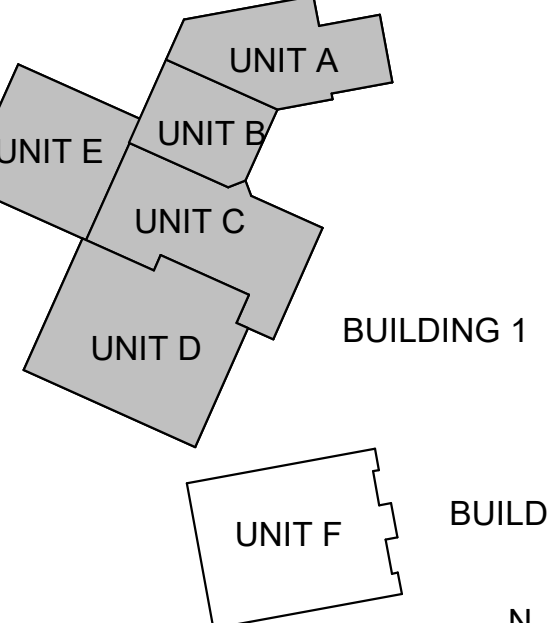



1 ARCHITECTURAL ROOF PLAN UNIT A - ALTERNATE  
1/8" = 1'-0"

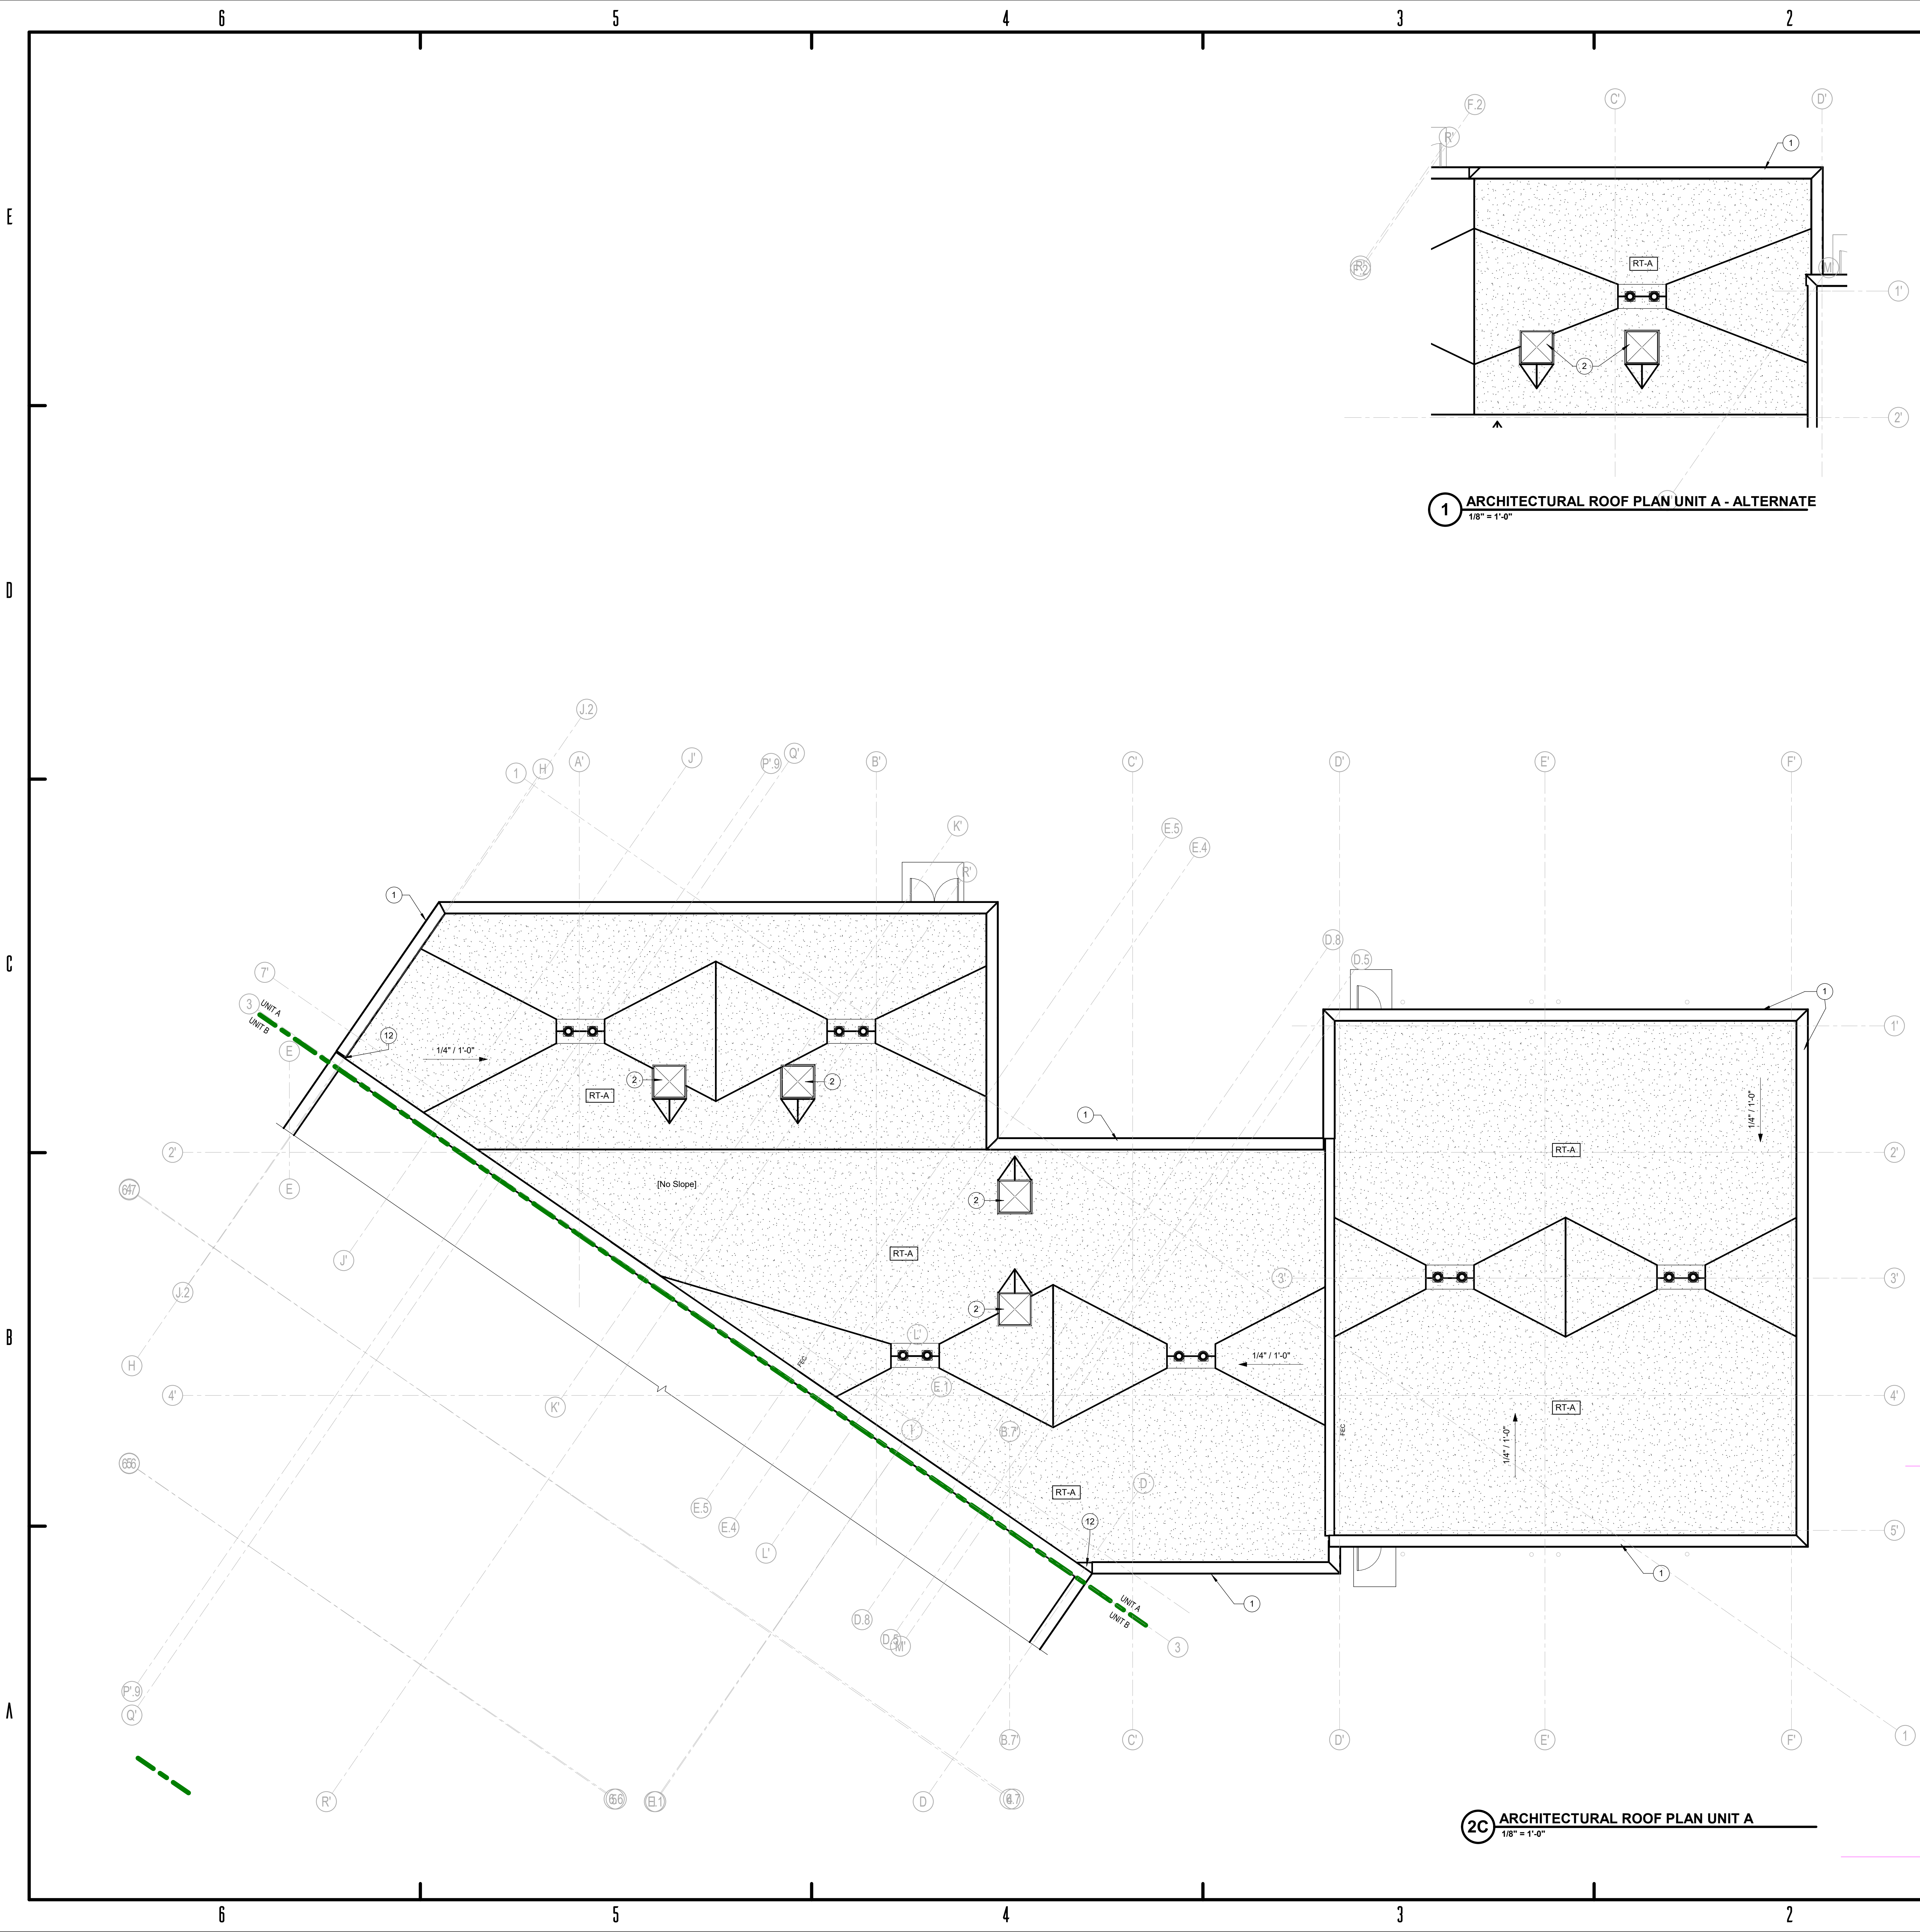
2C ARCHITECTURAL ROOF PLAN UNIT A  
1/8" = 1'-0"

GENERAL ROOF PLAN NOTES


1. Roof to be installed to achieve positive drainage with a minimum resultant slope of 1/4" per foot, unless indicated otherwise. Provide "crickets or saddles" at all roof curbs to allow for positive drainage.
2. Low slope roof areas shall have a minimum of 4" rigid insulation over roof deck. Saddles, crickets, and slope portions of flat roof deck shall be formed by tapered insulation. Areas where tapered insulation is anticipated have been indicated, but shall not be considered all inclusive. It is Contractor's responsibility to provide sloped surfaces to achieve proper drainage.
3. Roof penetrations and equipment shown shall not be considered all inclusive. Coordinate with Mechanical, Plumbing and Electrical Documents to confirm penetrations and equipment locations. Flash all roof penetrations in accordance with roofing manufacturer's recommendations. Provide crickets to allow for proper drainage around units.
4. Roof walkway pads or blocks shall be installed in accordance with roofing manufacturer's recommendation where indicated and around entire perimeter of rooftop equipment.
5. All roof systems are "Roof Type A" except where noted otherwise.

5.4.140 - ROOF PLAN NOTES

Key	Note
1	MANUFACTURED METAL COPING, FINISH AS SELECTED BY ARCHITECT
2	13 34 49 - PREENGINEERED METAL BUILDING 4'-0" X 4'-0" SKYLIGHT, SEE DETAIL.
3	13 34 49 - PREENGINEERED METAL TYPICAL DOWNSPOUT
4	13 34 49 - PREENGINEERED METAL BUILDING 8'-0" X 4'-0" SKYLIGHT, SEE DETAIL.
5	13 34 49 - PREENGINEERED METAL BUILDING TYPICAL GUTTER
6	ENGINEERED MANUFACTURED METAL CANOPY, MAPES STYLE OR EQUAL
7	ICE AND SNOW GUARDS BY ROOF MANUFACTURER, TWO ROWS
8	PREENGINEERED CUSTOM CANOPY FINISH AS SELECTED BY ARCHITECT
9	ENGINEERED METAL CANOPY LOUVER SUN SHADES
10	MANUFACTURED METAL CANOPY MAPES STYLE OR EQUAL
11	MANUFACTURED ROOF TO WALL EXPANSION JOINT, 4"
12	MANUFACTURED ROOF TO WALL EXPANSION JOINT, 2"
13	CONCRETE BENCH, SEE DETAIL ###

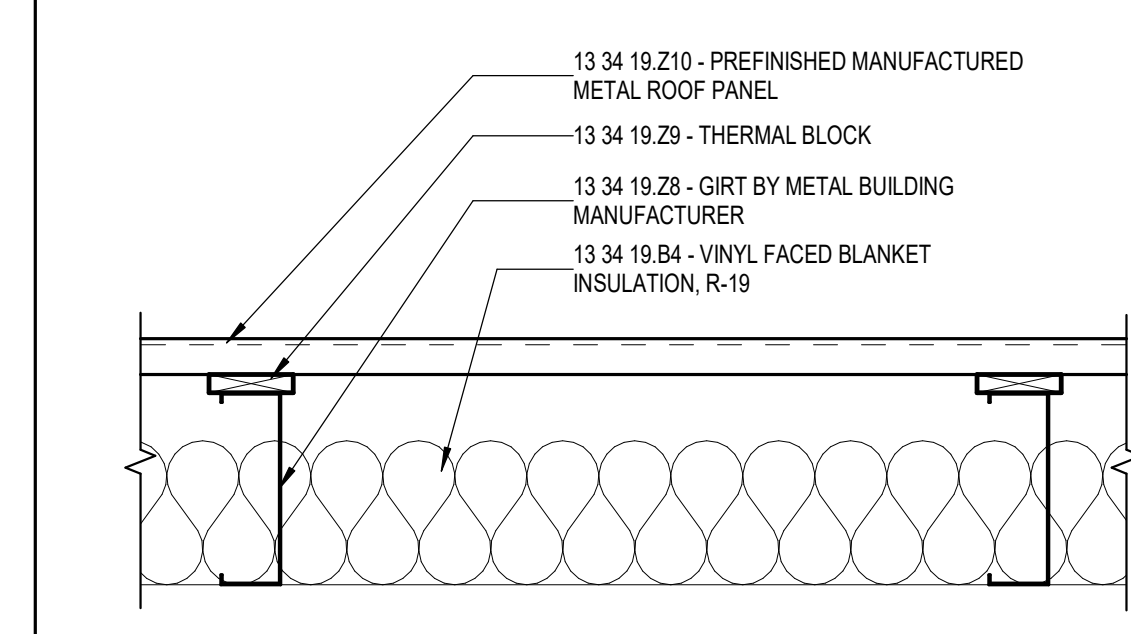

1B ROOF TYPE - RT-C  
1 1/2" = 1'-0"

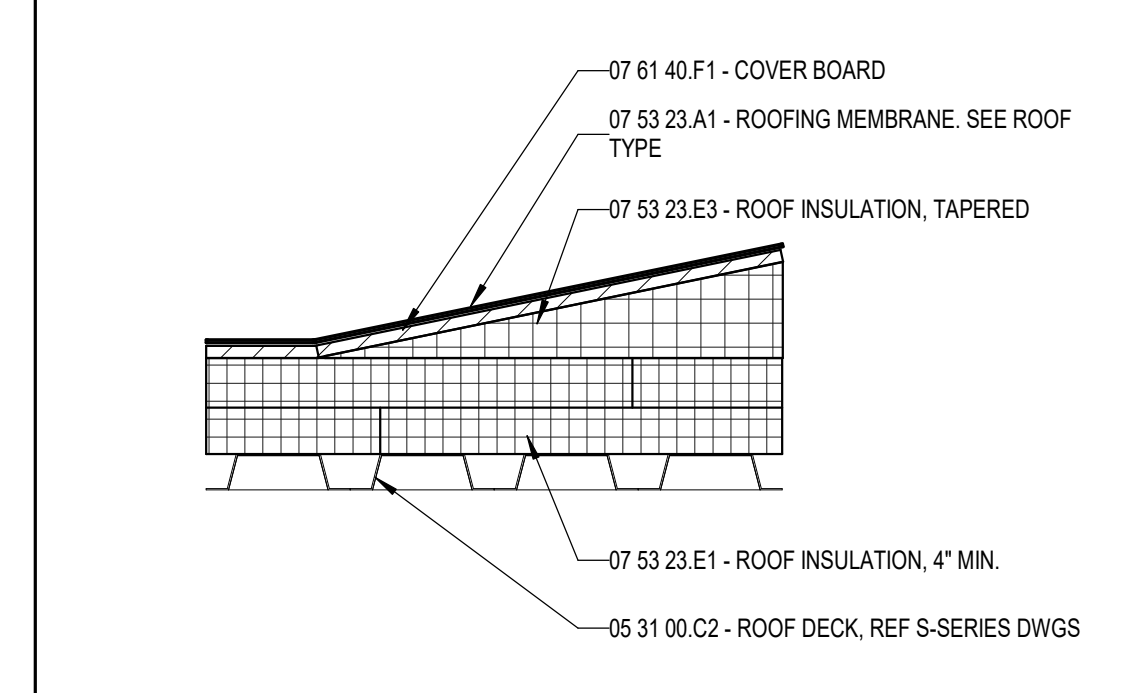

NOTE: PROVIDE 2 LAYERS OF 2" BOARD WITH STAGGERED JOINTS, TYPICAL

1A ROOF TYPE - RT-A  
1 1/2" = 1'-0"

BID SET

KNOX COUNTY BOARD OF COMMISSIONERS

KNOX COUNTY JUSTICE CAMPUS

2375 OLD DECKER RD. VINCENNES, IN 47591

#	Revision	Date

Project #: 20-700-151-2

Designed By: LD/SP

Drawn By: CW

Checked By: LD/EV


Date: 01.28.2022

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ARCHITECTURAL ROOF PLAN UNIT A

AR 1A1



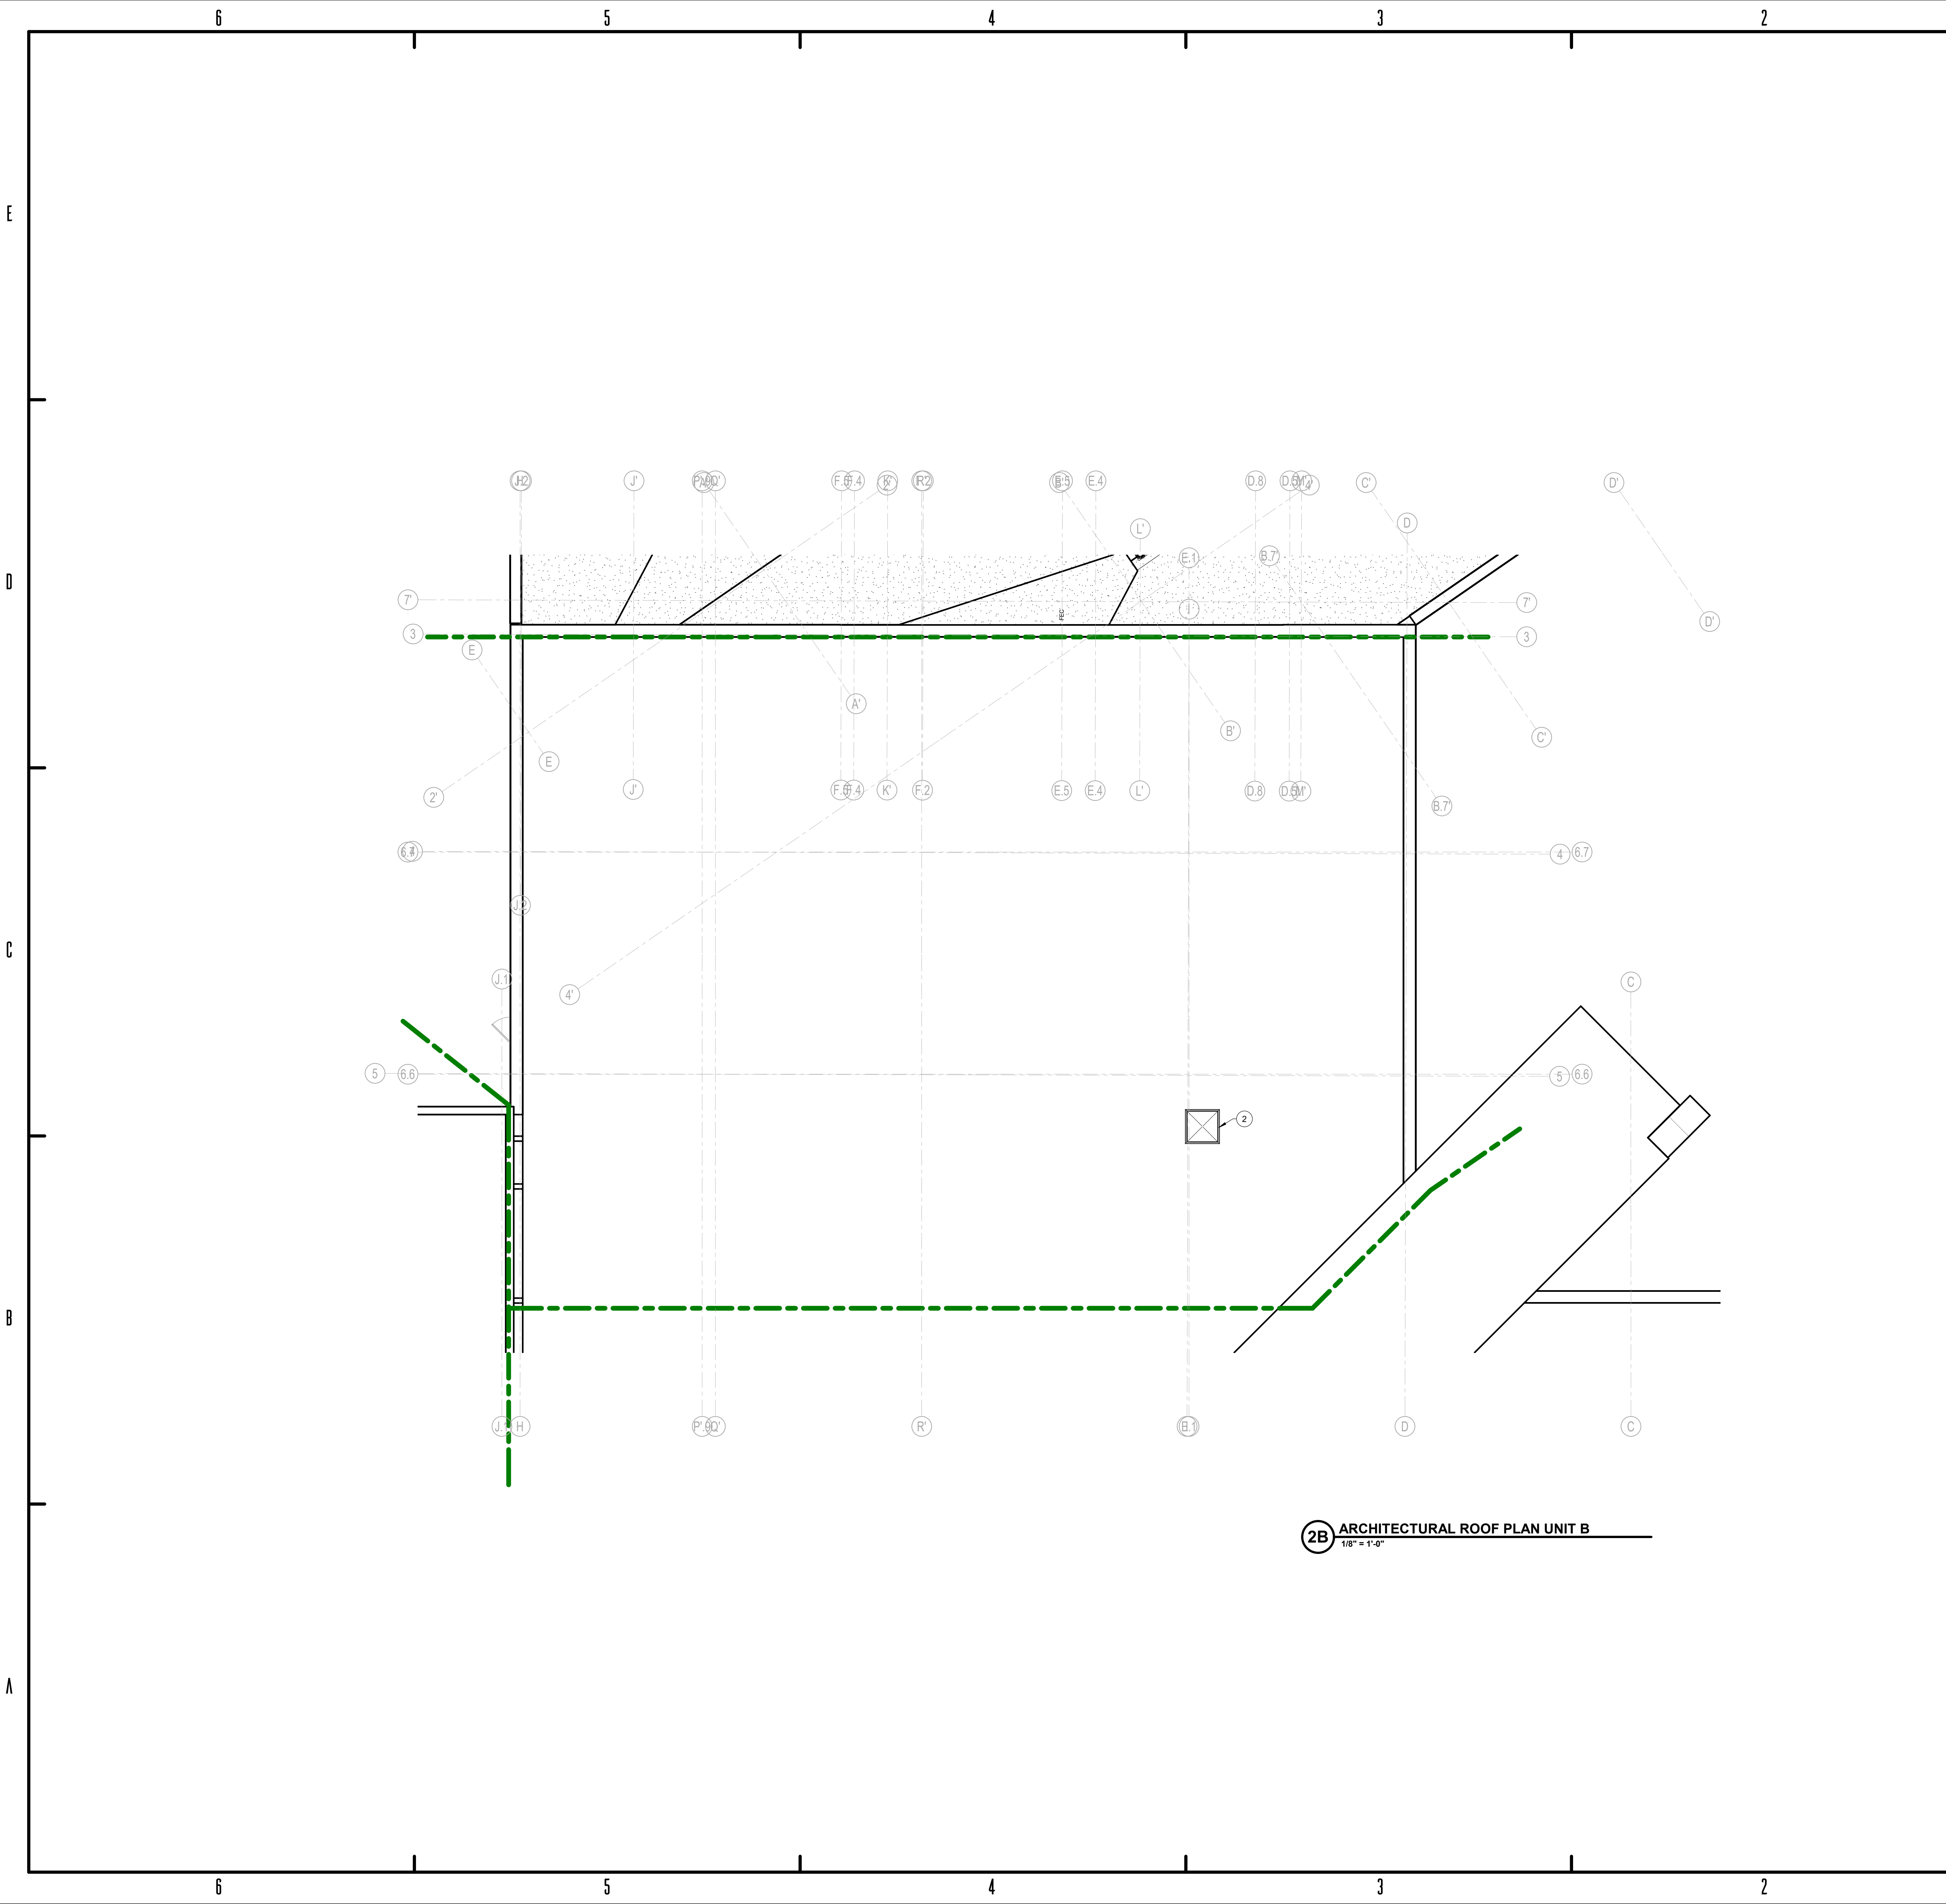


## GENERAL ROOF PLAN NOTES


1. Roof to be installed to achieve positive drainage with a minimum resultant slope of 1/4" per foot, unless indicated otherwise. Provide "creeks or saddles" at all roof curbs to allow for positive drainage.
2. Low slope roof areas shall have a minimum of 4" rigid insulation over roof deck. Saddles, creeks, and slope portions of flat roof deck shall be formed by tapered insulation. Areas where tapered insulation is anticipated have been indicated, but shall not be considered all inclusive. It is Contractor's responsibility to provide sloped surfaces to achieve proper drainage.
3. Roof penetrations and equipment shown shall not be considered all inclusive. Coordinate with Mechanical, Plumbing and Electrical Documents to confirm penetrations and equipment locations. Flash all roof penetrations in accordance with roofing manufacturer's recommendations. Provide creeks to allow for proper drainage around units.
4. Roof walkway pads or blocks shall be installed in accordance with roofing manufacturer's recommendation where indicated and around entire perimeter of rooftop equipment.
5. All roof systems are "Roof Type A" except where noted otherwise.

## 5.4.140 - ROOF PLAN NOTES

Key	Note
1	MANUFACTURED METAL COPING, FINISH AS SELECTED BY ARCHITECT
2	13 34 49 - PREENGINEERED METAL BUILDING 4'-0" X 4'-0" SKYLIGHT, SEE DETAIL.
3	13 34 49 - PREENGINEERED METAL TYPICAL DOWNSPOUT
4	13 34 49 - PREENGINEERED METAL BUILDING 8'-0" X 4'-0" SKYLIGHT, SEE DETAIL.
5	13 34 49 - PREENGINEERED METAL BUILDING TYPICAL GUTTER
6	ENGINEERED MANUFACTURED METAL CANOPY, MAPES STYLE OR EQUAL
7	ICE AND SNOW GUARDS BY ROOF MANUFACTURER, TWO ROWS
8	PREENGINEERED CUSTOM CANOPY FINISH AS SELECTED BY ARCHITECT
9	ENGINEERED METAL CANOPY/LOUVER SUN SHADES
10	MANUFACTURED METAL CANOPY MAPES STYLE OR EQUAL
11	MANUFACTURED ROOF TO WALL EXPANSION JOINT, 4"
12	MANUFACTURED ROOF TO WALL EXPANSION JOINT, 2"
13	CONCRETE BENCH SEE DETAIL ###

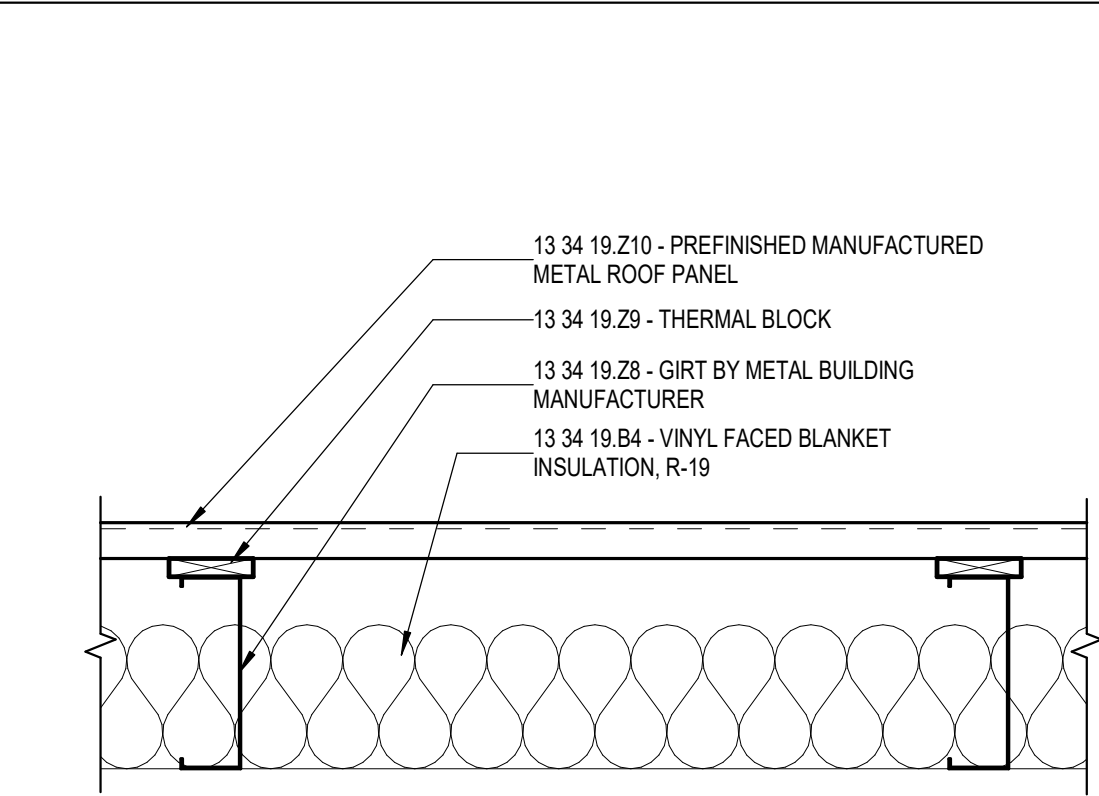

**1B ROOF TYPE - RT-C**  
1 1/2" = 1'-0"

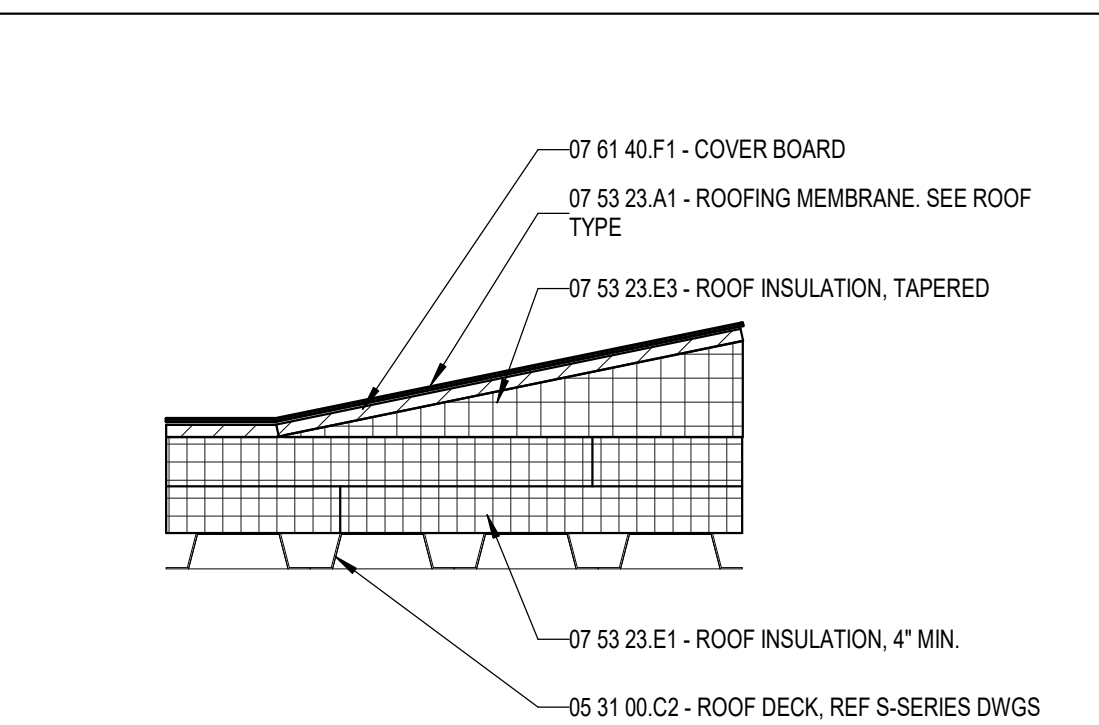


NOTE: PROVIDE 2 LAYERS OF 2" BOARD WITH STAGGERED JOINTS, TYPICAL


**1A ROOF TYPE - RT-A**  
1 1/2" = 1'-0"

#	Revision	Date
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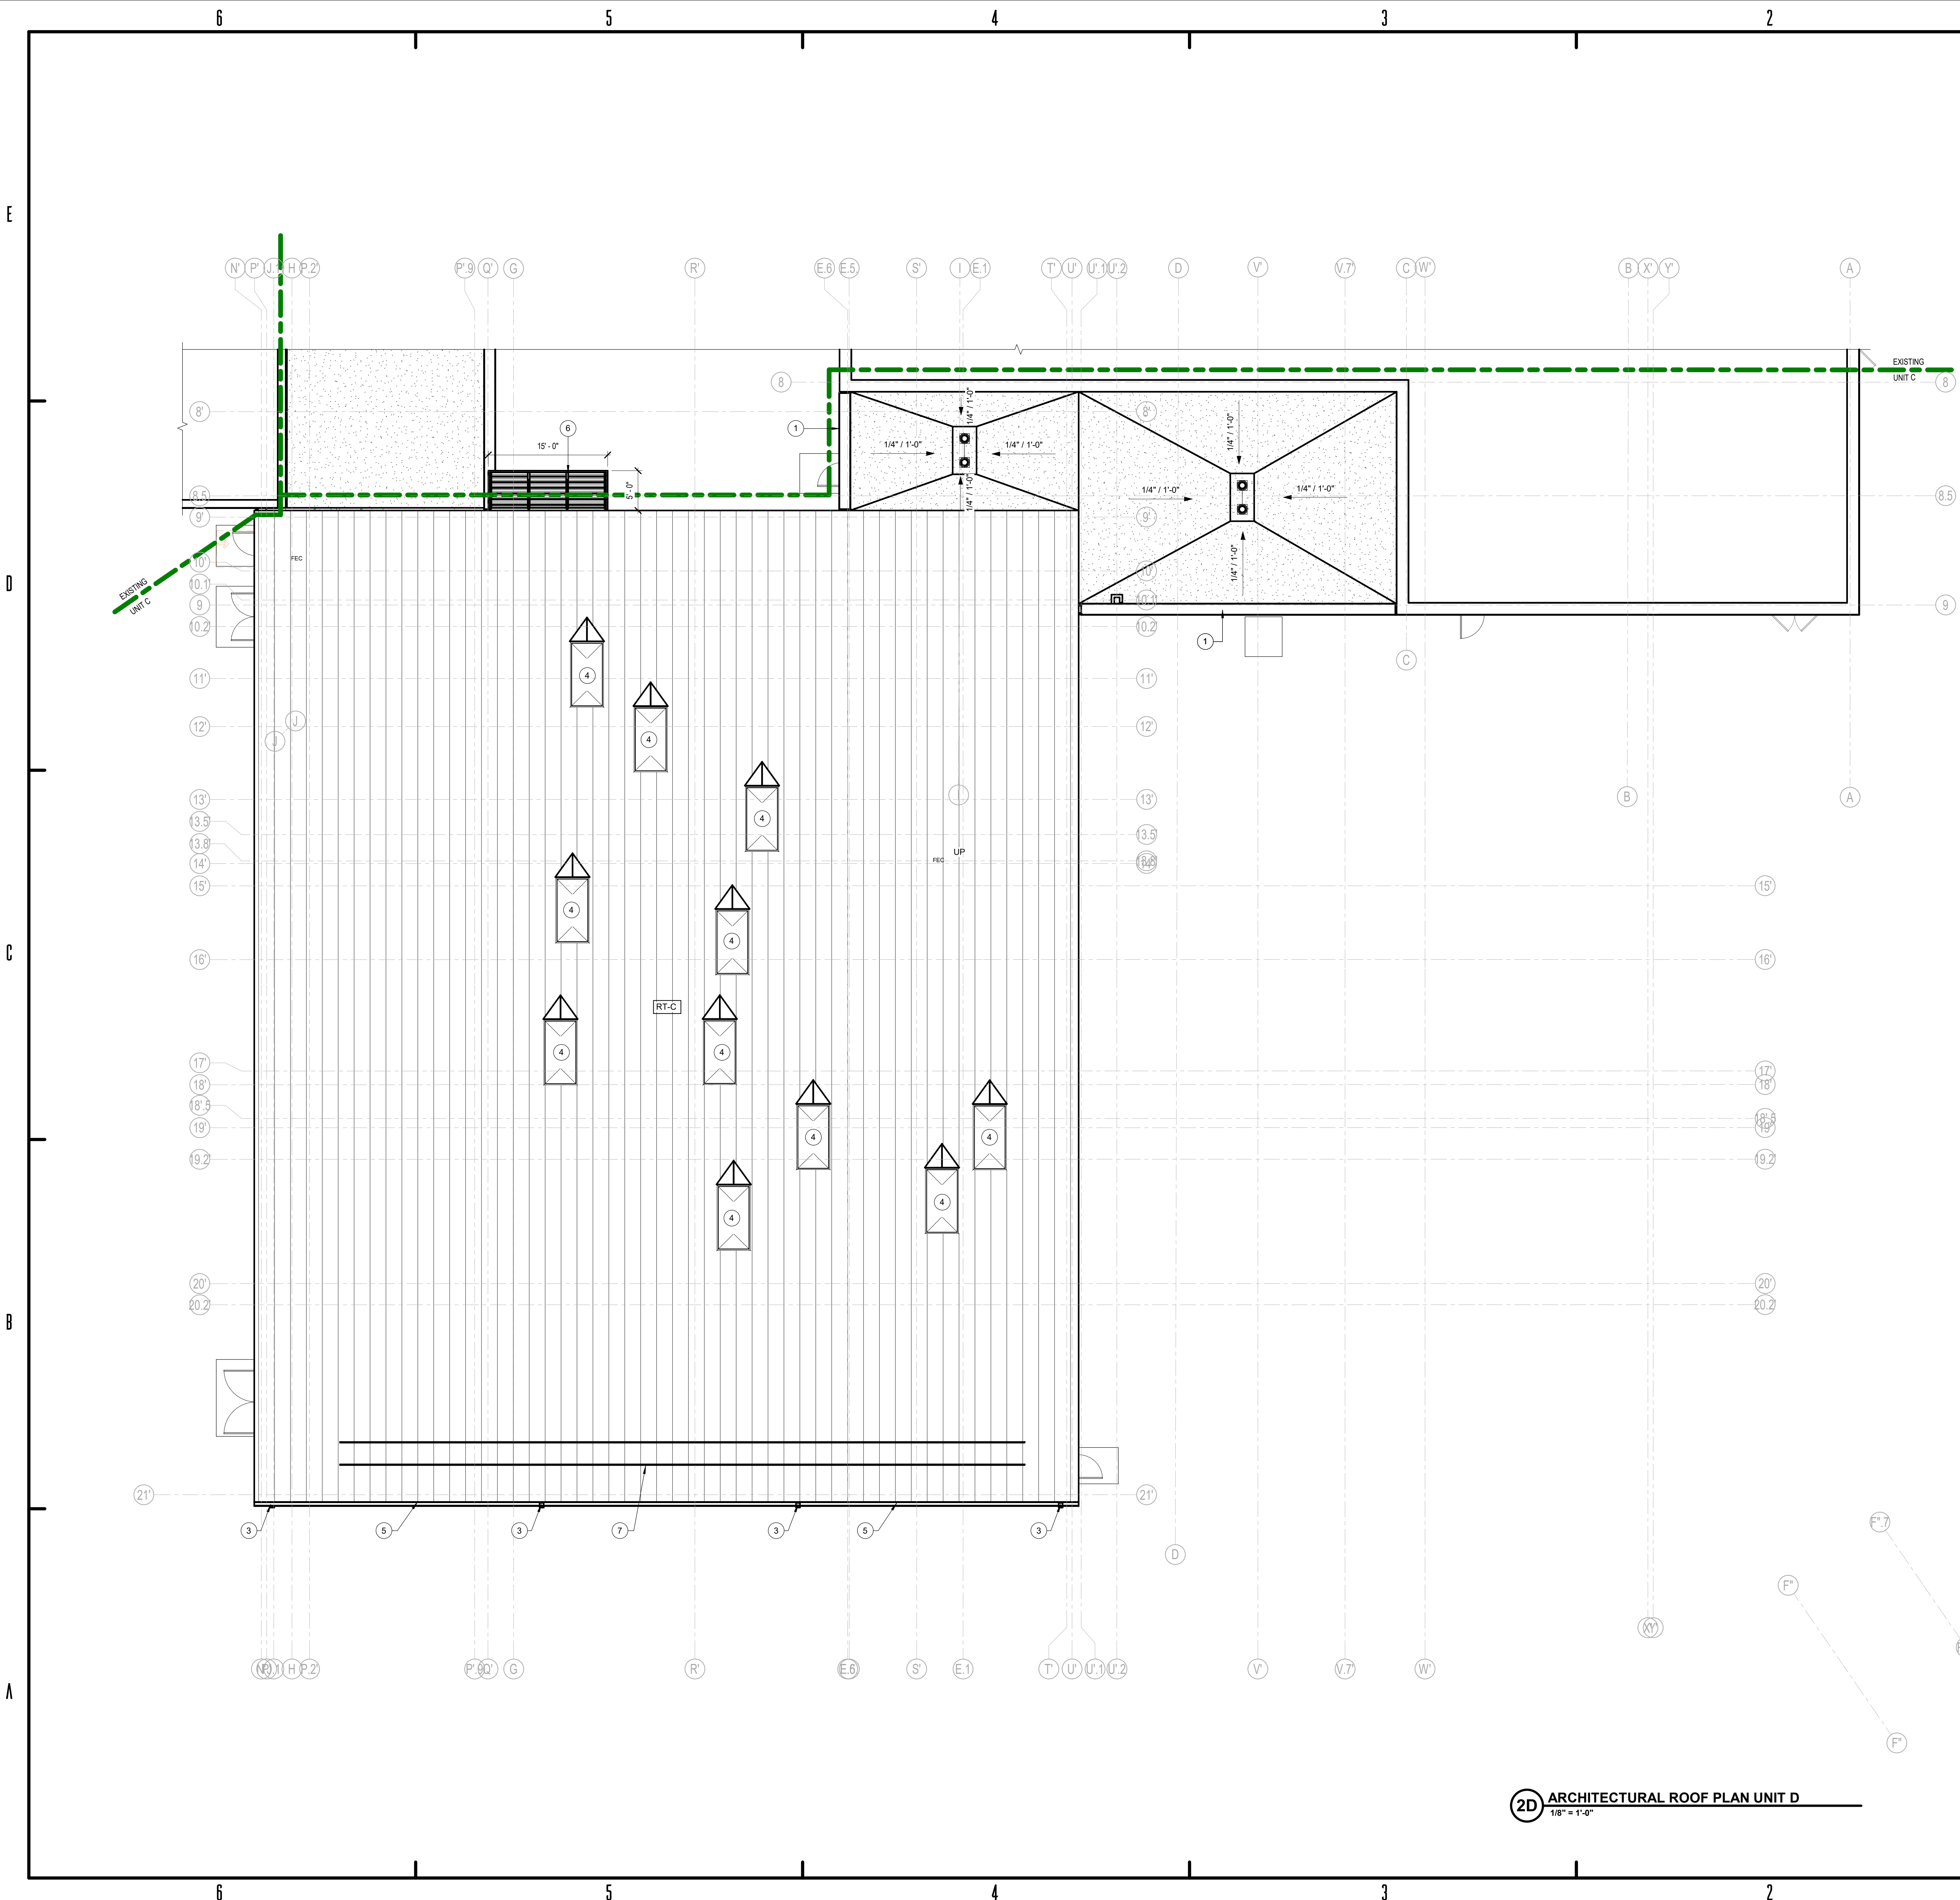
Project #: 20-700-151-2  
Designed By: LD/SP  
Drawn By: CP  
Checked By: LD/EV  
Date: 01.28.2022

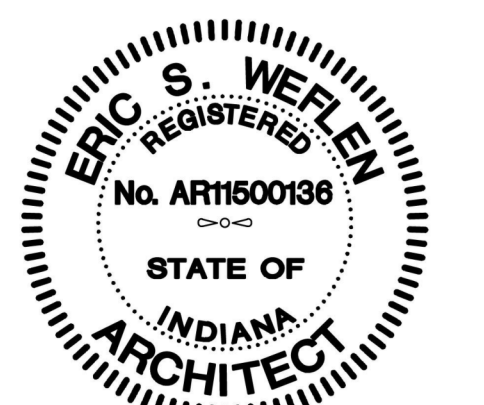

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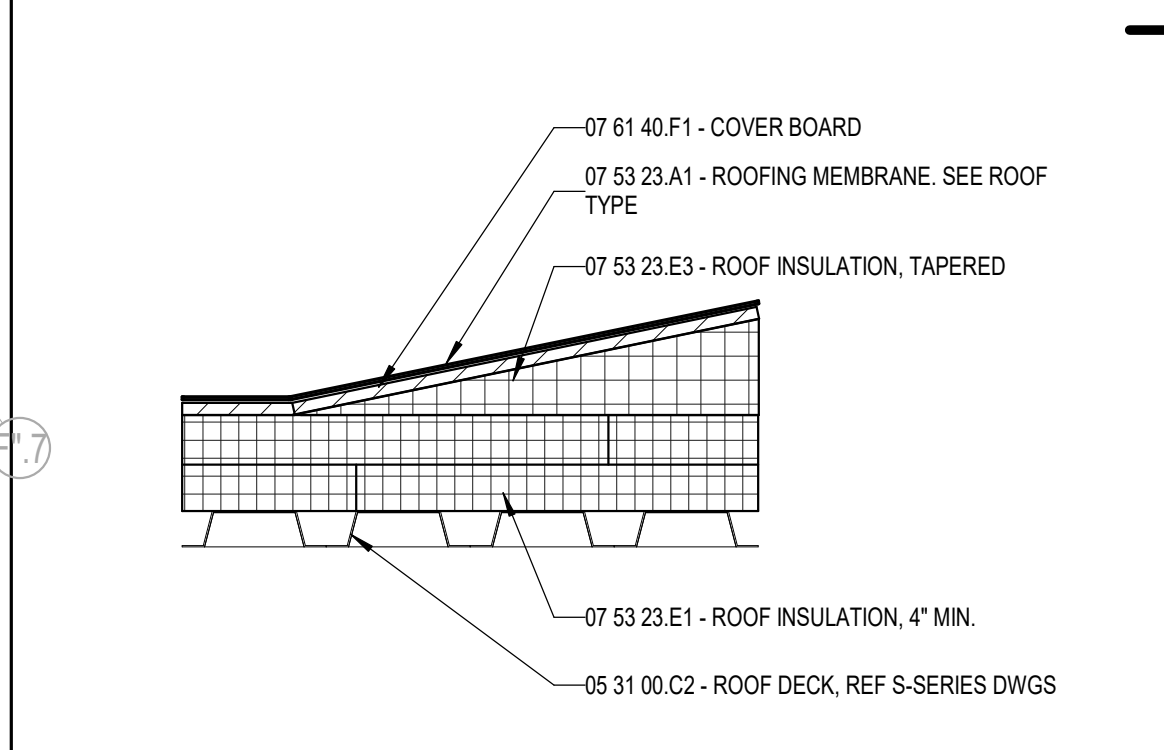
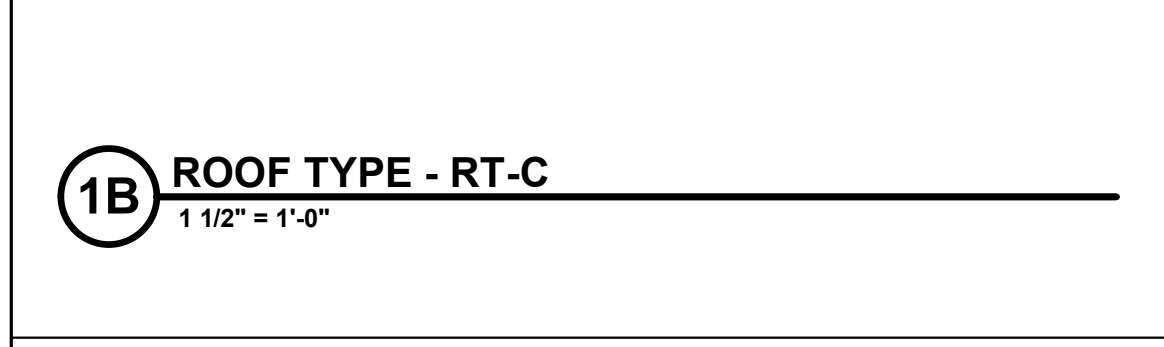
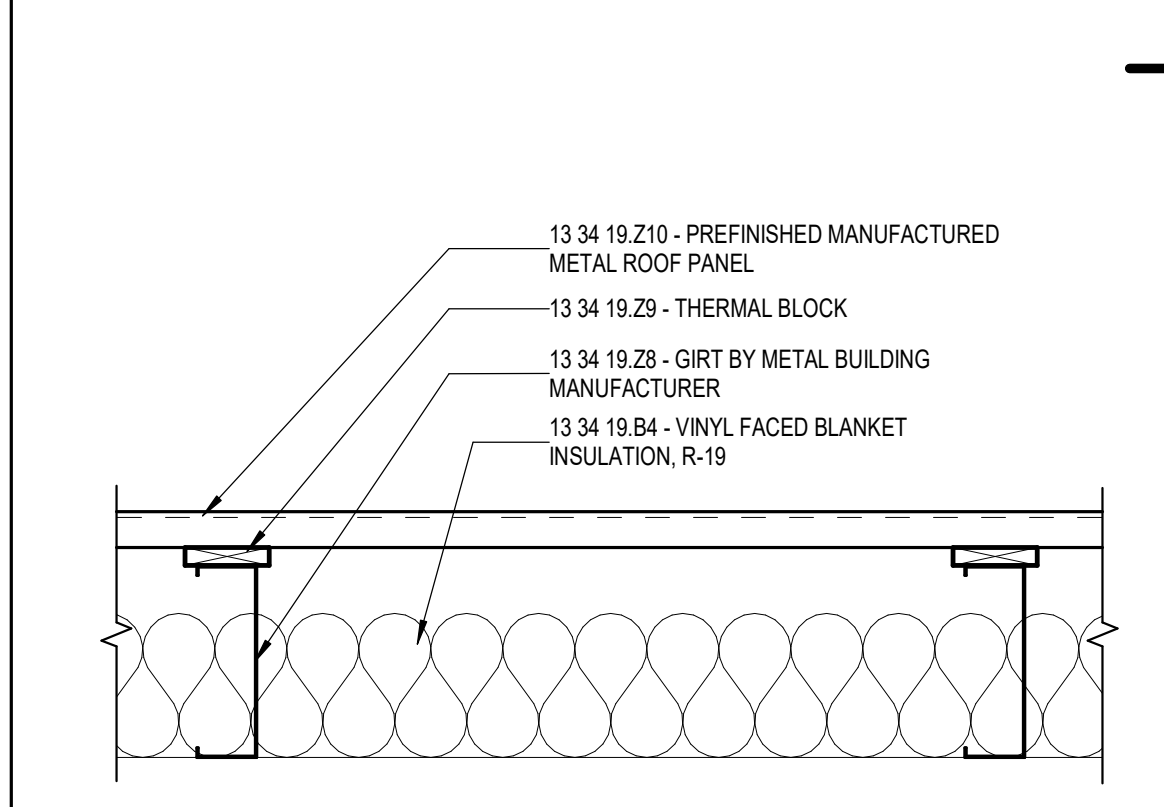
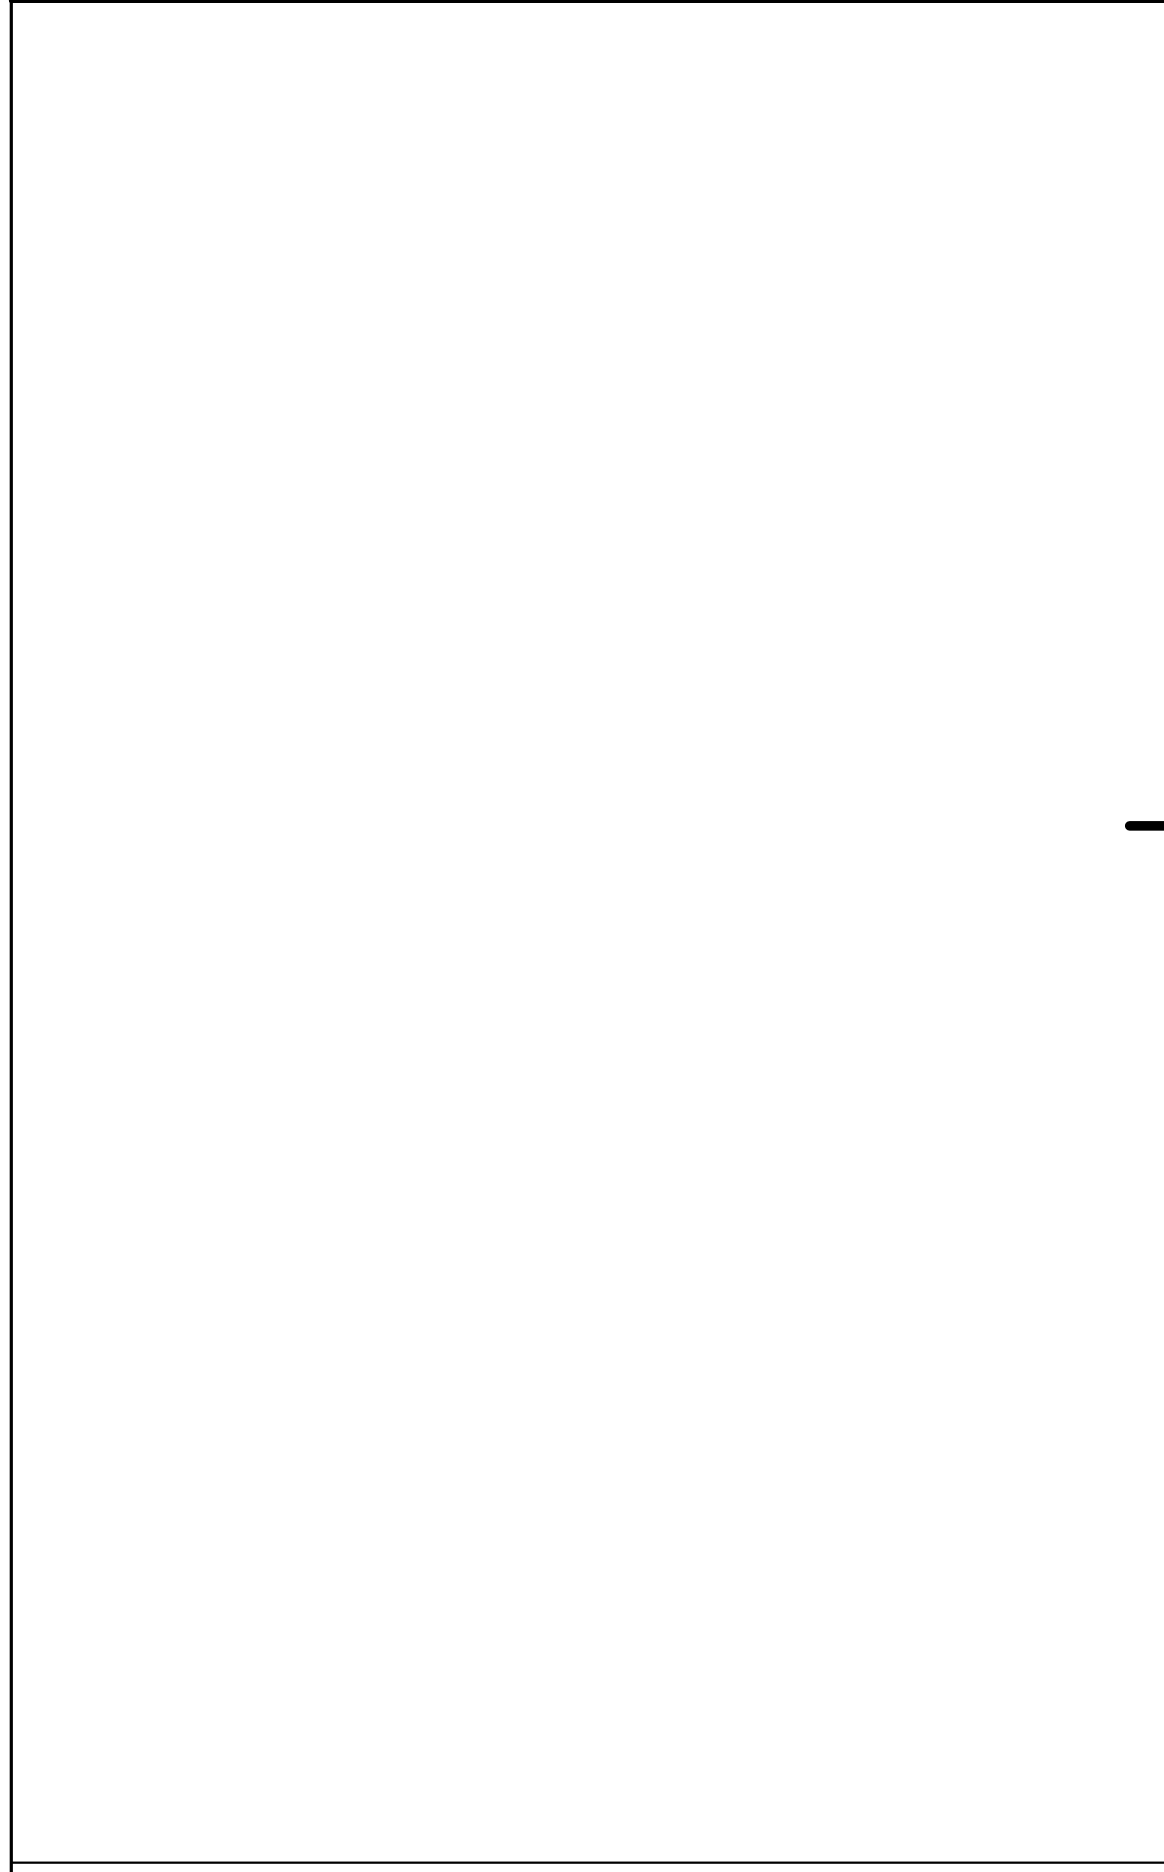


# GENERAL ROOF PLAN NOTES

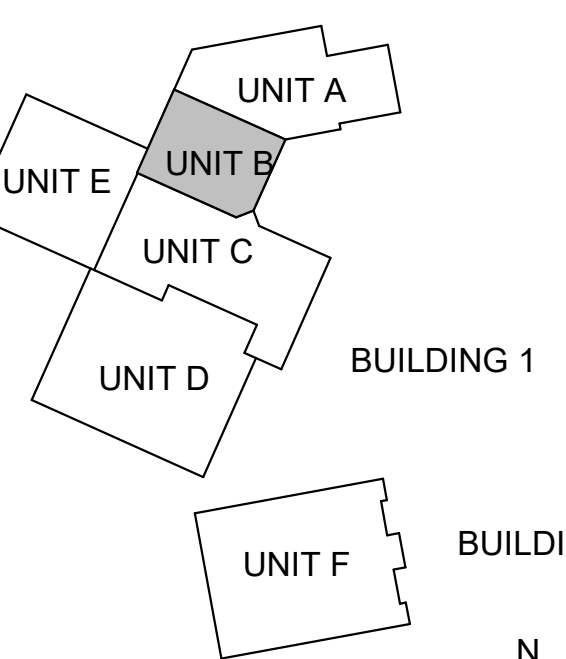
1. Roof to be installed to achieve positive drainage with a minimum resultant slope of 1/4" per foot, unless indicated otherwise. Provide "crickets or saddles" at all roof curbs to allow for positive drainage.
2. Low slope roof areas shall have a minimum of 4" rigid insulation over roof deck. Saddles, crickets, and slope portions of flat roof deck shall be formed by tapered insulation. Areas where tapered insulation is anticipated have been indicated, but shall not be considered all inclusive. It is Contractor's responsibility to provide sloped surfaces to achieve proper drainage.
3. Roof penetrations and equipment shown shall not be considered all inclusive. Coordinate with Mechanical, Plumbing and Electrical Documents to confirm penetrations and equipment locations. Flash all roof penetrations in accordance with roofing manufacturer's recommendations. Provide crickets to allow for proper drainage around units.
4. Roof walkway pads or blocks shall be installed in accordance with roofing manufacturer's recommendation where indicated and around entire perimeter of rooftop equipment.
5. All roof systems are "Roof Type A" except where noted otherwise.

## 5.4.140 - ROOF PLAN NOTES

Key	Note
1	MANUFACTURED METAL COPING, FINISH AS SELECTED BY ARCHITECT
2	13 34 49 - PREENGINEERED METAL BUILDING 4'-0" X 4'-0" SKYLIGHT, SEE DETAIL.
3	13 34 49 - PREENGINEERED METAL TYPICAL DOWNSPOUT
4	13 34 49 - PREENGINEERED METAL BUILDING 8'-0" X 4'-0" SKYLIGHT, SEE DETAIL.
5	13 34 49 - PREENGINEERED METAL TYPICAL GUTTER
6	ENGINEERED MANUFACTURED METAL CANOPY, MAPES STYLE OR EQUAL
7	ICE AND SNOW GUARDS BY ROOF MANUFACTURER, TWO ROWS
8	PREENGINEERED CUSTOM CANOPY FINISH AS SELECTED BY ARCHITECT
9	ENGINEERED METAL CANOPY/LOUVER SUN SHADES
10	MANUFACTURED METAL CANOPY MAPES STYLE OR EQUAL
11	MANUFACTURED ROOF TO WALL EXPANSION JOINT, 4"
12	MANUFACTURED ROOF TO WALL EXPANSION JOINT, 2"
13	CONCRETE BENCH, SEE DETAIL ###



NOTE: PROVIDE 2 LAYERS OF 2" BOARD WITH STAGGERED JOINTS, TYPICAL

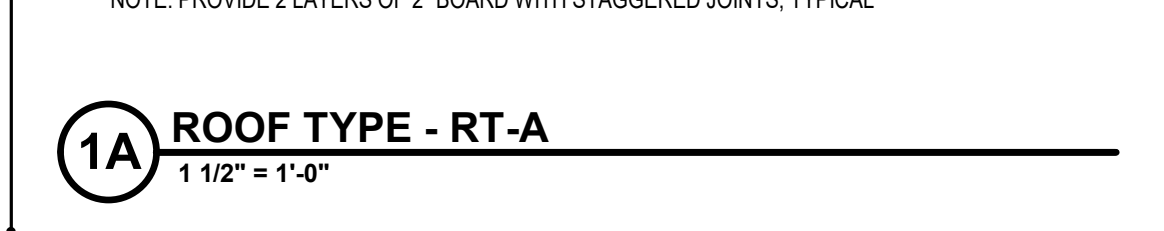

BID SET

KNOX COUNTY BOARD OF COMMISSIONERS

KNOX COUNTY JUSTICE CAMPUS

2375 OLD DECKER RD. VINCENNES, IN 47591

#	Revision	Date

Project # 20-700-151-2

Designed By: LD/SP

Drawn By: JW

Checked By: LD/EV


Date: 01.28.2022

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ARCHITECTURAL ROOF PLAN UNIT D

AR 1D1



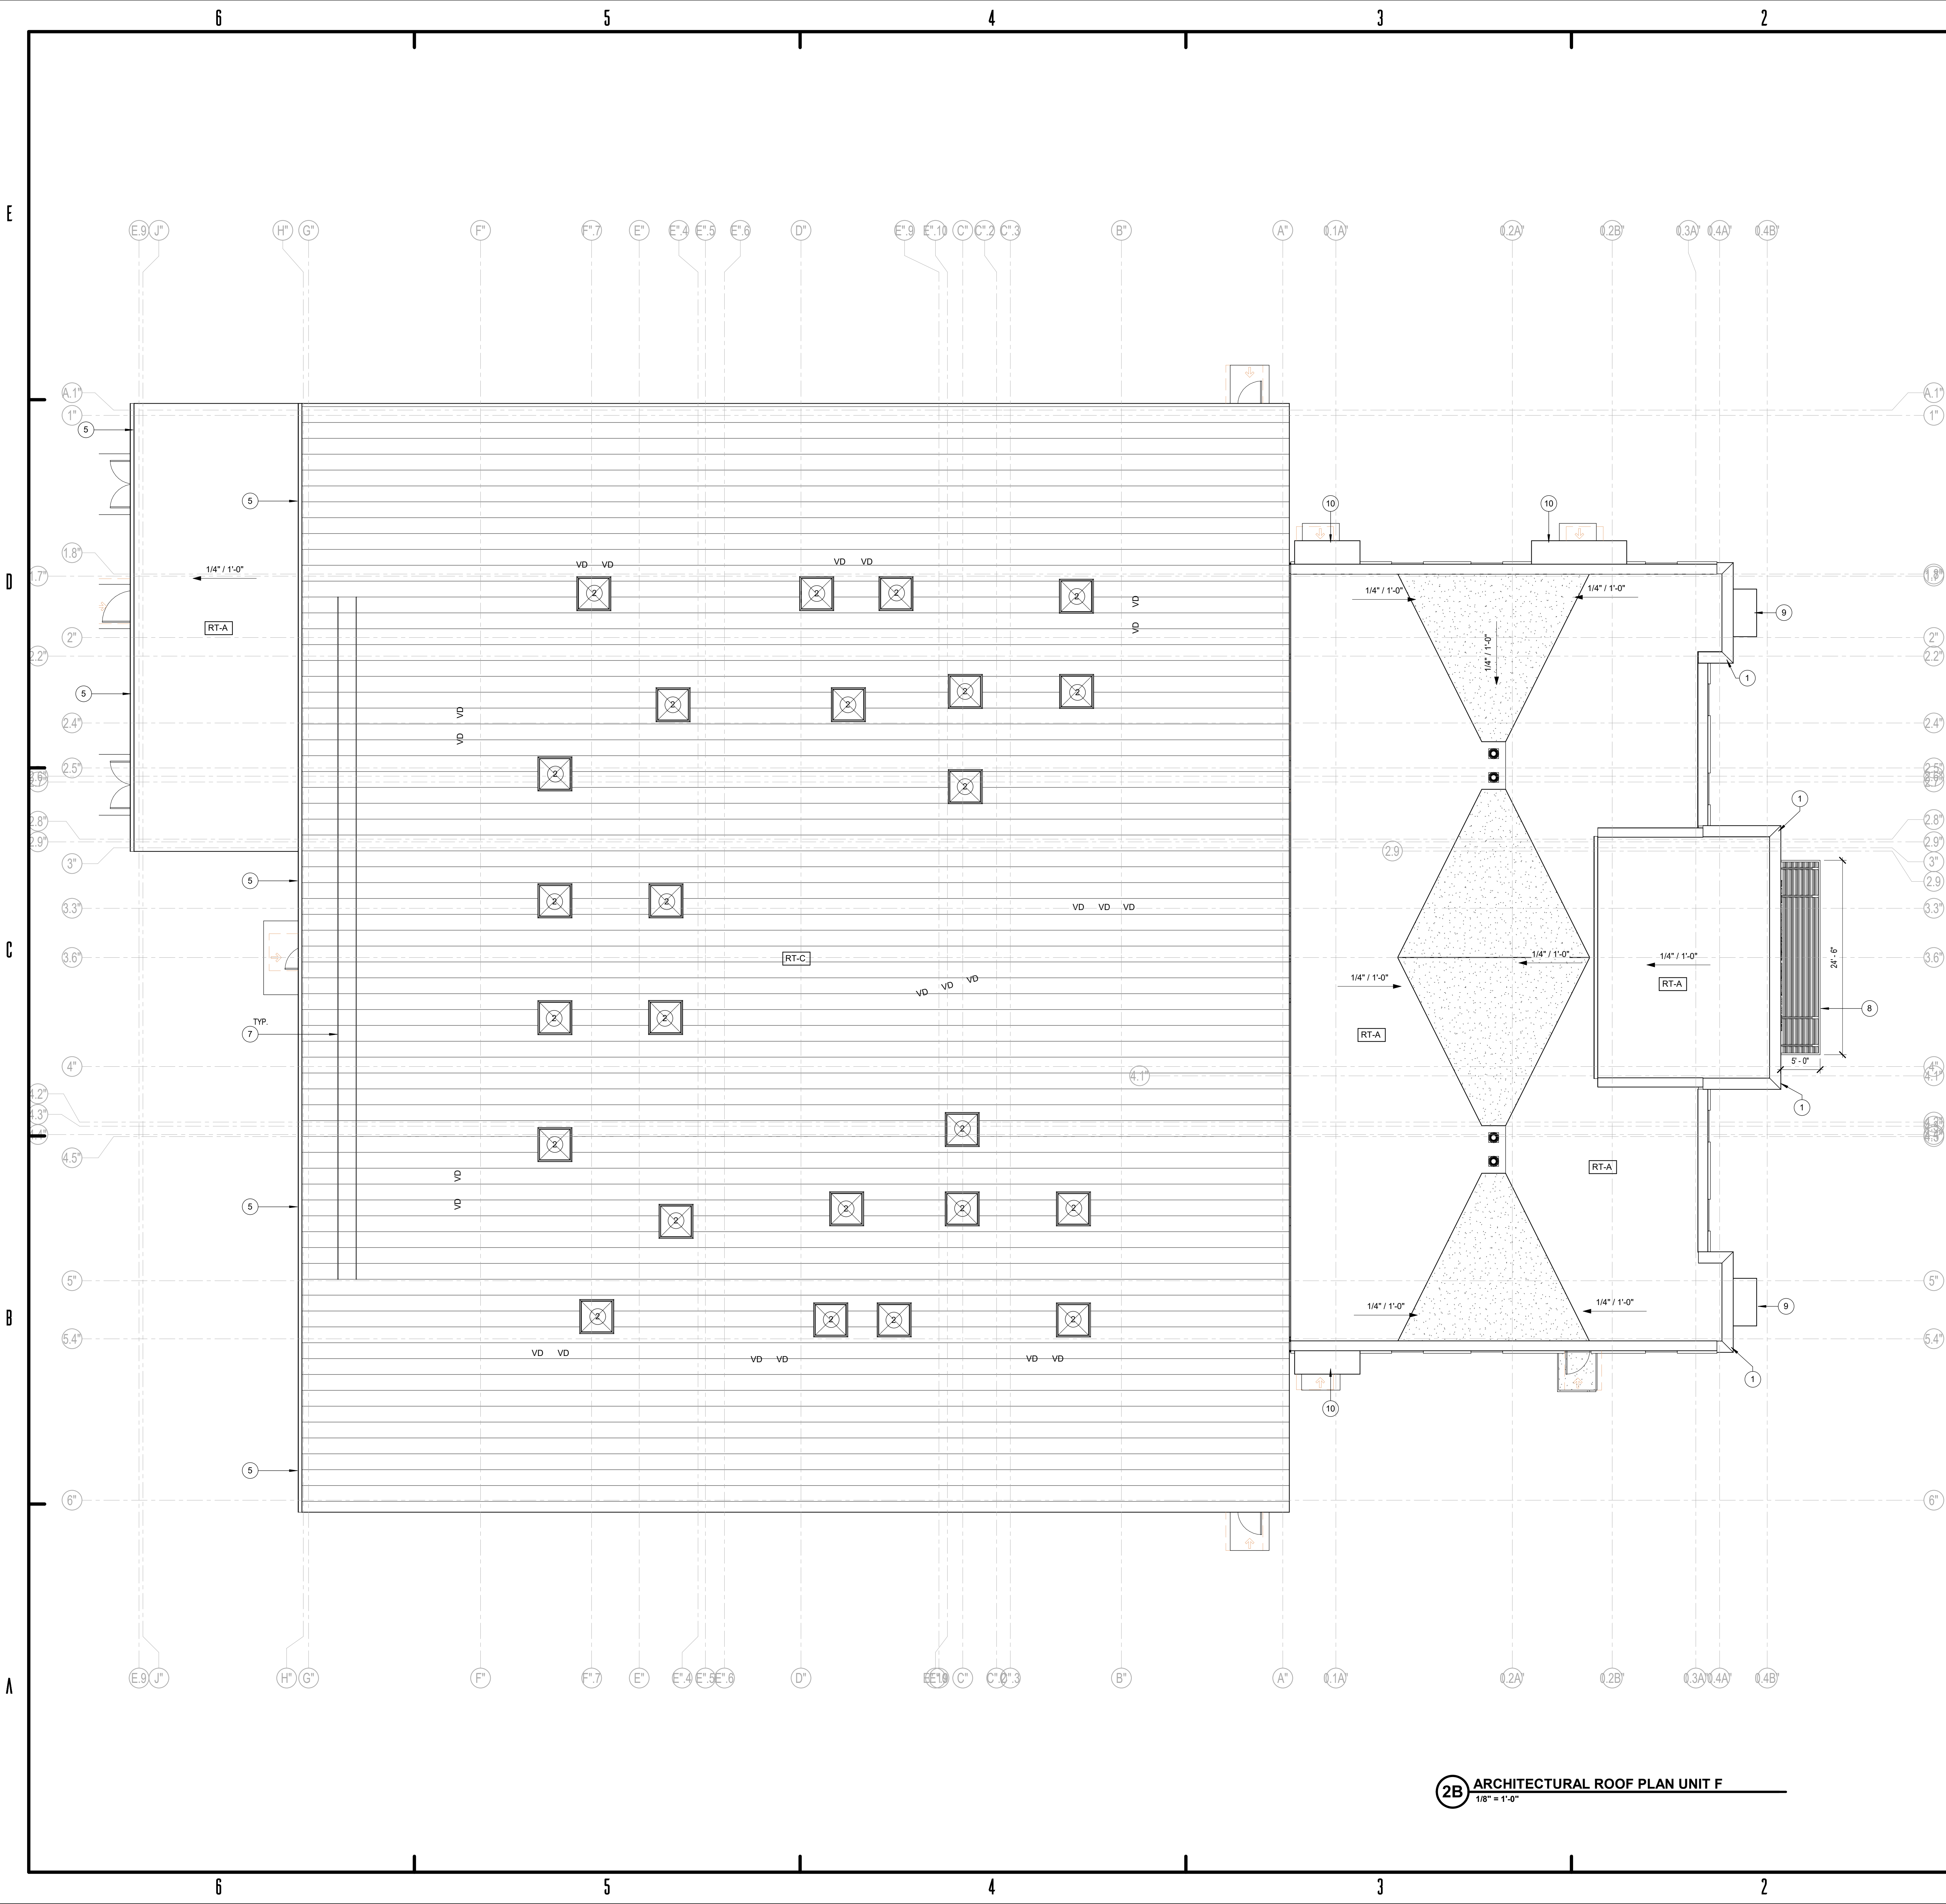


**2B ARCHITECTURAL ROOF PLAN UNIT F**  
1/8" = 1'-0"


**GENERAL ROOF PLAN NOTES**

1. Roof to be installed to achieve positive drainage with a minimum resultant slope of 1/4" per foot, unless indicated otherwise. Provide "crickets or saddles" at all roof curbs to allow for positive drainage.
2. Low slope roof areas shall have a minimum of 4" rigid insulation over roof deck. Saddles, crickets, and slope portions of flat roof deck shall be formed by tapered insulation. Areas where tapered insulation is anticipated have been indicated, but shall not be considered all inclusive. It is Contractor's responsibility to provide sloped surfaces to achieve proper drainage.
3. Roof penetrations and equipment shown shall not be considered all inclusive. Coordinate with Mechanical, Plumbing and Electrical Documents to confirm penetrations and equipment locations. Flash all roof penetrations in accordance with roofing manufacturer's recommendations. Provide crickets to allow for proper drainage around units.
4. Roof walkway pads or blocks shall be installed in accordance with roofing manufacturer's recommendation where indicated and around entire perimeter of rooftop equipment.
5. All roof systems are "Roof Type A" except where noted otherwise.

5.4.140 - ROOF PLAN NOTES	
Key	Note
1	MANUFACTURED METAL COPING, FINISH AS SELECTED BY ARCHITECT
2	13 34 49 - PREENGINEERED METAL BUILDING 4'-0" X 4'-0" SKYLIGHT, SEE DETAIL
3	13 34 49 - PREENGINEERED METAL TYPICAL DOWNSPOUT
4	13 34 49 - PREENGINEERED METAL BUILDING 6'-0" X 4'-0" SKYLIGHT, SEE DETAIL
5	13 34 49 - PREENGINEERED METAL BUILDING TYPICAL GUTTER
6	ENGINEERED MANUFACTURED METAL CANOPY, MAPES STYLE OR EQUAL
7	ICE AND SNOW GUARDS BY ROOF MANUFACTURER, TWO ROWS
8	PREENGINEERED CUSTOM CANOPY FINISH AS SELECTED BY ARCHITECT
9	ENGINEERED METAL CANOPY/LOUVER SUN SHADES
10	MANUFACTURED METAL CANOPY MAPES STYLE OR EQUAL
11	MANUFACTURED ROOF TO WALL EXPANSION JOINT, 4"
12	MANUFACTURED ROOF TO WALL EXPANSION JOINT, 2"
13	CONCRETE BENCH SEE DETAIL ###

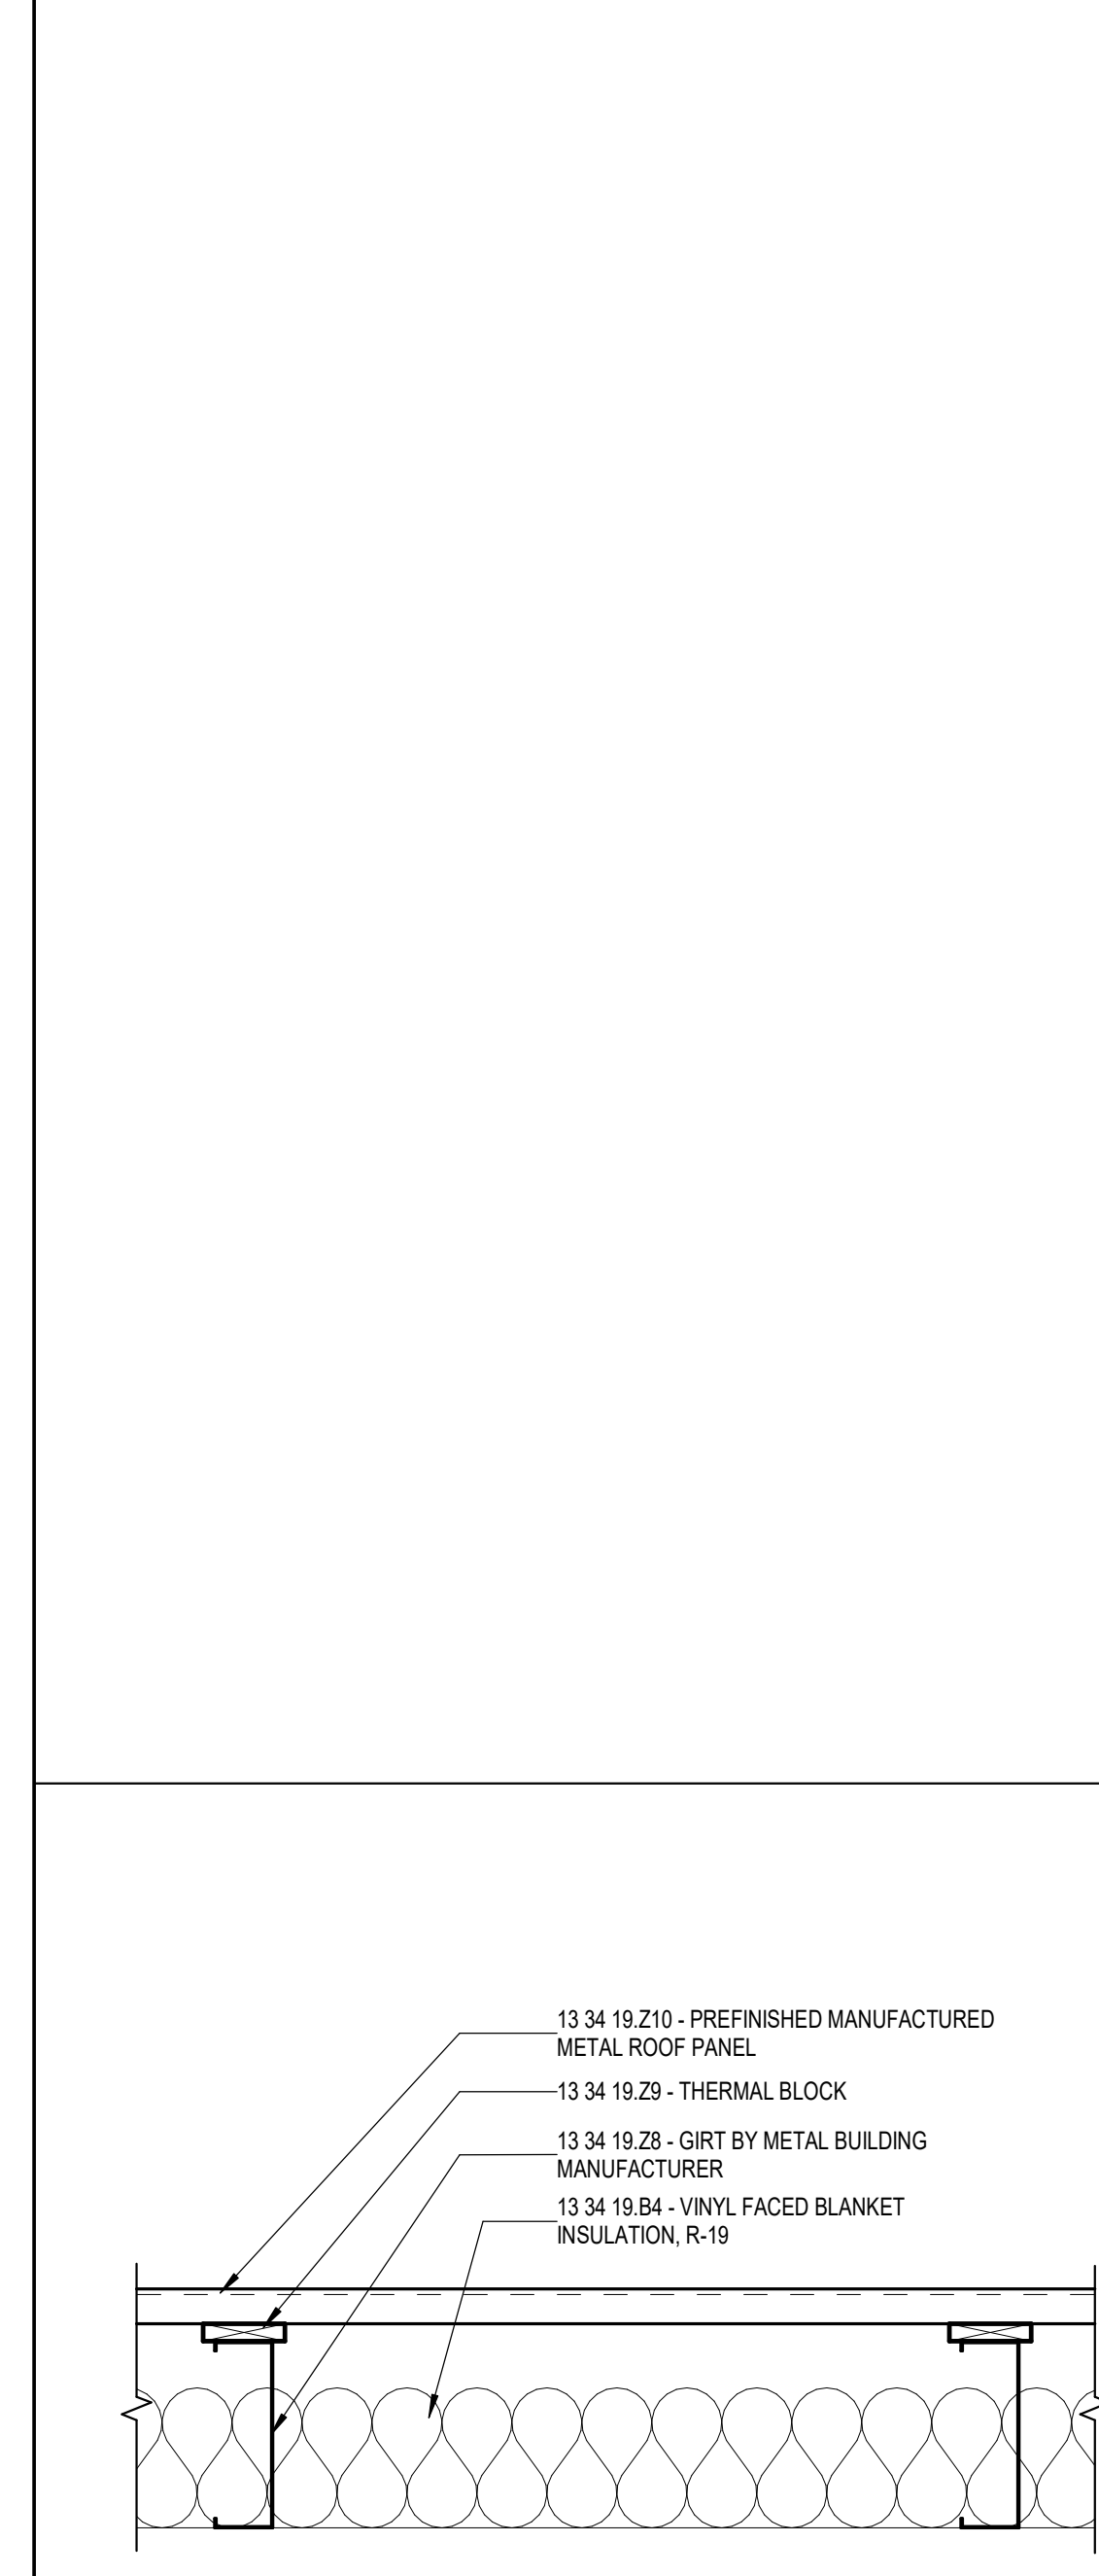

**1B ROOF TYPE - RT-C**  
1 1/2" = 1'-0"

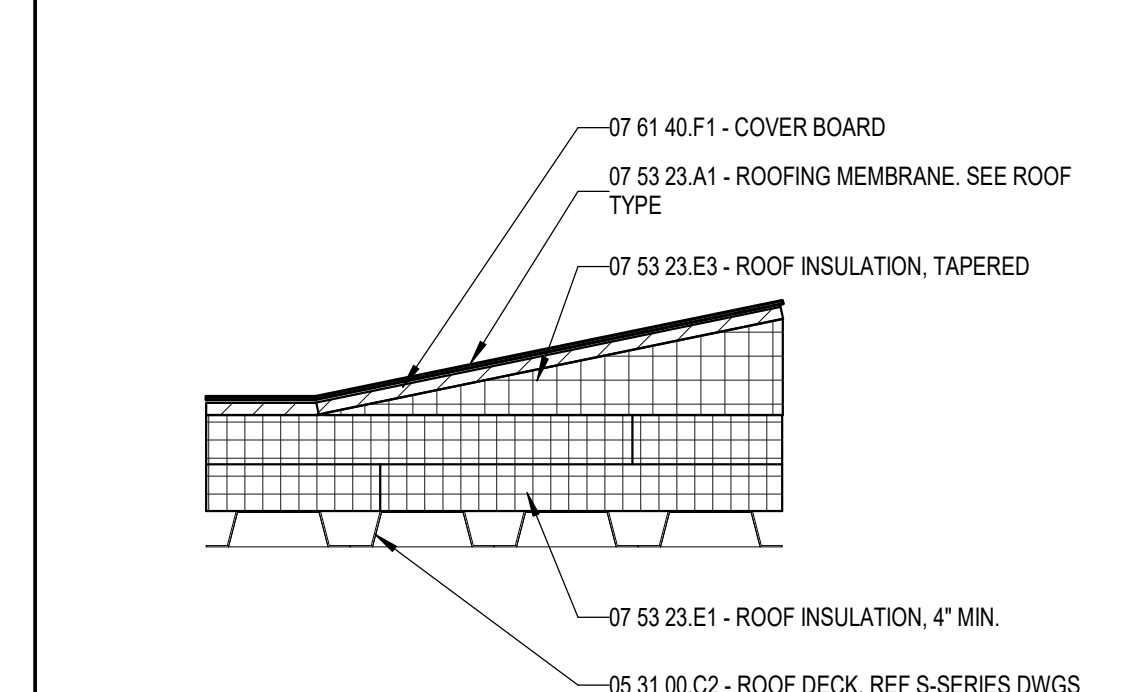

**1A ROOF TYPE - RT-A**  
1 1/2" = 1'-0"

**BID SET**

KNOX COUNTY BOARD OF COMMISSIONERS

**KNOX COUNTY JUSTICE CAMPUS**

2375 OLD DECKER RD. VINCENNES, IN 47591

#	Revision	Date
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Project #: 20-700-151-2

Designed By: LD

Drawn By: WD

Checked By: LD/EV


Date: 01.28.2022

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ARCHITECTURAL ROOF PLAN UNIT F

**AR 2F1**



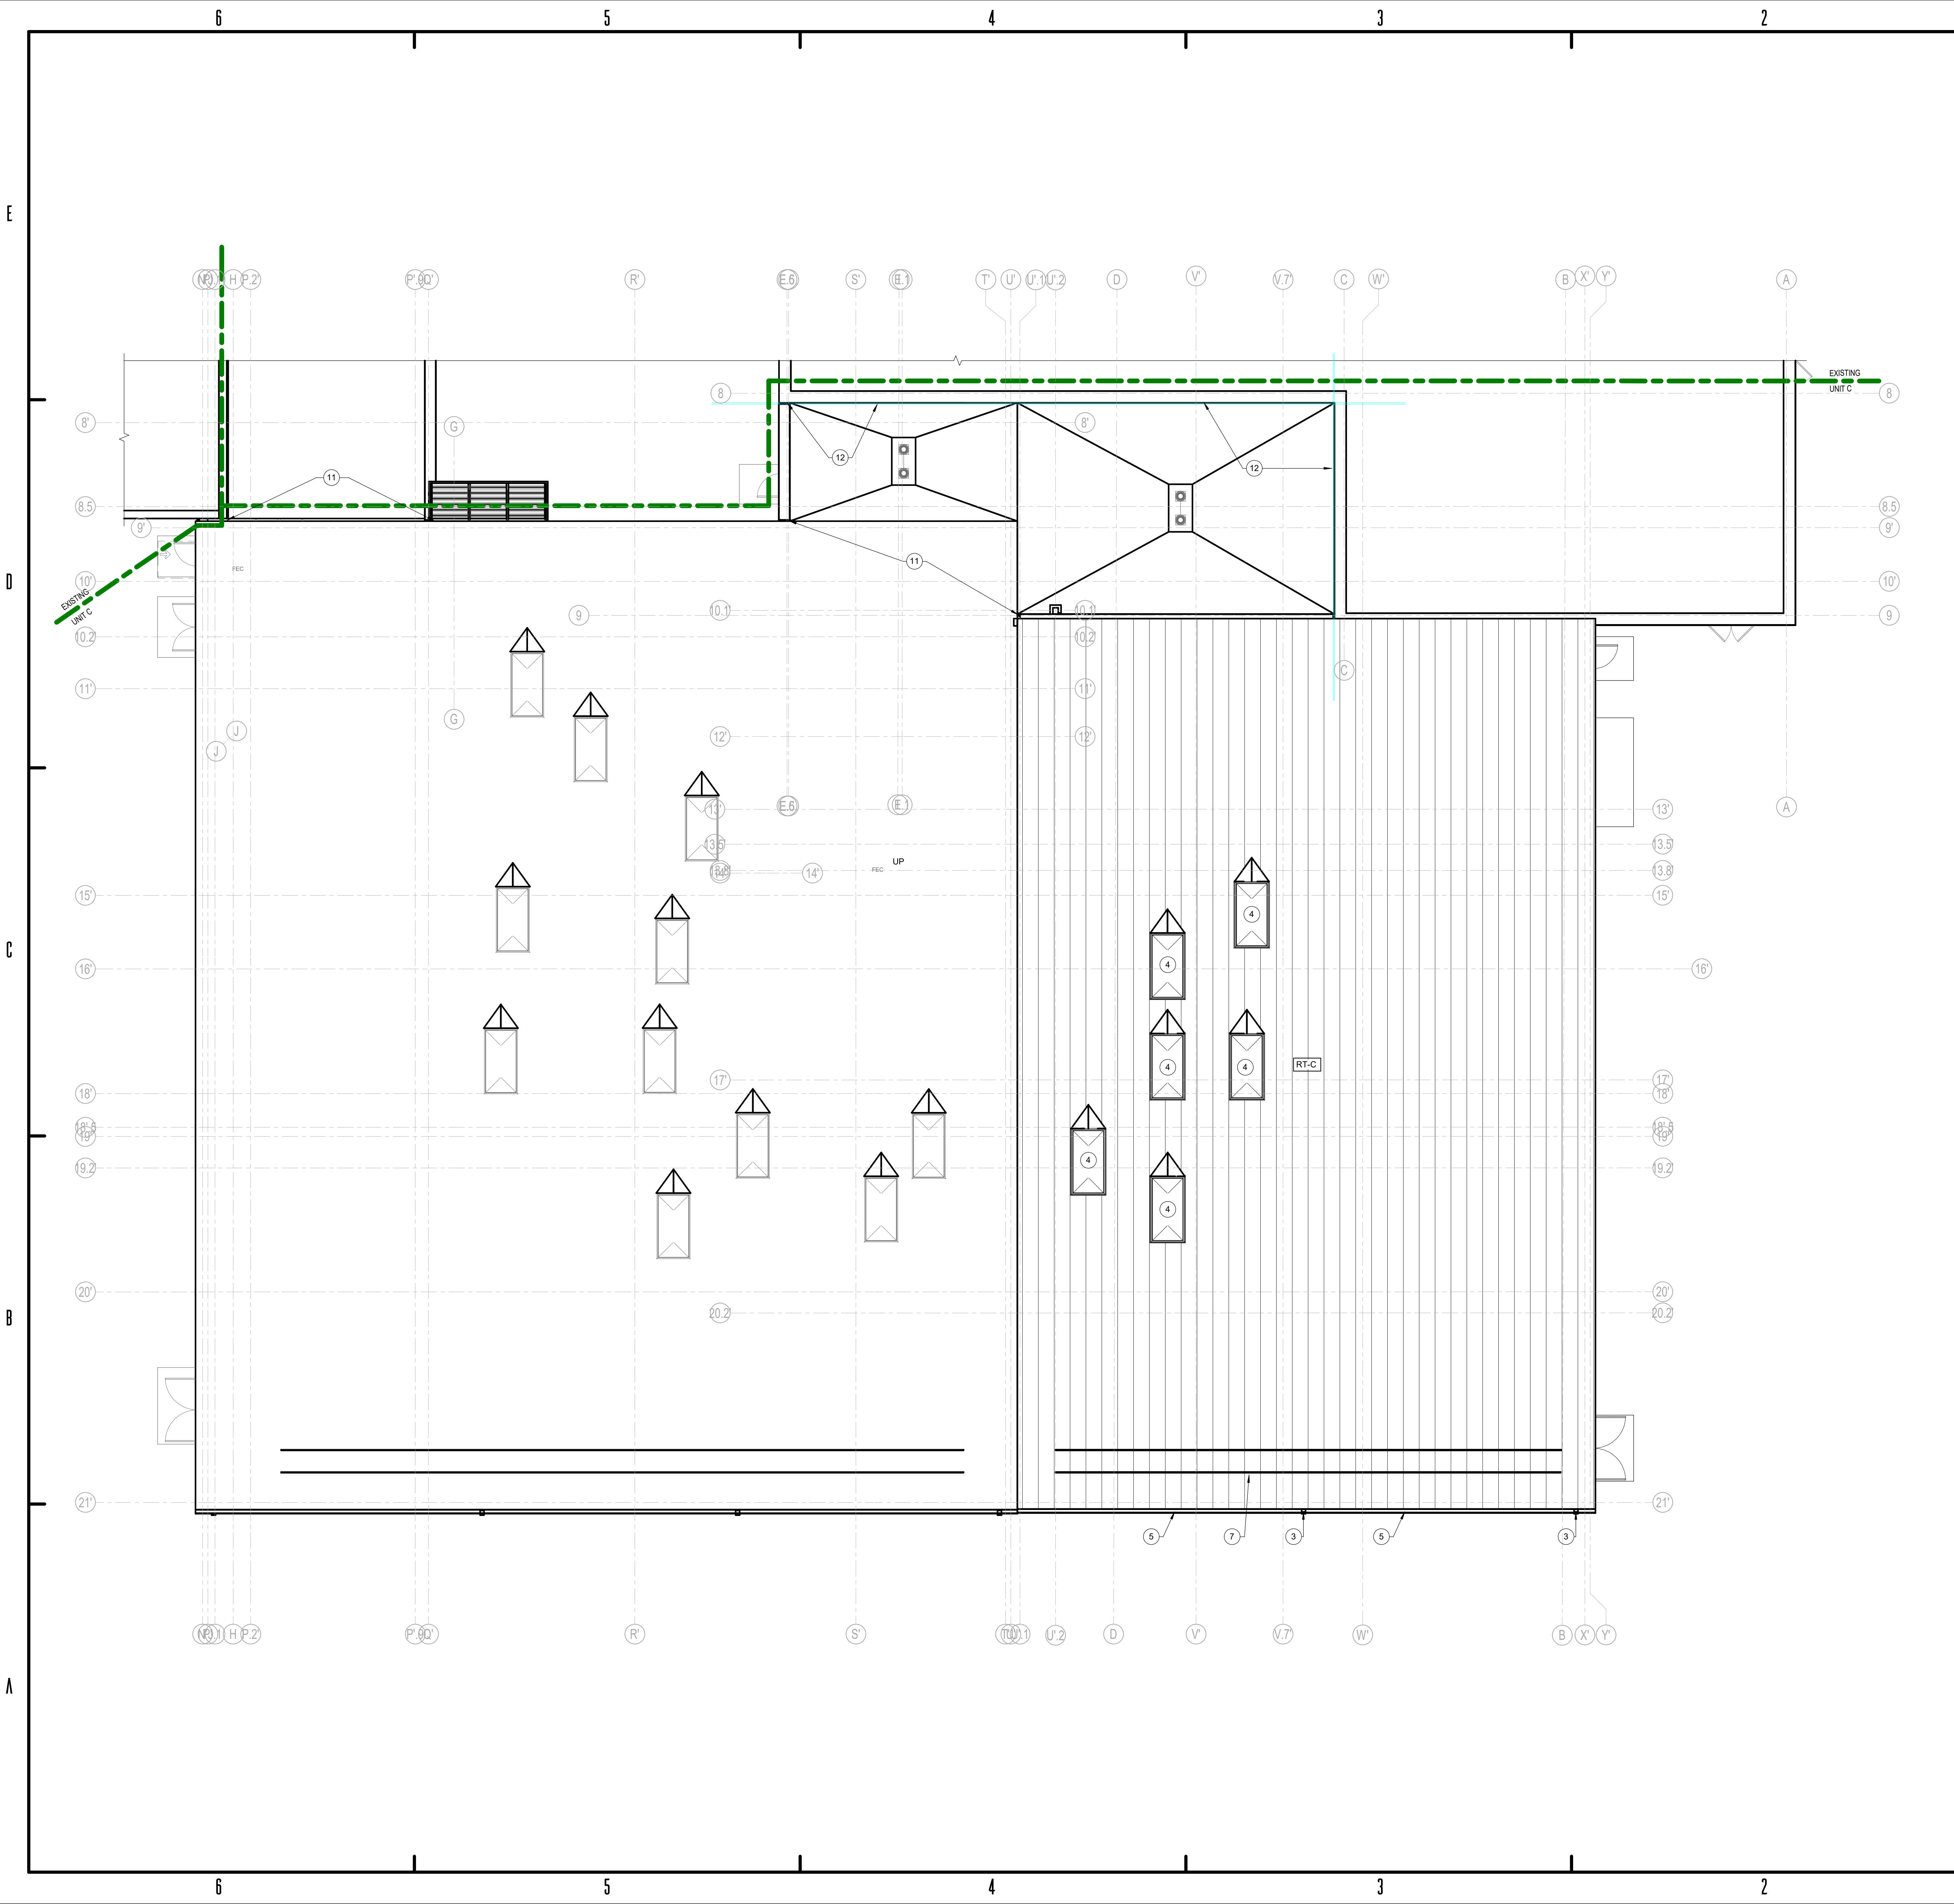

5.4.140 - ROOF PLAN NOTES	
Key	Note
1	MANUFACTURED METAL COPING, FINISH AS SELECTED BY ARCHITECT
2	13 34 49 - PREENGINEERED METAL BUILDING 4'-0" X 4'-0" SKYLIGHT, SEE DETAIL
3	13 34 49 - PREENGINEERED METAL TYPICAL DOWNSPOUT
4	13 34 49 - PREENGINEERED METAL BUILDING 6'-0" X 4'-0" SKYLIGHT, SEE DETAIL
5	13 34 49 - PREENGINEERED METAL BUILDING TYPICAL GUTTER
6	ENGINEERED MANUFACTURED METAL CANOPY, MAPES STYLE OR EQUAL
7	ICE AND SNOW GUARDS BY ROOF MANUFACTURER, TWO ROWS
8	PREENGINEERED CUSTOM CANOPY FINISH AS SELECTED BY ARCHITECT
9	ENGINEERED METAL CANOPY LOUVER SUN SHADES
10	MANUFACTURED METAL CANOPY MAPES STYLE OR EQUAL
11	MANUFACTURED ROOF TO WALL EXPANSION JOINT, 4"
12	MANUFACTURED ROOF TO WALL EXPANSION JOINT, 2"
13	CONCRETE BENCH SEE DETAIL ###



BID SET

KNOX COUNTY BOARD OF COMMISSIONERS

KNOX COUNTY JUSTICE CAMPUS

2375 OLD DECKER RD. VINCENNES, IN 47591

#	Revision	Date
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Project #: 20-700-151-2

Designed By: Designer

Drawn By: Author


Checked By: Checker

Date: 01.28.2022



Eric Wepler

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ALTERNATE ARCHITECTURAL ROOF PLAN D

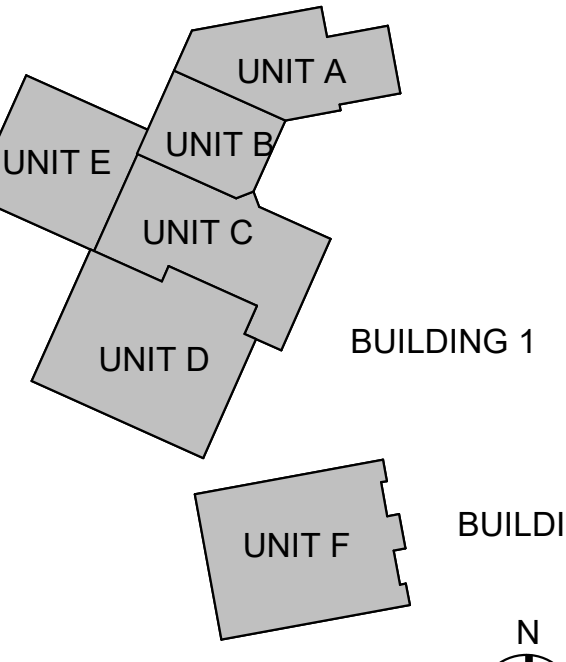AR ALT D




#	Revision	Date
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Project #: 20-700-151-2  
Designed By: LD/SP  
Drawn By: JW  
Checked By: LD/EV  
Date: 01.28.2022




*Eric Weylan*


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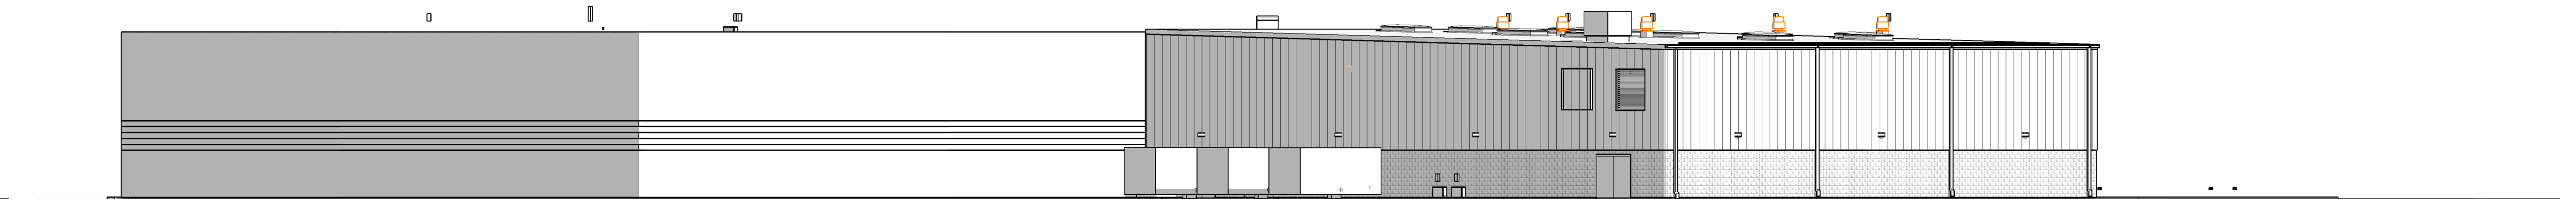
OVERALL ELEVATIONS -  
BUILDING 1

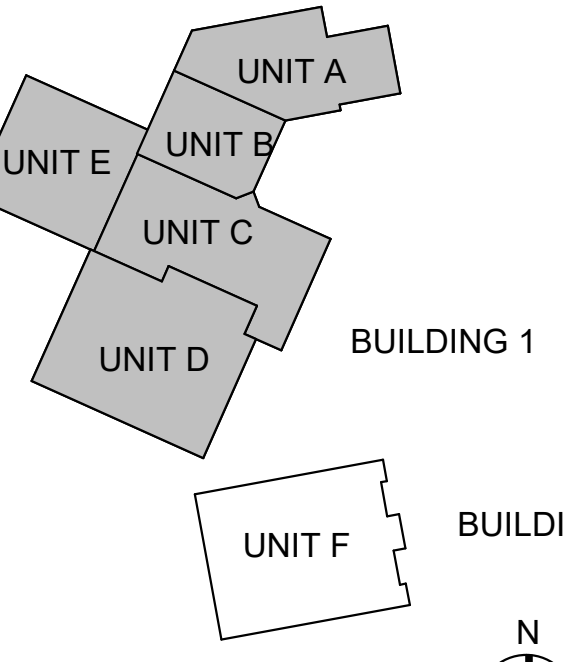


6E BLDG 1 - EAST ELEVATION  
1/16" = 1'-0"

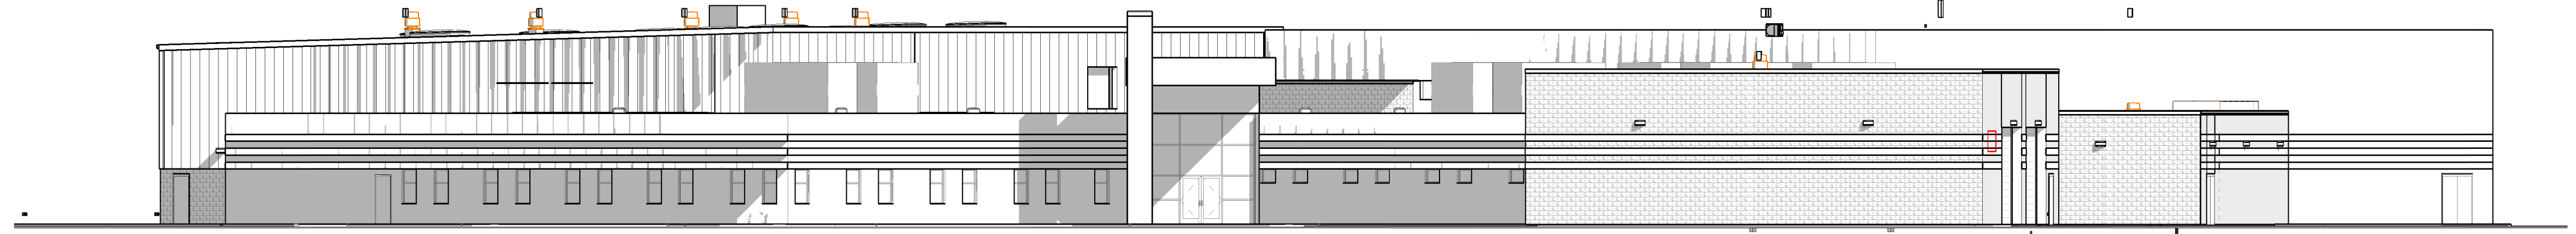

6D BLDG 1 - NORTH ELEVATION  
1/16" = 1'-0"

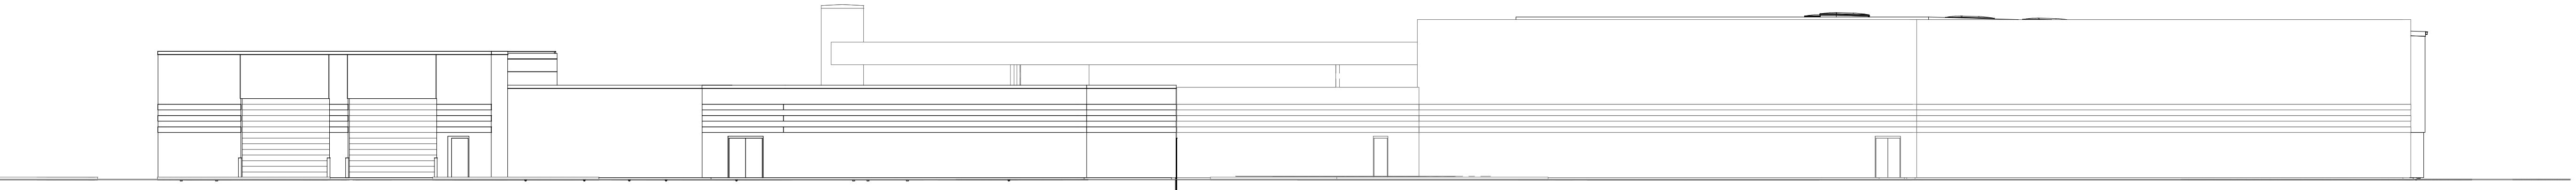


6C BLDG 1 - WEST ELEVATION  
1/16" = 1'-0"

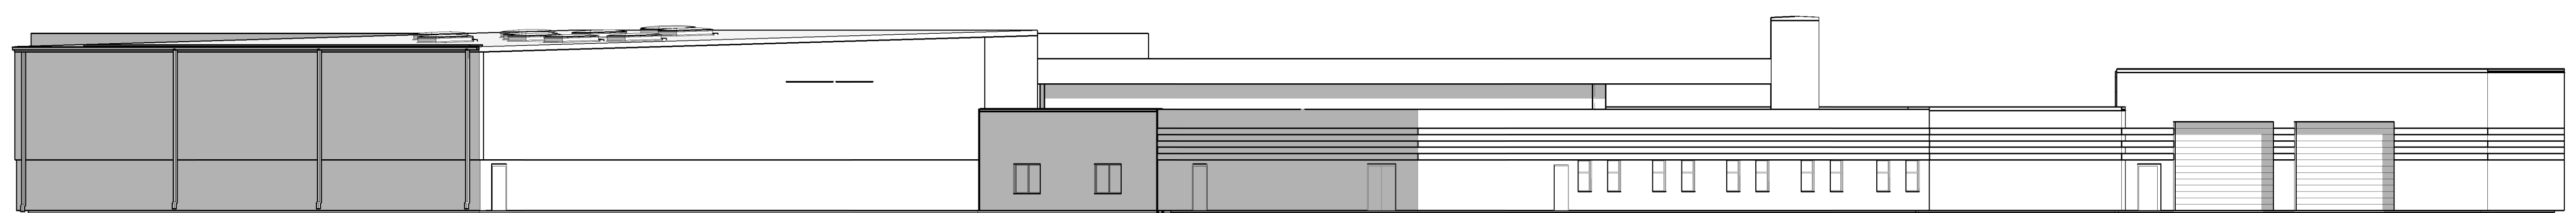


6A BLDG 1 - SOUTH ELEVATION  
1/16" = 1'-0"




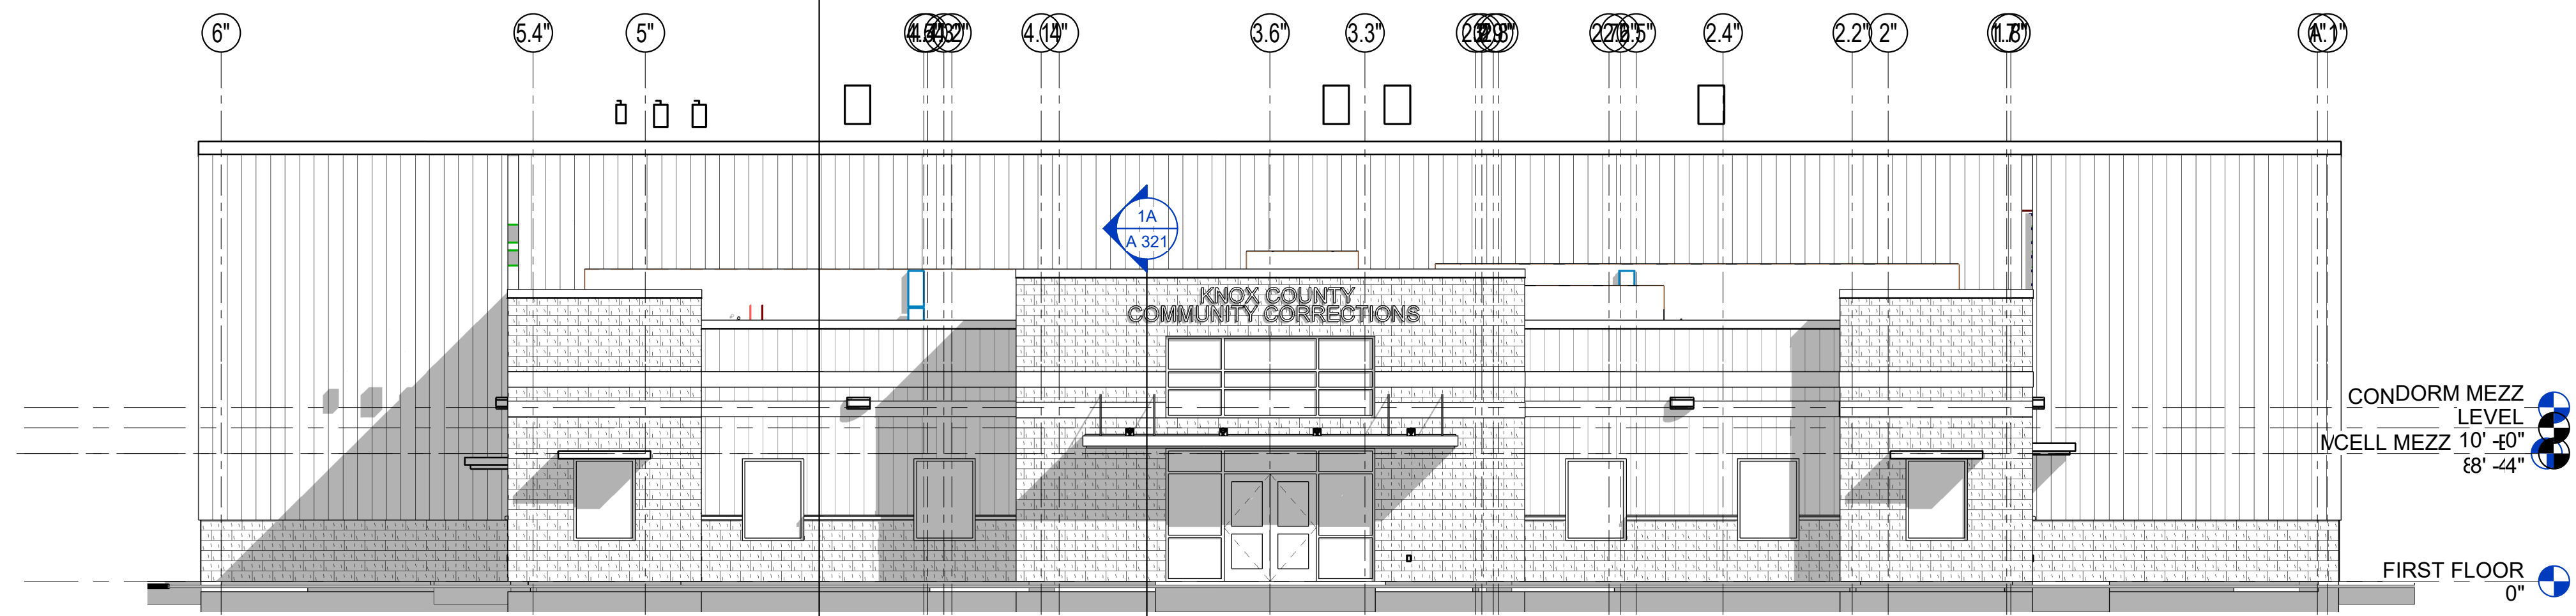


6D BLDG 2 - EAST ELEVATION  
1/8" = 1'-0"

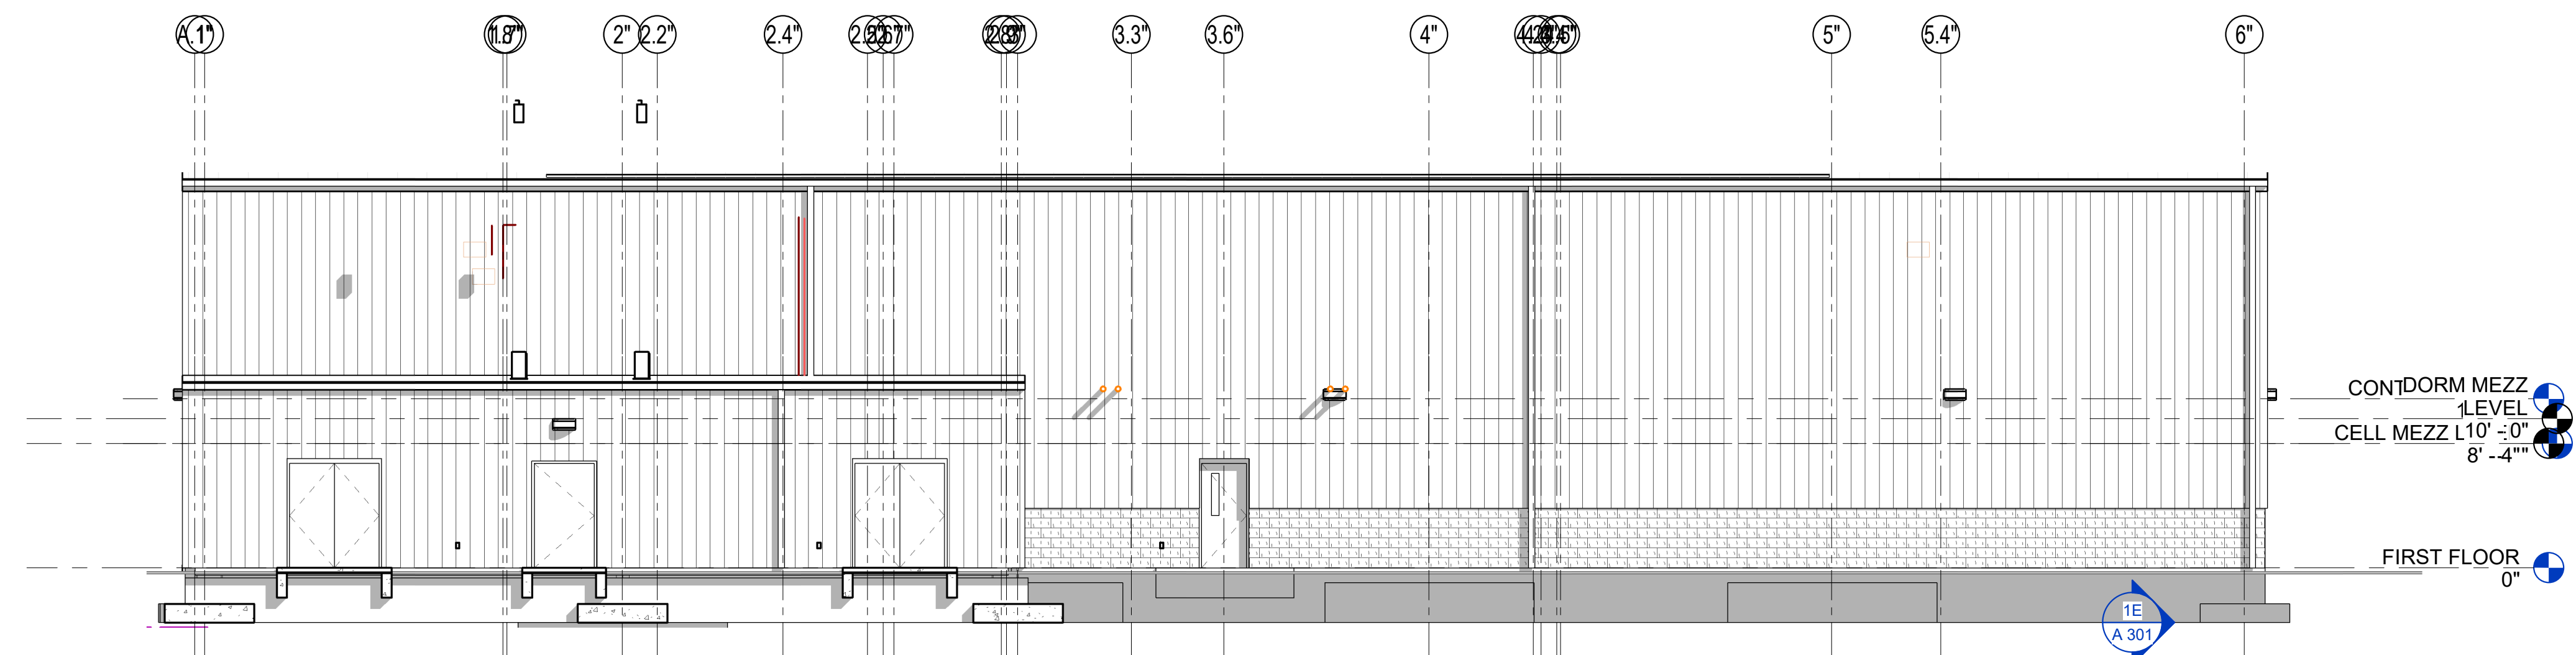

6C BLDG 2 - WEST ELEVATION  
1/8" = 1'-0"

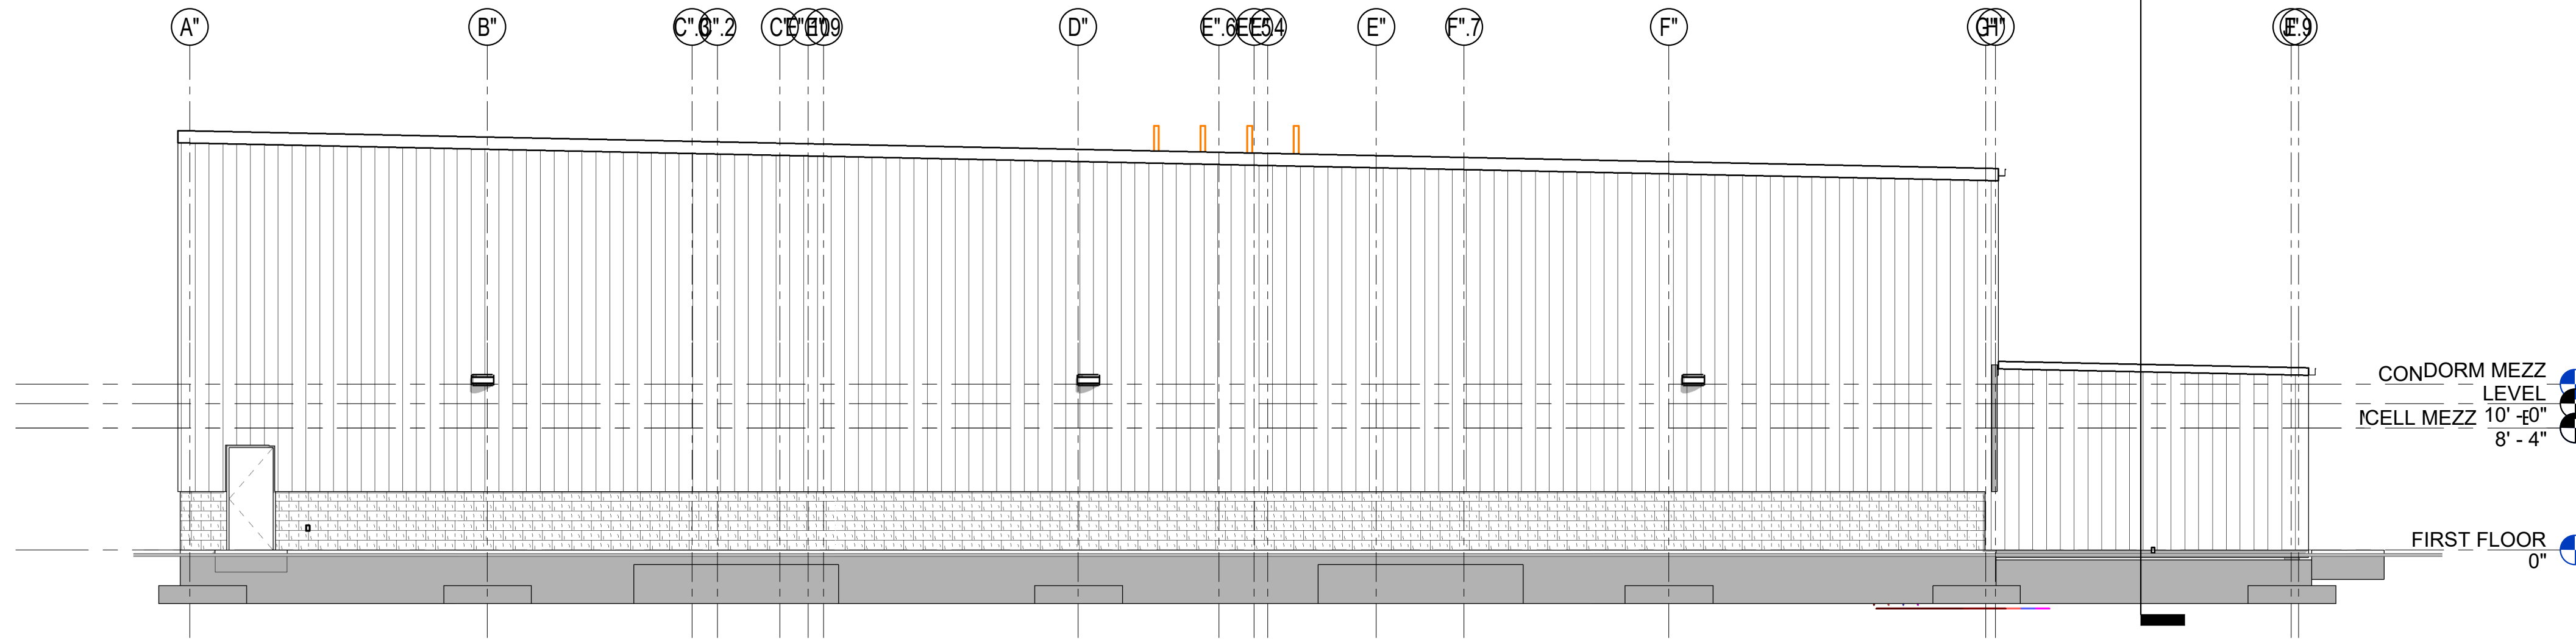

6B BLDG 2 - NORTH ELEVATION  
1/8" = 1'-0"

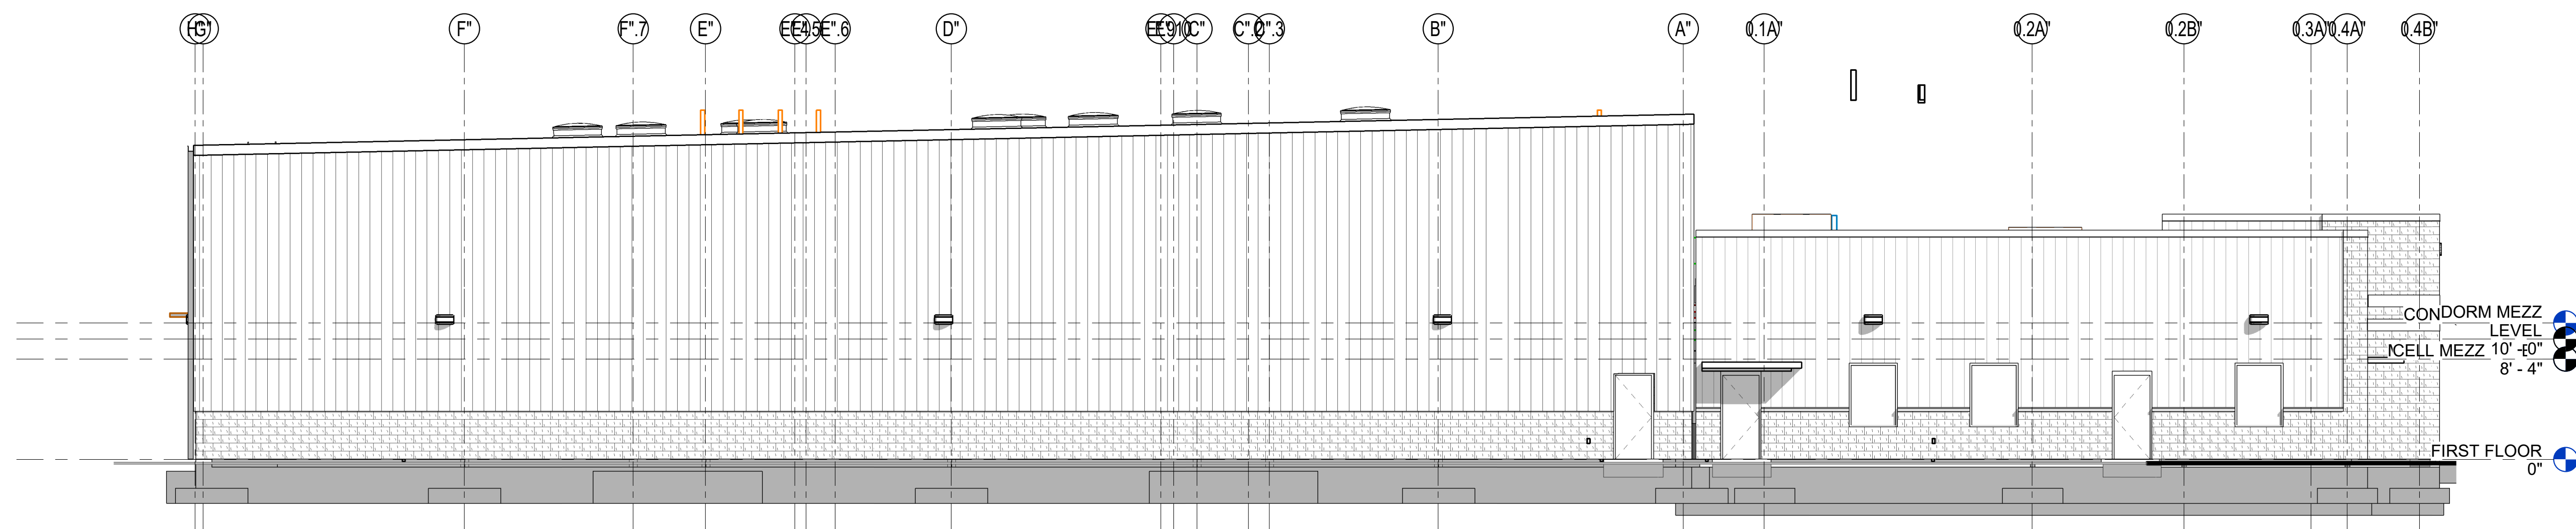

6A BLDG 2 - SOUTH ELEVATION  
1/8" = 1'-0"

5.4.200 - ELEVATION NOTES

Key	Note
1	OVERHEAD COILING DOOR, FINISH AS SELECTED BY ARCHITECT
2	07 71 00 - MANUFACTURED METAL COPING
3	04 20 00 - SPLIT FACE CMU, FINISH AS SELECTED BY ARCHITECT. PROVIDE CONTROL JOINT AT 2'-8" OF EACH CORNER AND 20'-0" O.C.
4	SMOOTH FACE CMU VENEER INTEGRAL COLOR
5	08 11 13 - HOLLOW METAL DOOR AND FRAME, SEE DOOR SCHEDULE
6	SECURITY HOLLOW METAL DOOR AND FRAME, SEE DOOR SCHEDULE
7	13 34 49 - PREENGINEERED METAL BUILDING, PREFINISHED METAL PANEL, FINISH TYPE - A
8	13 34 49 - PREENGINEERED METAL BUILDING TYPICAL ROOF EDGE RAKE DETAIL
9	13 34 49 - PREENGINEERED METAL BUILDING TYPICAL GUTTER
10	13 34 49 - PREENGINEERED METAL BUILDING TYPICAL DOWNSPOUT
11	08 41 13 - PREFINISHED ALUMINUM STOREFRONT SYSTEM
12	EXISTING BUILDING TO REMAIN, PROTECT DURING CONSTRUCTION, ANY DAMAGED CAUSED DURING CONSTRUCTION IS TO BE REPAIRED AT CONTRACTORS EXPENSE
13	MANUFACTURED METAL CANOPY MAPES STYLE OR EQUAL
14	ENGINEERED METAL CANOPY LOUVER SUN SHADES
15	MANUFACTURED DIMENSIONAL CAST ALUMINUM LETTERS
16	WALL TO WALL EXTERIOR EXPANSION JOINT COVER, PROVIDE AIRWEATHER BARRIER AND STUFF CAVITY WITH BATT INSULATION RATED



BID SET

KNOX COUNTY BOARD OF COMMISSIONERS

KNOX COUNTY JUSTICE CAMPUS

2375 OLD DECKER RD. VINCENNES, IN 47591

#	Revision	Date
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Project #: 20-700-151-2

Designed By: LD


Drawn By: WD

Checked By: LD/EV

Date: 01.28.2022




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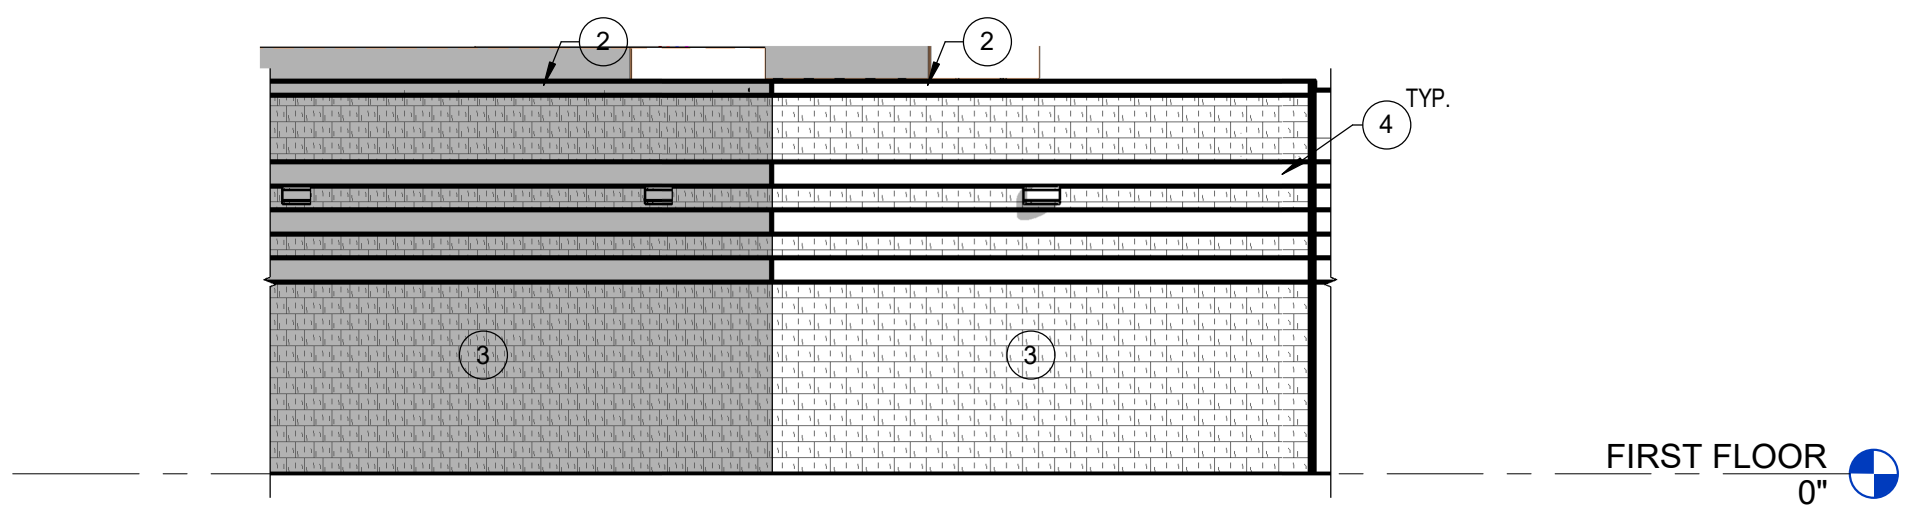


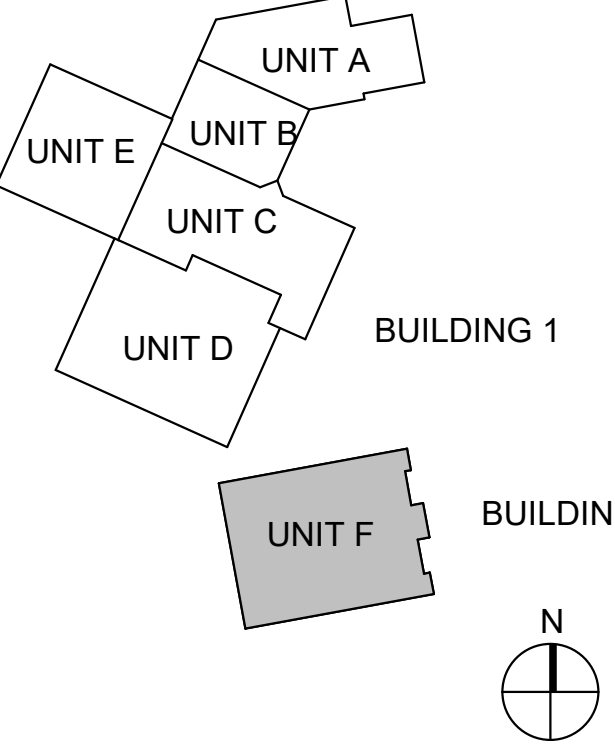OVERALL ELEVATIONS - BUILDING 2




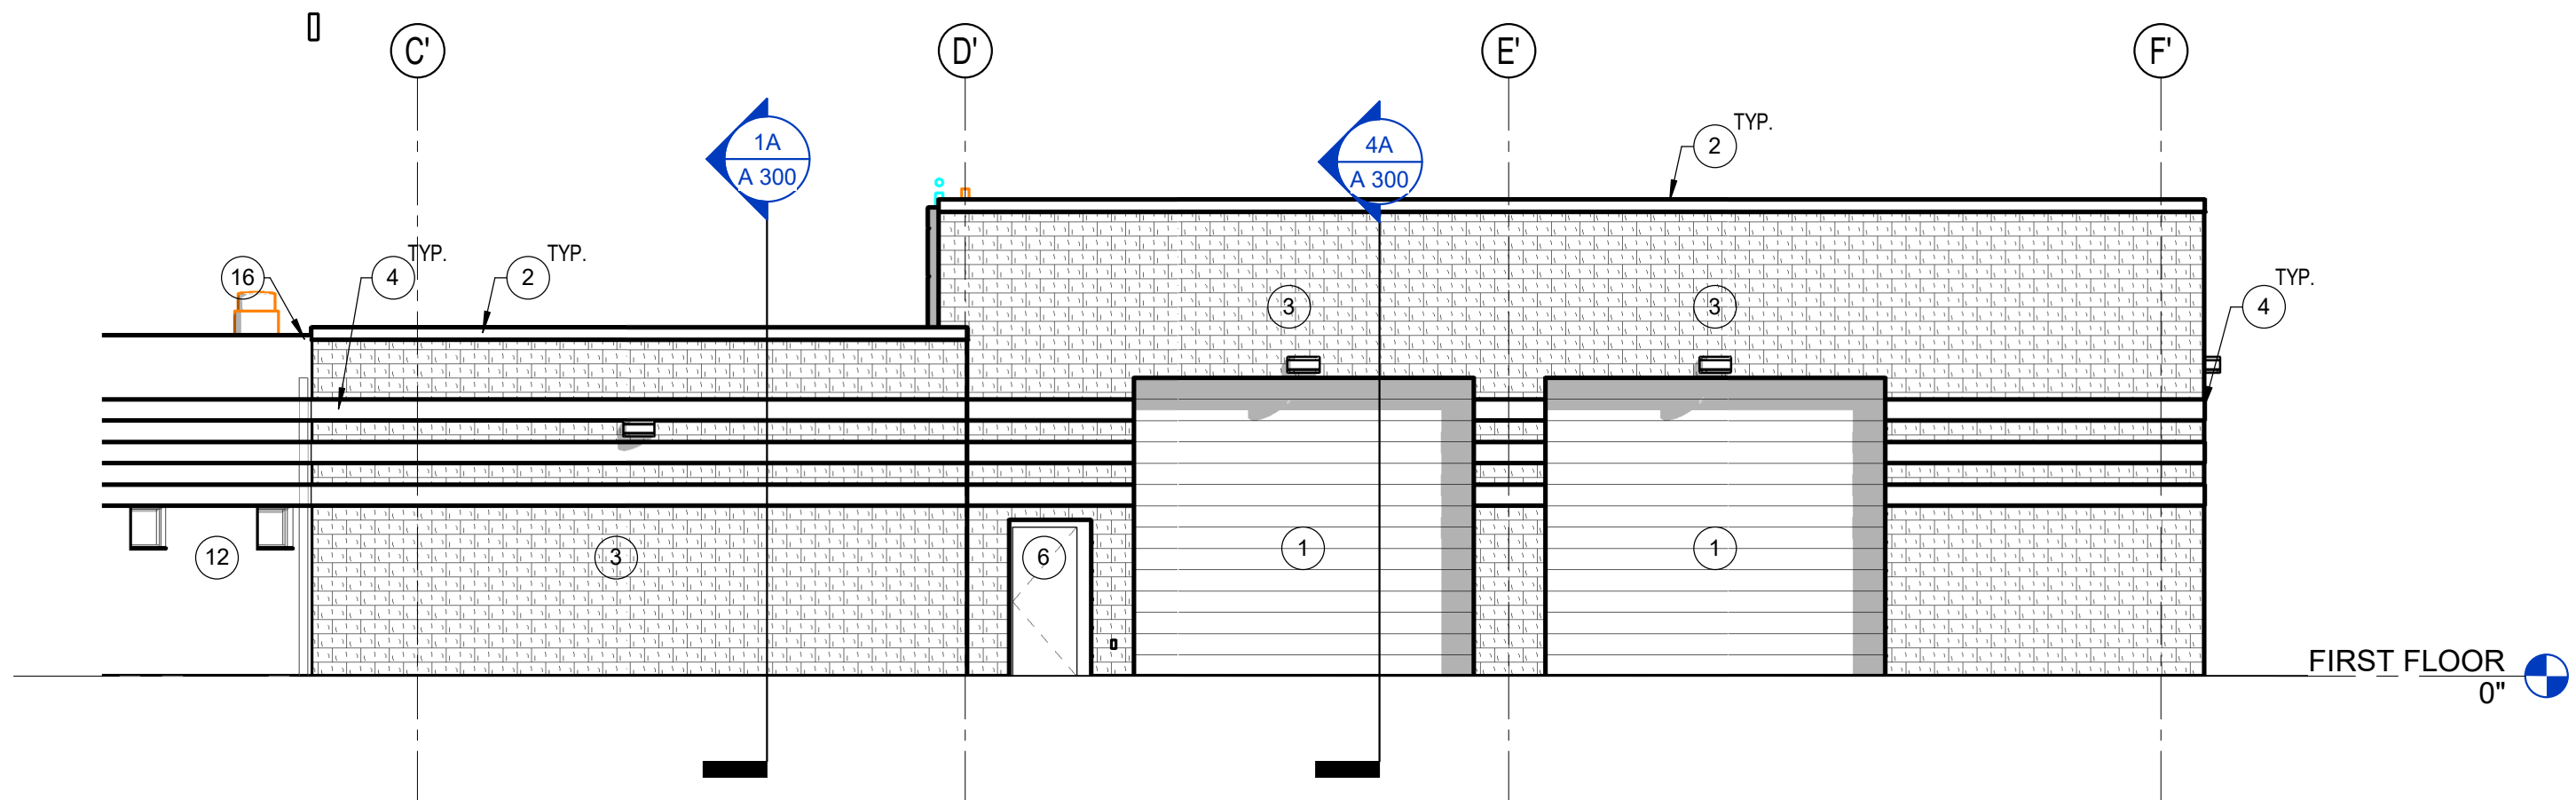


2E UNIT A - SOUTH  
1/8" = 1'-0"



5C UNIT A - WEST ELEVATION  
1/8" = 1'-0"

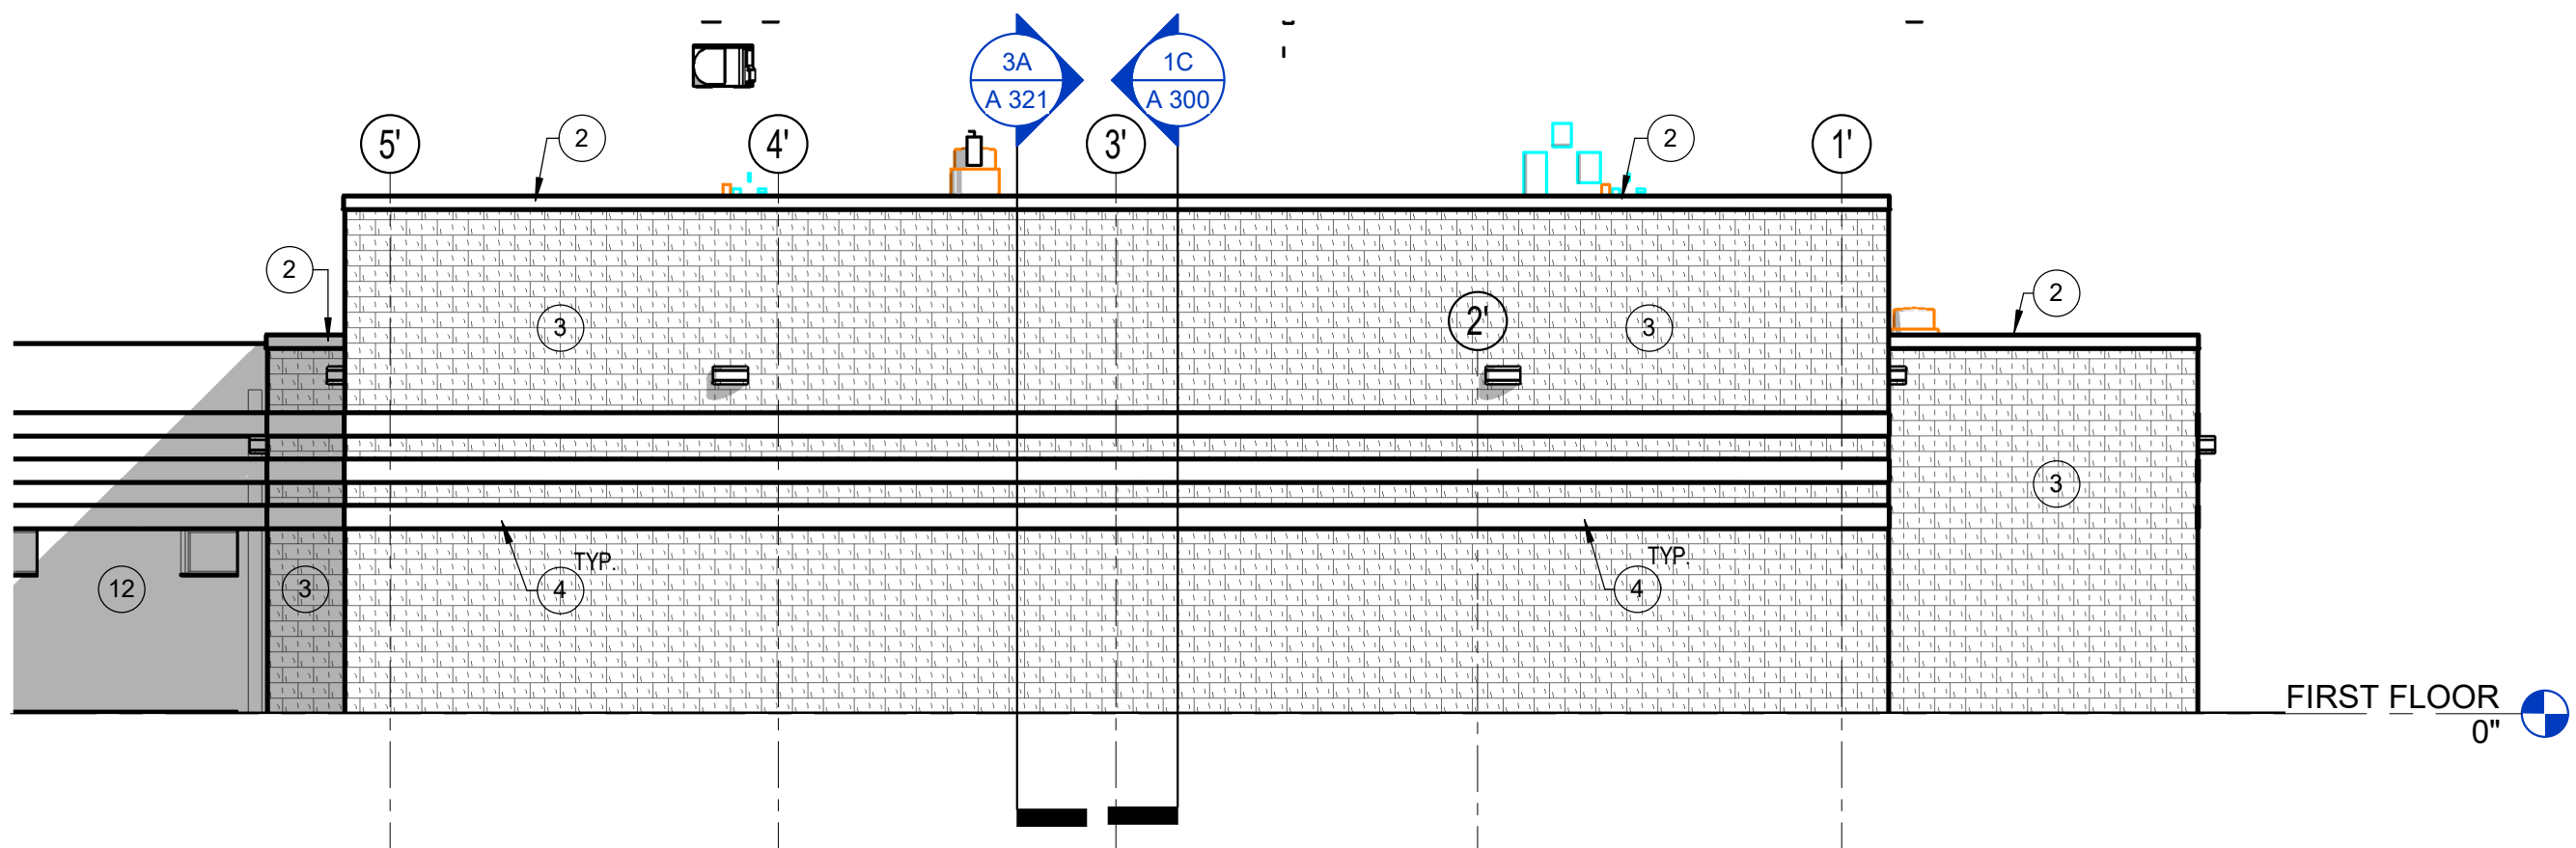

2C UNIT A - EAST  
1/8" = 1'-0"

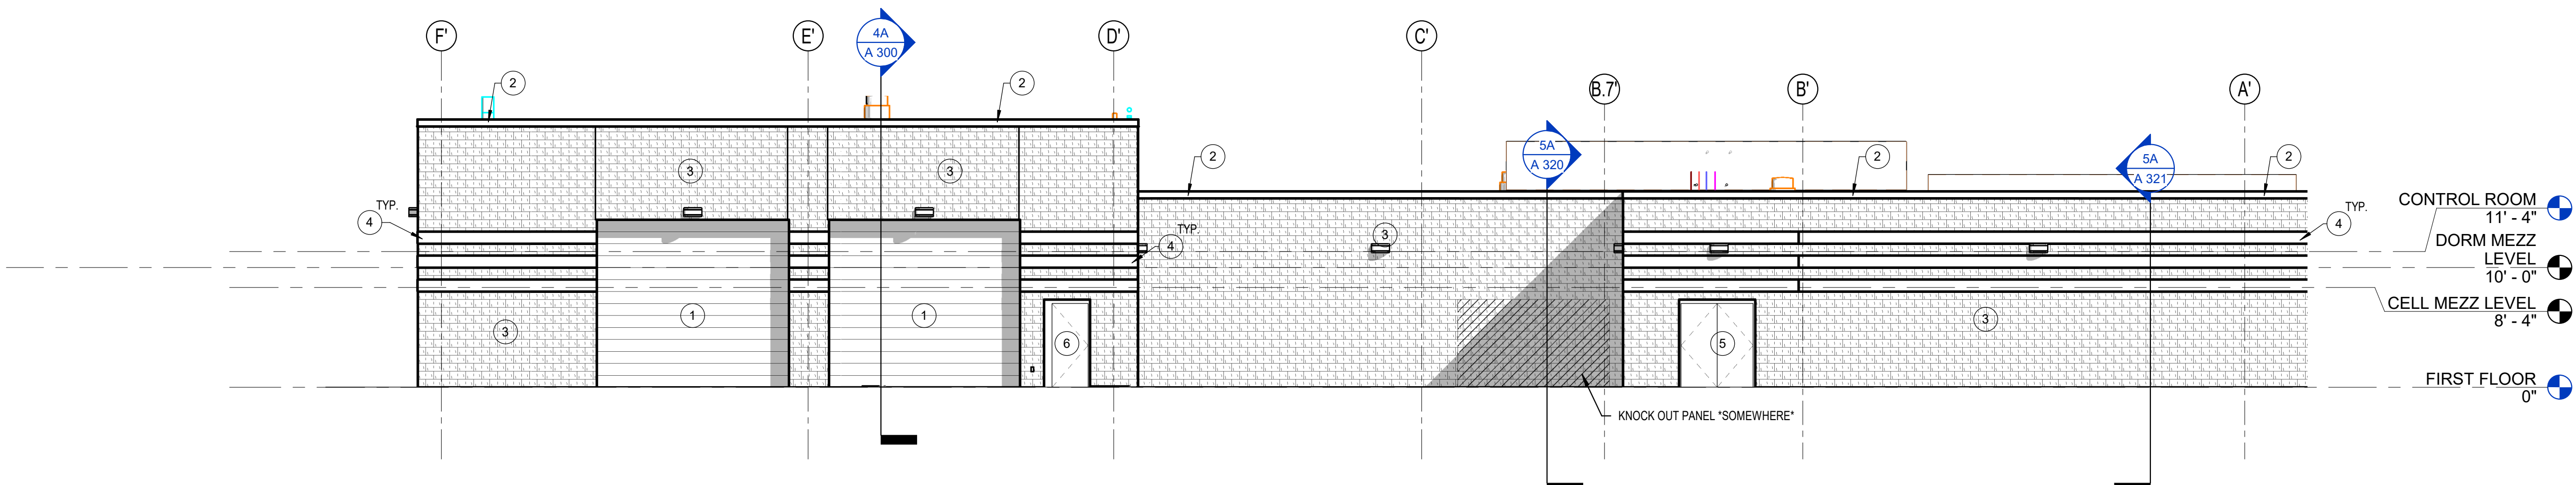

2A UNIT A - NORTH  
1/8" = 1'-0"

## 5.4.200 - ELEVATION NOTES


Key	Note
1	OVERHEAD COILING DOOR, FINISH AS SELECTED BY ARCHITECT
2	07 71 00 - MANUFACTURED METAL COPING
3	04 20 00 - SPLIT FACE CMU, FINISH AS SELECTED BY ARCHITECT. PROVIDE CONTROL JOINT AT 2'-8" OF EACH CORNER AND 20'-0" O.C.
4	SMOOTH FACE CMU VENEER INTEGRAL COLOR
5	08 11 13 - HOLLOW METAL DOOR AND FRAME, SEE DOOR SCHEDULE
6	SECURITY HOLLOW METAL DOOR AND FRAME, SEE DOOR SCHEDULE
7	13 34 49 - PREENGINEERED METAL BUILDING, PREFINISHED METAL PANEL, FINISH TYPE - A
8	13 34 49 - PREENGINEERED METAL BUILDING TYPICAL ROOF EDGE RAKE DETAIL
9	13 34 49 - PREENGINEERED METAL BUILDING TYPICAL GUTTER
10	13 34 49 - PREENGINEERED METAL BUILDING TYPICAL DOWNSPOUT
11	08 41 13 - PREFINISHED ALUMINUM STOREFRONT SYSTEM
12	EXISTING BUILDING TO REMAIN, PROTECT DURING CONSTRUCTION, ANY DAMAGED CAUSED DURING CONSTRUCTION IS TO BE REPAIRED AT CONTRACTORS EXPENSE
13	MANUFACTURED METAL CANOPY MAPES STYLE OR EQUAL
14	ENGINEERED METAL CANOPY LOUVER SUN SHADES
15	MANUFACTURED DIMENSIONAL CAST ALUMINUM LETTERS
16	WALL TO WALL EXTERIOR EXPANSION JOINT COVER, PROVIDE AIRWEATHER BARRIER AND STUFF CAVITY WITH BATT INSULATION RATED

RQAW  
ARCHITECTURE

BID SET  
KNOX COUNTY BOARD OF COMMISSIONERS  
KNOX COUNTY JUSTICE CAMPUS  
2375 OLD DECKER RD. VINCENNES, IN 47591


#	Revision	Date
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Project #: 20-700-151-2  
Designed By: LD/SP  
Drawn By: JW  
Checked By: LD/EV  
Date: 01.28.2022

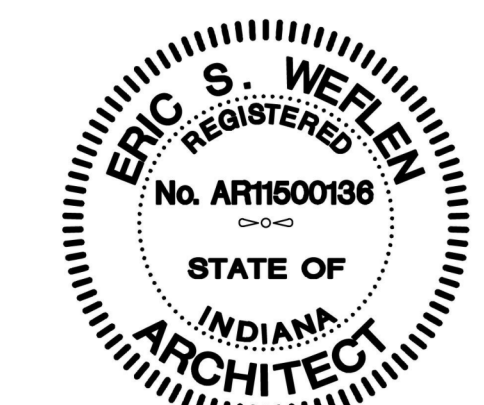

Eric Weylan


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BUILDING ELEVATIONS

A 210

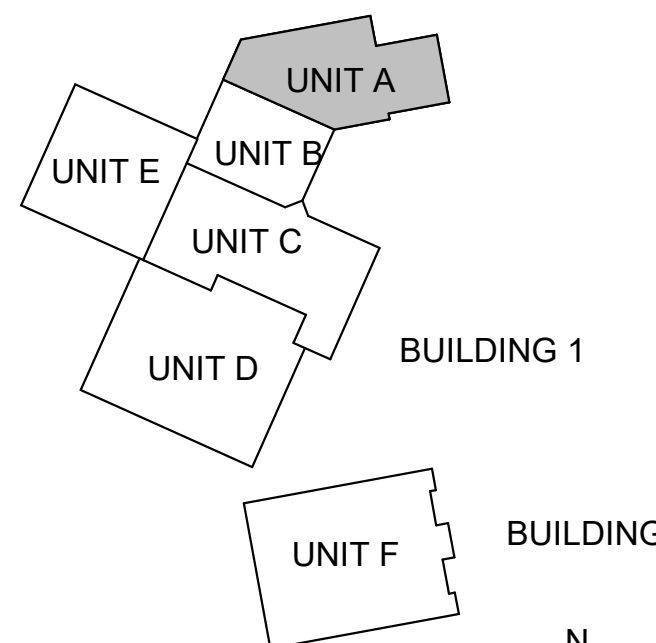



5.4.200 - ELEVATION NOTES	
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KNOX COUNTY JUSTICE CAMPUS

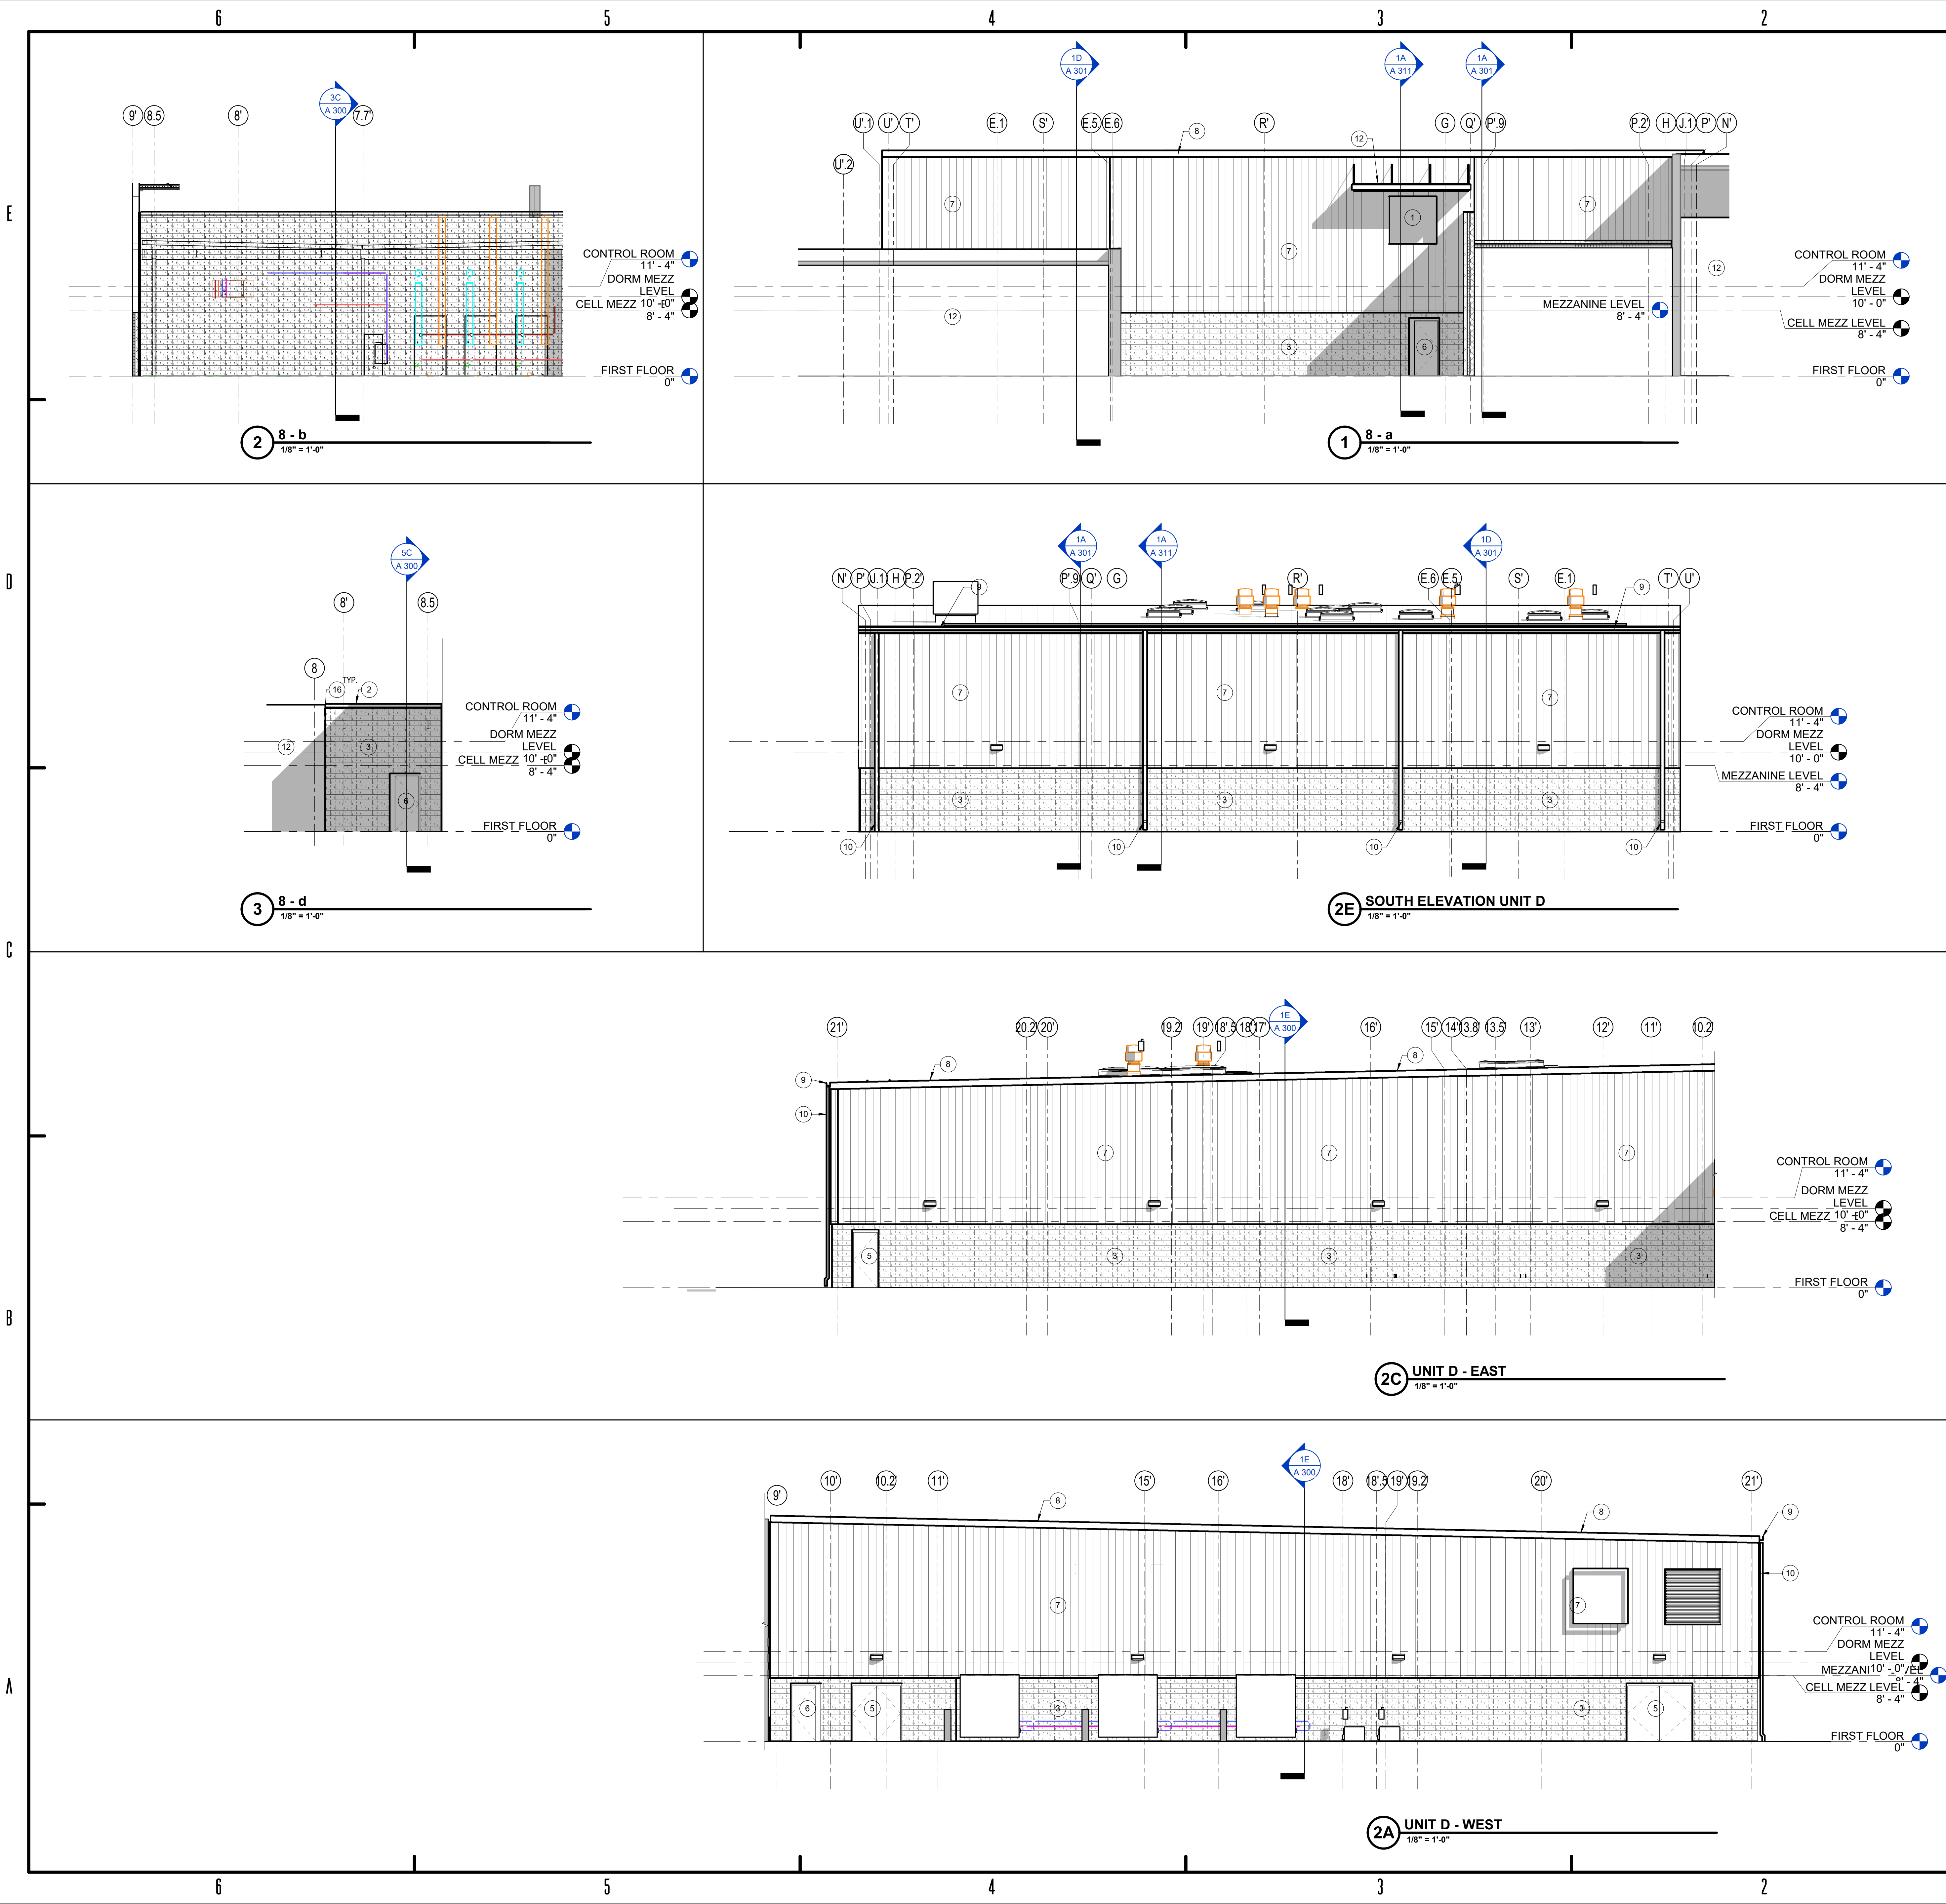2375 OLD DECKER RD. VINCENNES, IN 47591

#	Revision	Date
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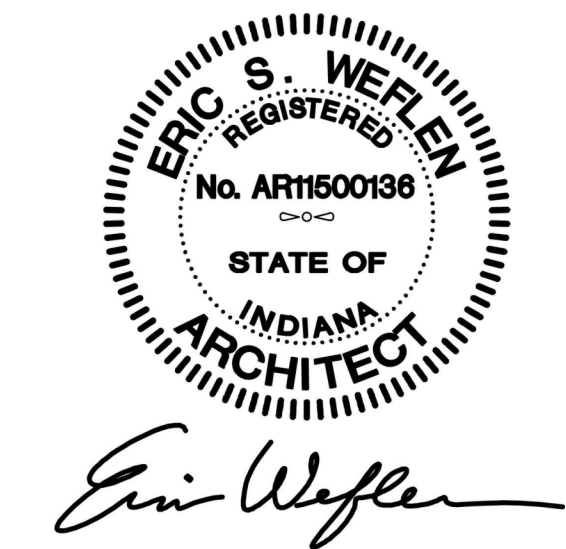
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Designed By: LD/SP


Drawn By: JW

Checked By: LD/EV

Date: 01.28.2022




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BUILDING ELEVATIONS

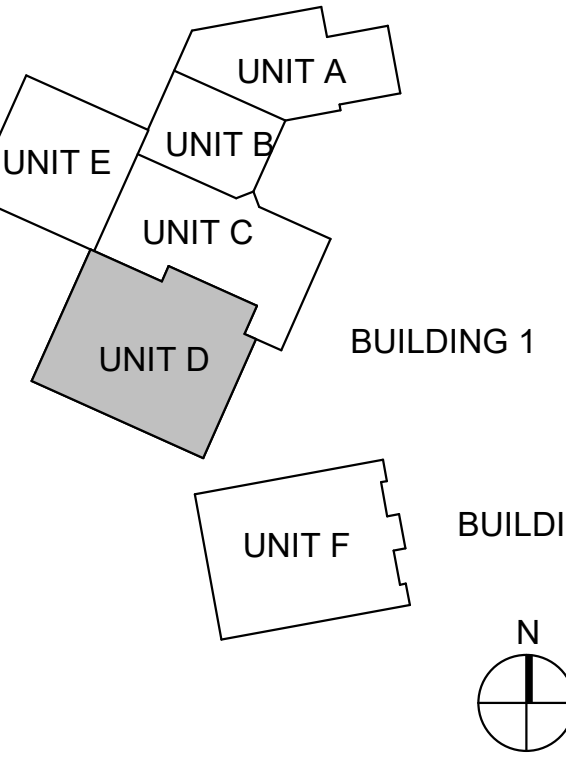



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2375 OLD DECKER RD. VINCENNES, IN 47591
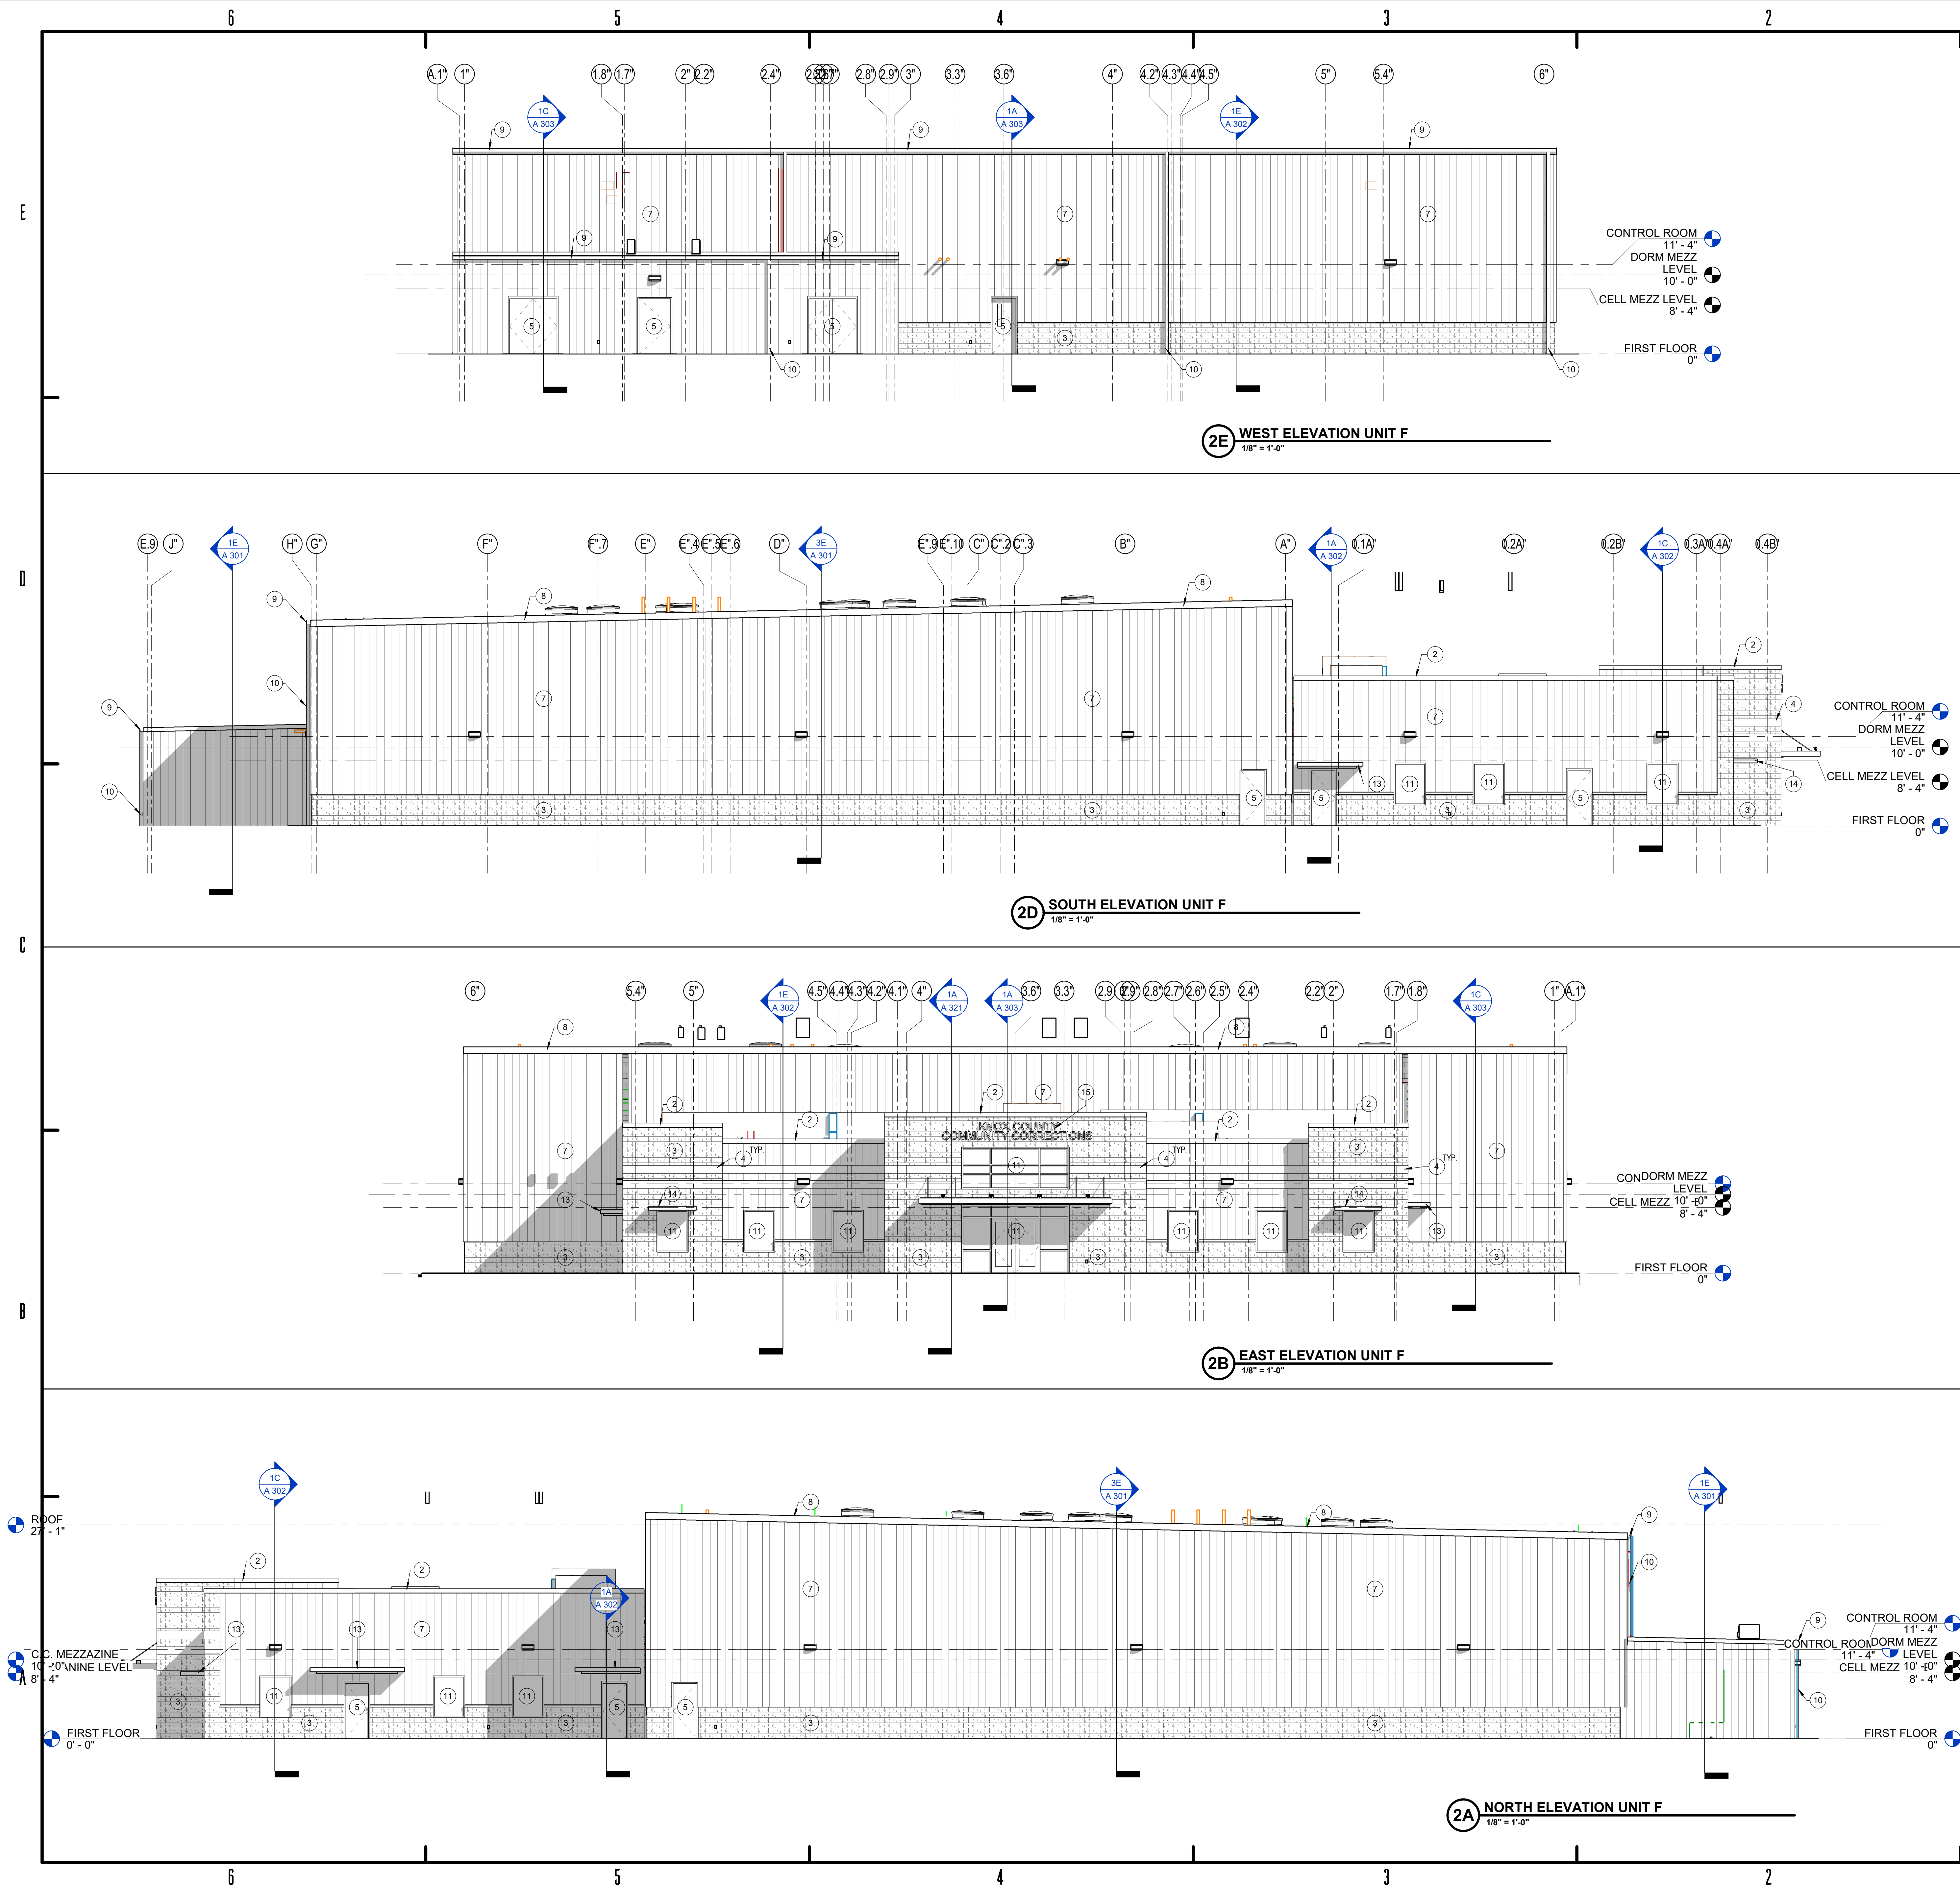
#

Revision

Date

Project # 20-700-151-2

Designed By: LD

Drawn By: WD

Checked By: LD/EV

Date: 01.28.2022

ERIC S. WELLEN

REGISTERED

No. AR1500196

STATE OF INDIANA

ARCHITECT

Eric Wellen

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UNIT A

UNIT B

UNIT C

UNIT D

UNIT E

UNIT F

BUILDING 1


BUILDING 2

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BUILDING ELEVATIONS

A 212



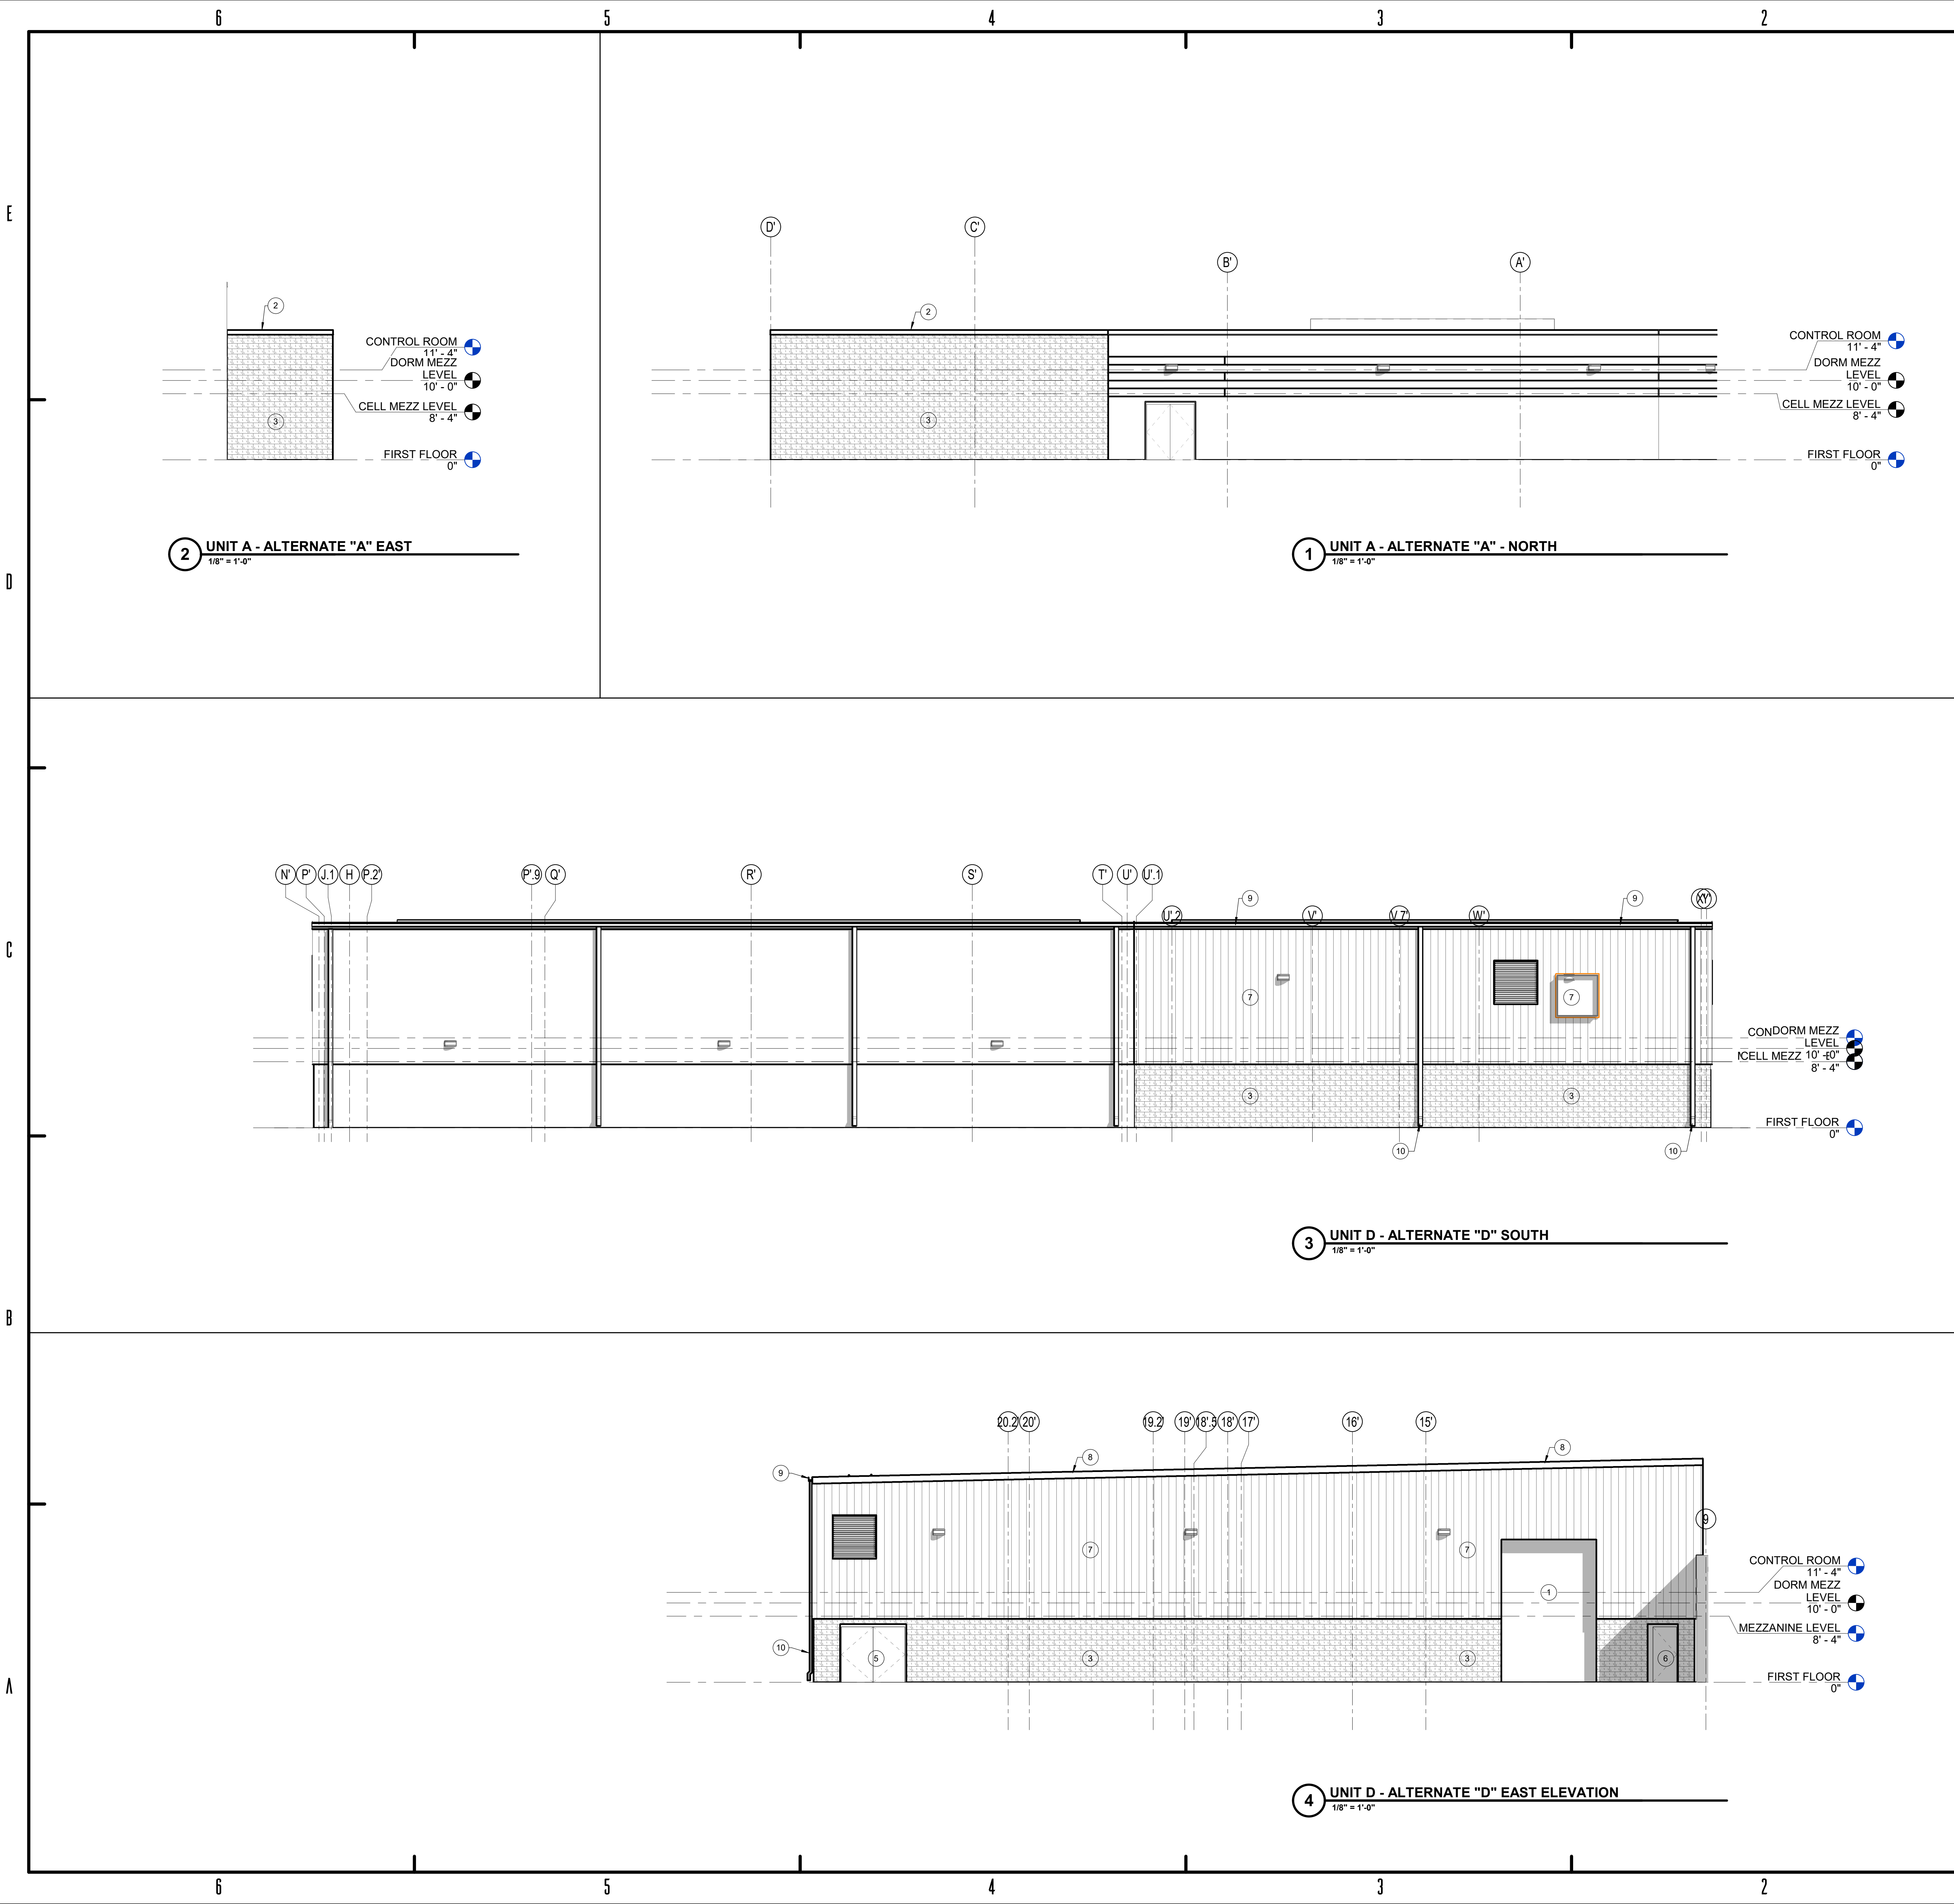

5.4.200 - ELEVATION NOTES	
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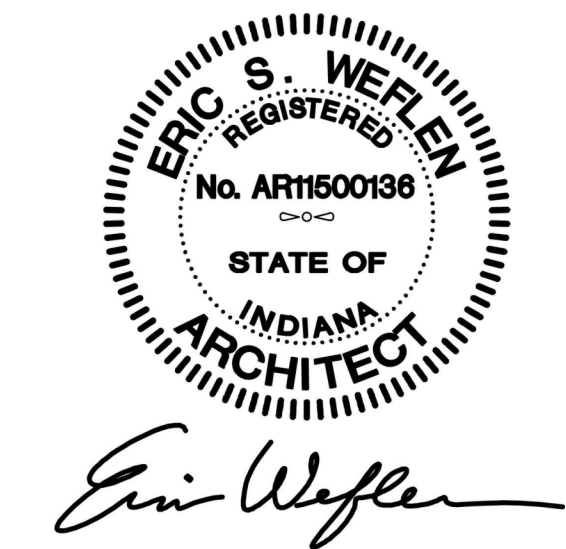
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Designed By: Designer


Drawn By: Author

Checked By: Checker

Date: 01.28.2022



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ALTERNATE BUILDING ELEVATIONS

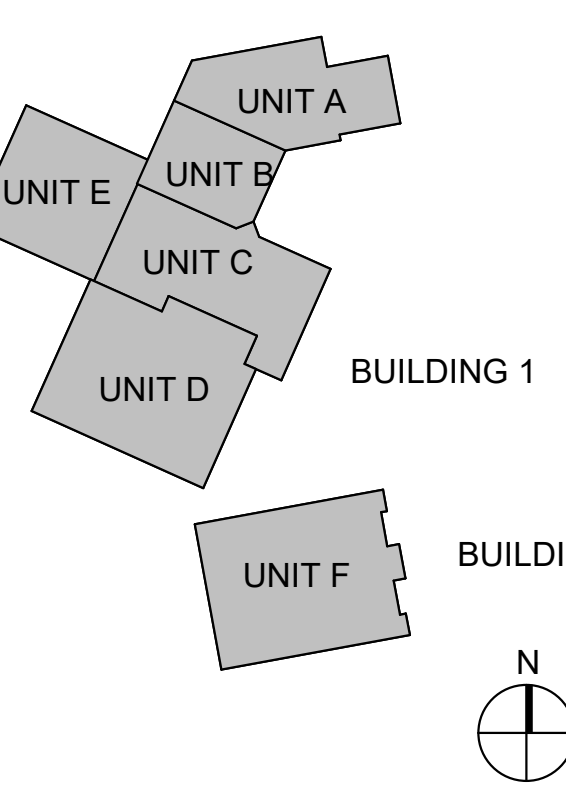


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Designed By: LD/SP  
Drawn By: CP  
Checked By: LD/EV  
Date: 02.04.2022




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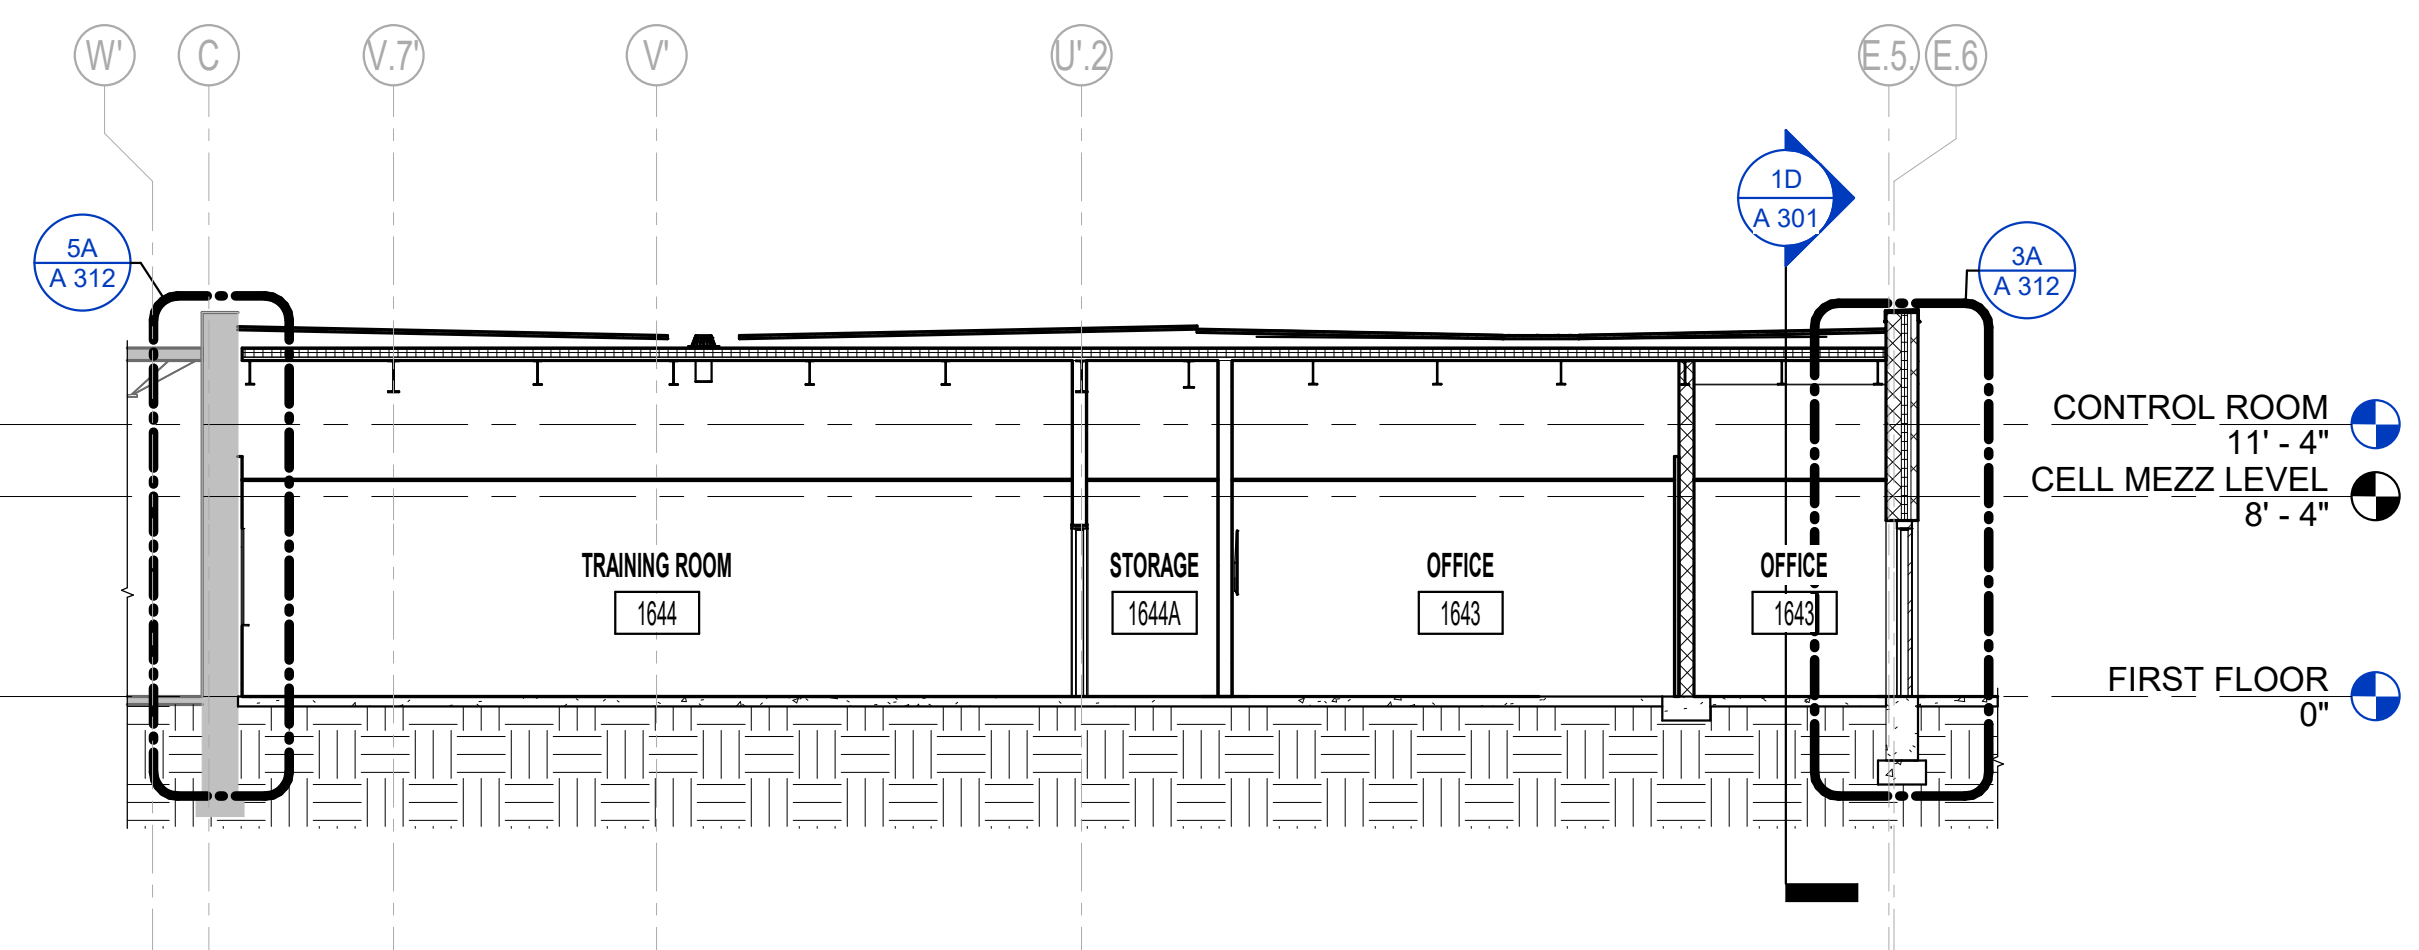


BUILDING SECTIONS

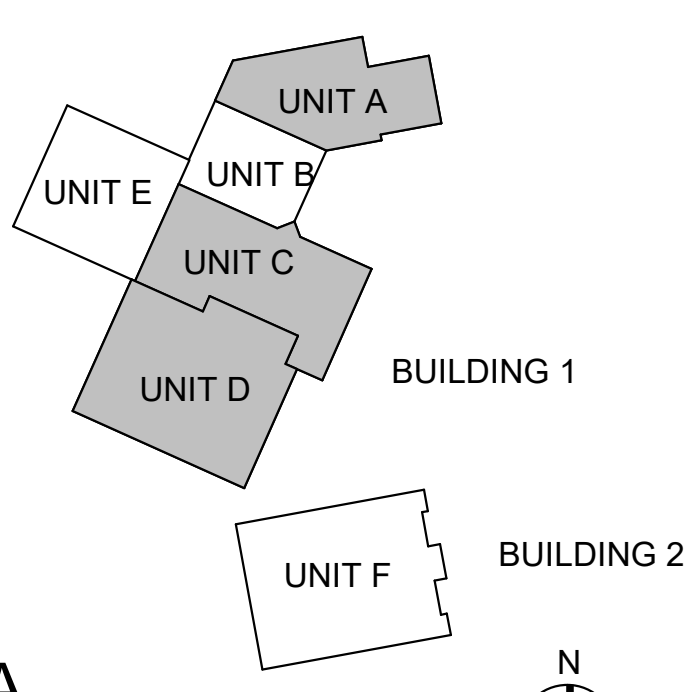
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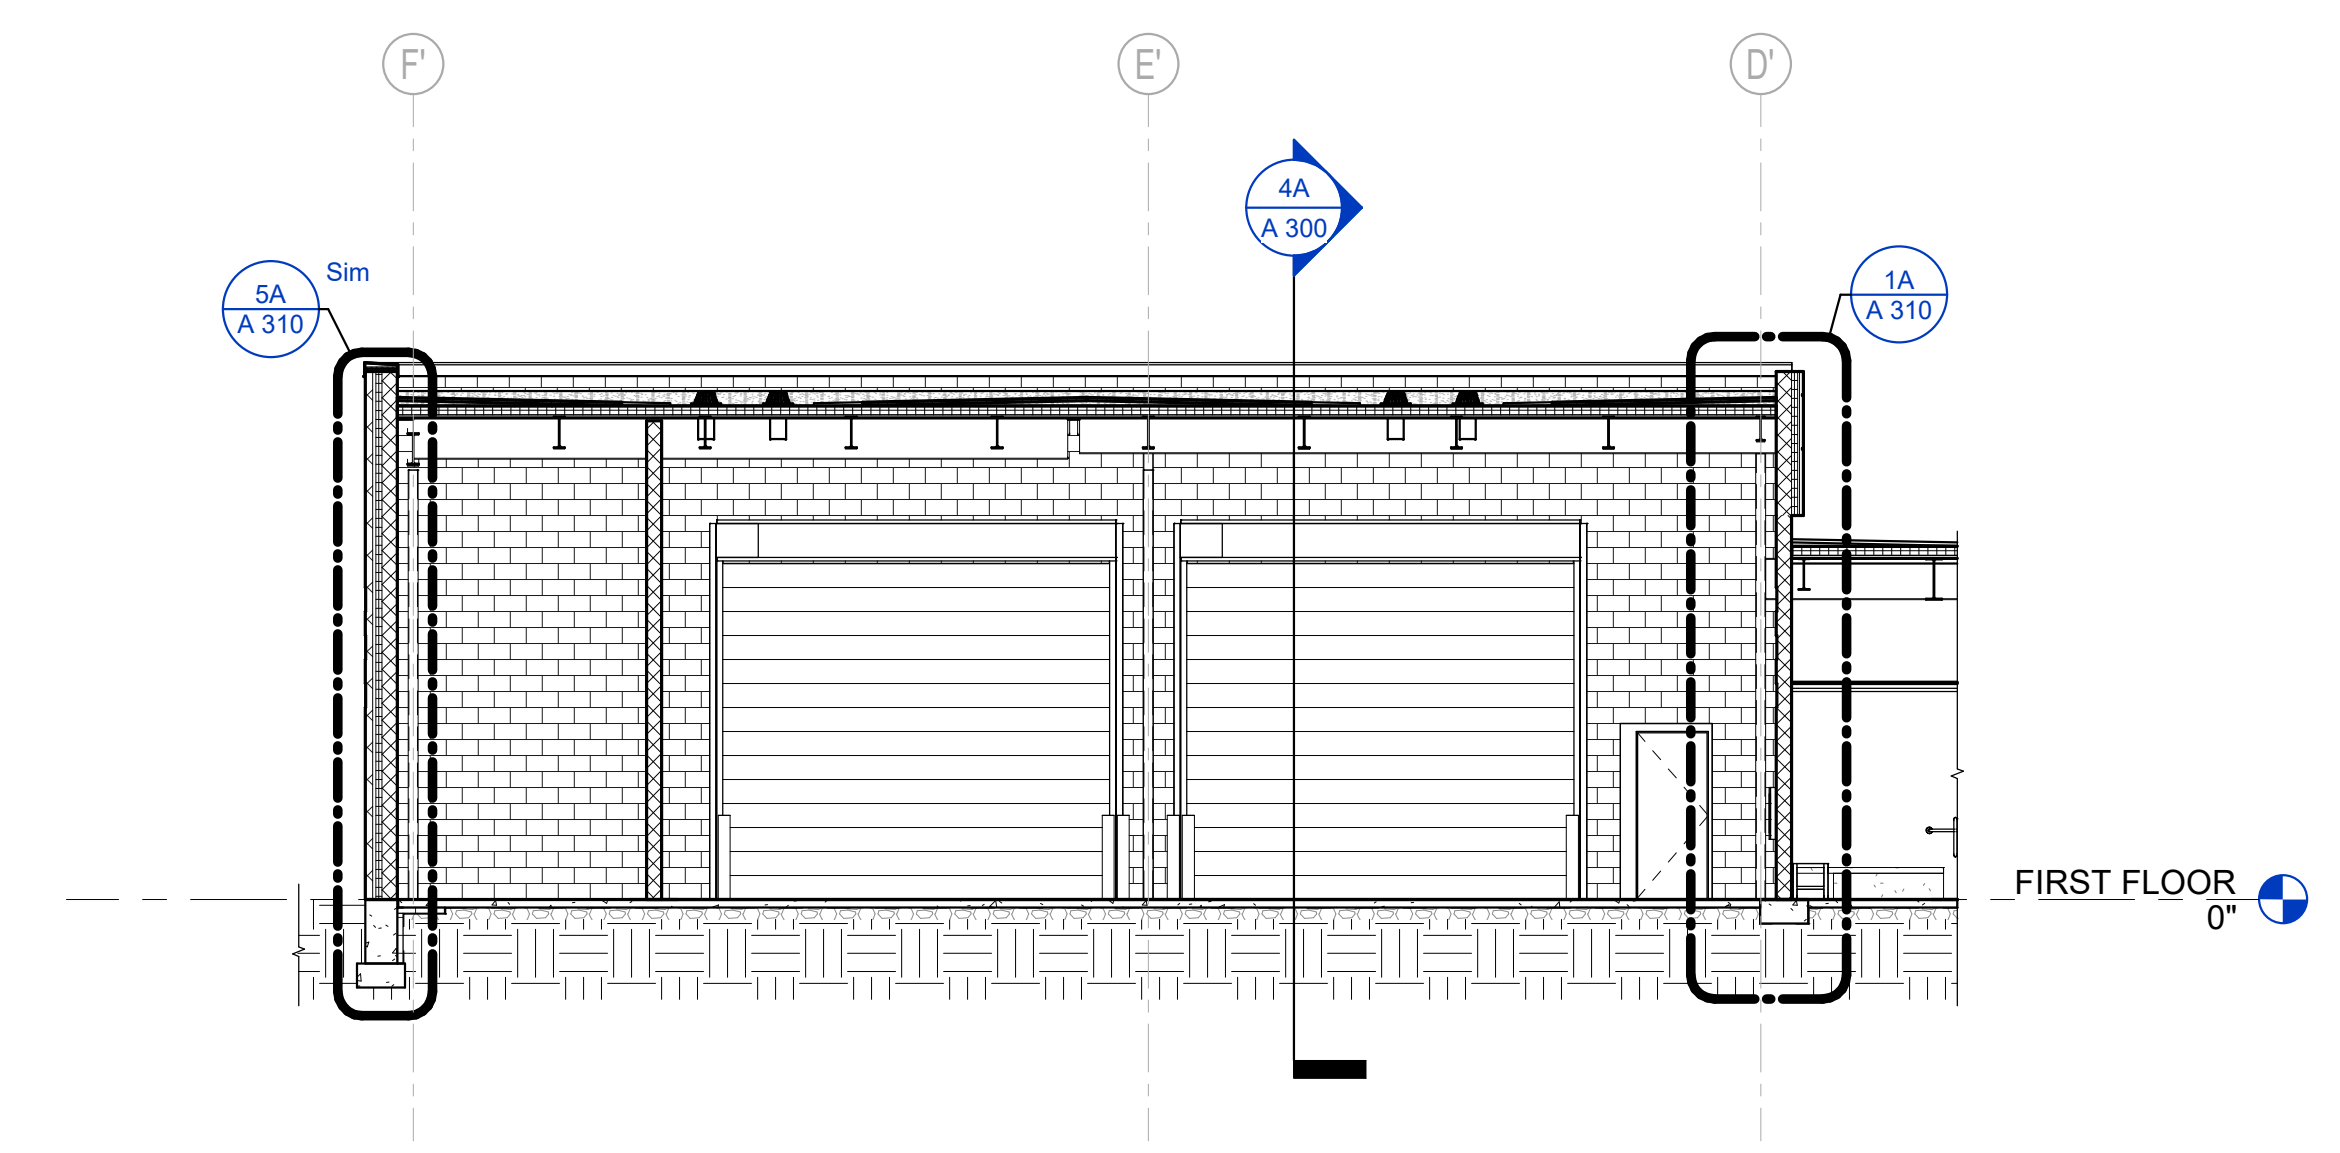
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1/8" = 1'-0"

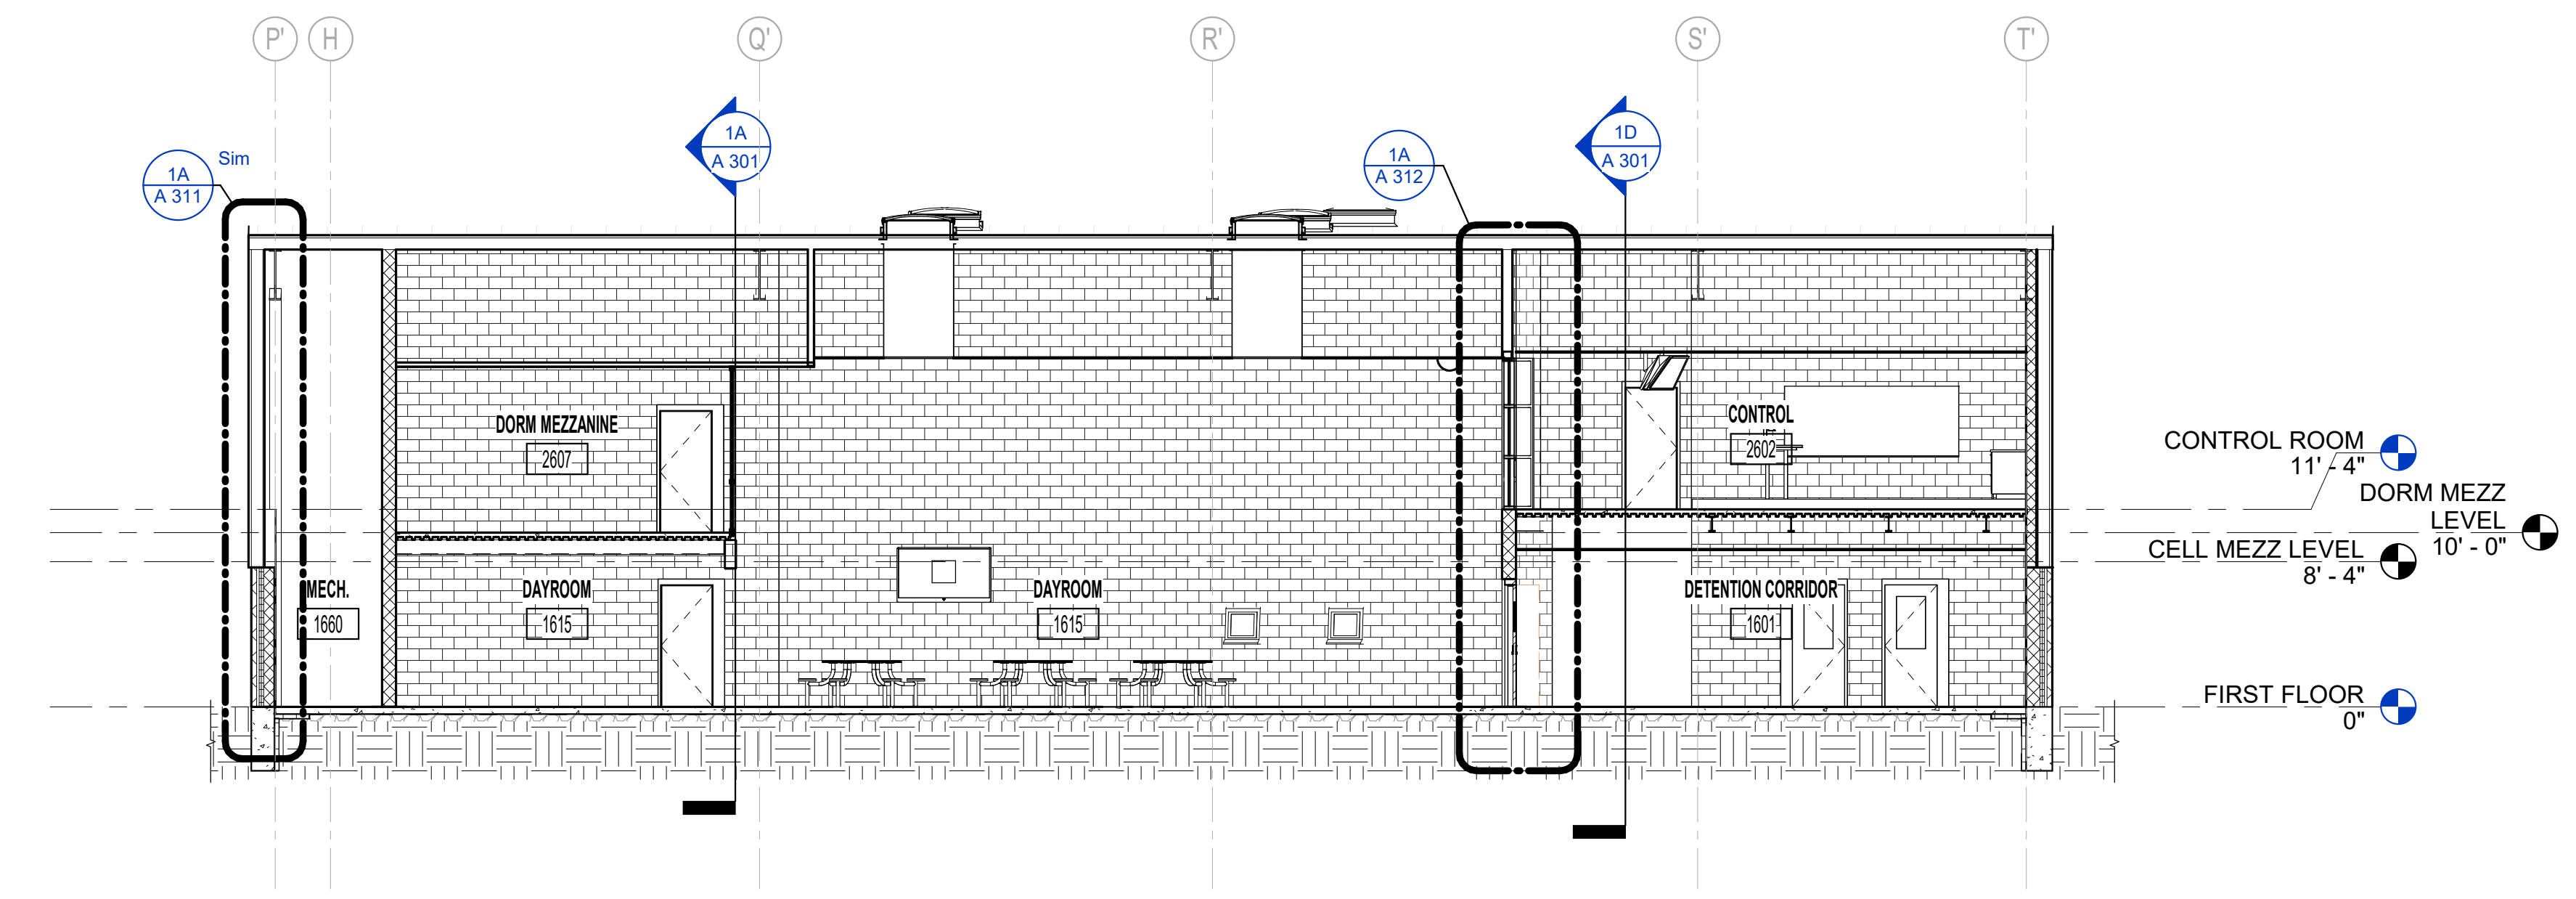


5C BUILDING SECTION 5.0  
1/8" = 1'-0"




3C BUILDING SECTION 4.0  
1/8" = 1'-0"

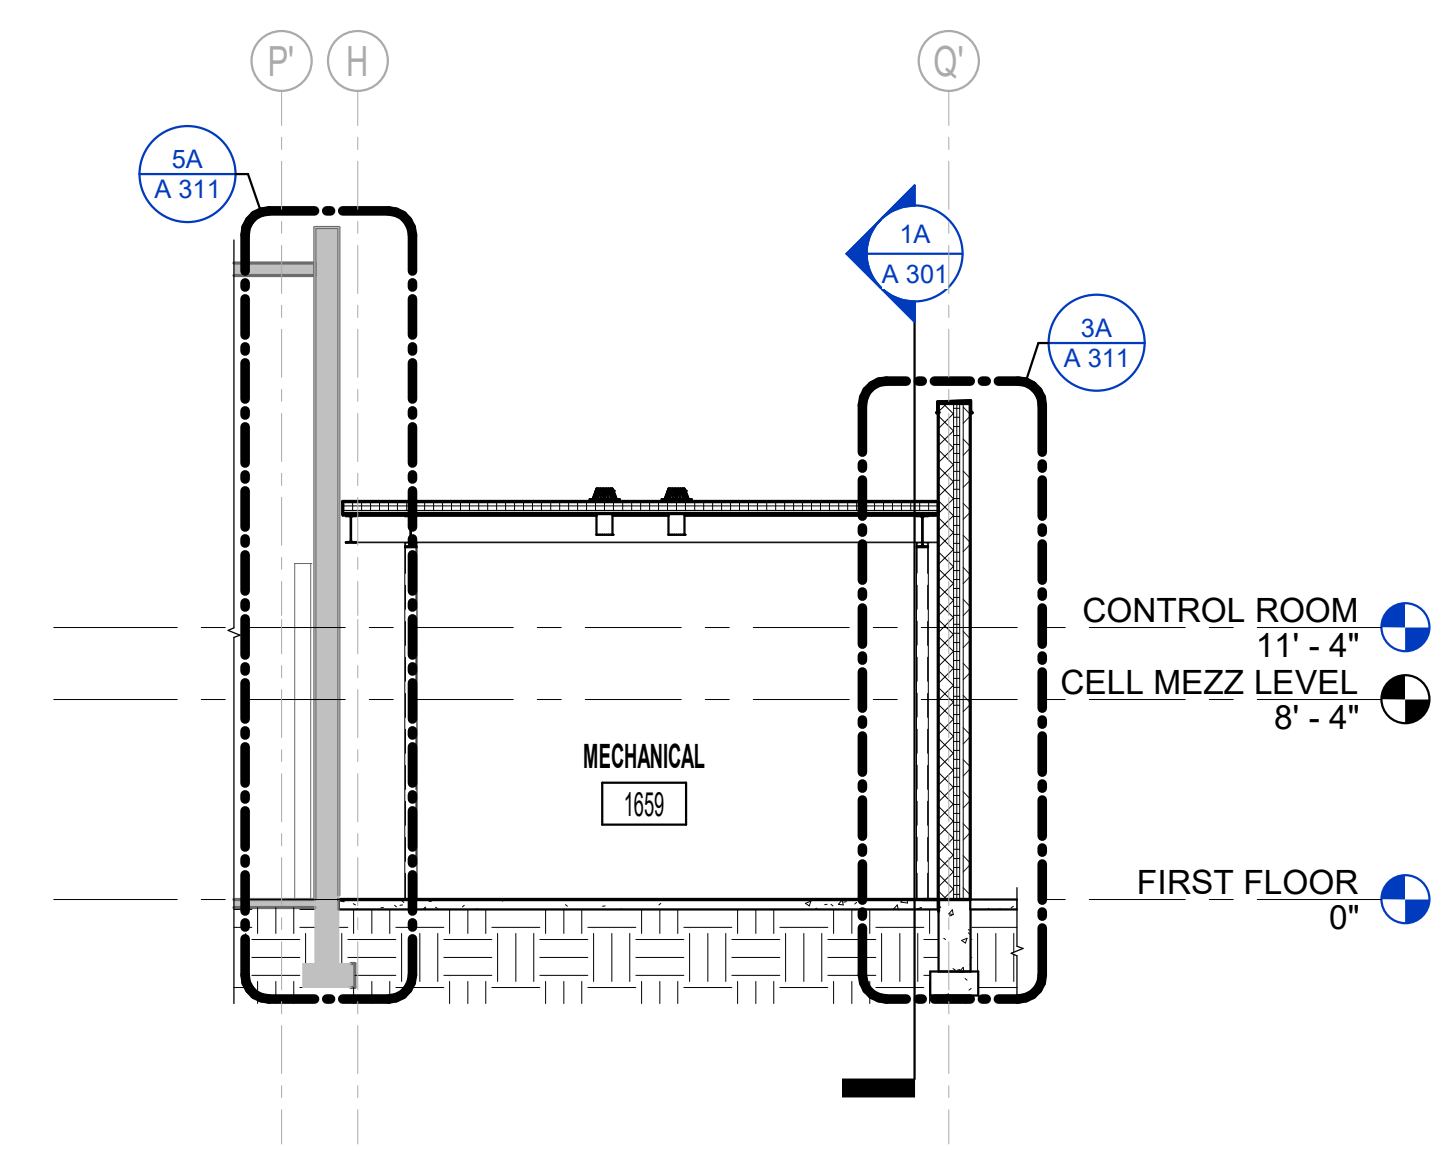

1C BUILDING SECTION 3.0  
1/8" = 1'-0"

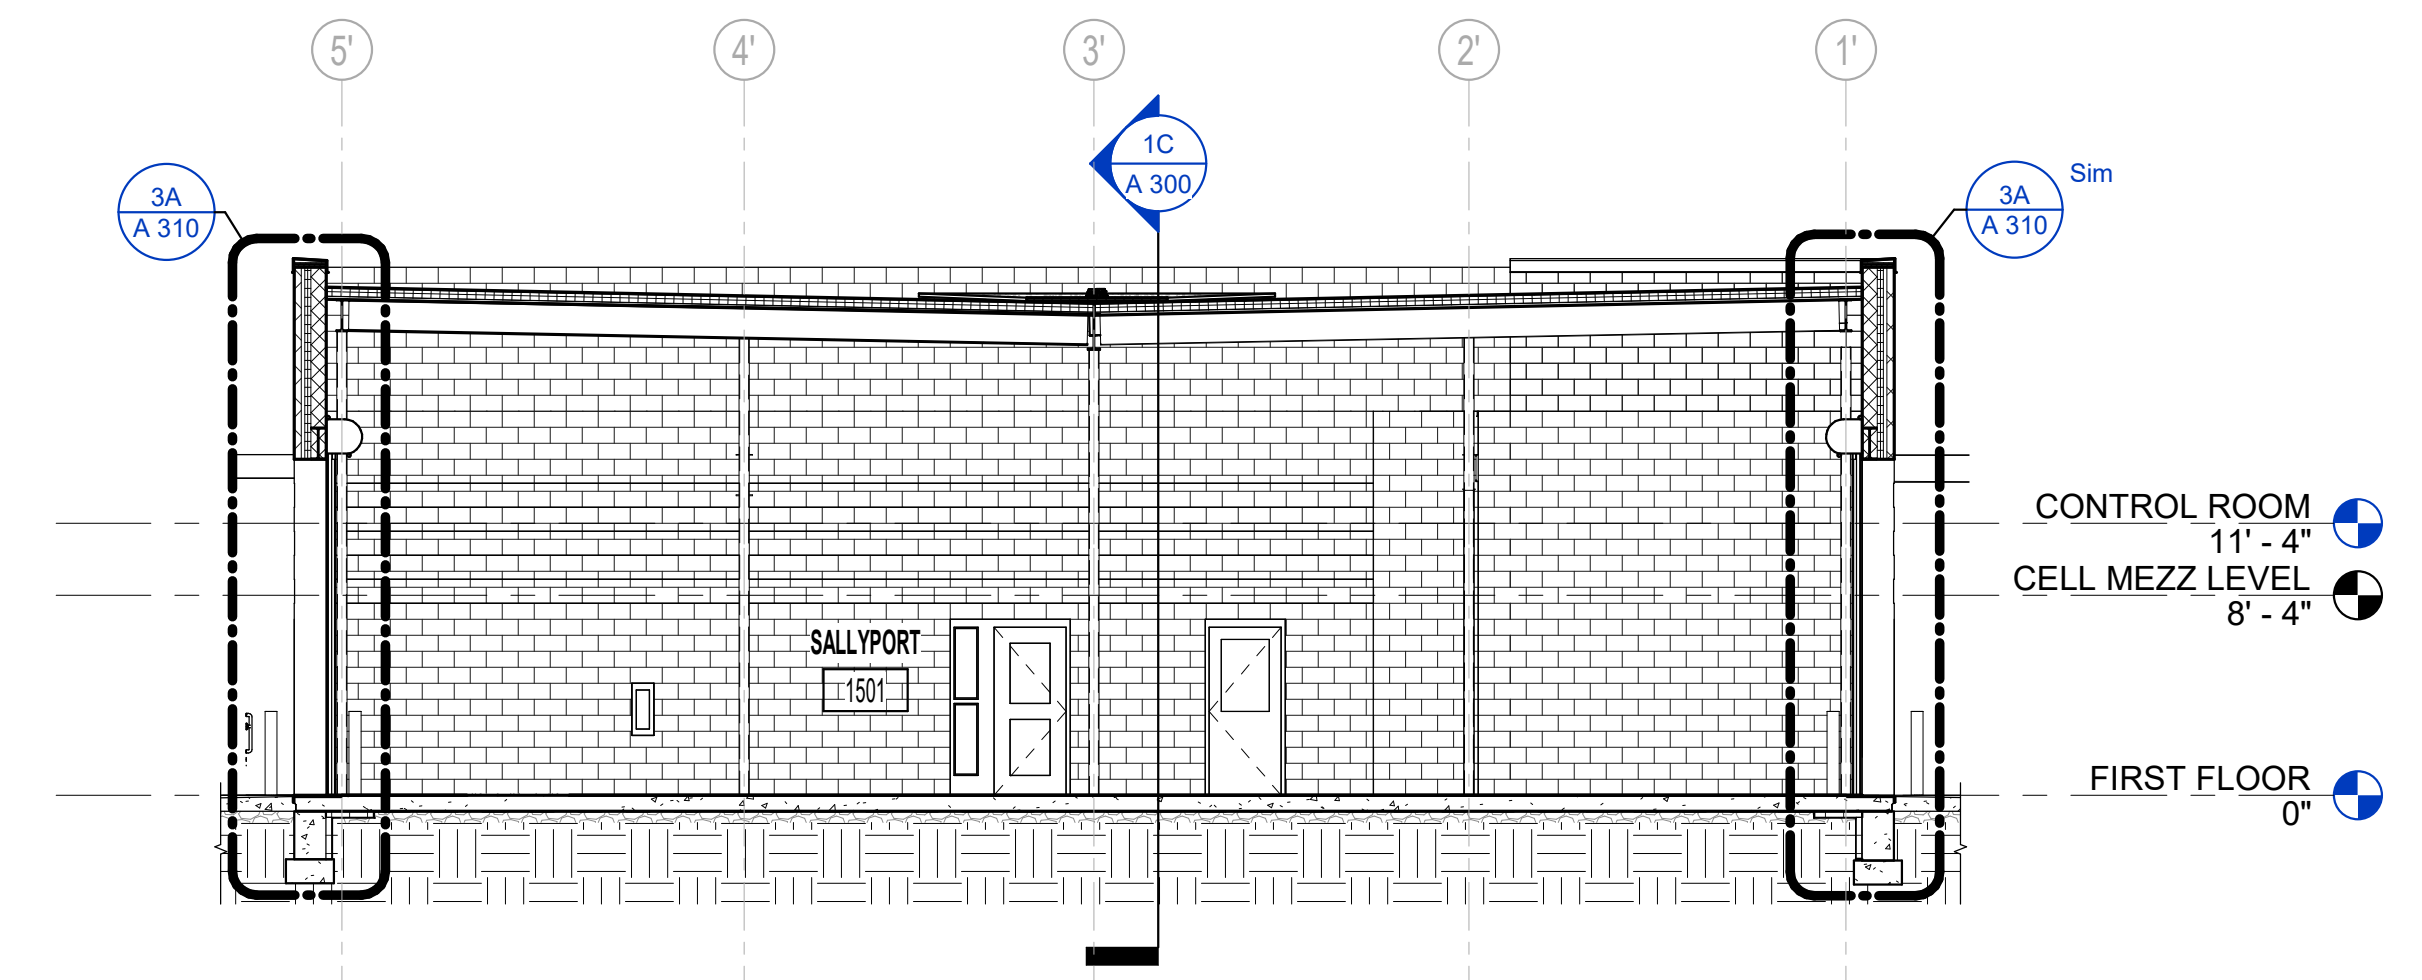

4A BUILDING SECTION 2.0  
1/8" = 1'-0"

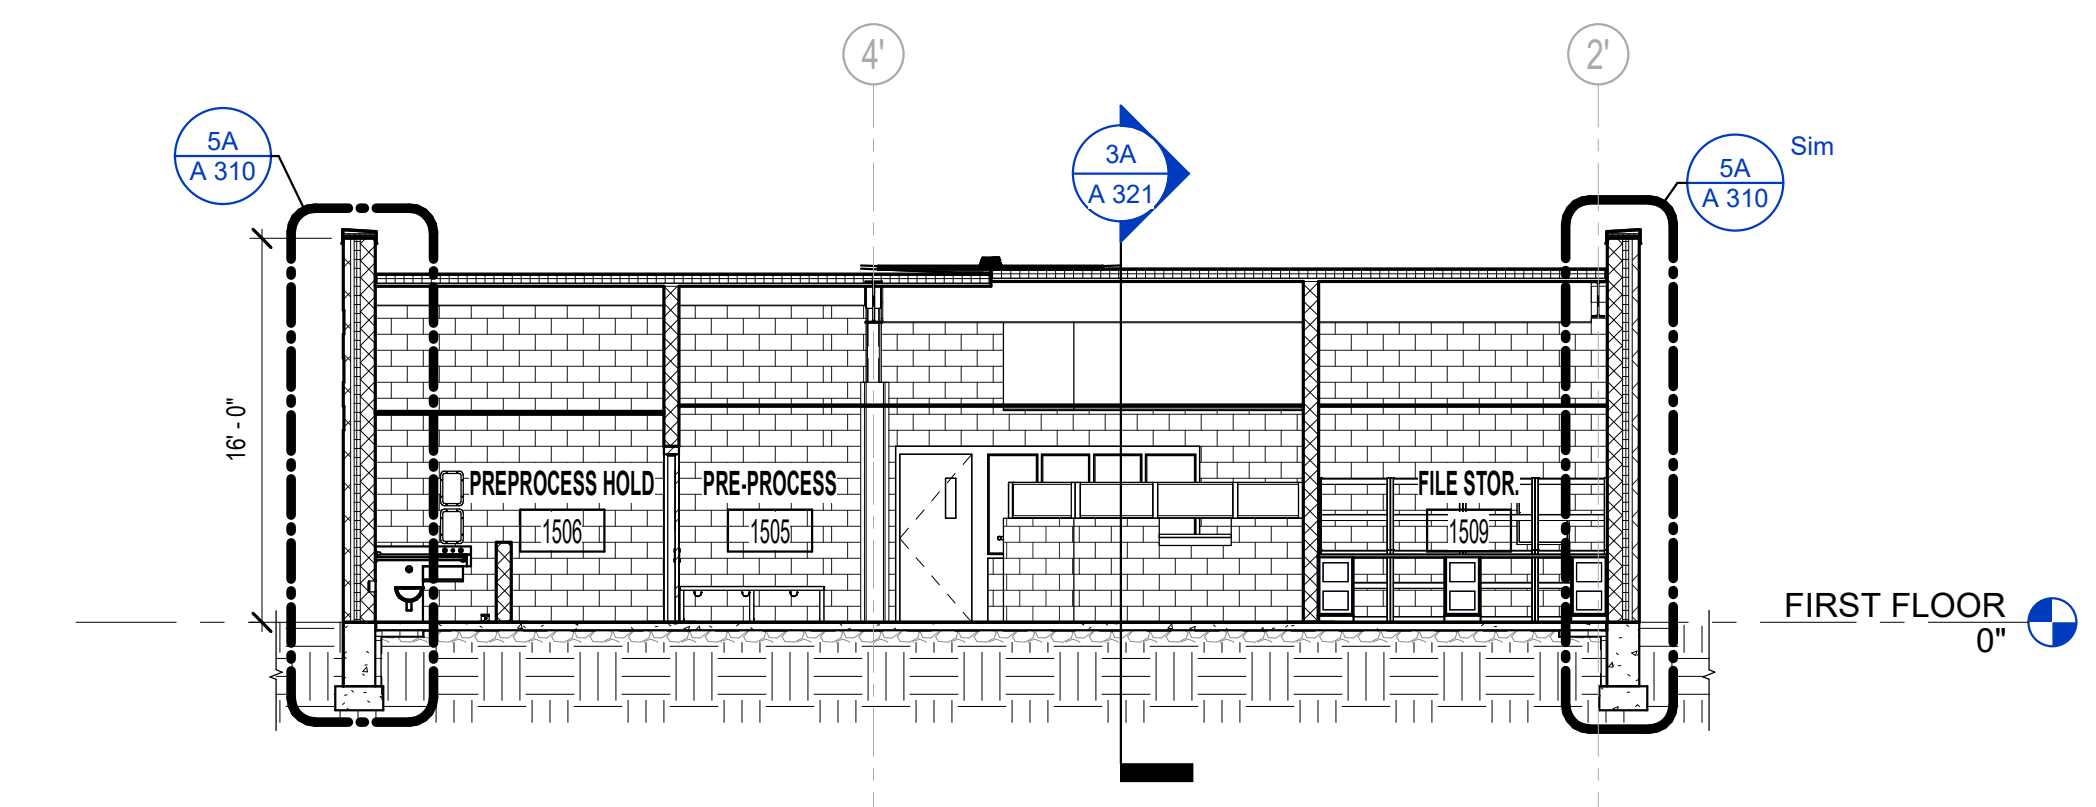


1A BUILDING SECTION 1.0  
1/8" = 1'-0"





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Designed By: LD/SP  
Drawn By: CP  
Checked By: LD/EV  
Date: 02.04.2022

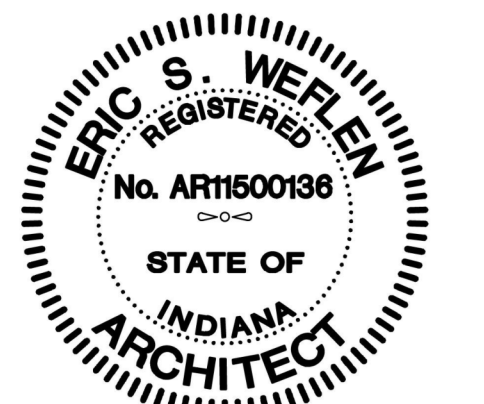


*Eric Wepler*


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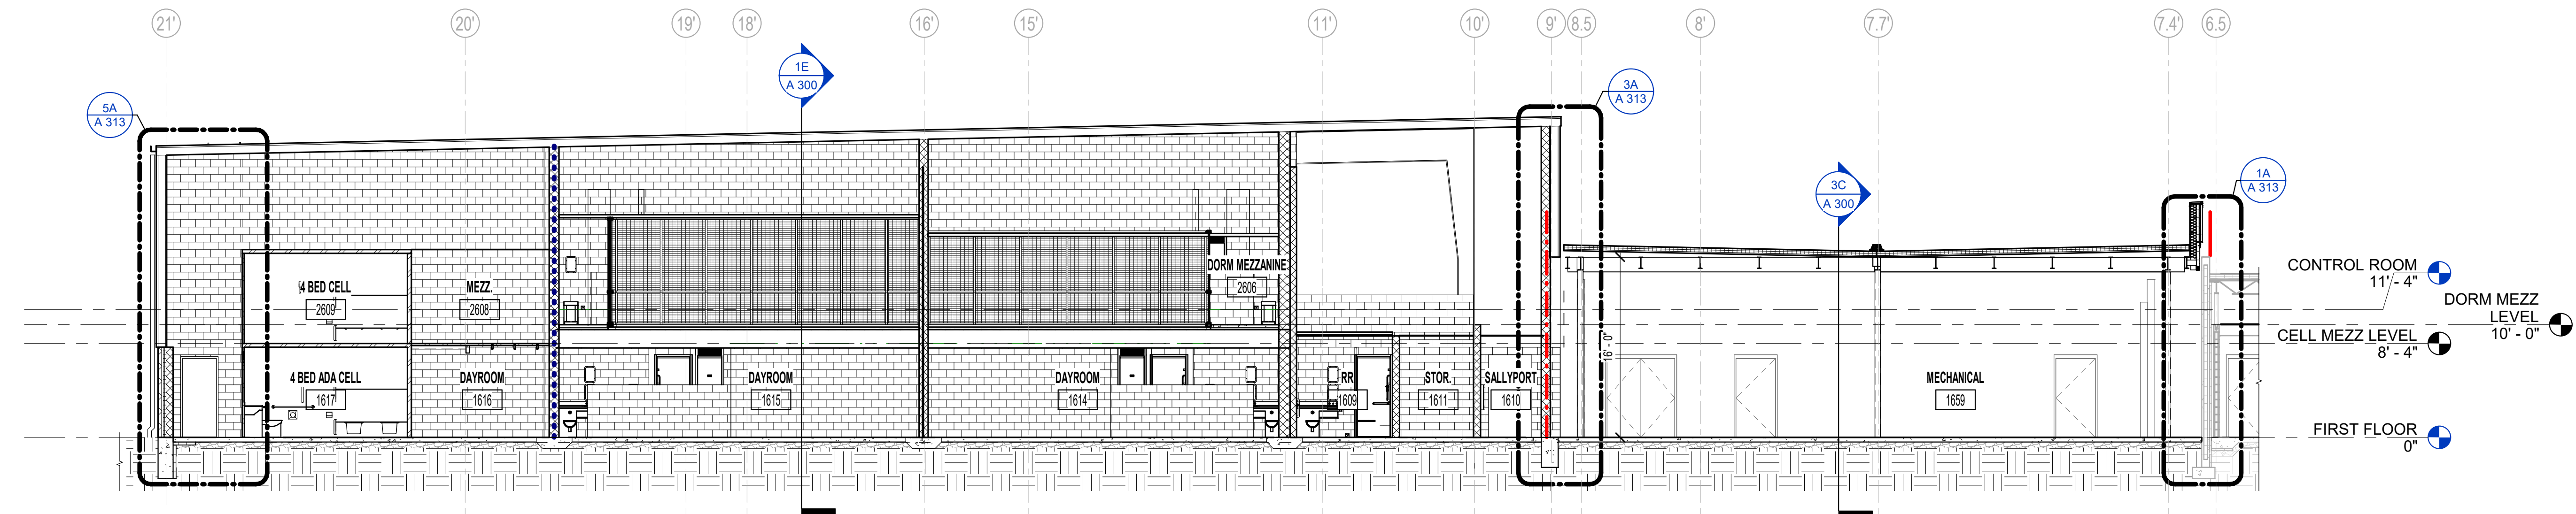
1E BUILDING SECTION 9.0  
1/8" = 1'-0"

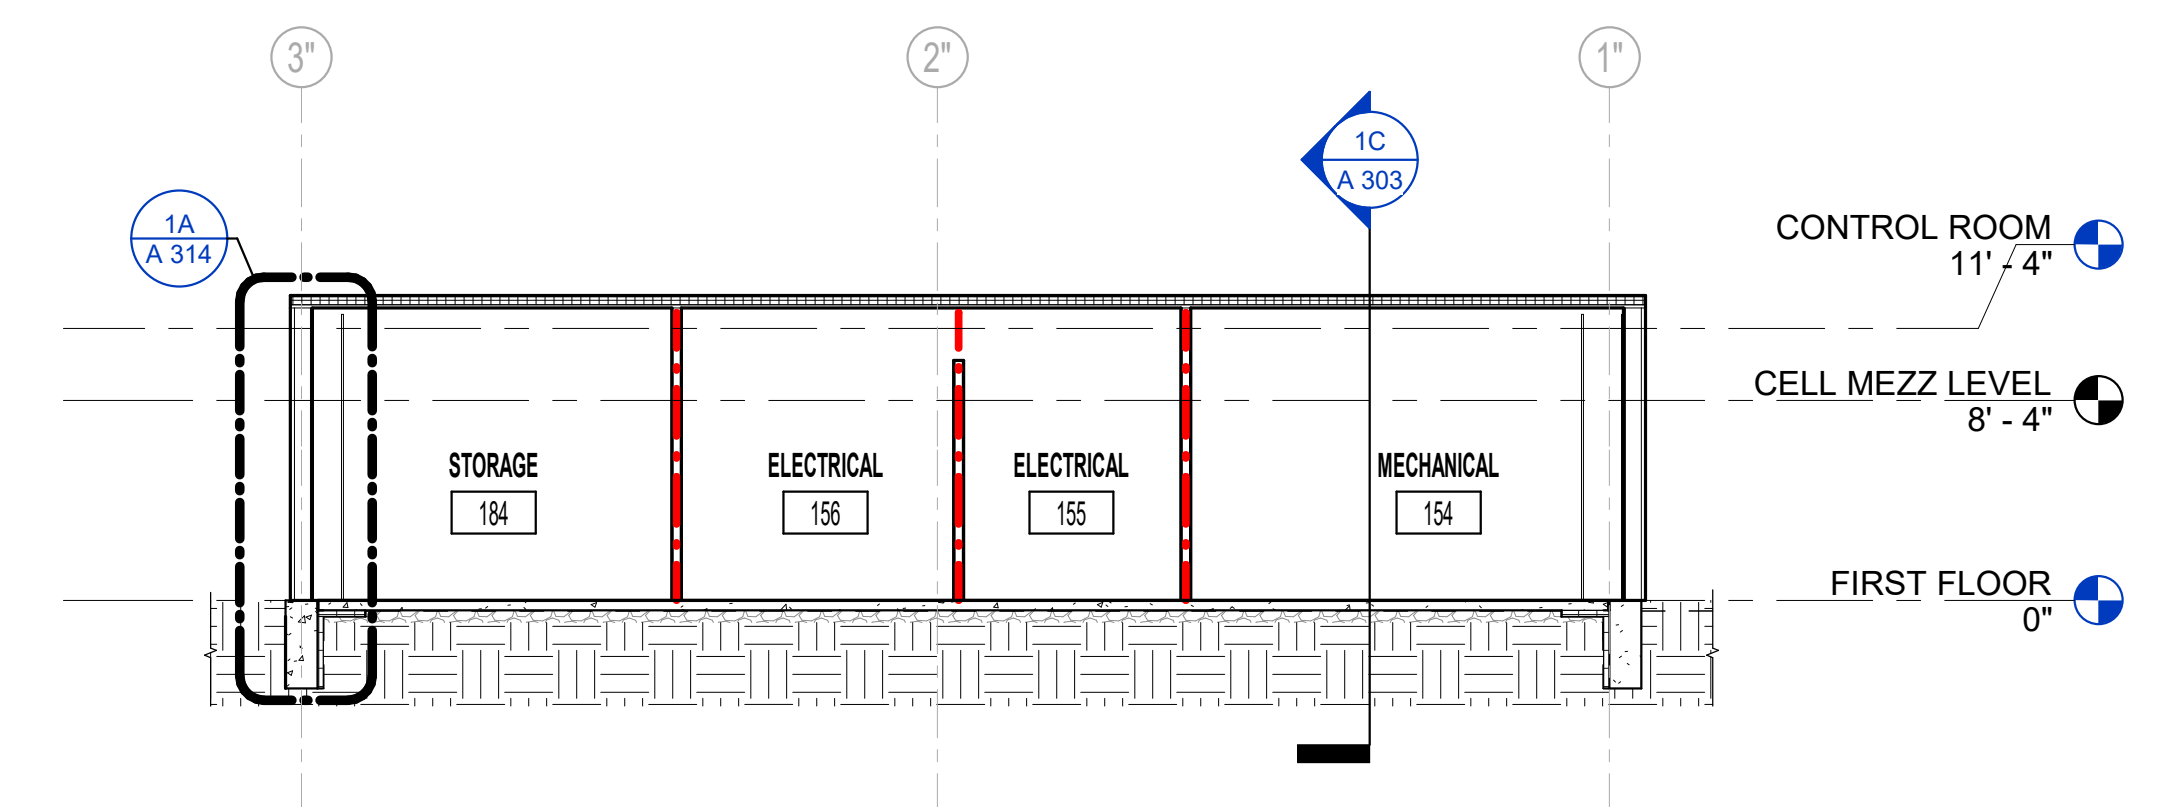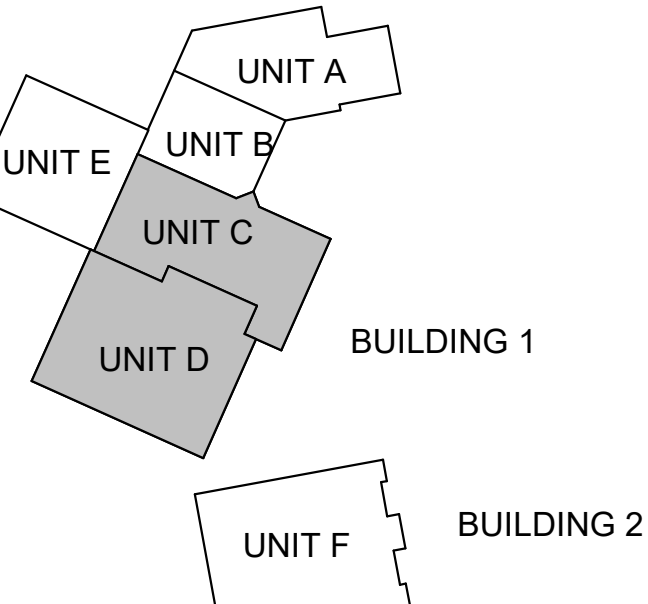

3E BUILDING SECTION 10.0  
1/8" = 1'-0"

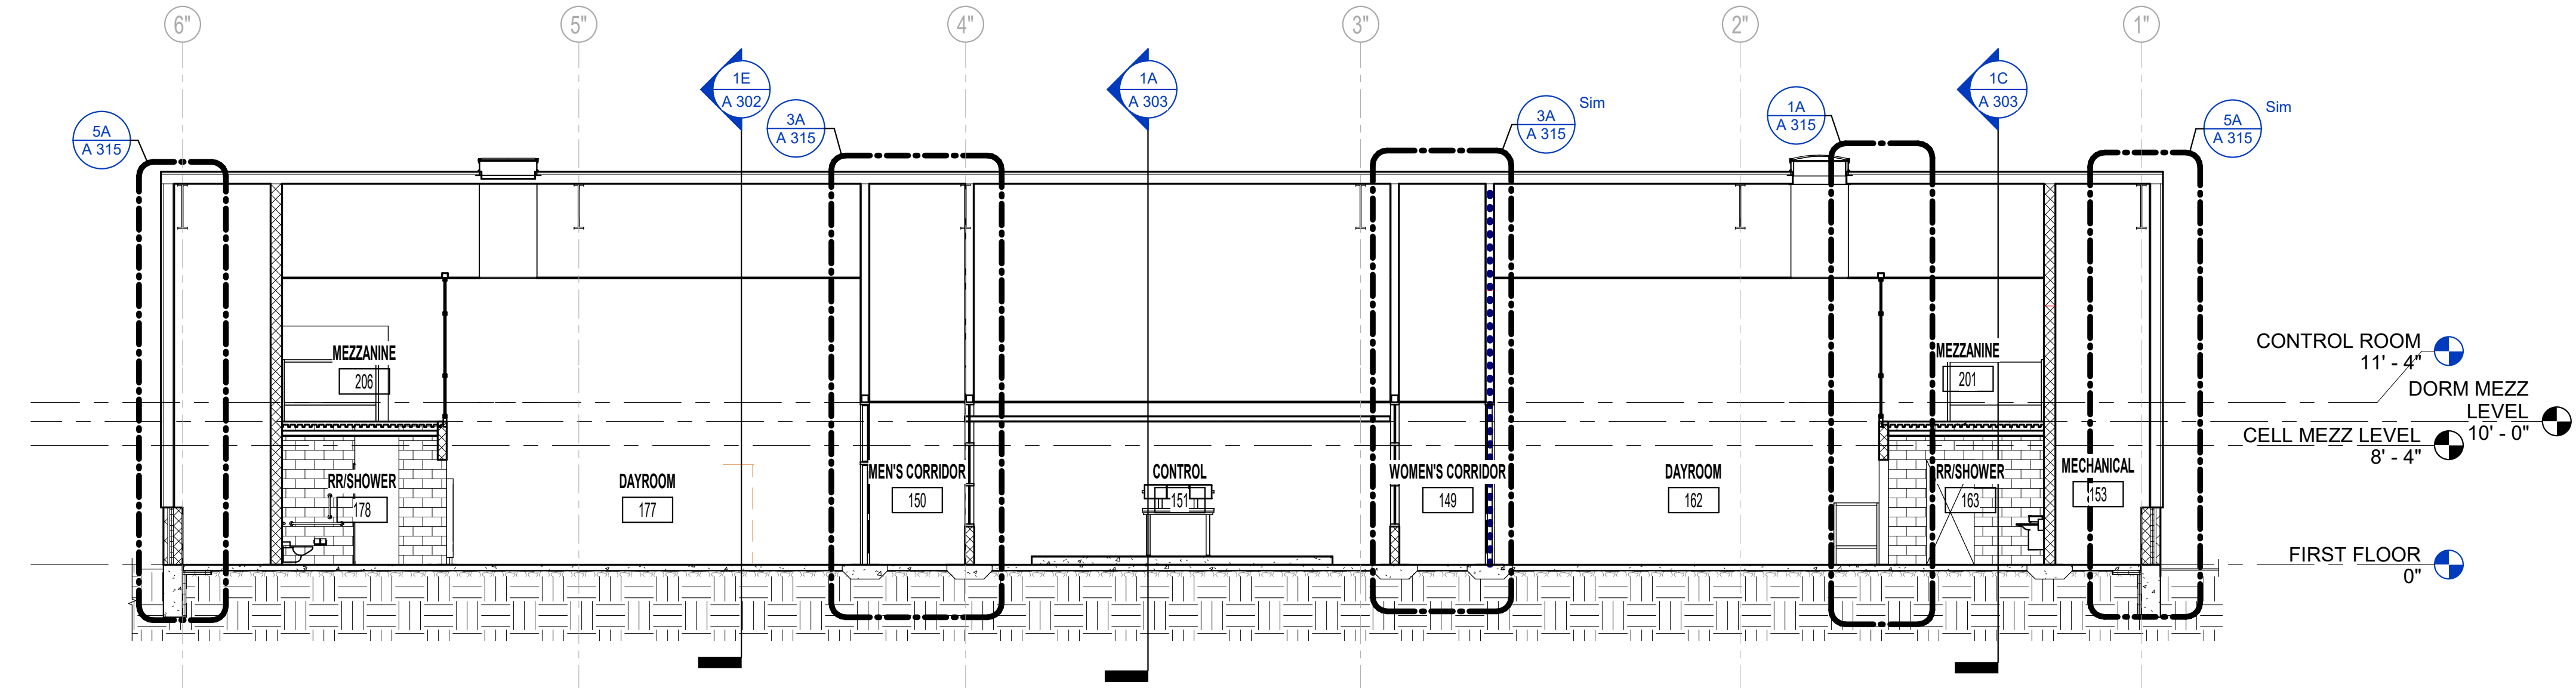

1D BUILDING SECTION 8.0  
1/8" = 1'-0"

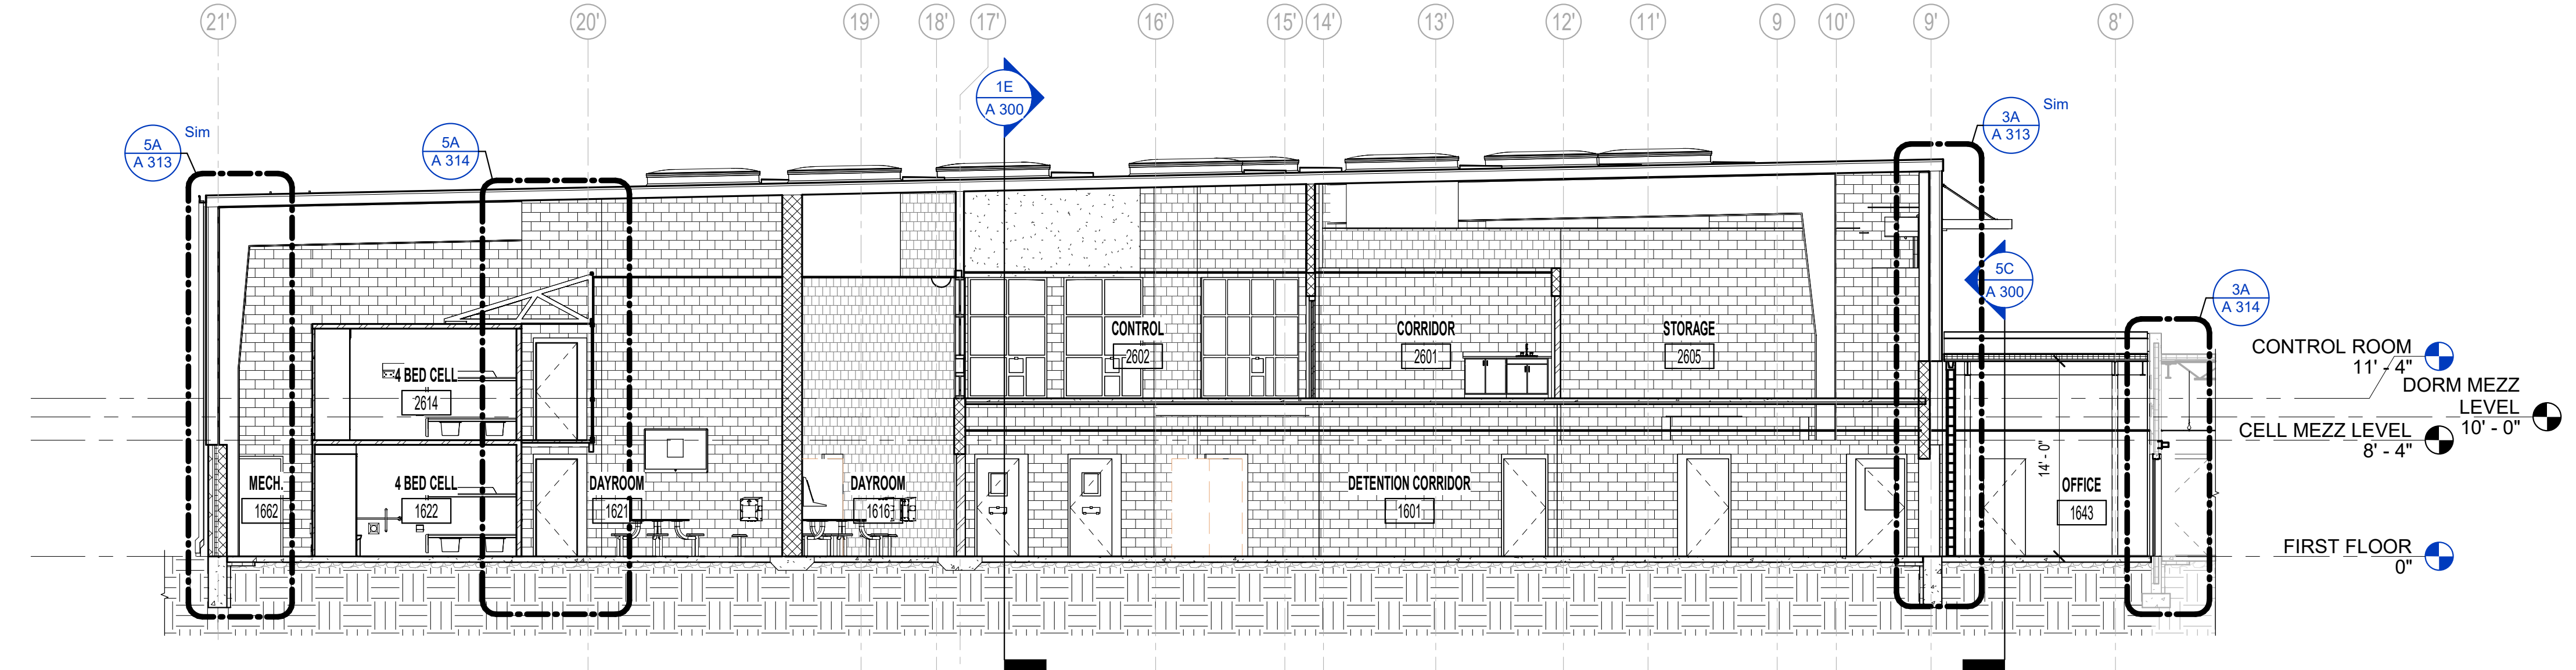


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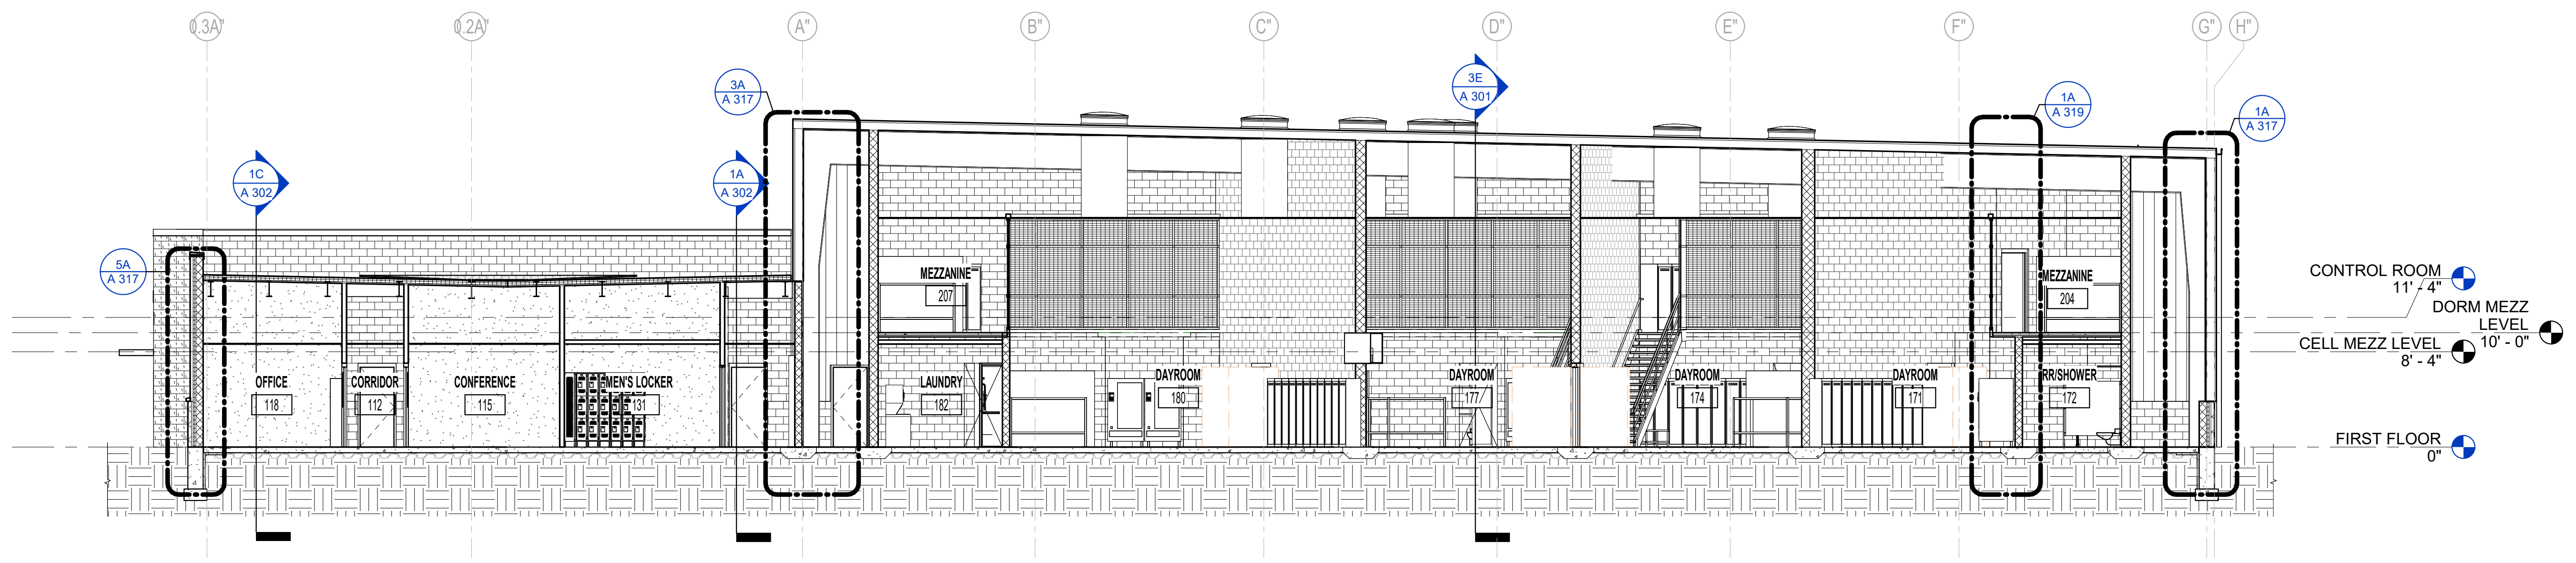
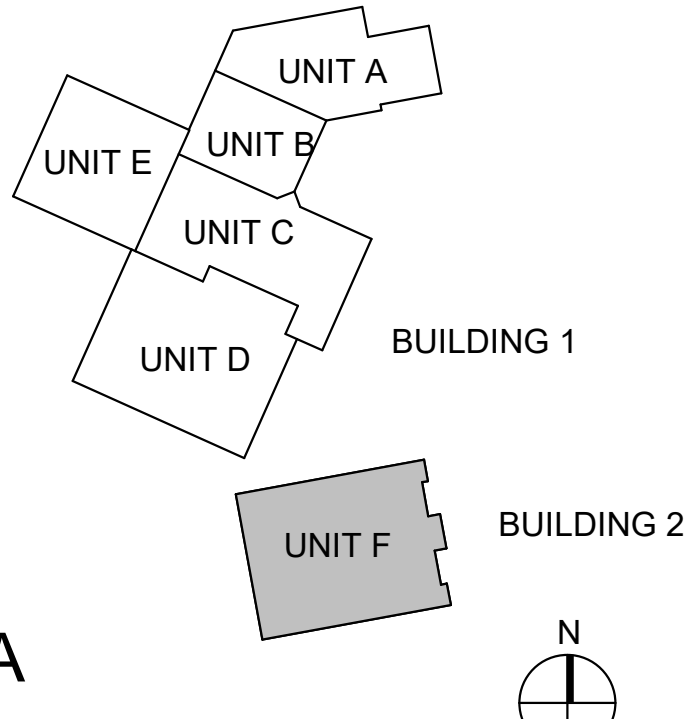
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Designed By: LD  
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Checked By: LD/EV  
Date: 02.04.2022




*Eric Welfen*


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1E BUILDING SECTION 13.0  
1/8" = 1'-0"

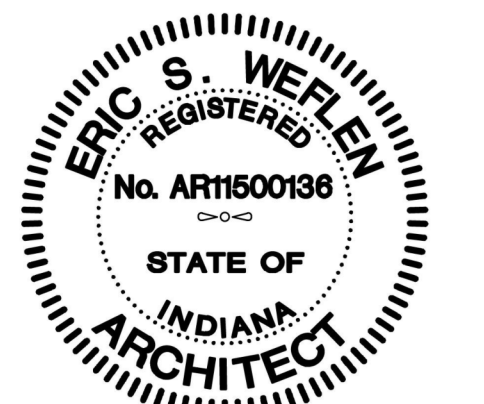

1C BUILDING SECTION 12.0  
1/8" = 1'-0"

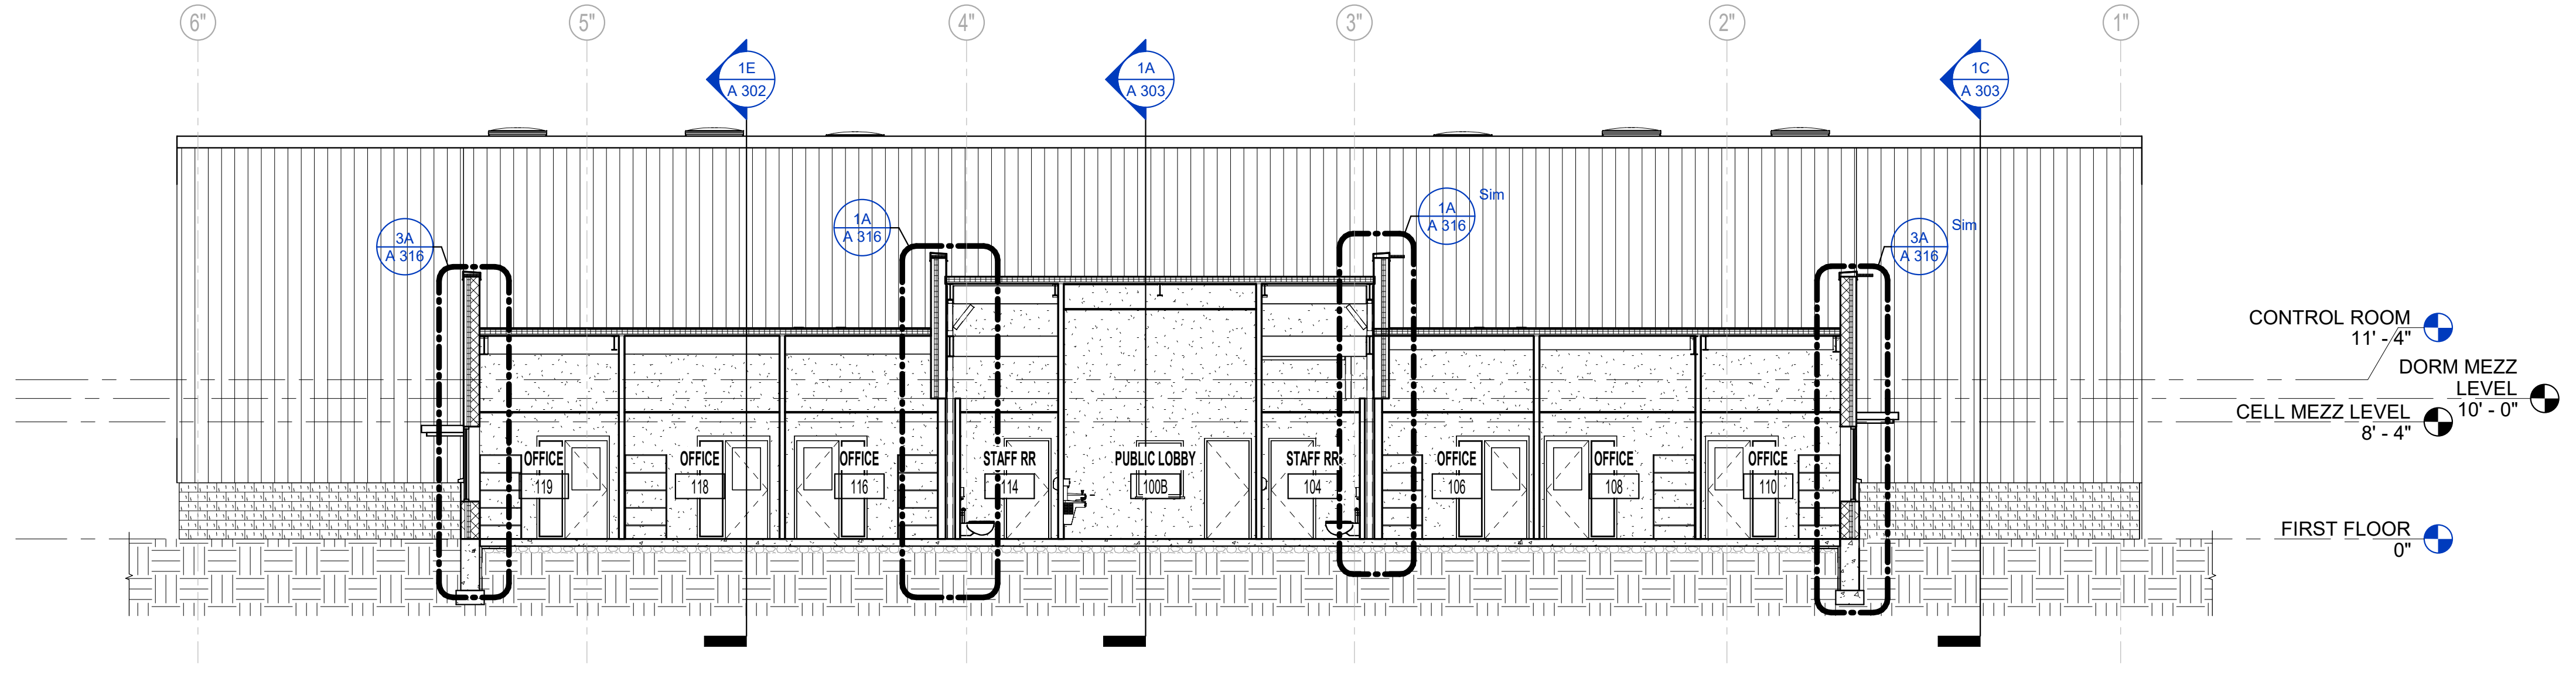

1A BUILDING SECTION 11.0  
1/8" = 1'-0"

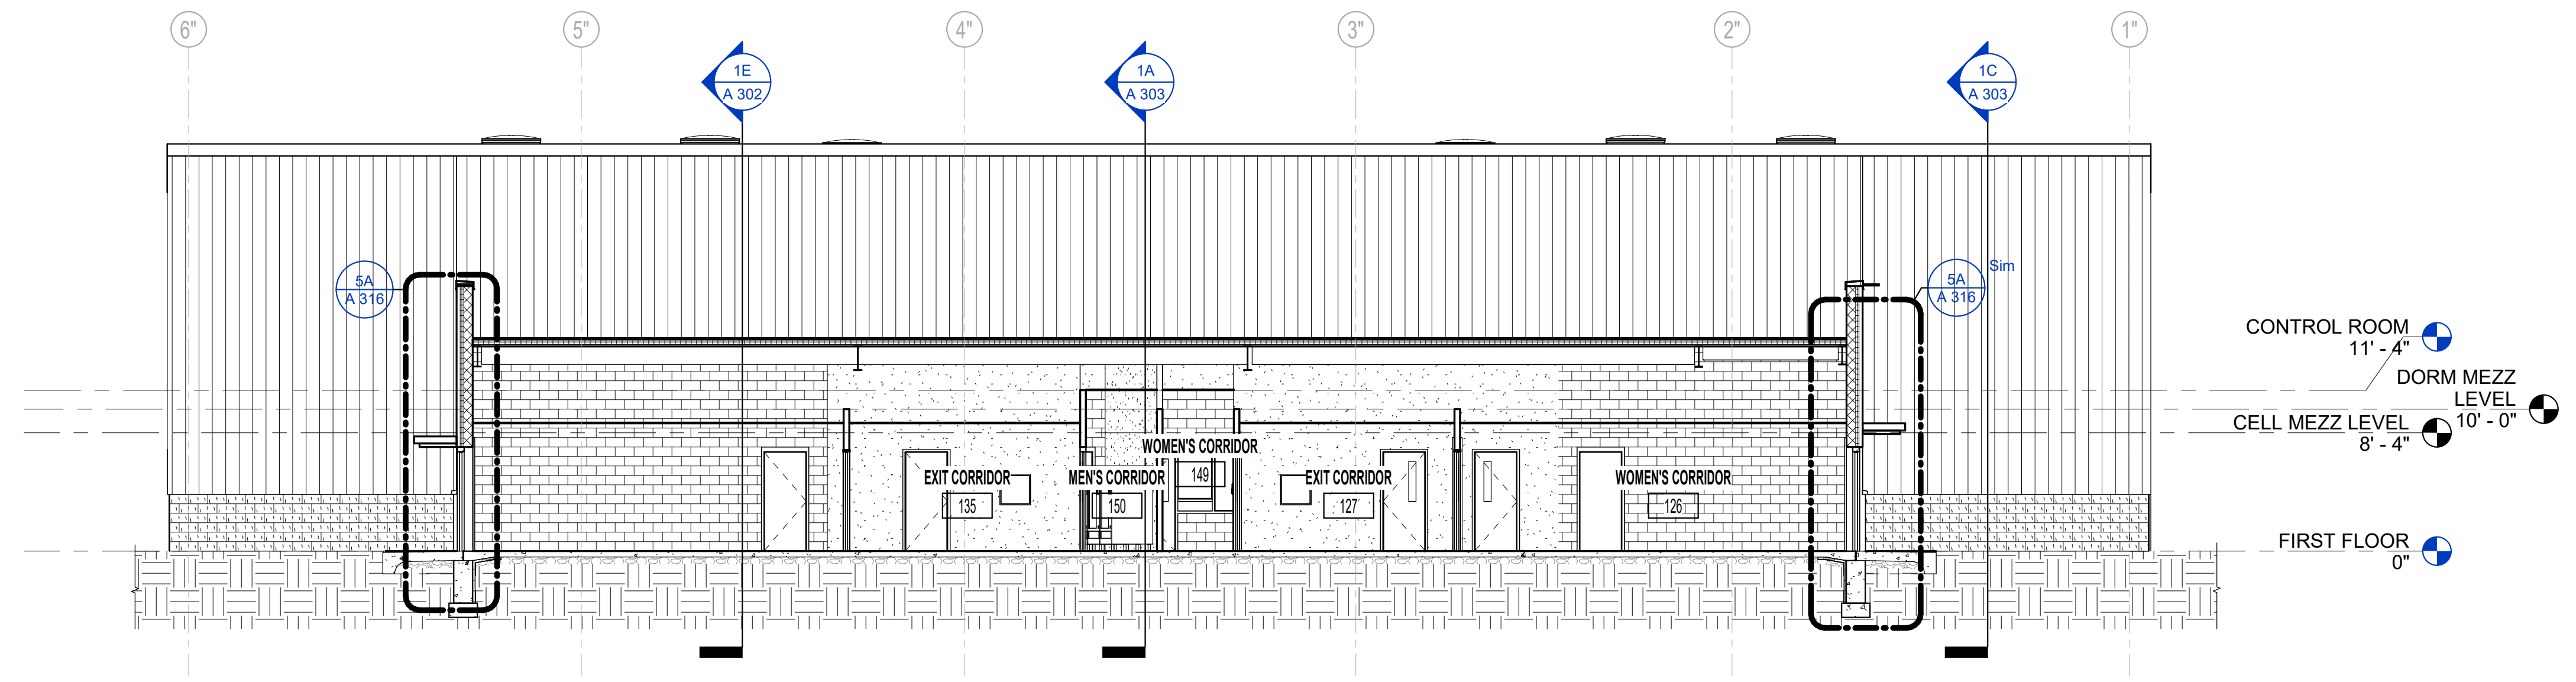


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Designed By: LD  
Drawn By: WD  
Checked By: LD/EV  
Date: 02.04.2022





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BUILDING SECTIONS

A 303

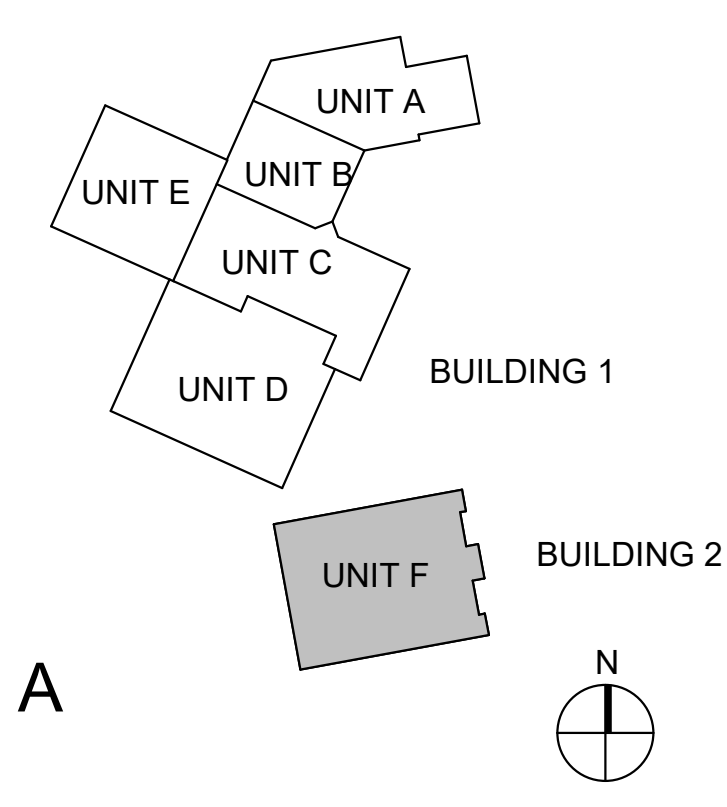

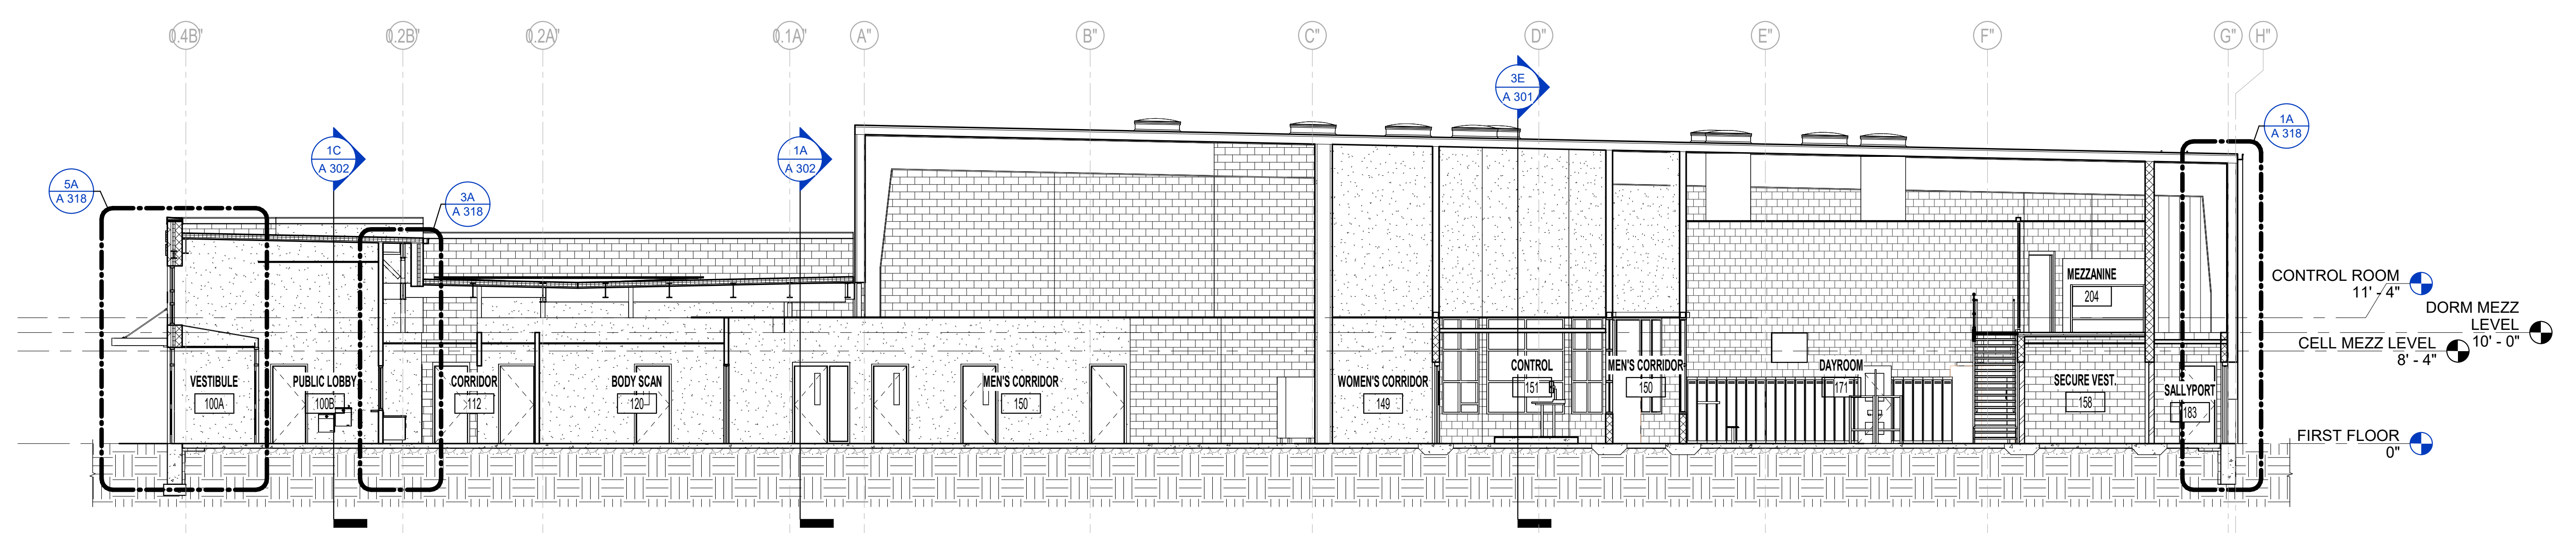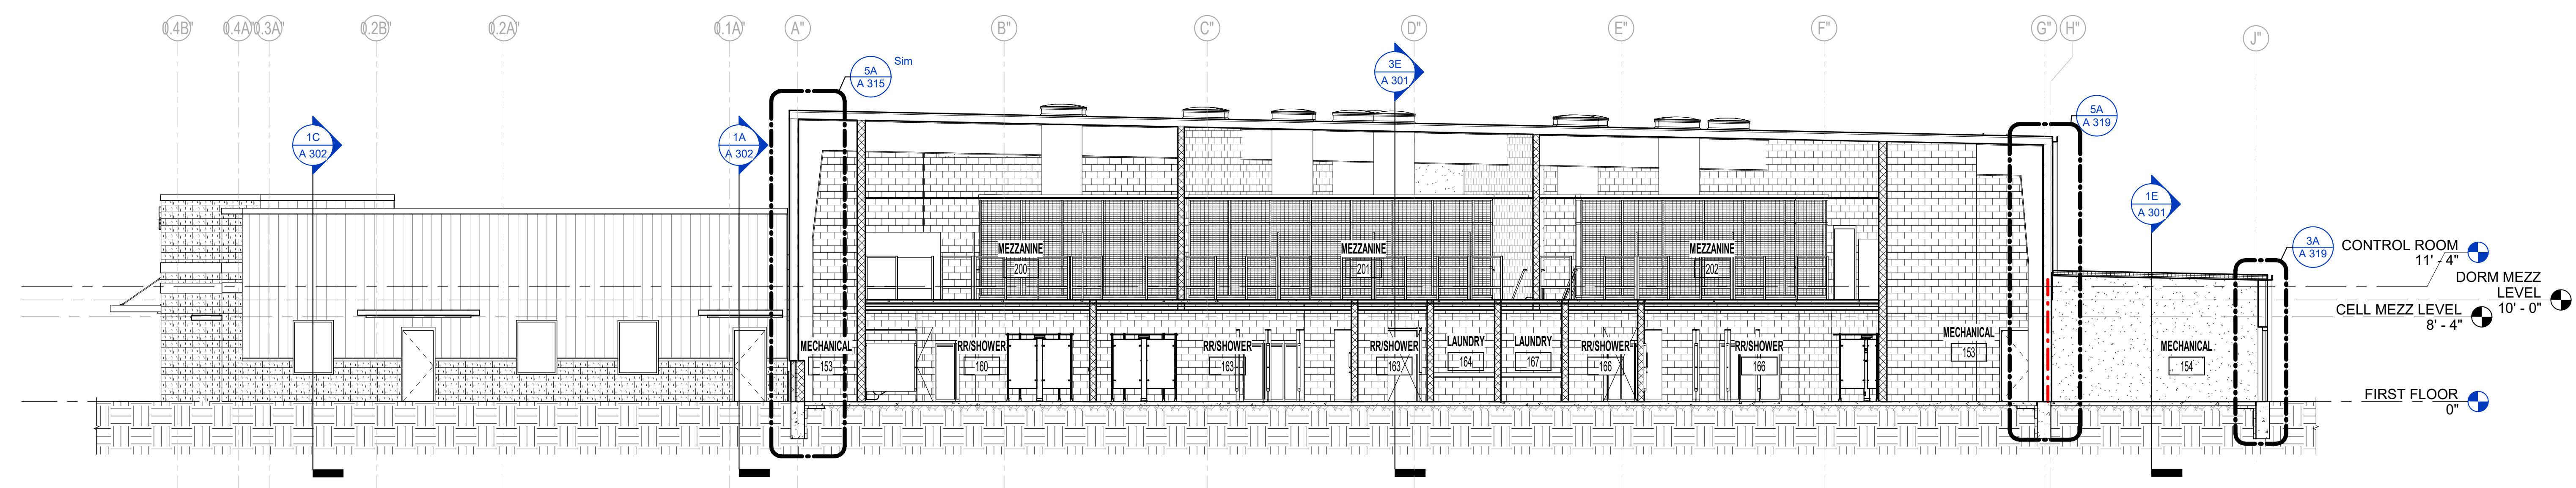

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2375 OLD DECKER RD. VINCENNES, IN 47591

BID SET


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Drawn By: CP  
Checked By: CP  
Date: 02.04.2022




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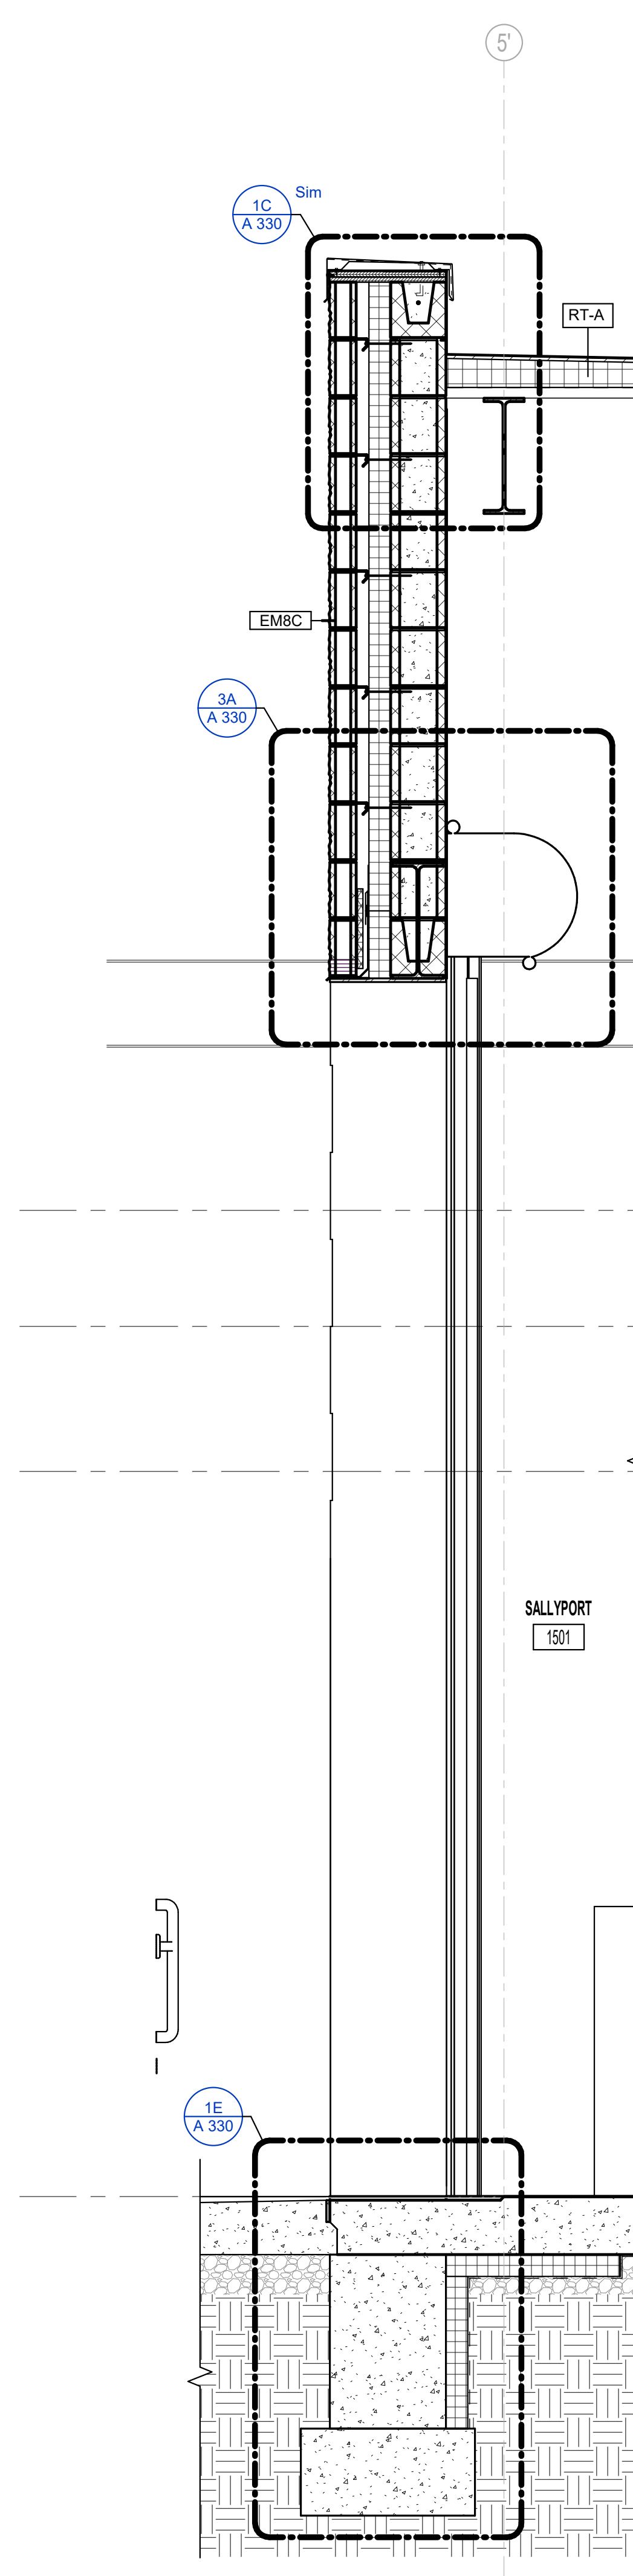


WALL SECTIONS & DETAILS


A 310

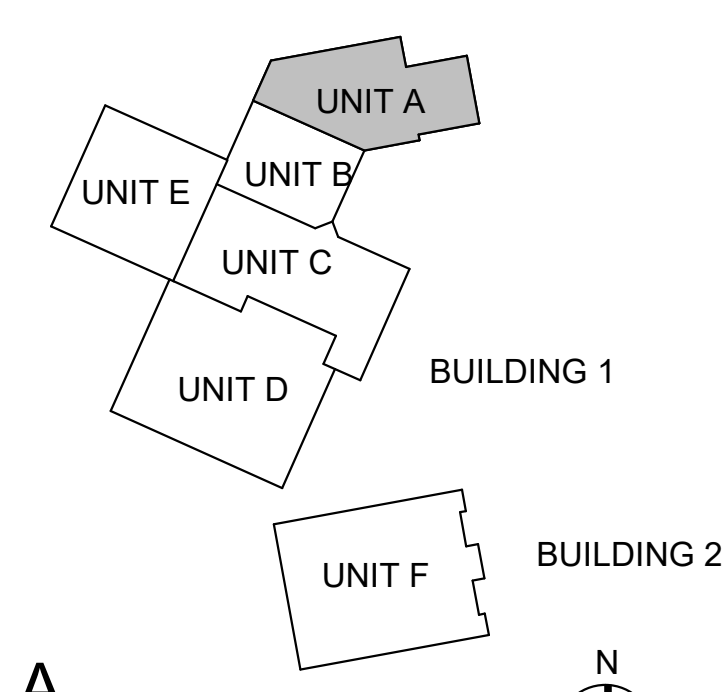

5A WALL SECTION 1.1  
3/4" = 1'-0"

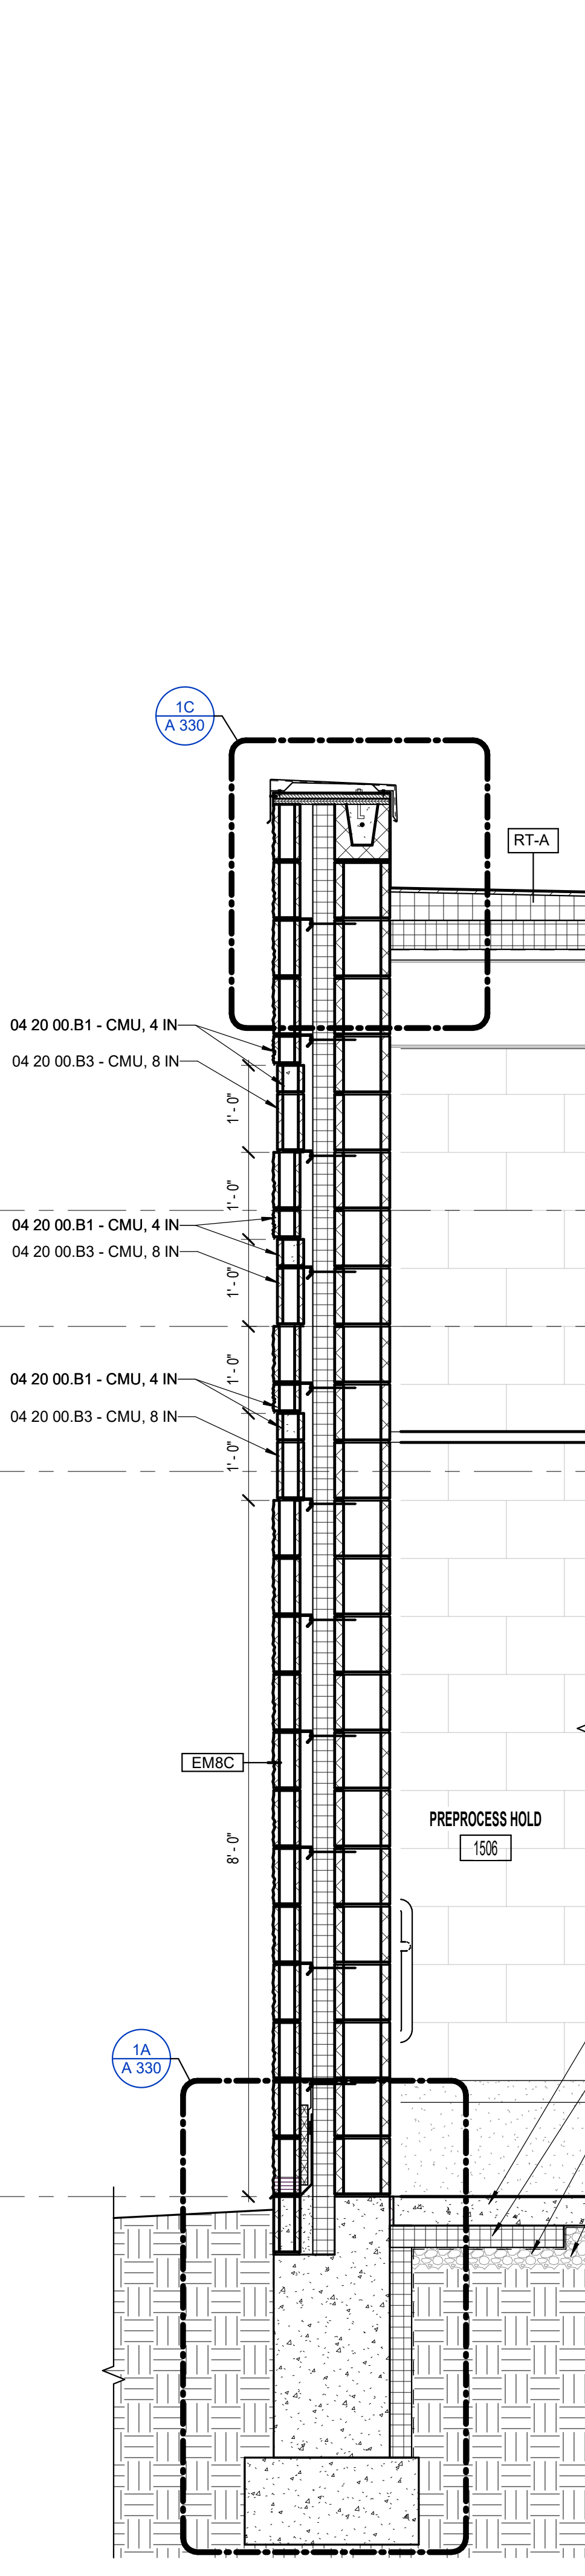

3A WALL SECTION 2.1  
3/4" = 1'-0"

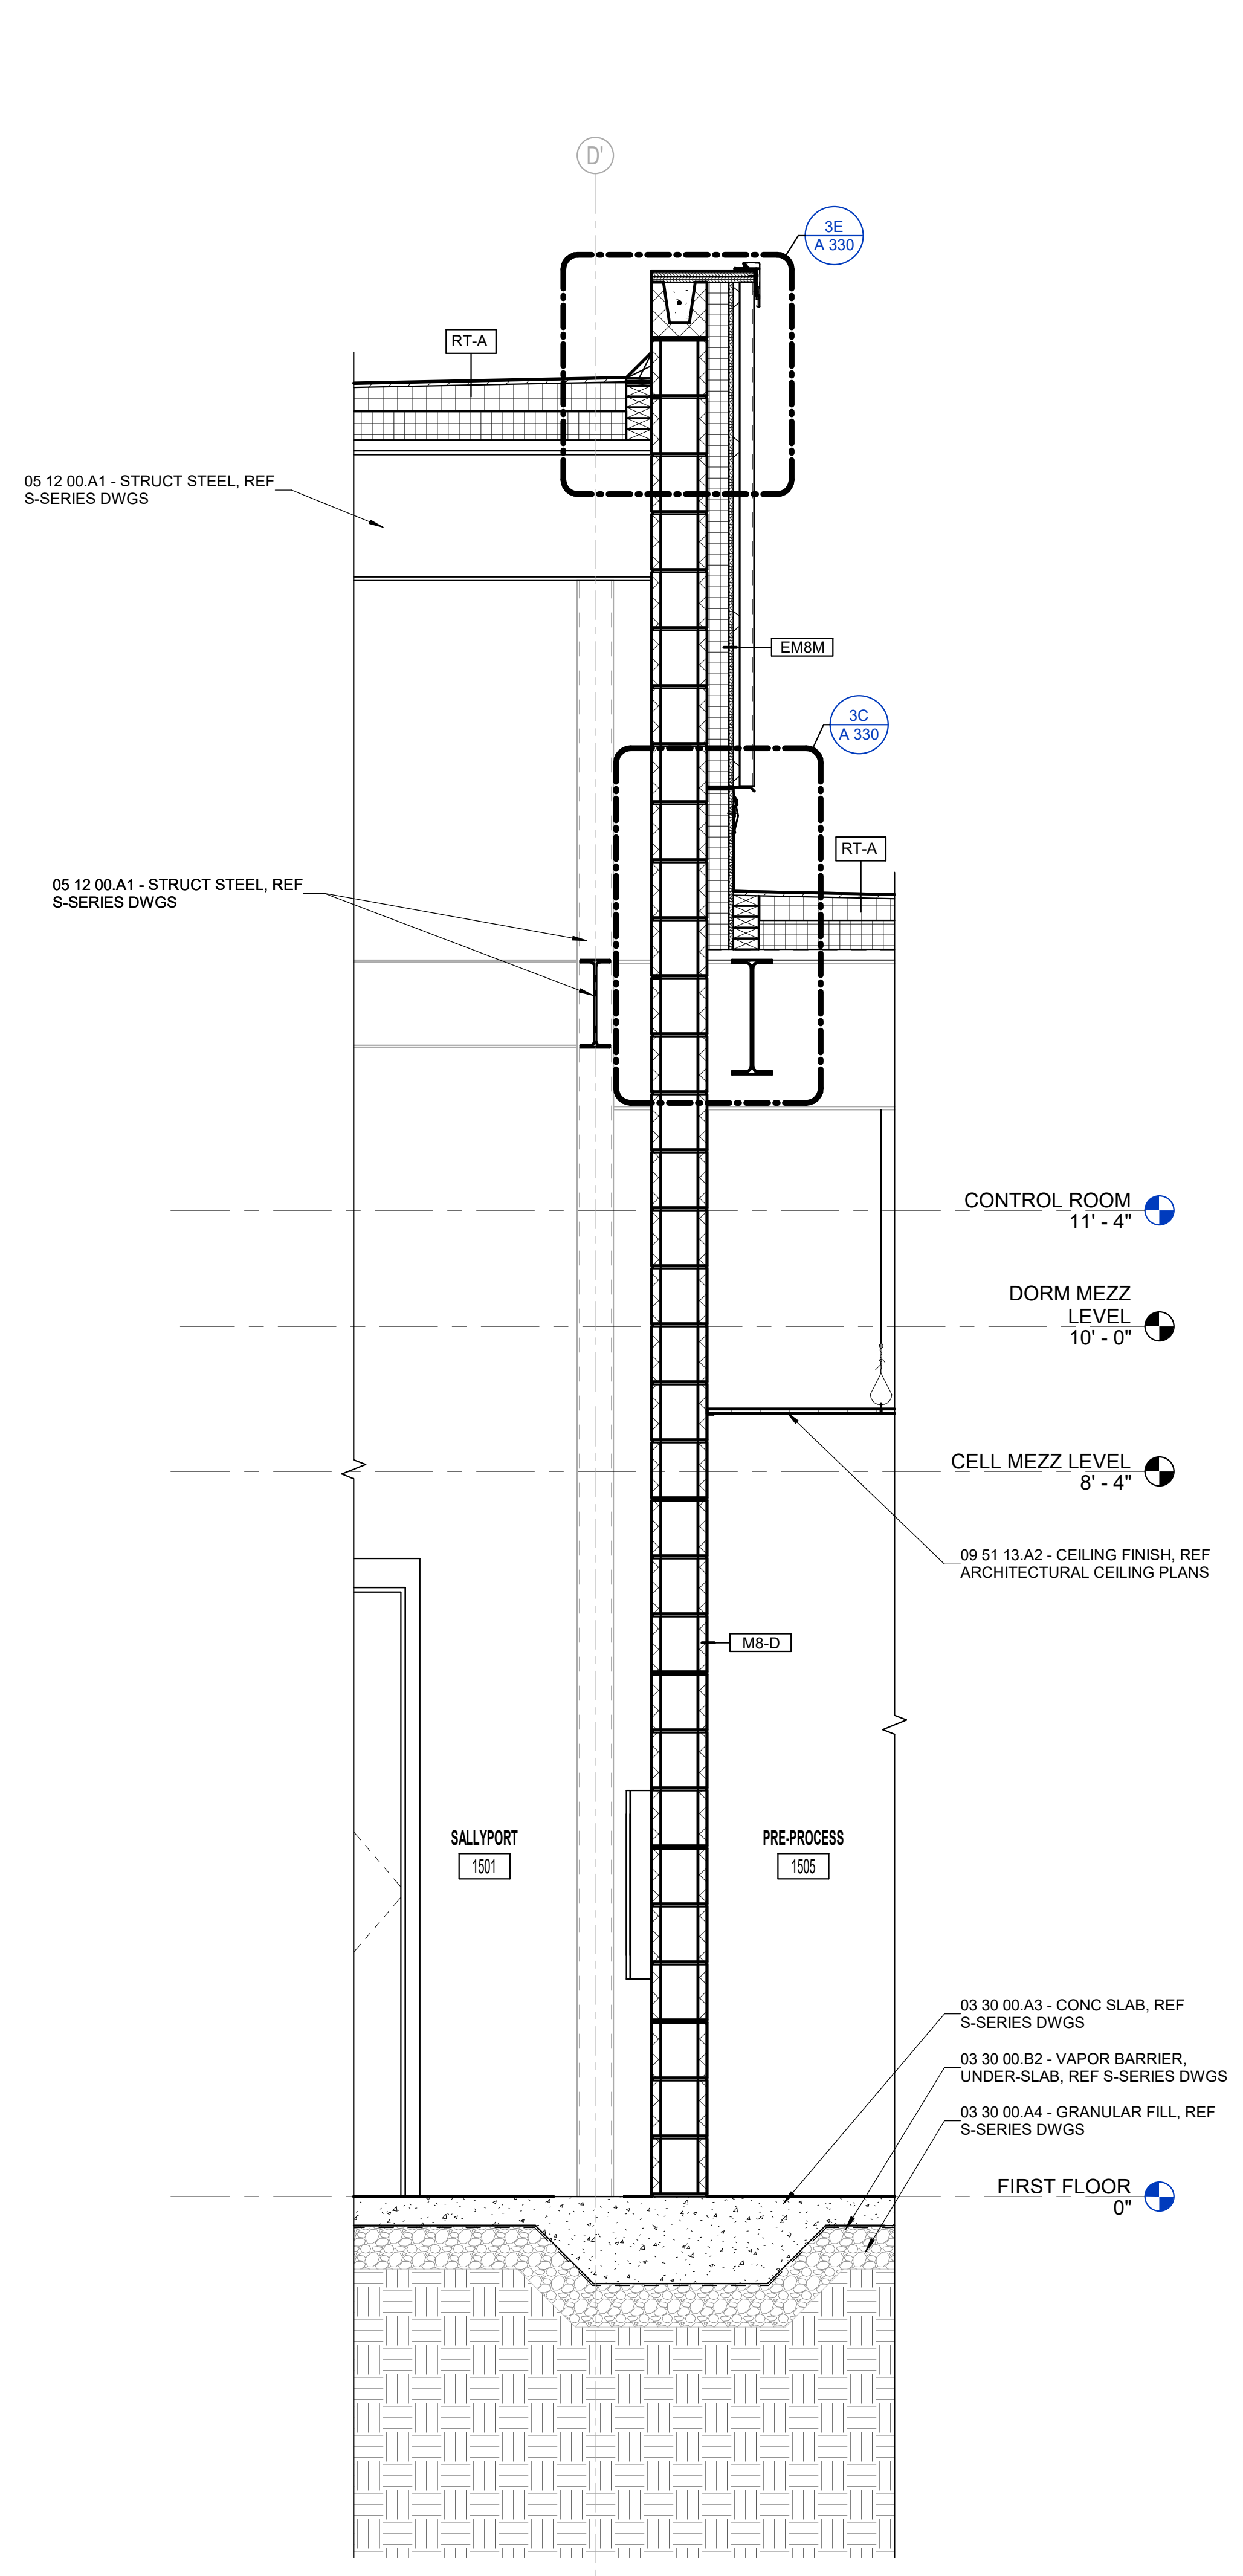

1A WALL SECTION 3.1  
3/4" = 1'-0"



KNOX COUNTY BOARD OF COMMISSIONERS  
KNOX COUNTY JUSTICE CAMPUS

2375 OLD DECKER RD. VINCENNES, IN 47591


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#	Revision	Date

Project #: 20-700-151-2  
Designed By: LD/SP  
Drawn By: CP  
Checked By: CP  
Date: 02.04.2022




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WALL SECTIONS & DETAILS

A 311

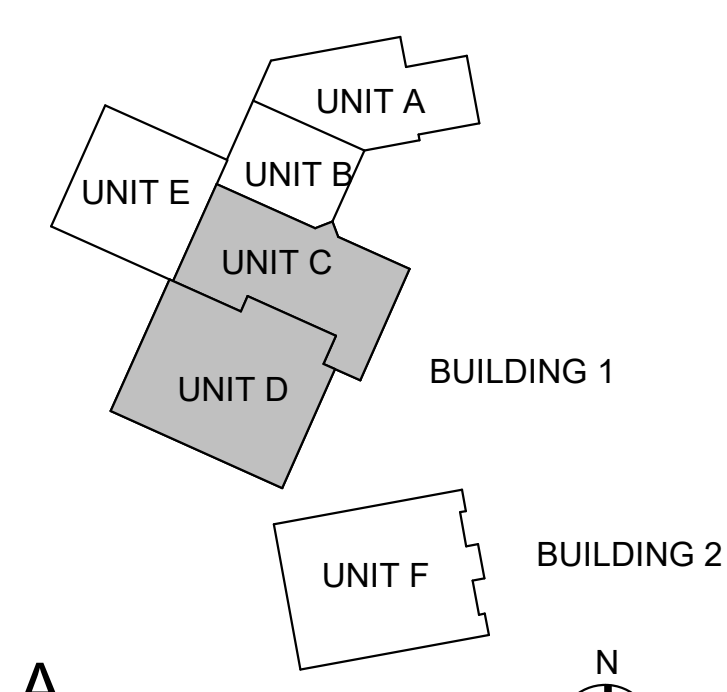

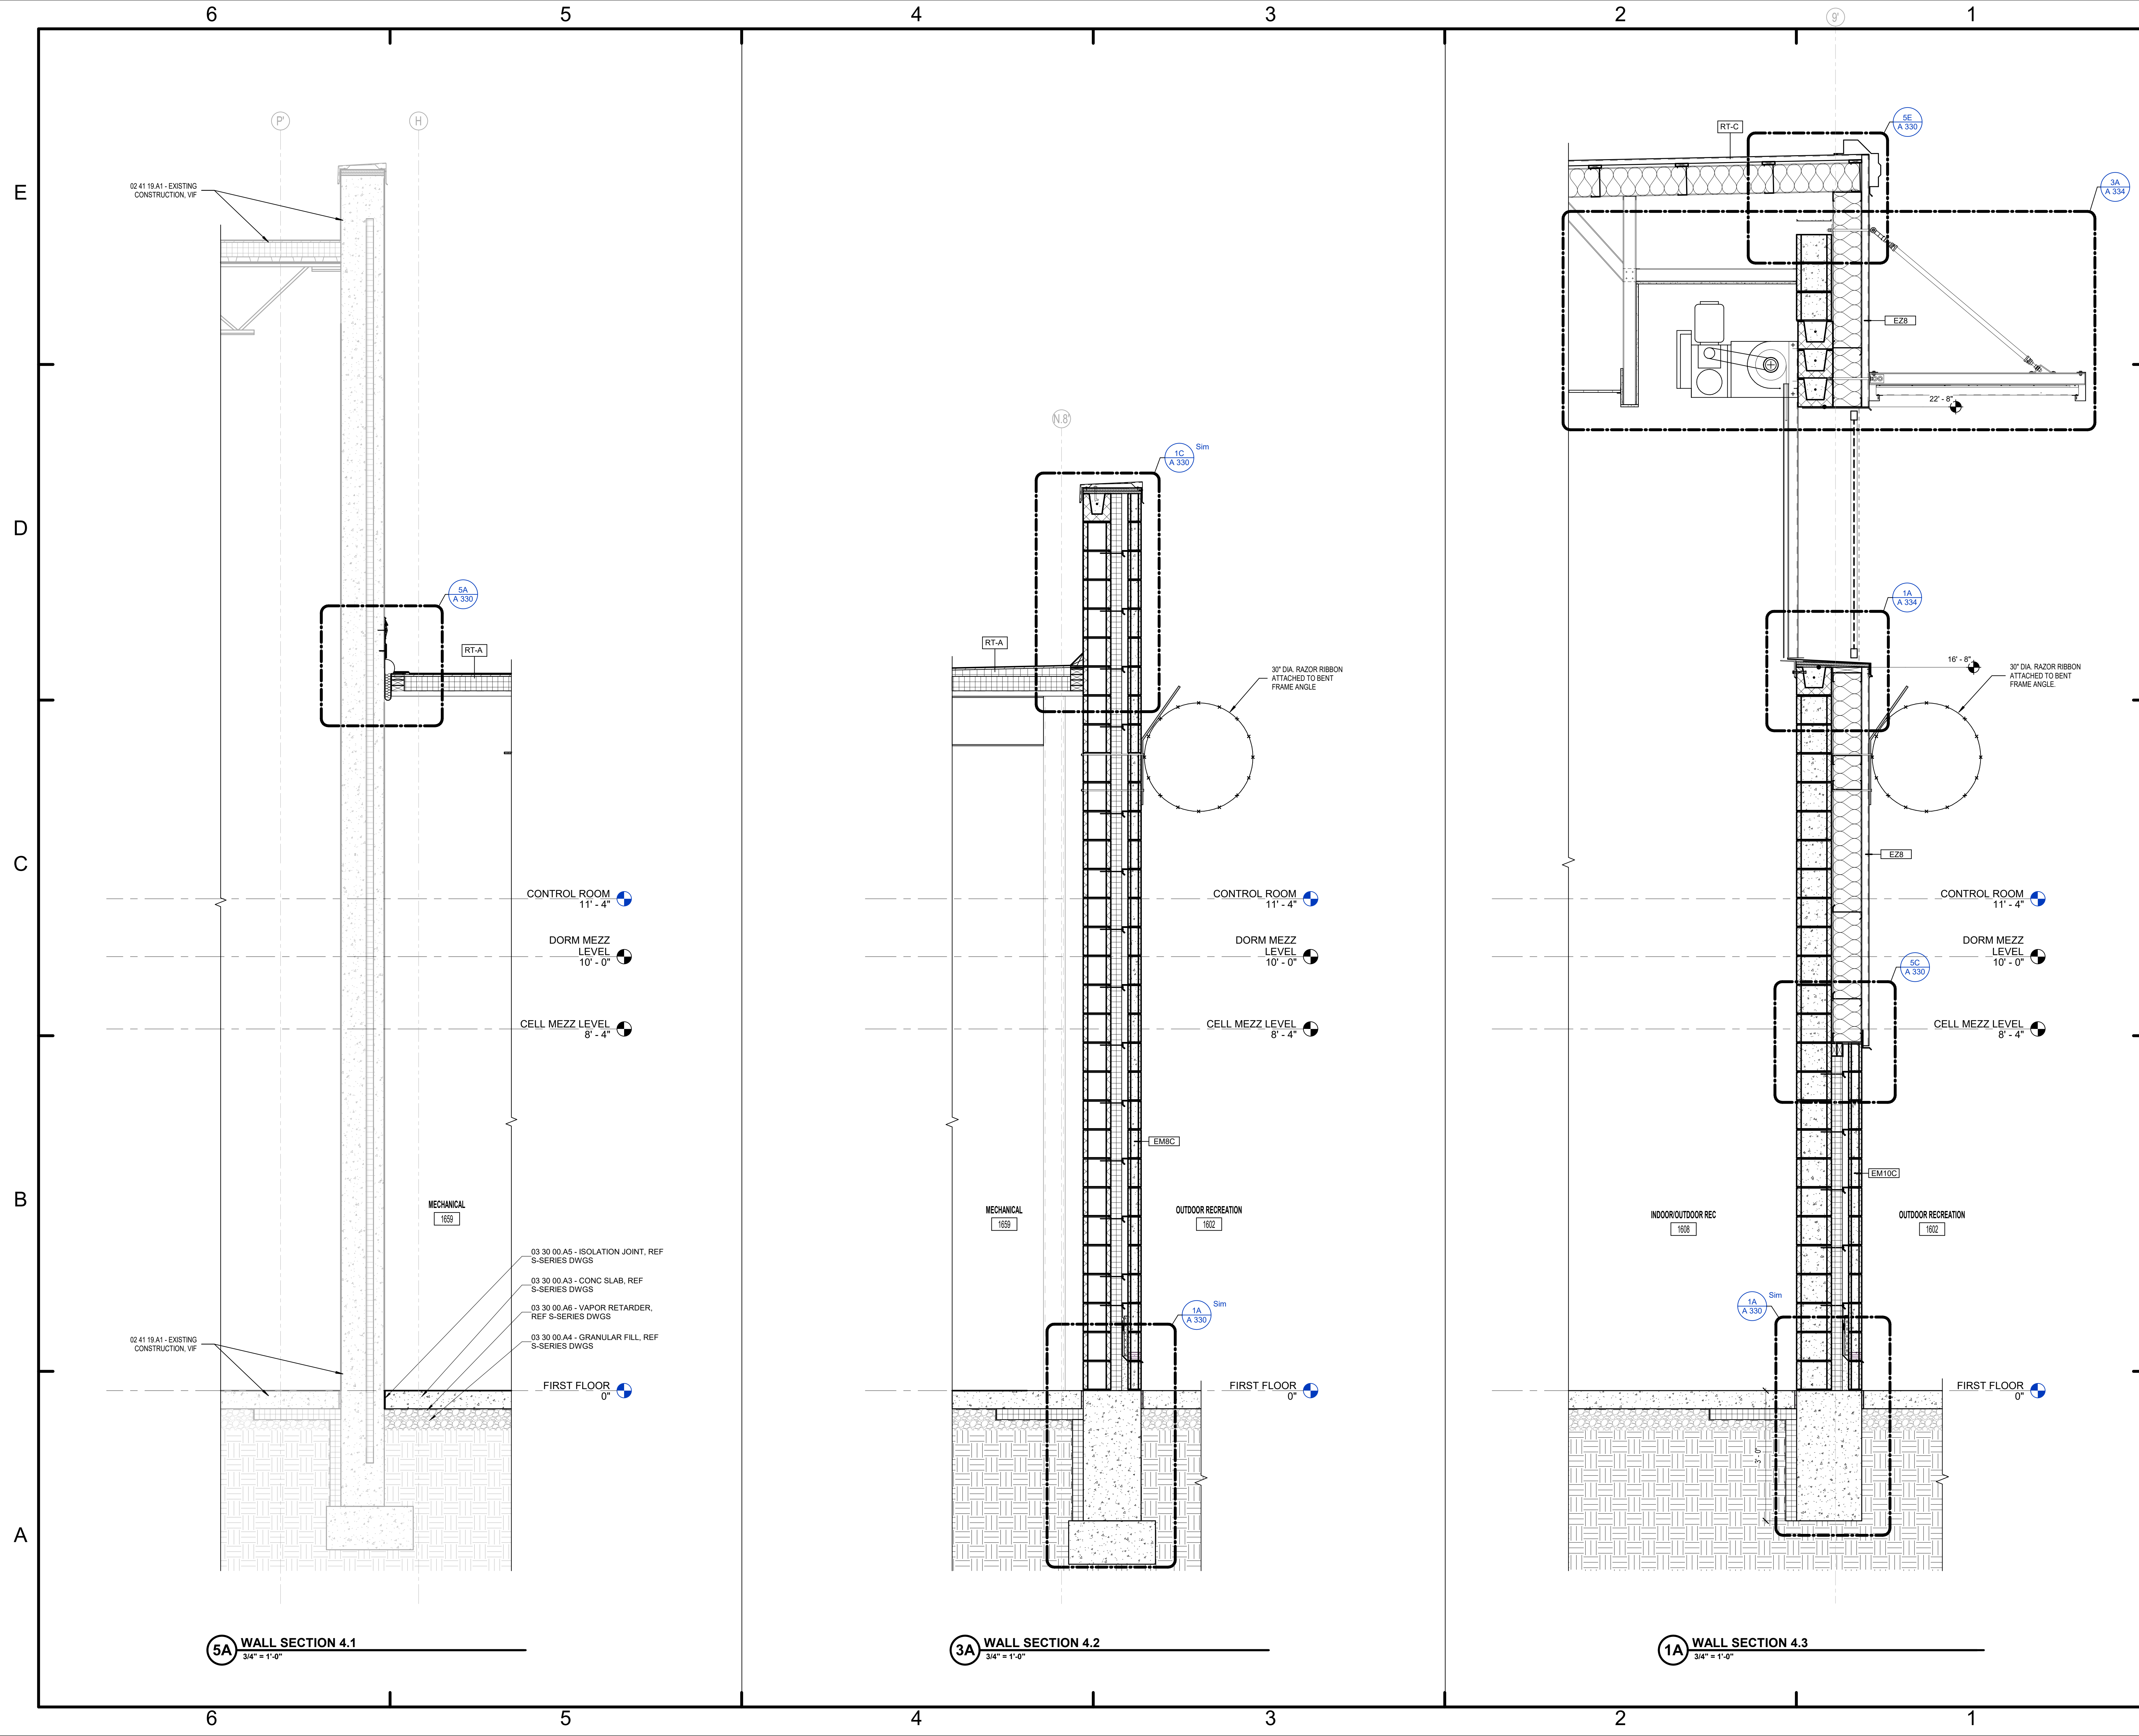



#	Revision	Date

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Designed By: LD/SP  
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Date: 02.04.2022




*Eric S. Wefer*


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1A WALL SECTION 6.1  
3/4" = 1'-0"

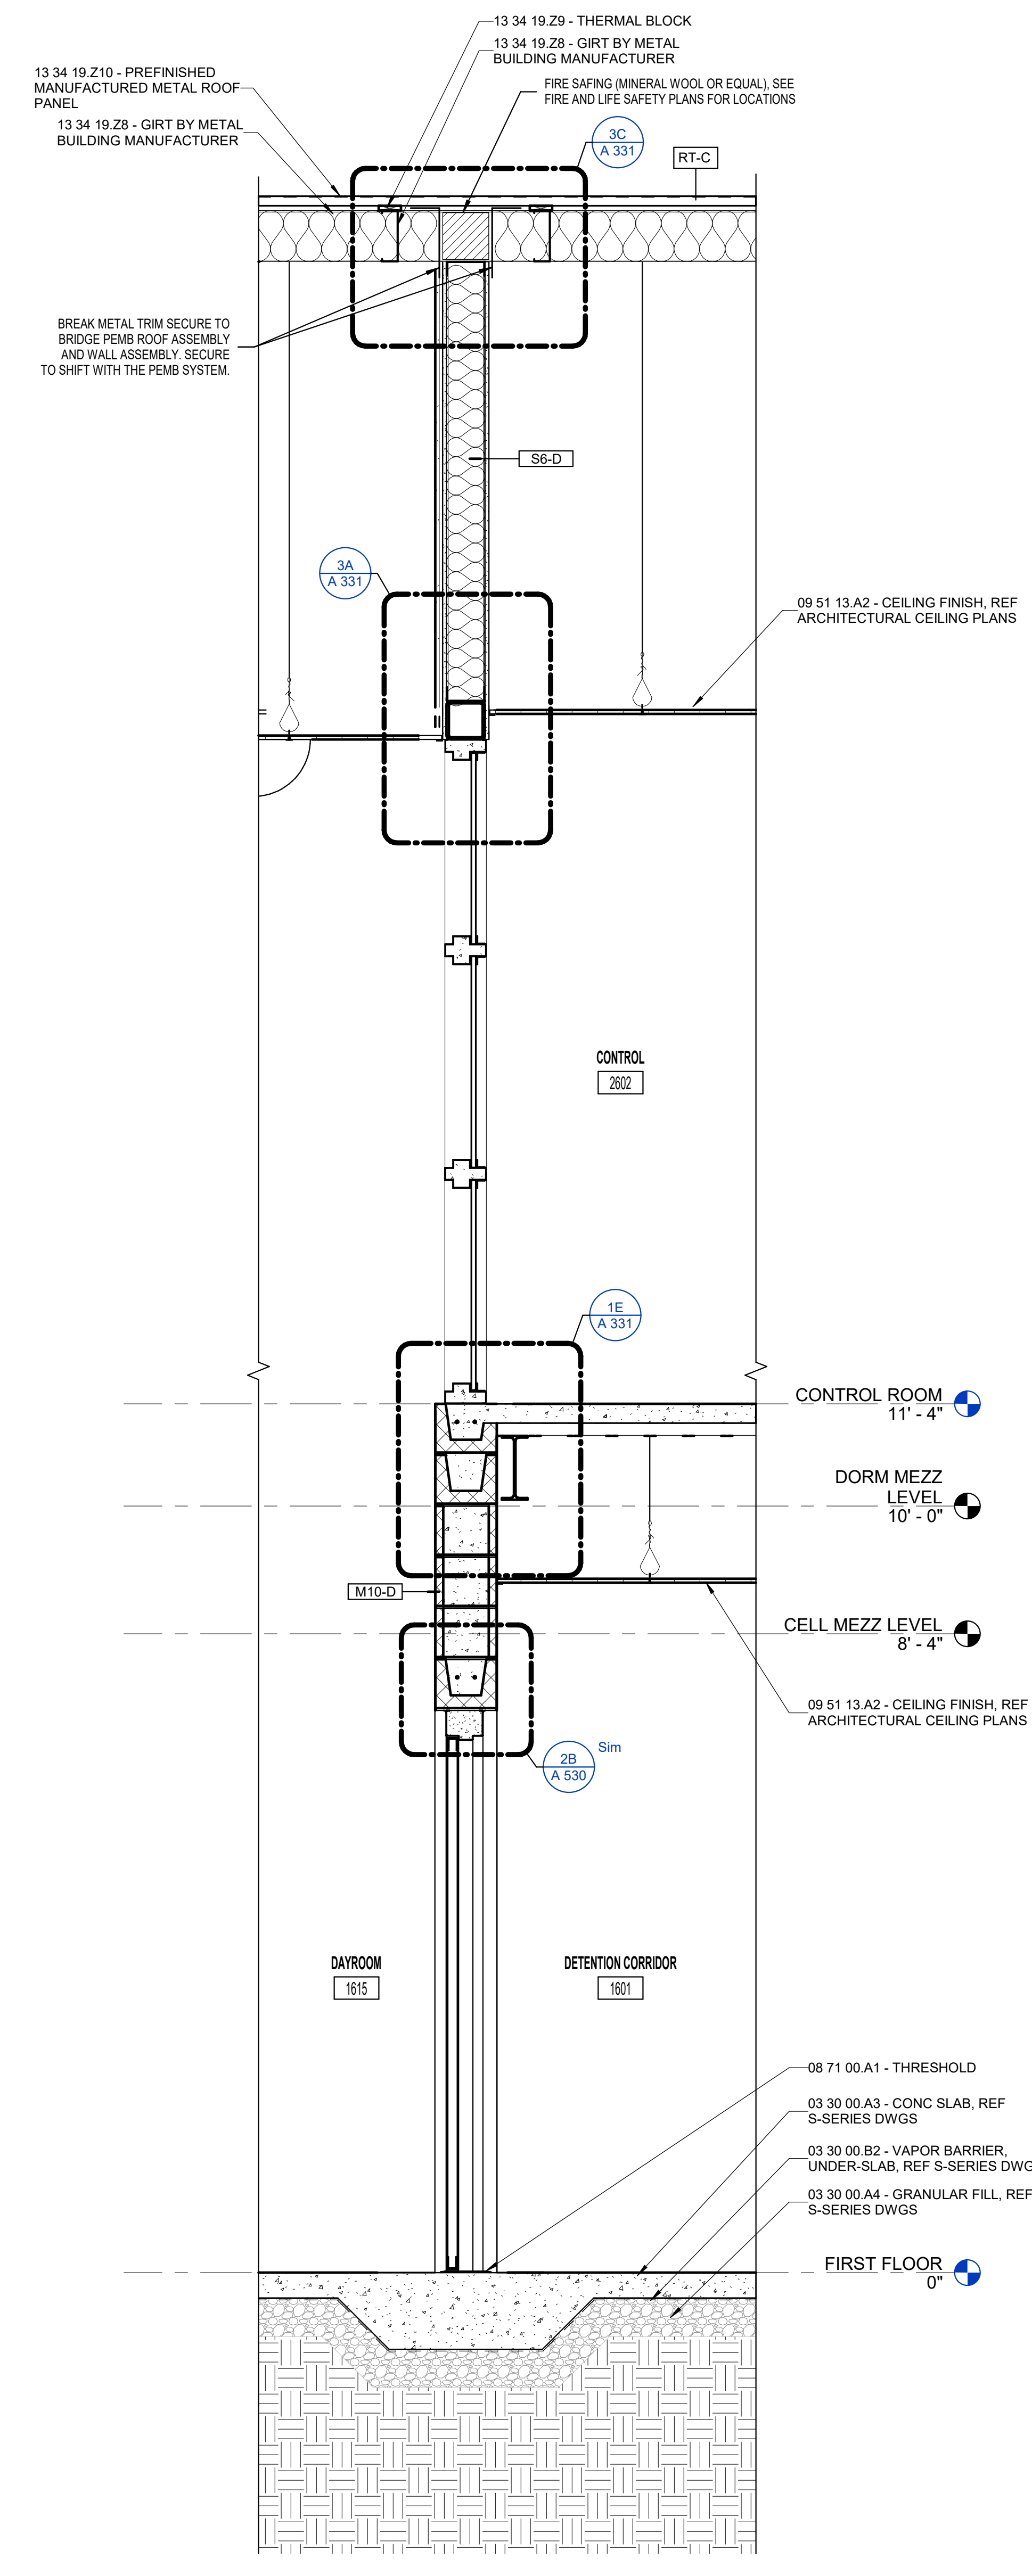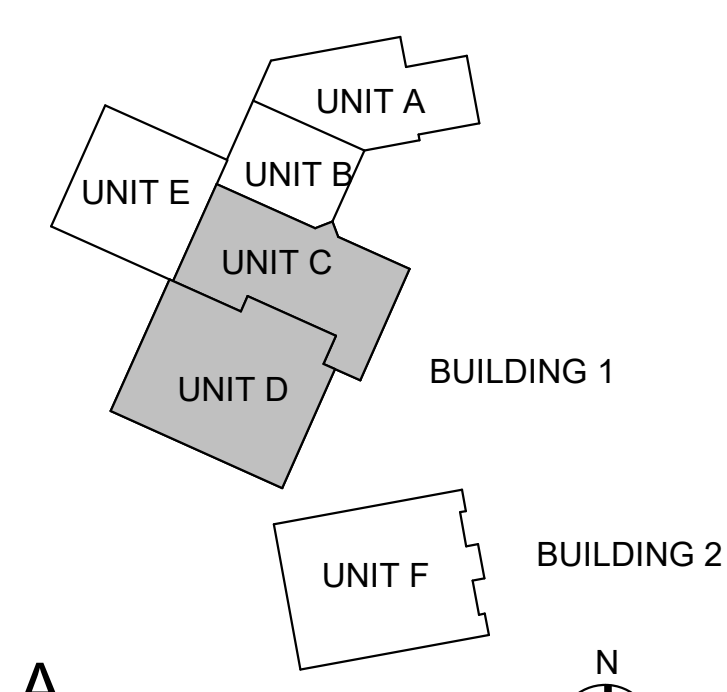

3A WALL SECTION 5.2  
3/4" = 1'-0"

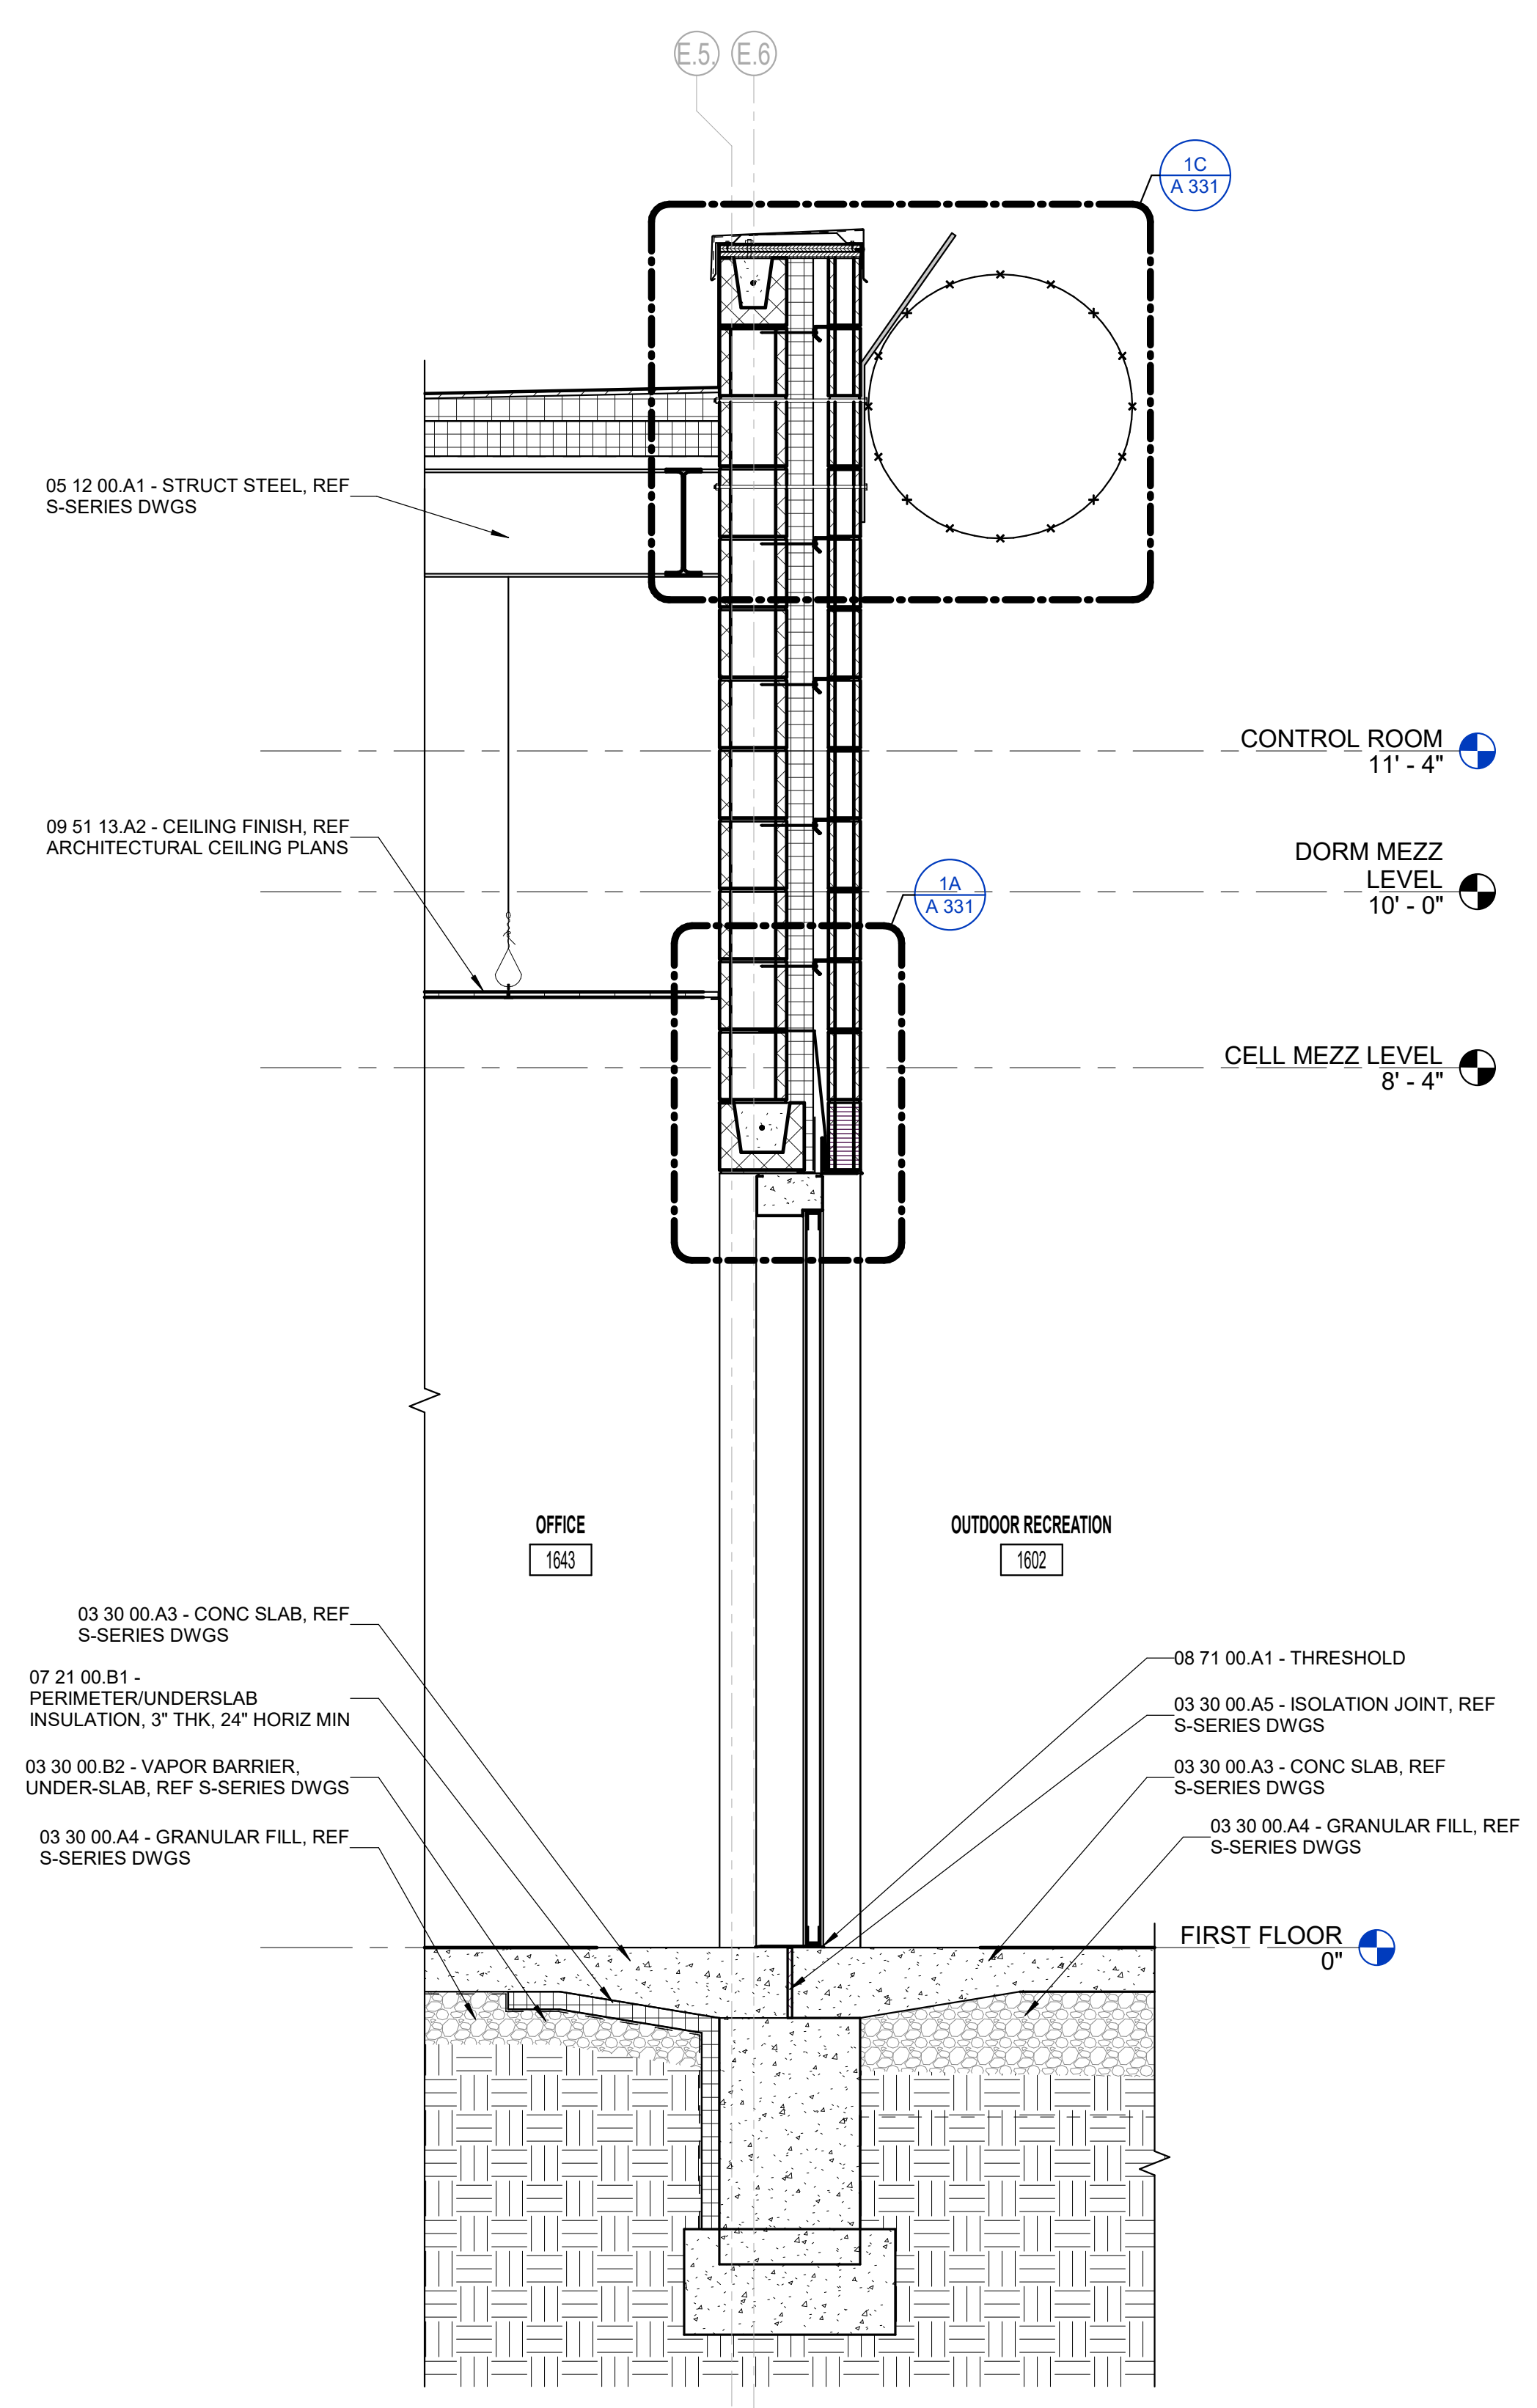

5A WALL SECTION 5.1  
3/4" = 1'-0"

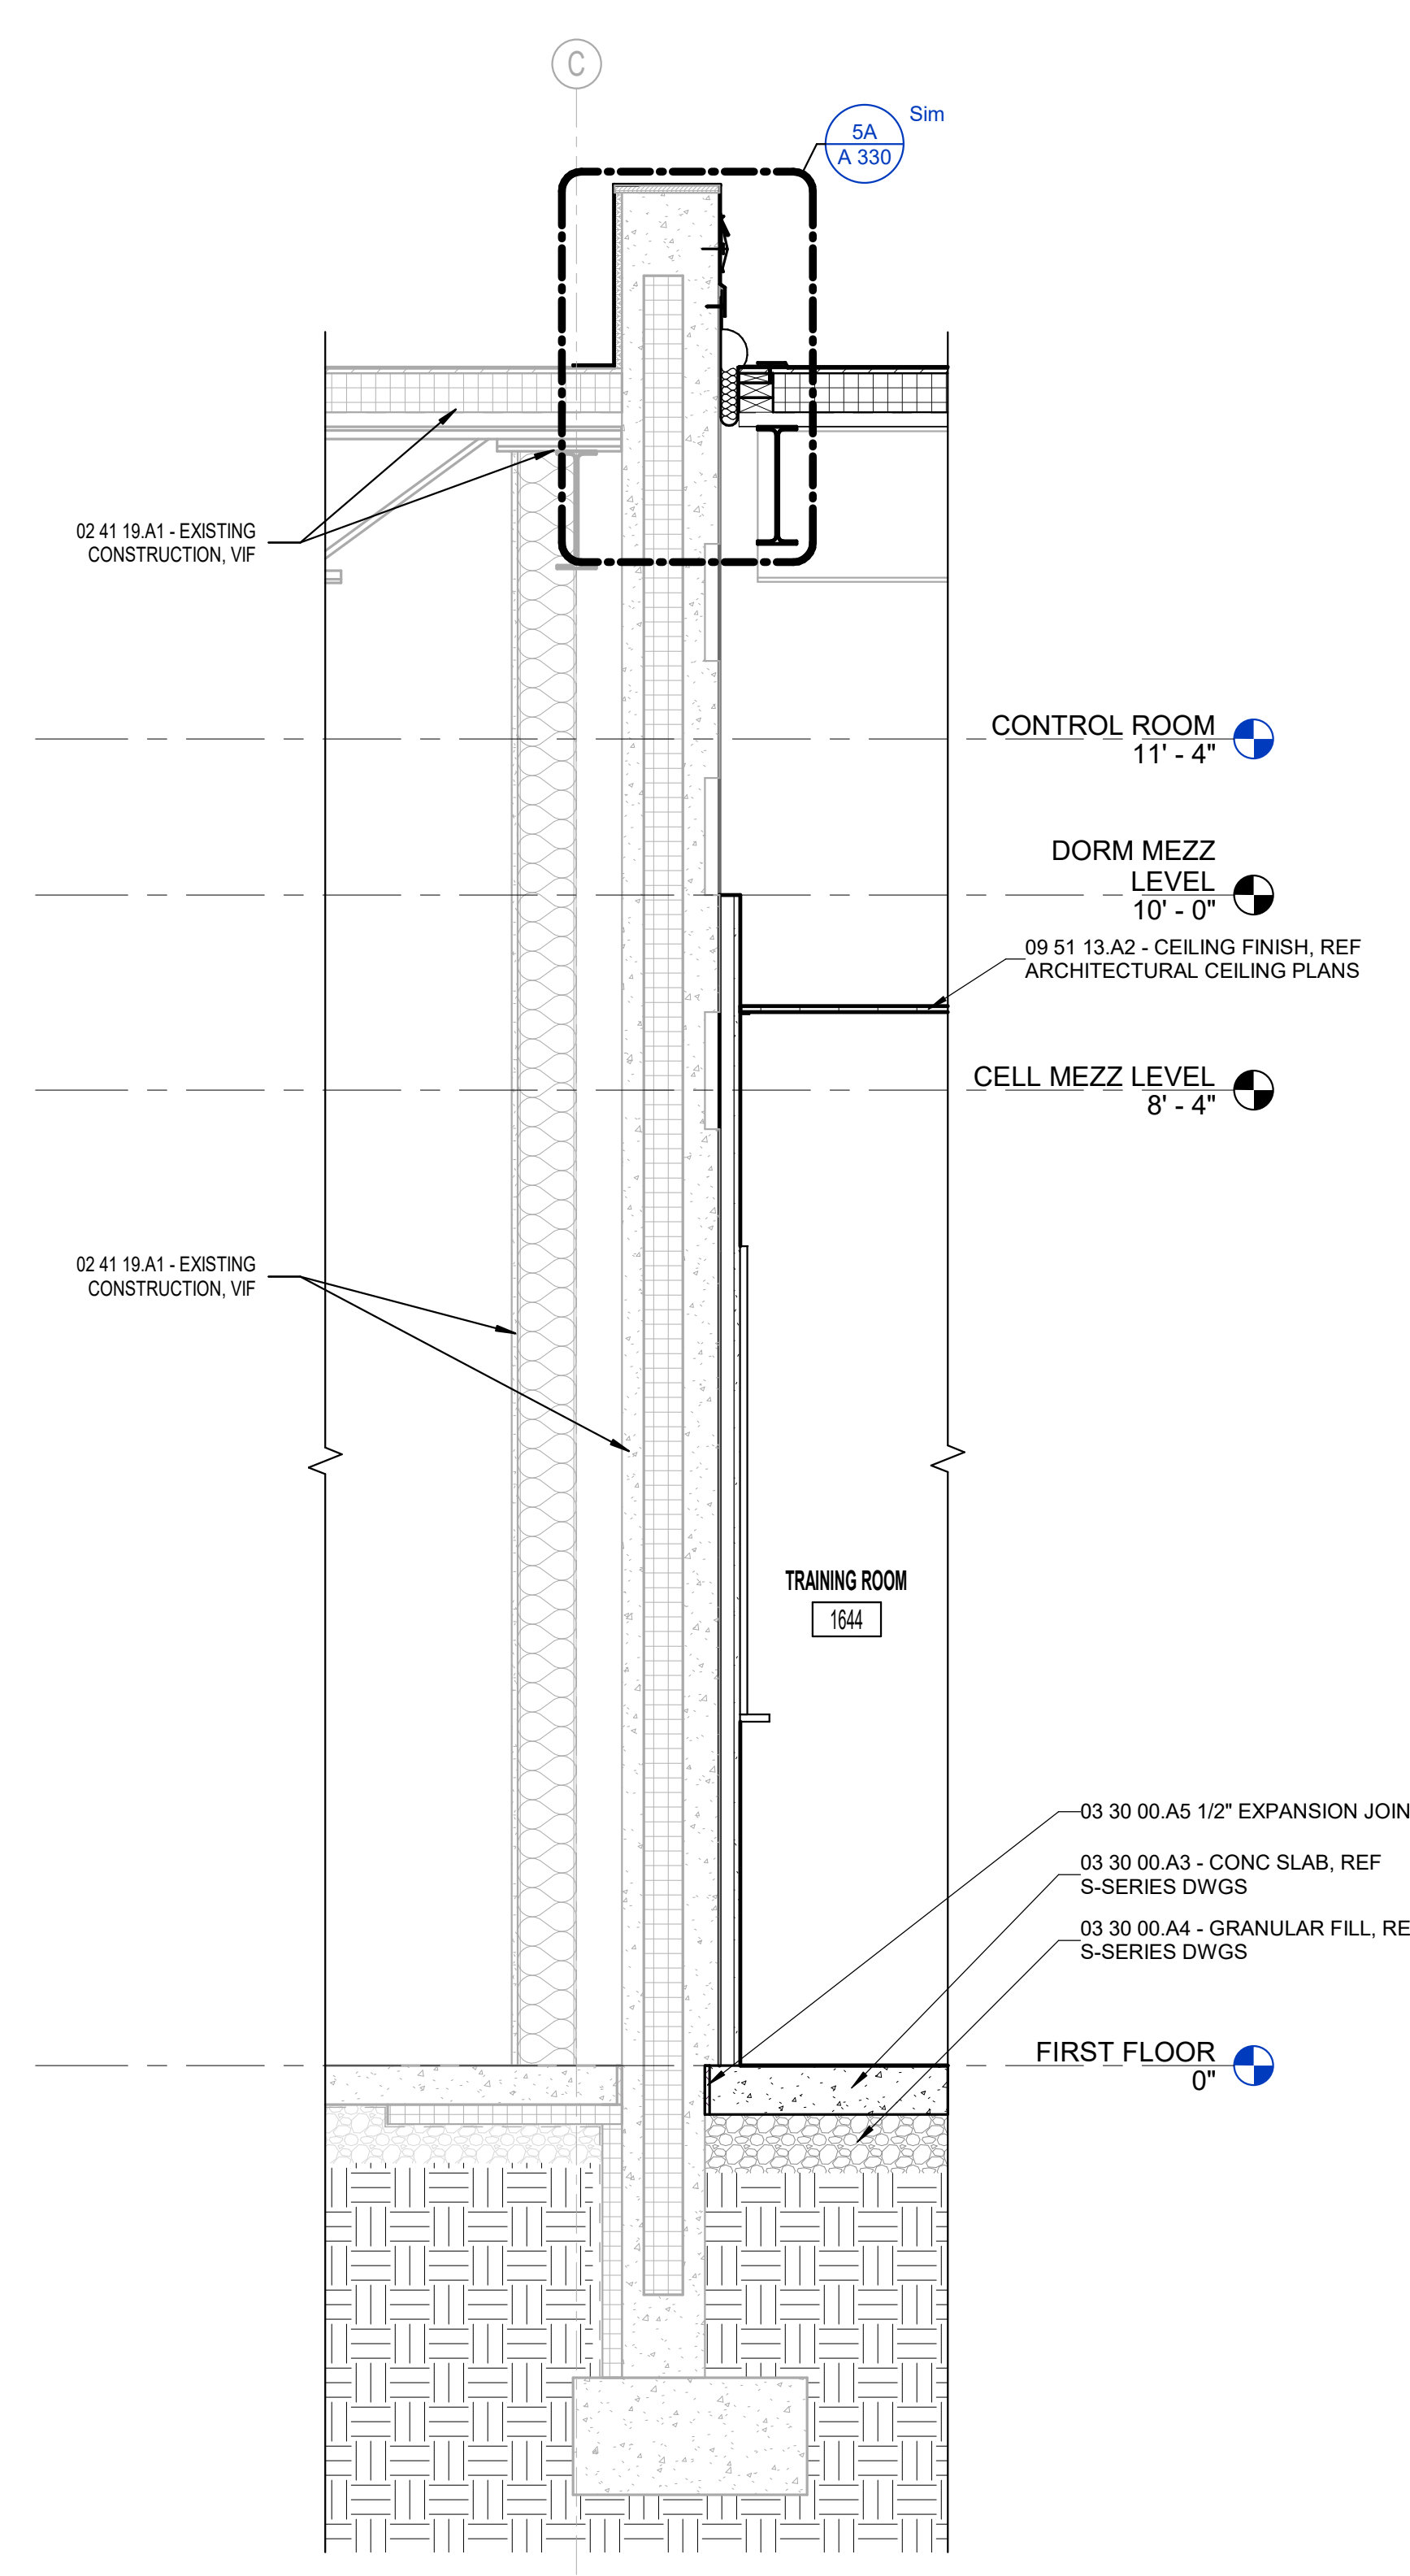


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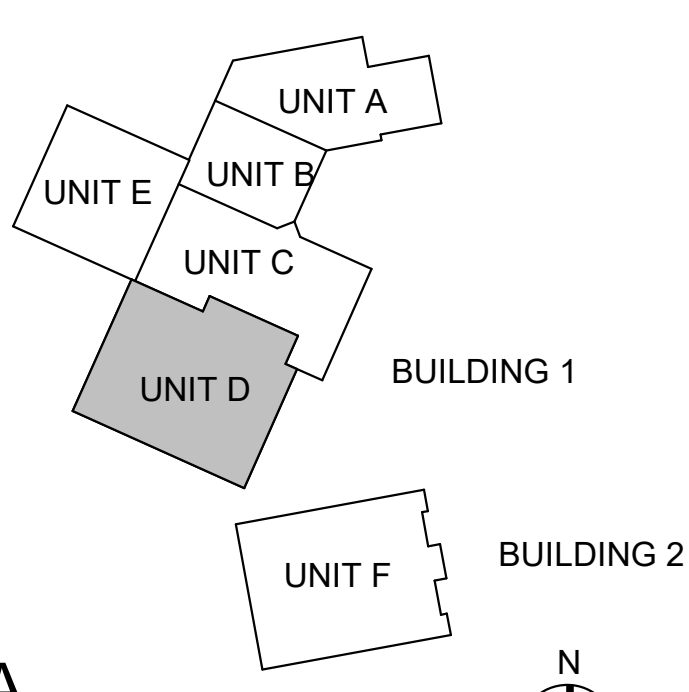
2375 OLD DECKER RD. VINCENNES, IN 47591

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Designed By: LD/SP  
Drawn By: CP  
Checked By: LD/EV  
Date: 02.04.2022




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WALL SECTIONS & DETAILS

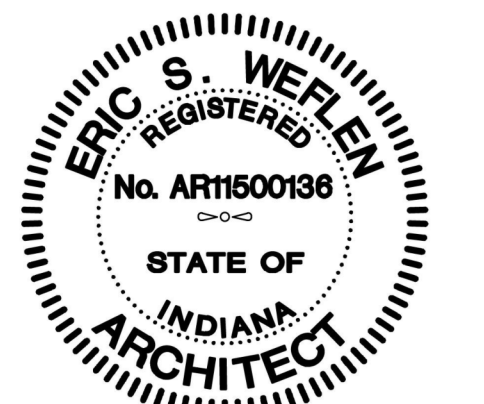A 313



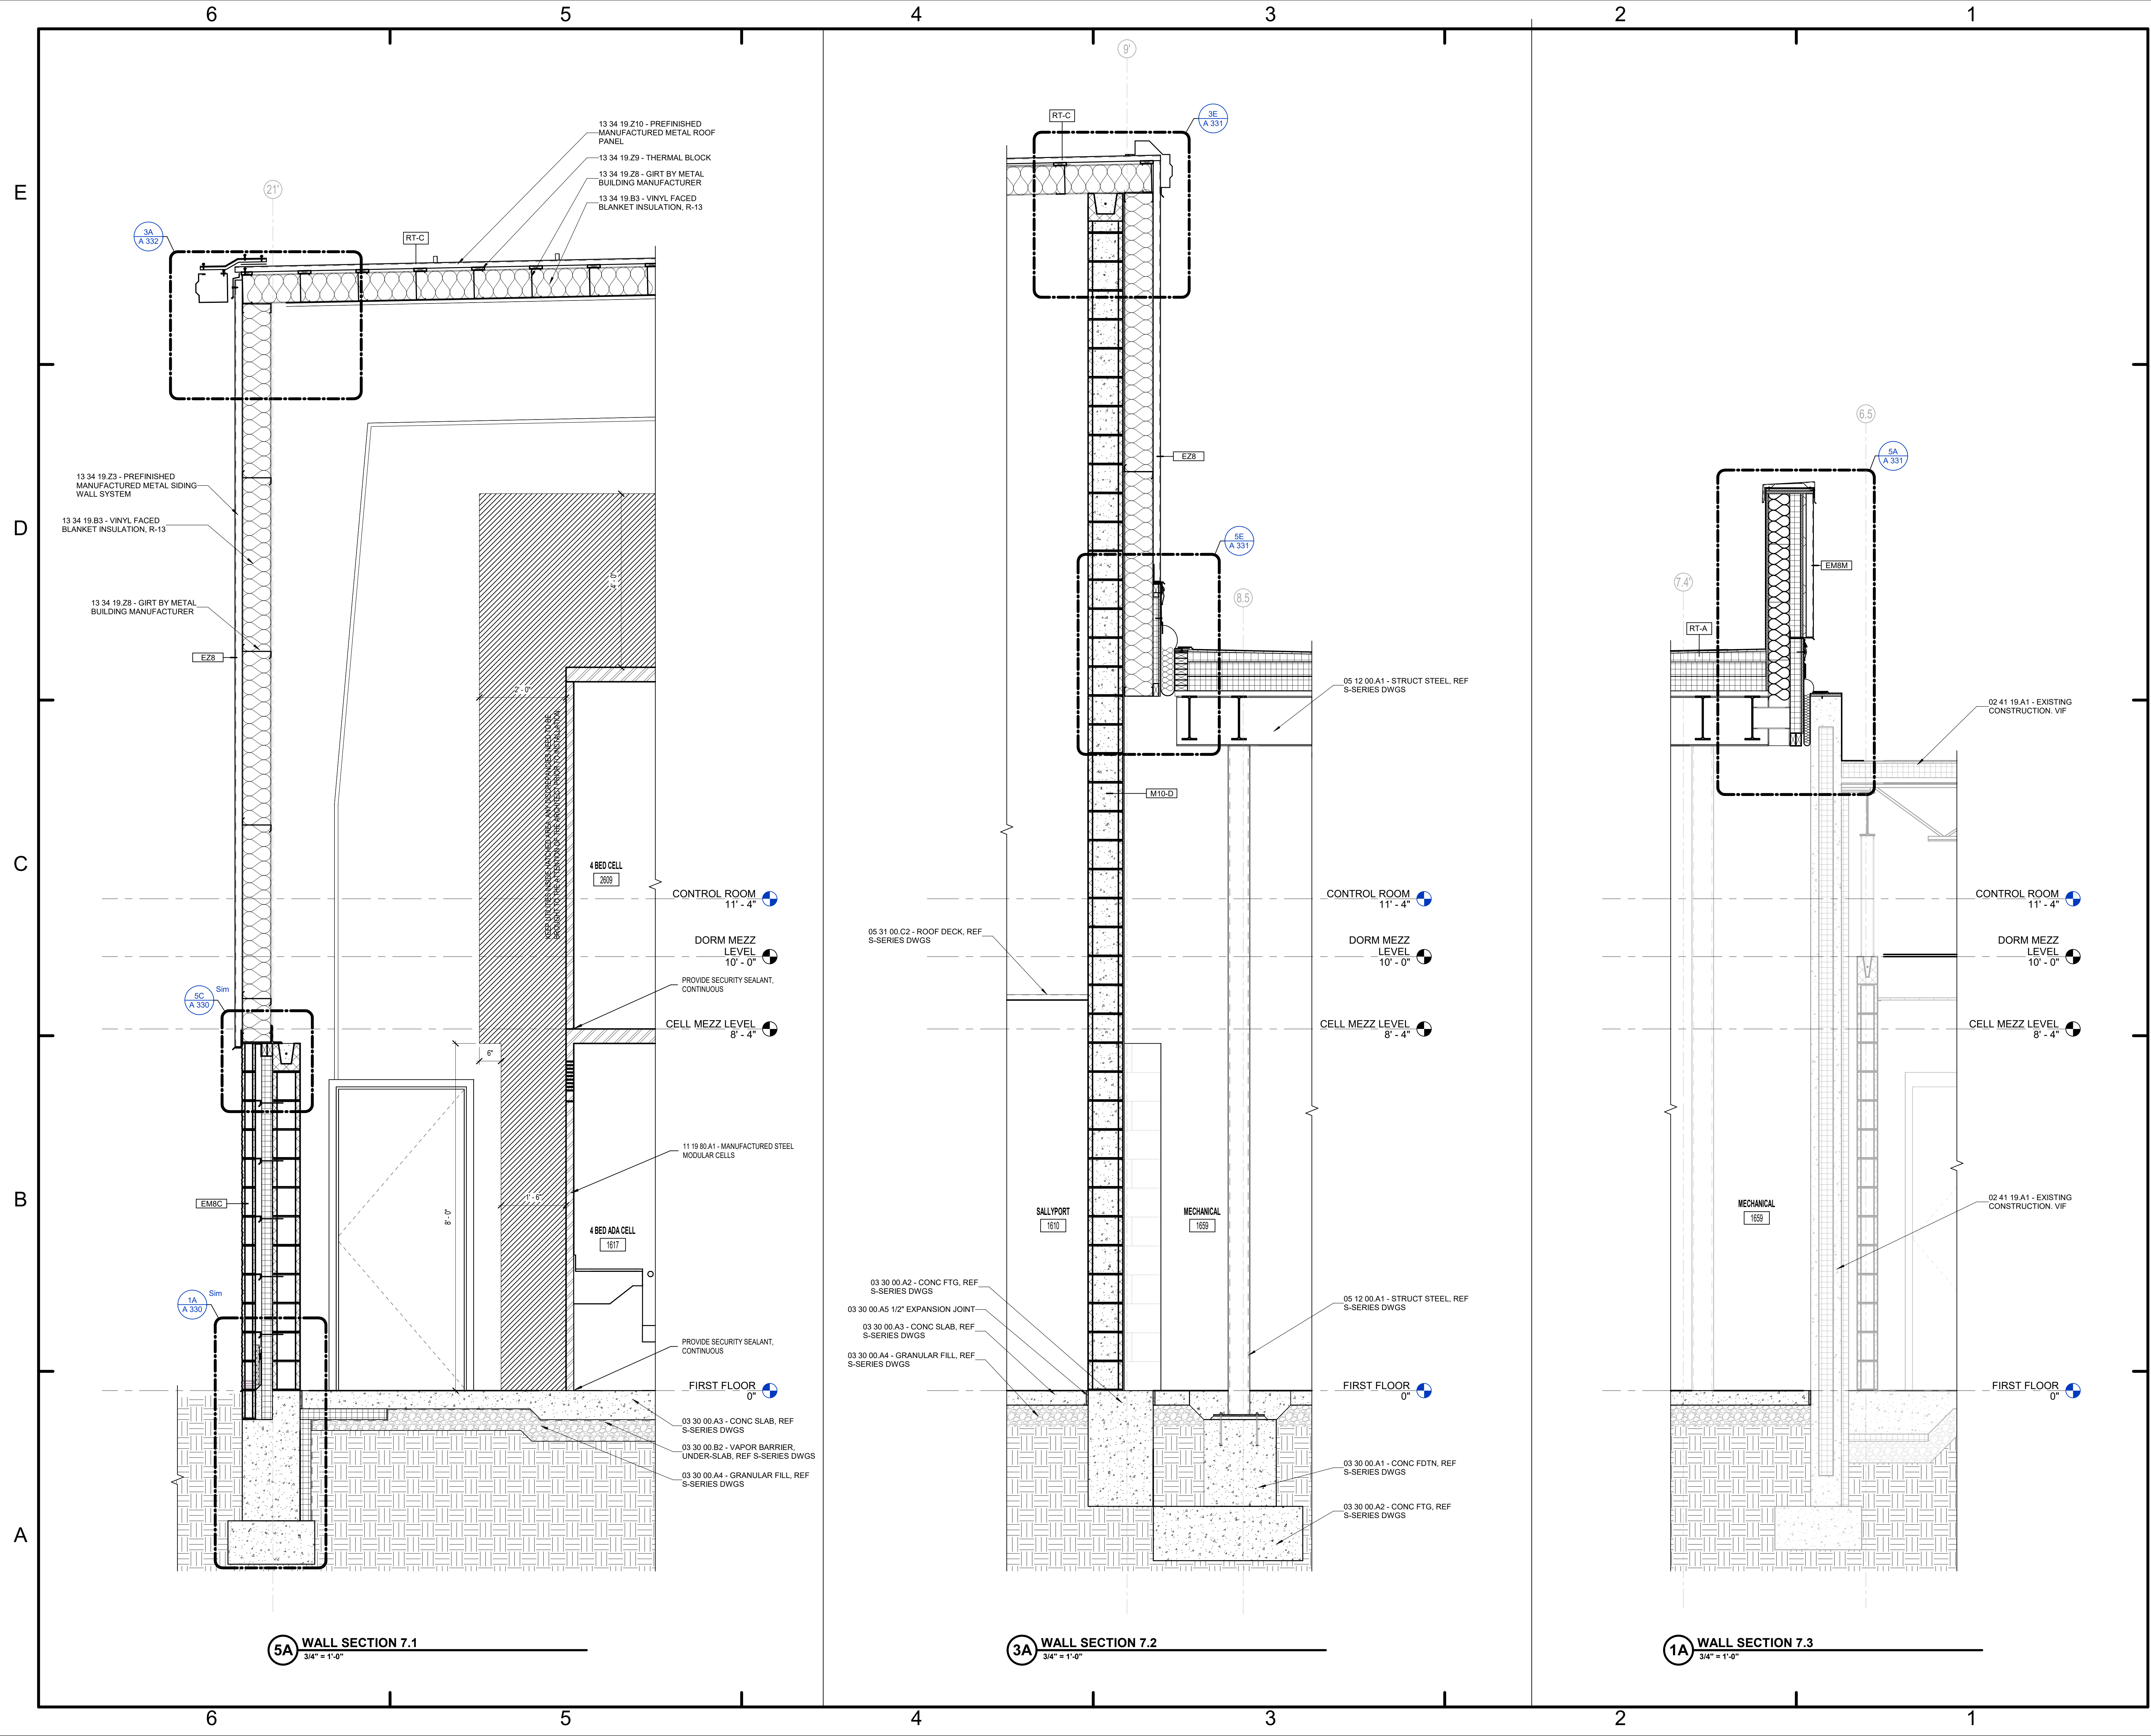


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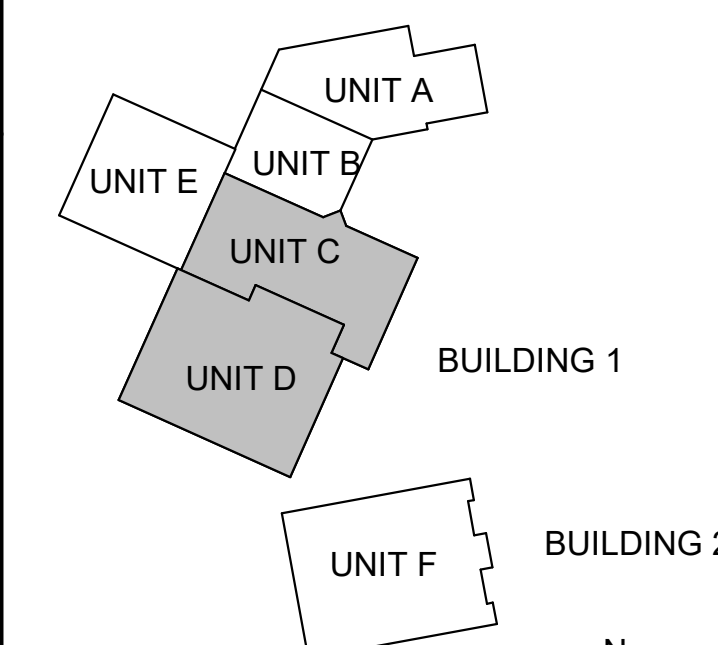
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Project #: 20-700-151-2  
Designed By: LD/SP  
Drawn By: CP  
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Date: 02.04.2022




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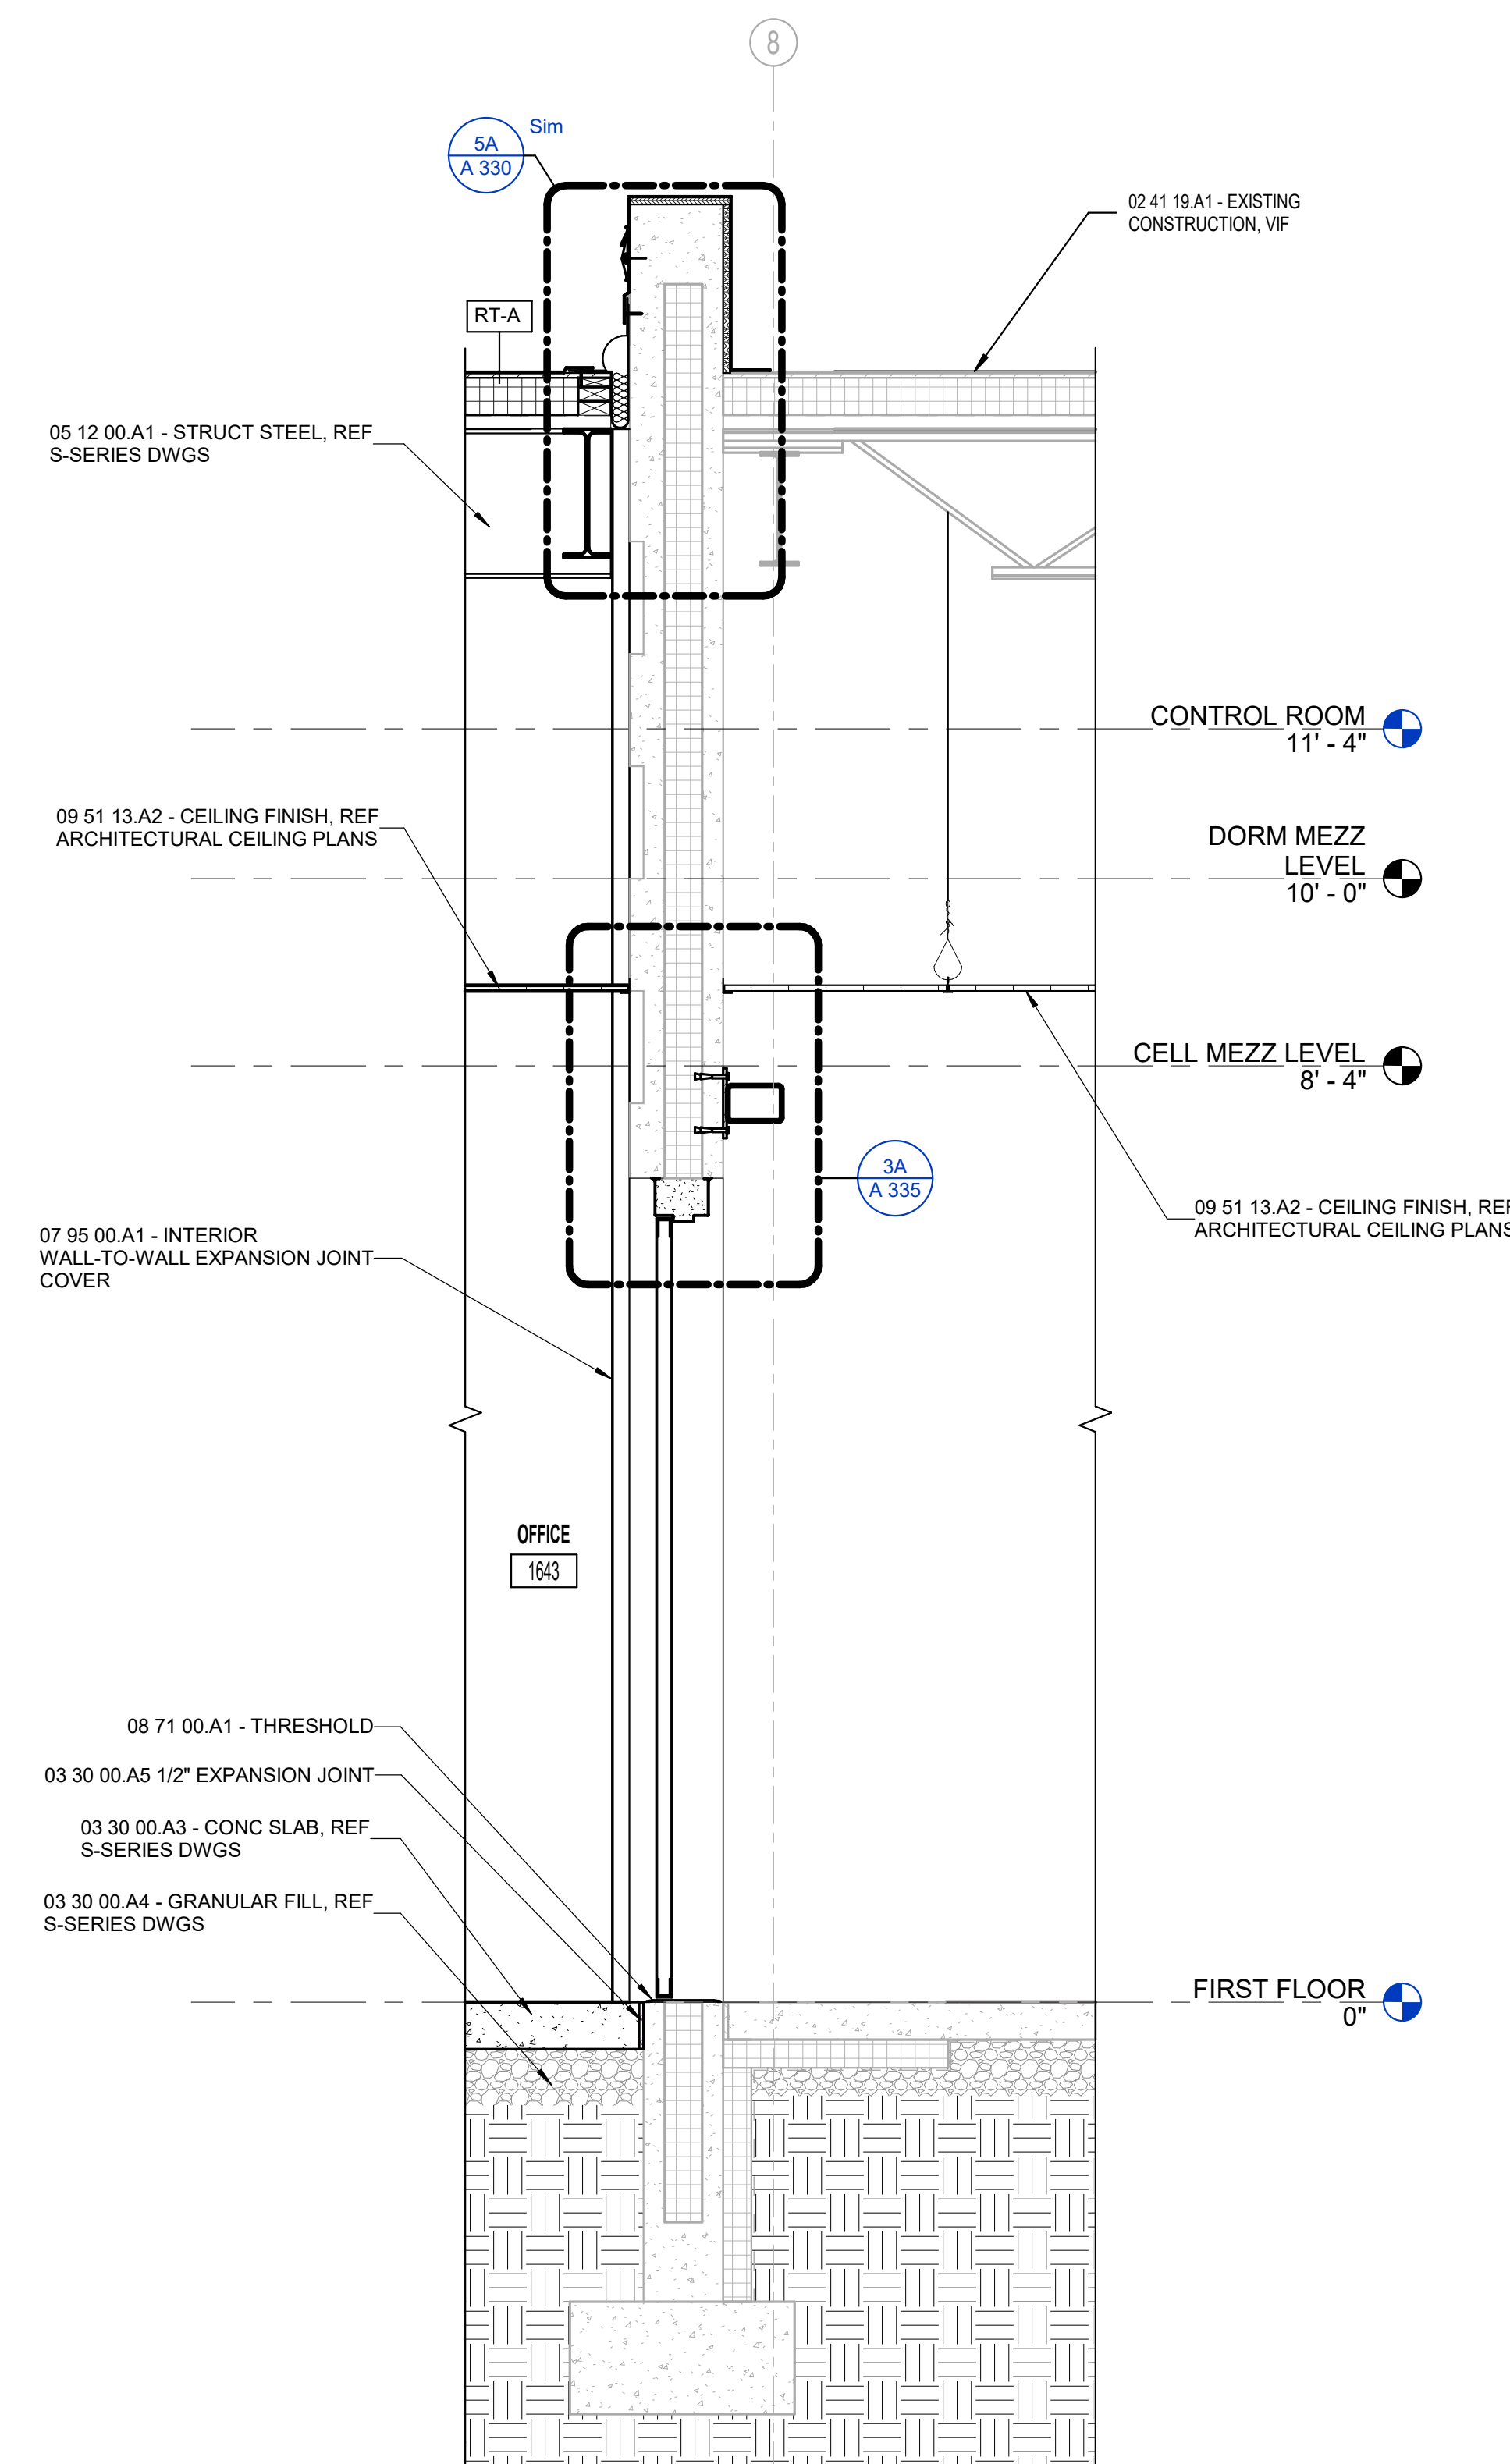


WALL SECTIONS & DETAILS

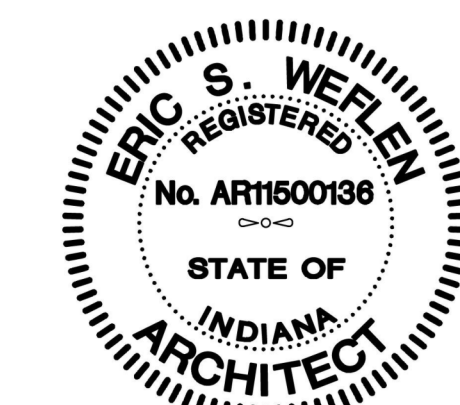
**A 314**

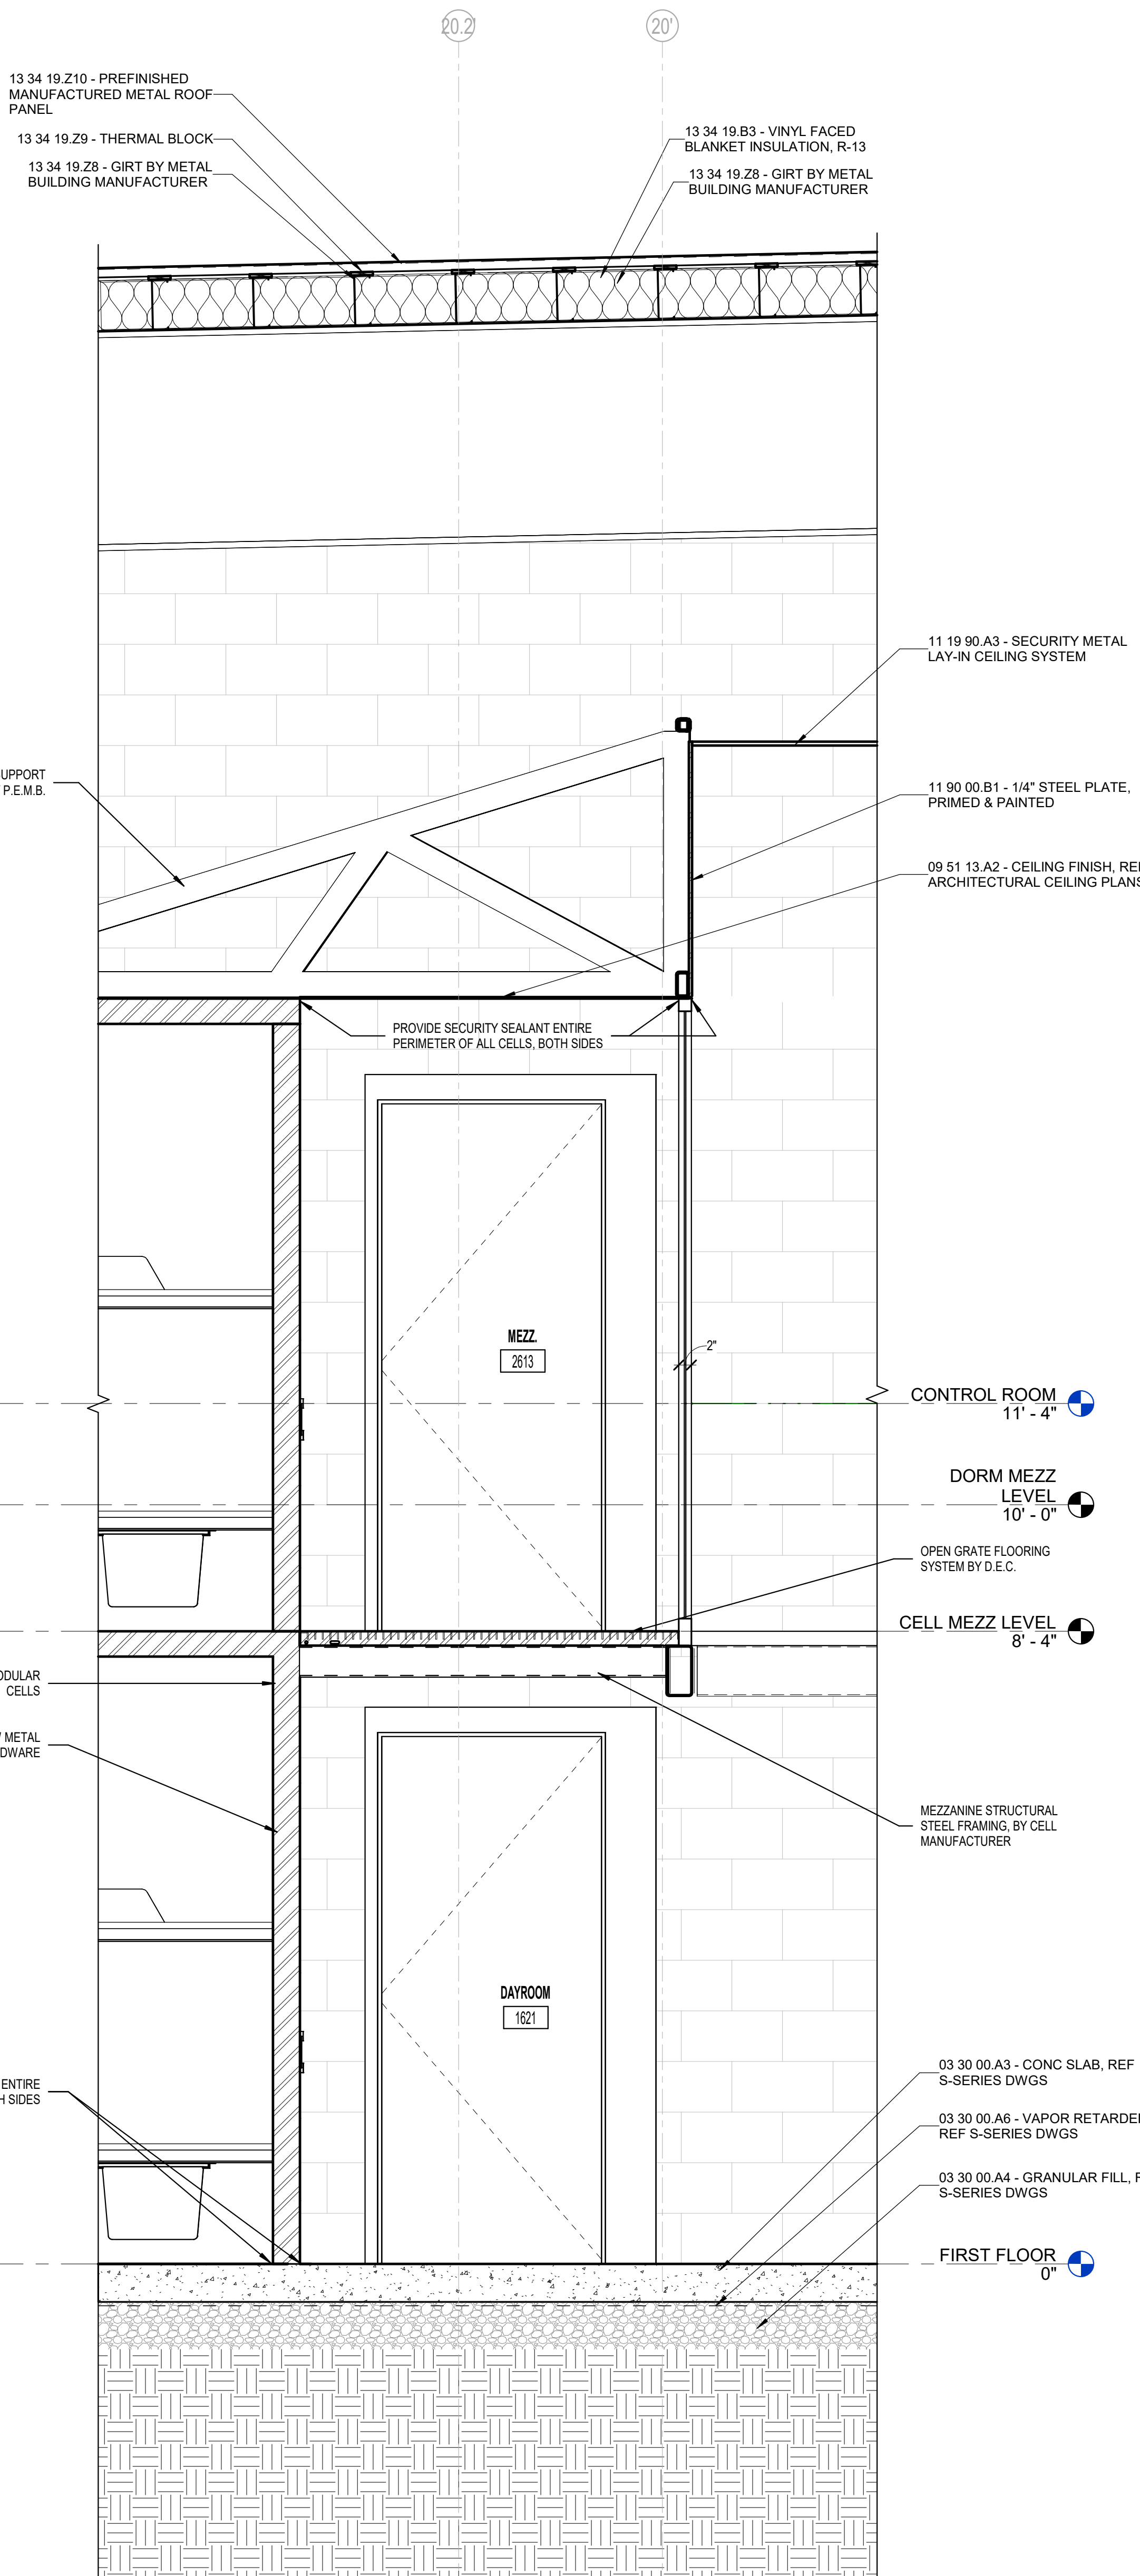

**5A WALL SECTION 8.1**  
3/4" = 1'-0"




**3A WALL SECTION 8.2**  
3/4" = 1'-0"

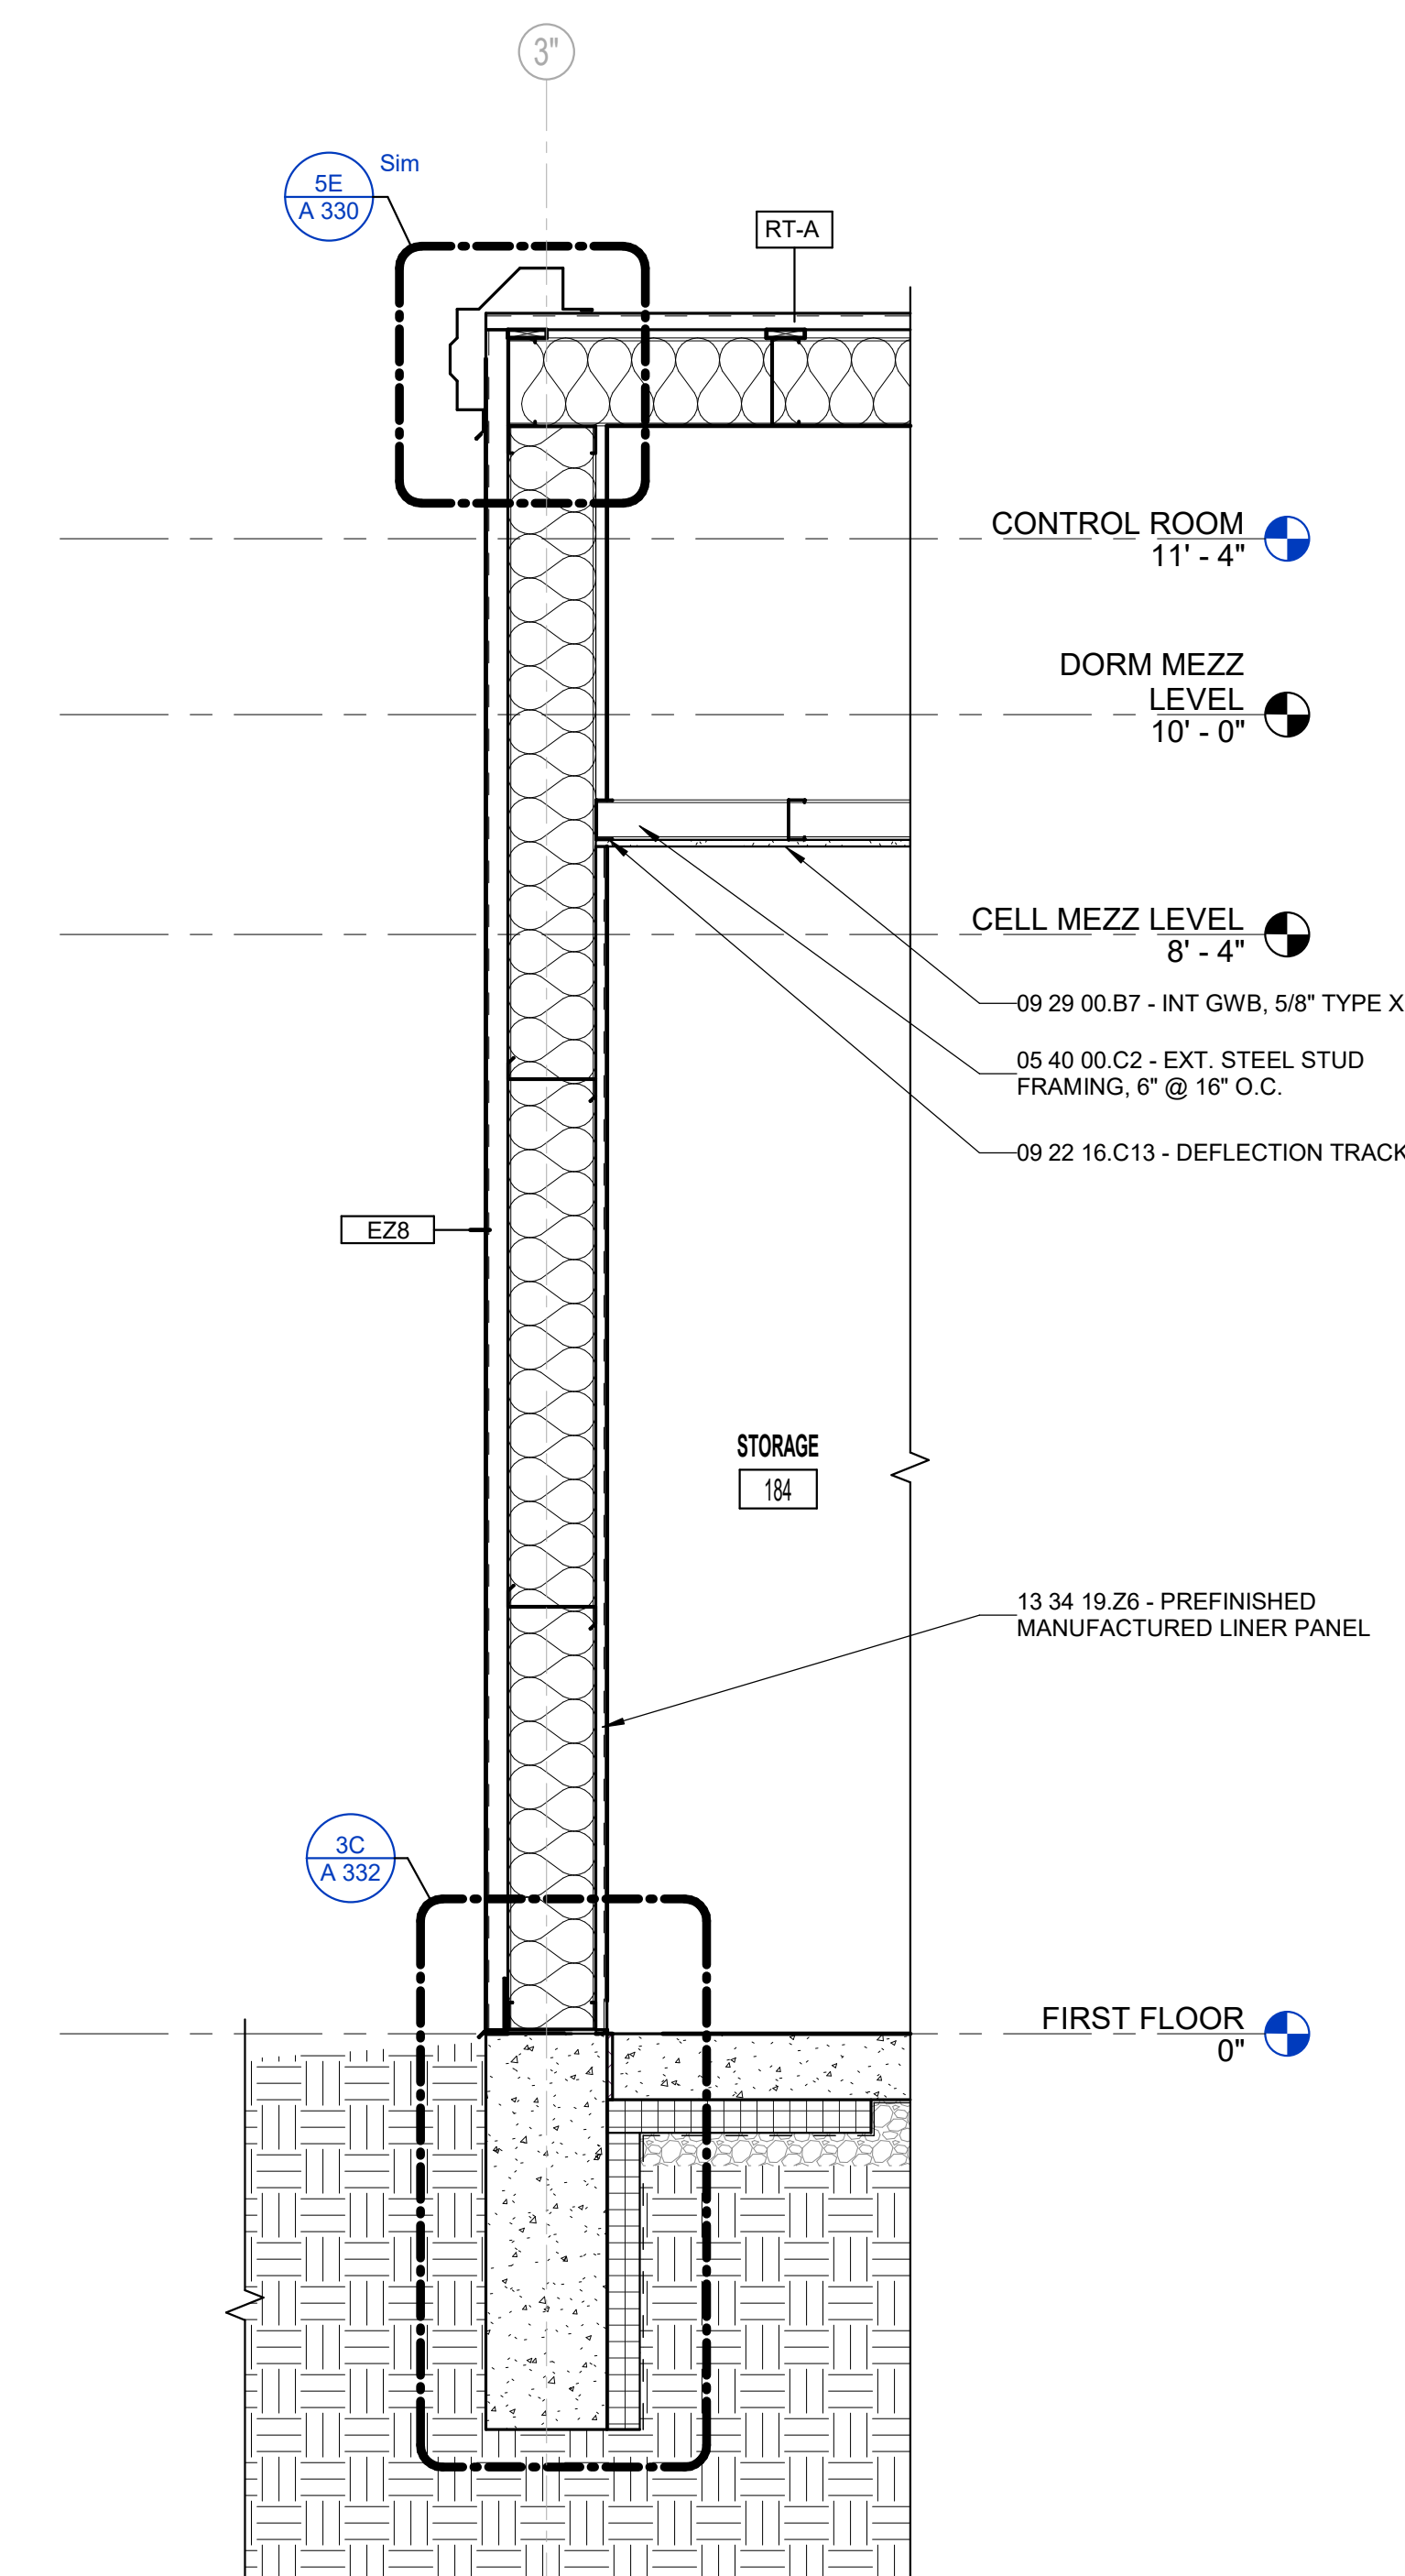

**1A WALL SECTION 9.1**  
3/4" = 1'-0"



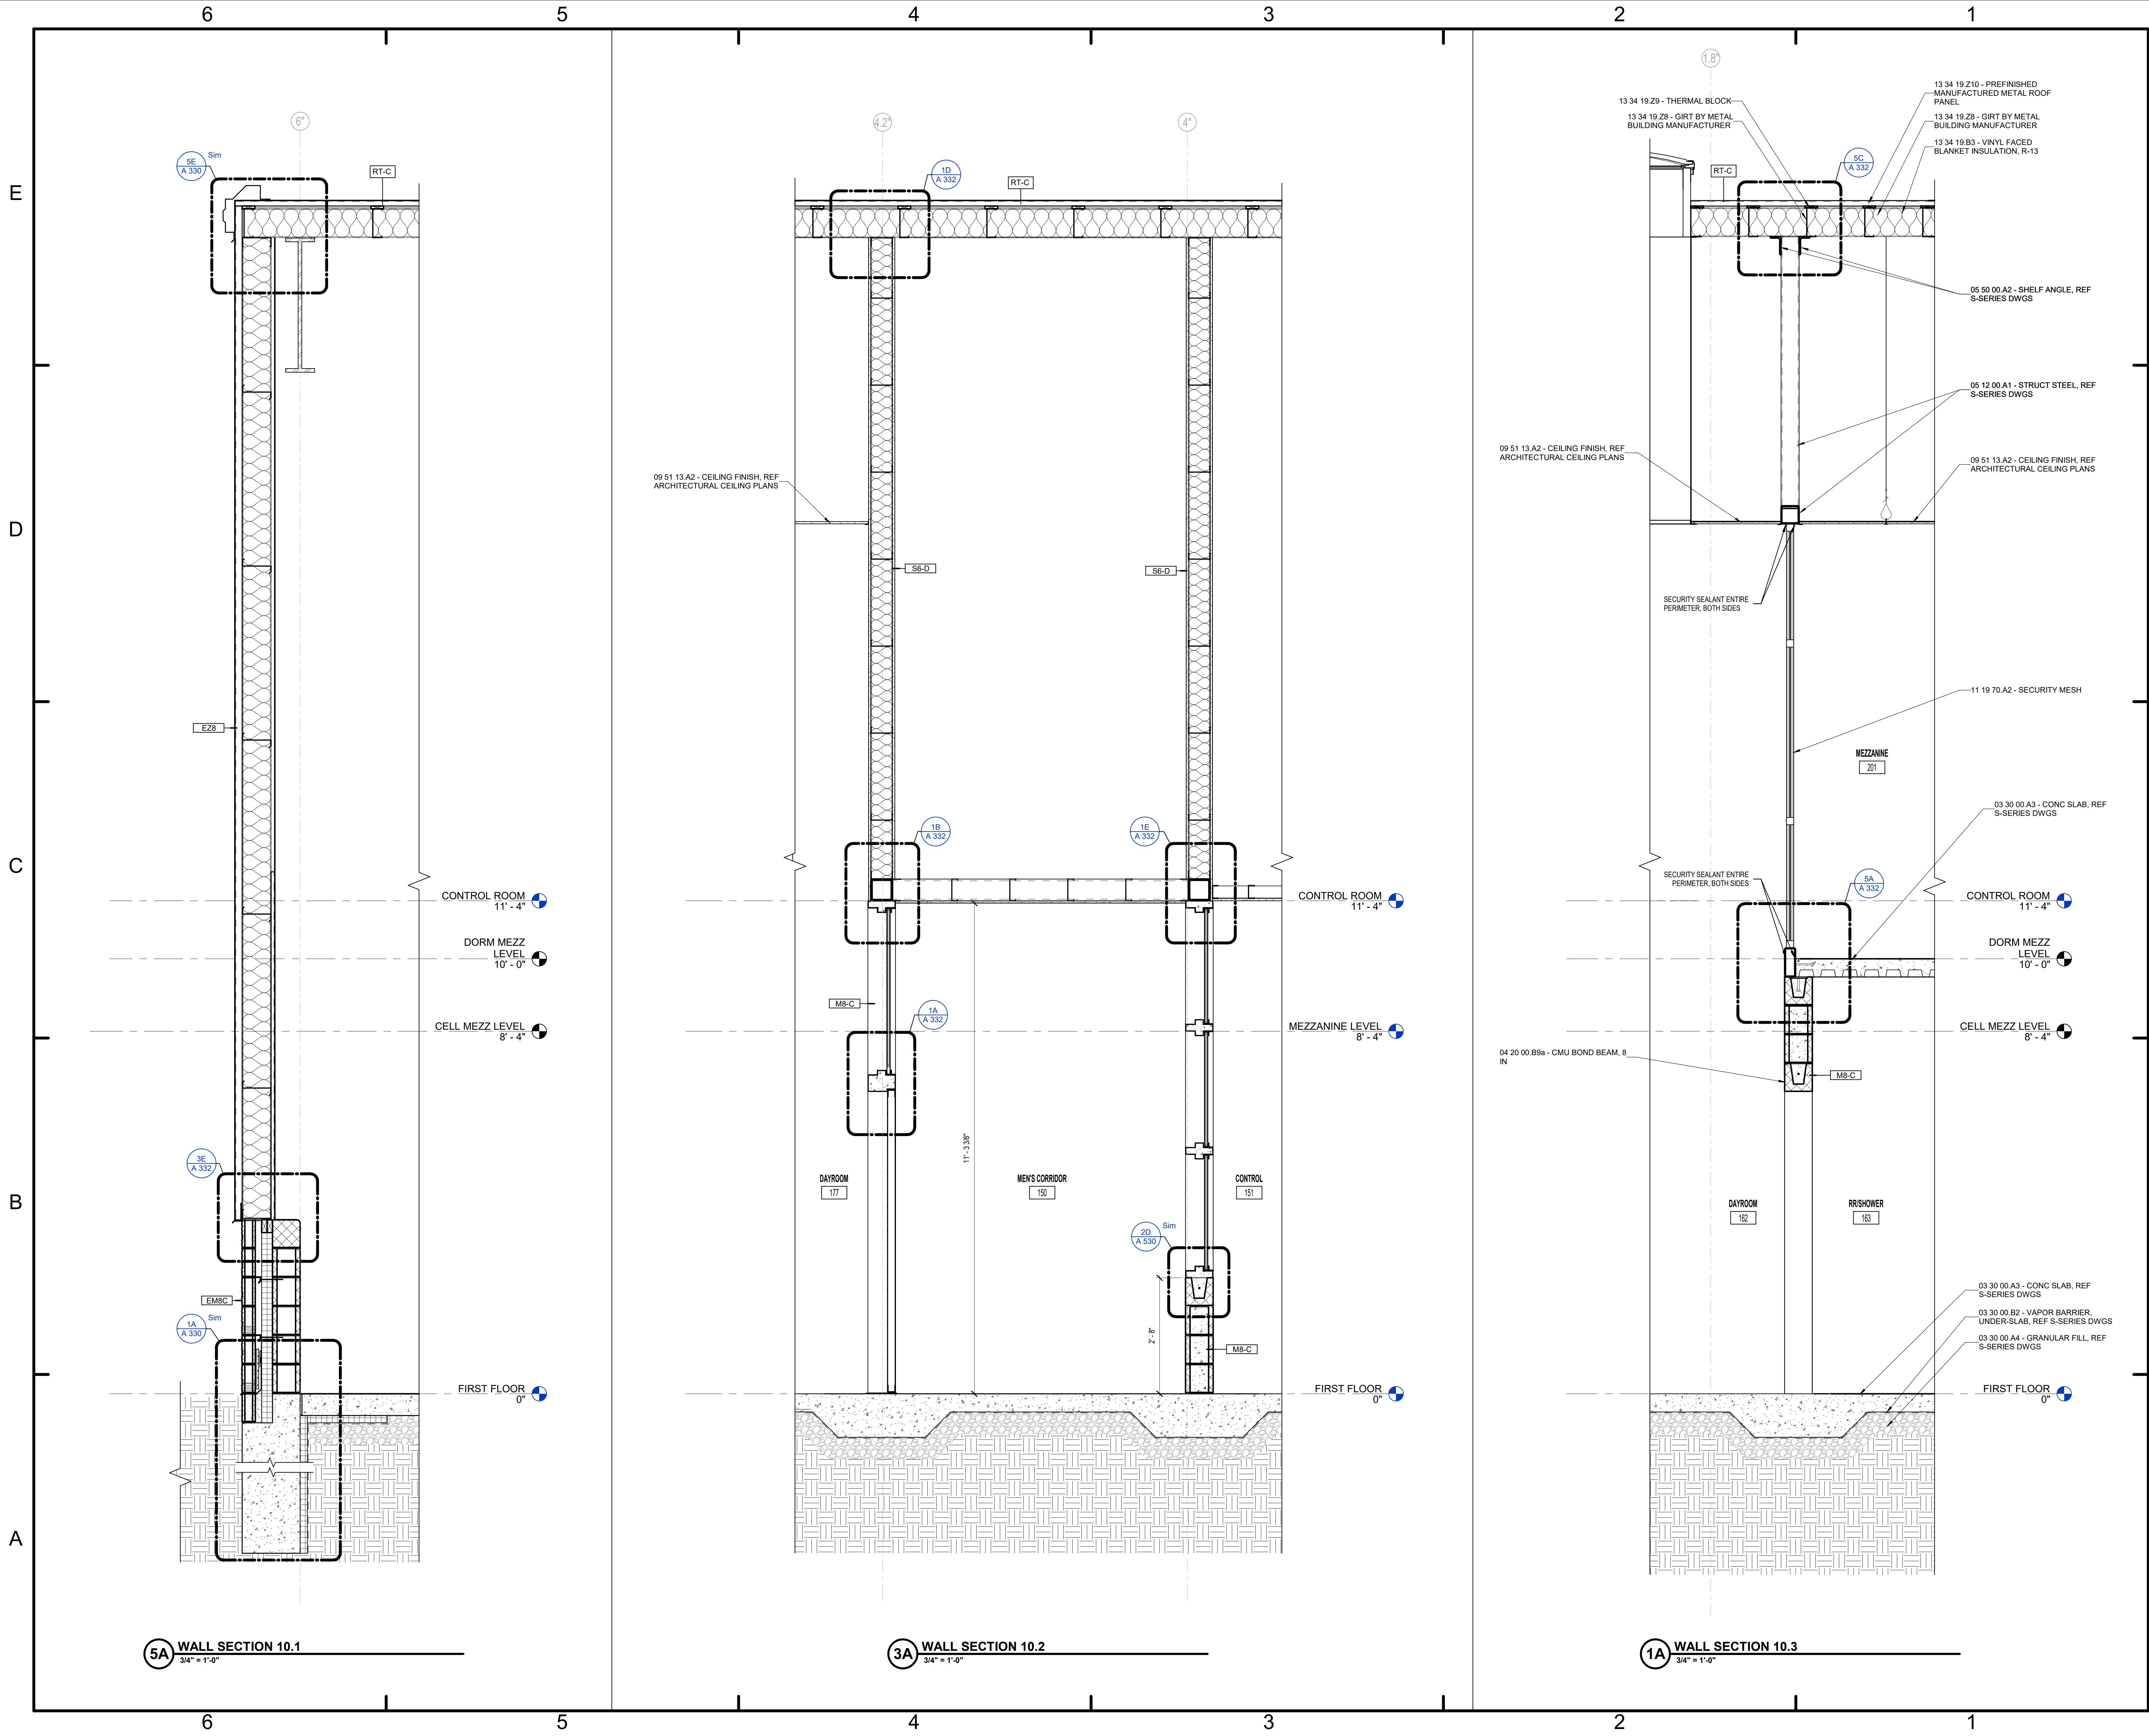

KNOX COUNTY BOARD OF COMMISSIONERS

**KNOX COUNTY JUSTICE CAMPUS**

2375 OLD DECKER RD. VINCENNES, IN 47591

#	Revision	Date

Project # 20-700-151-2

Designed By: LD/SP

Drawn By: CP

Checked By: CP

Date: 02.04.2022

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WALL SECTIONS & DETAILS

**A 315**







KNOX COUNTY BOARD OF COMMISSIONERS  
KNOX COUNTY JUSTICE CAMPUS

2375 OLD DECKER RD. VINCENNES, IN 47591


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#	Revision	Date
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Project #: 20-700-151-2  
Designed By: LD/SP  
Drawn By: CP  
Checked By: LD/EV  
Date: 02.04.2022




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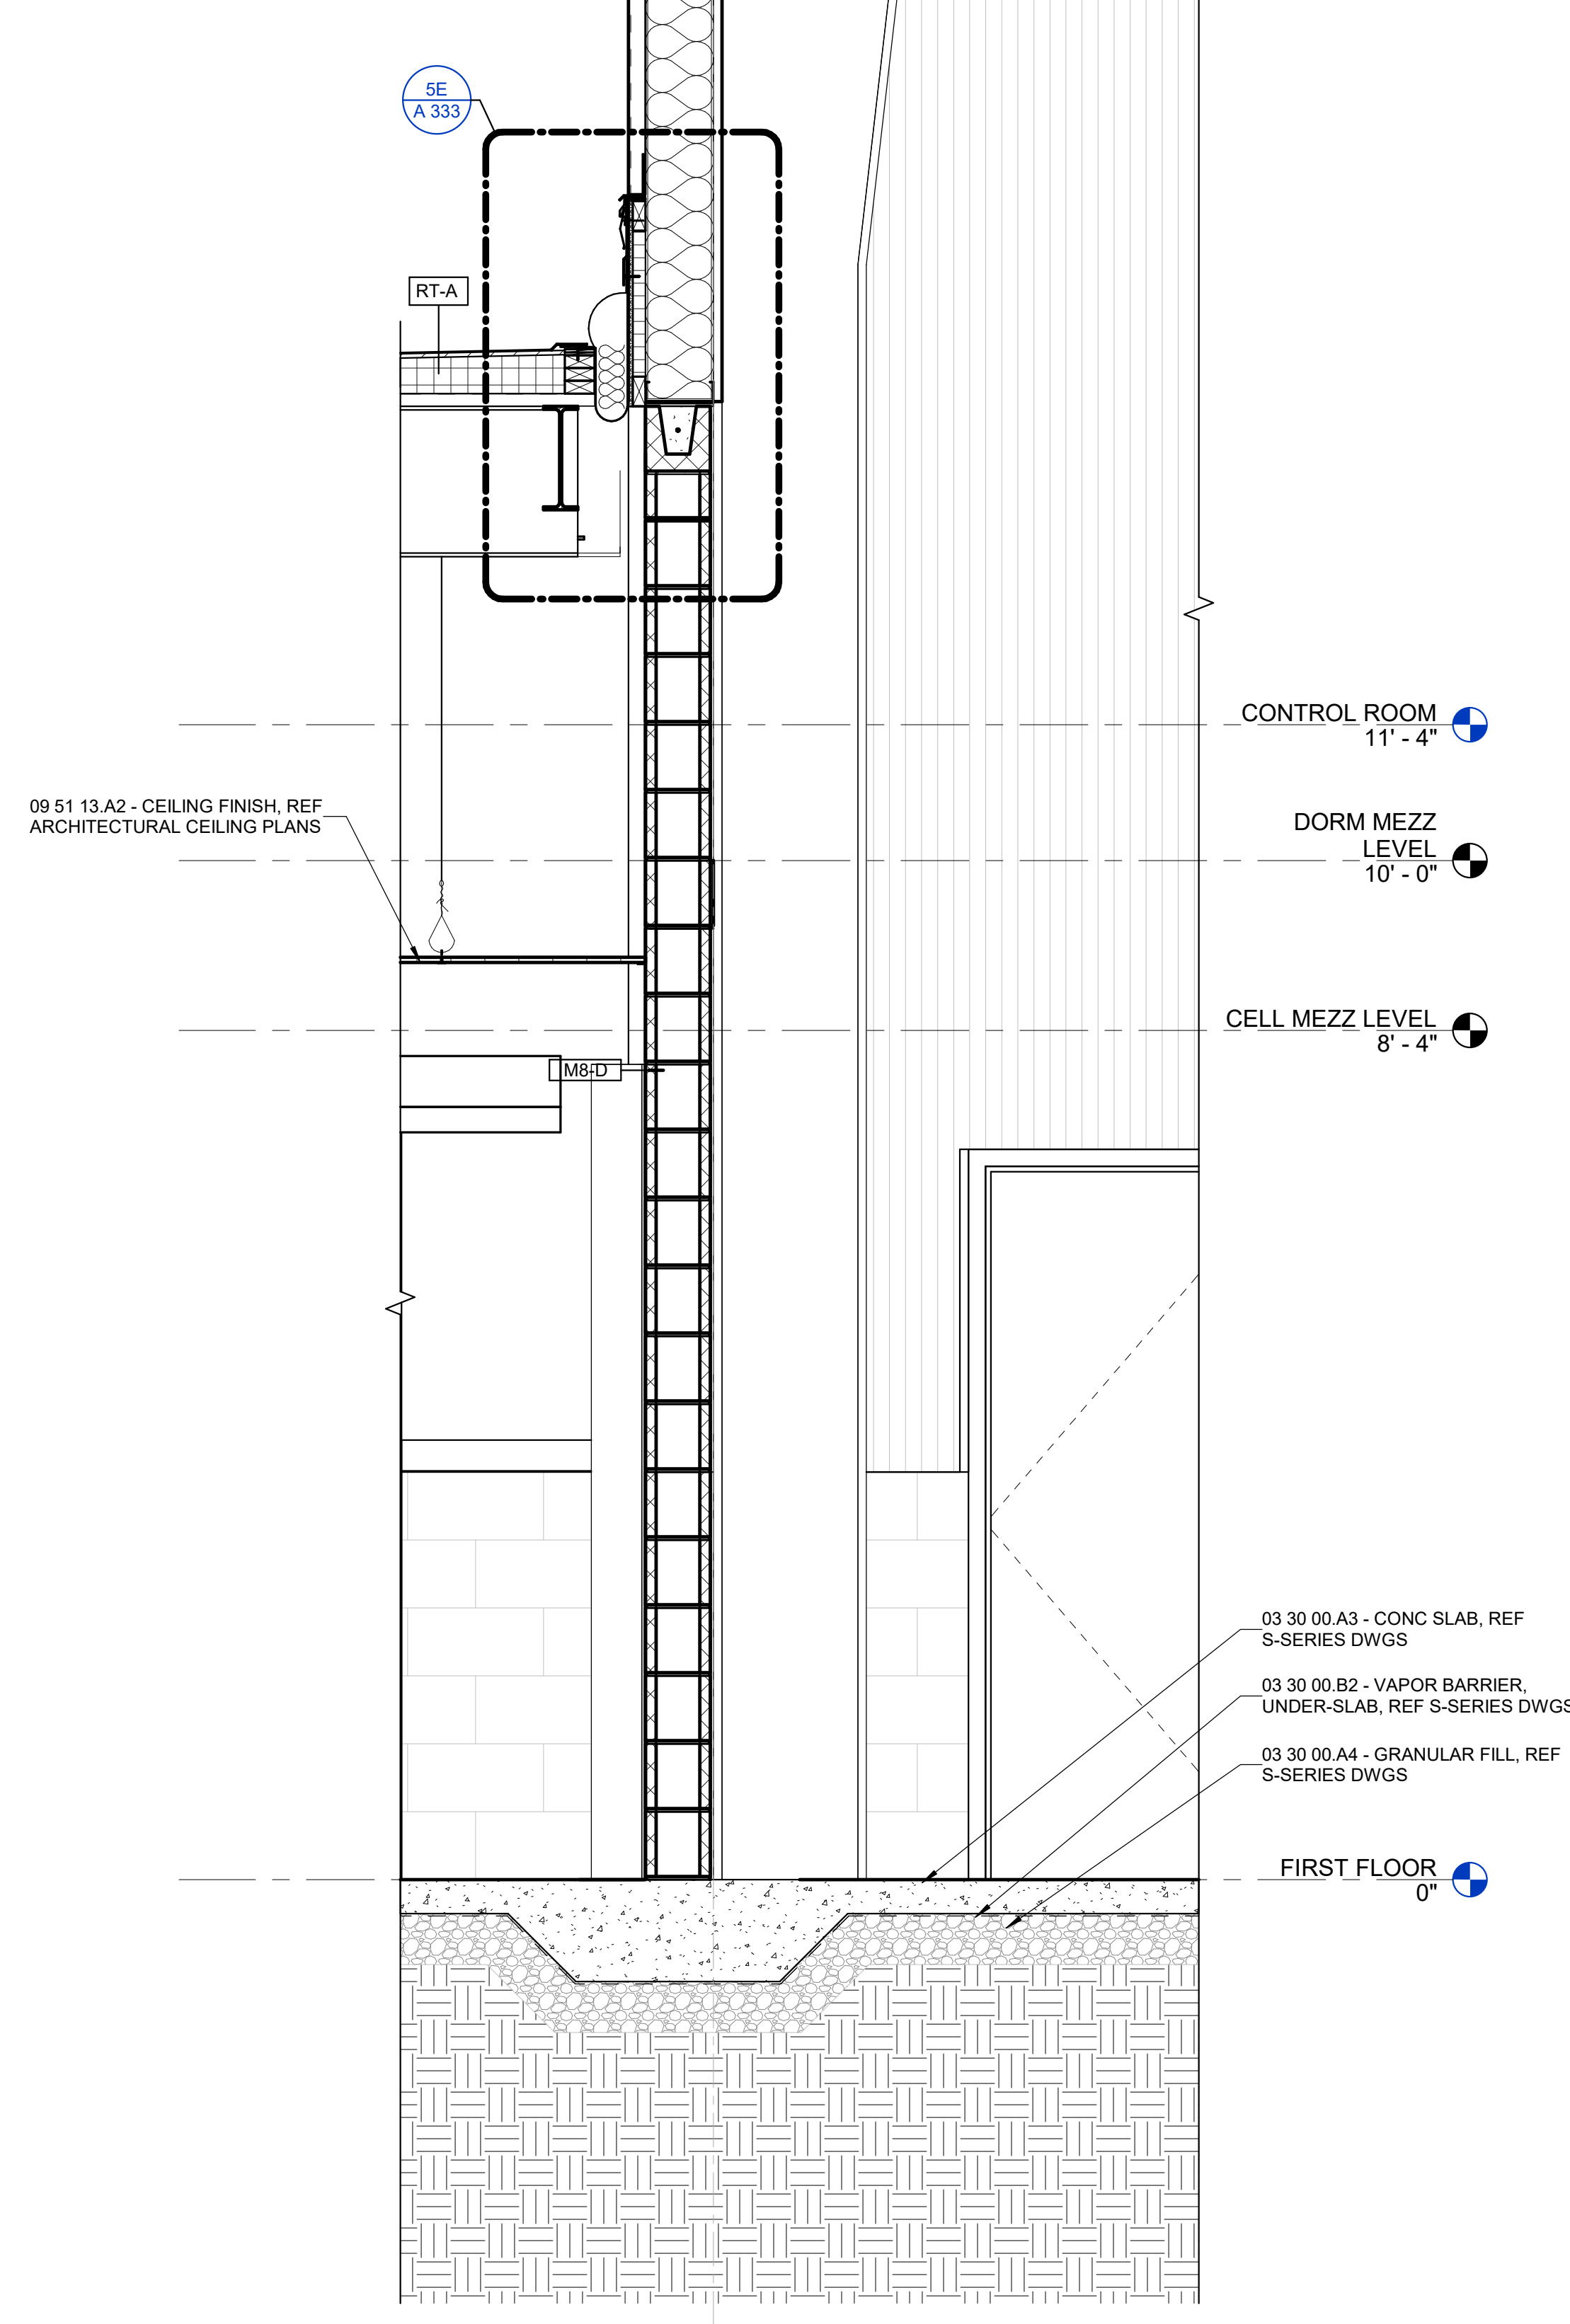
WALL SECTIONS & DETAILS

A 317


5A WALL SECTION 13.1  
3/4" = 1'-0"

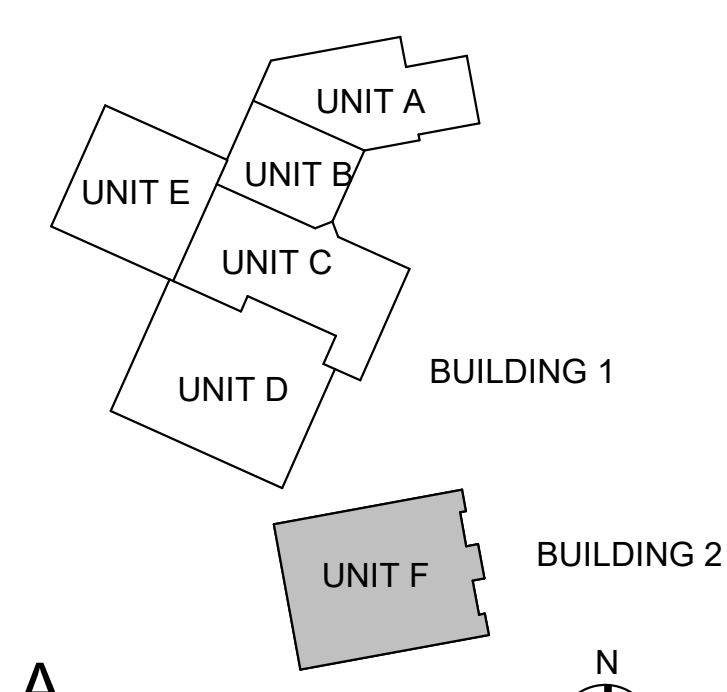

3A WALL SECTION 13.2  
3/4" = 1'-0"

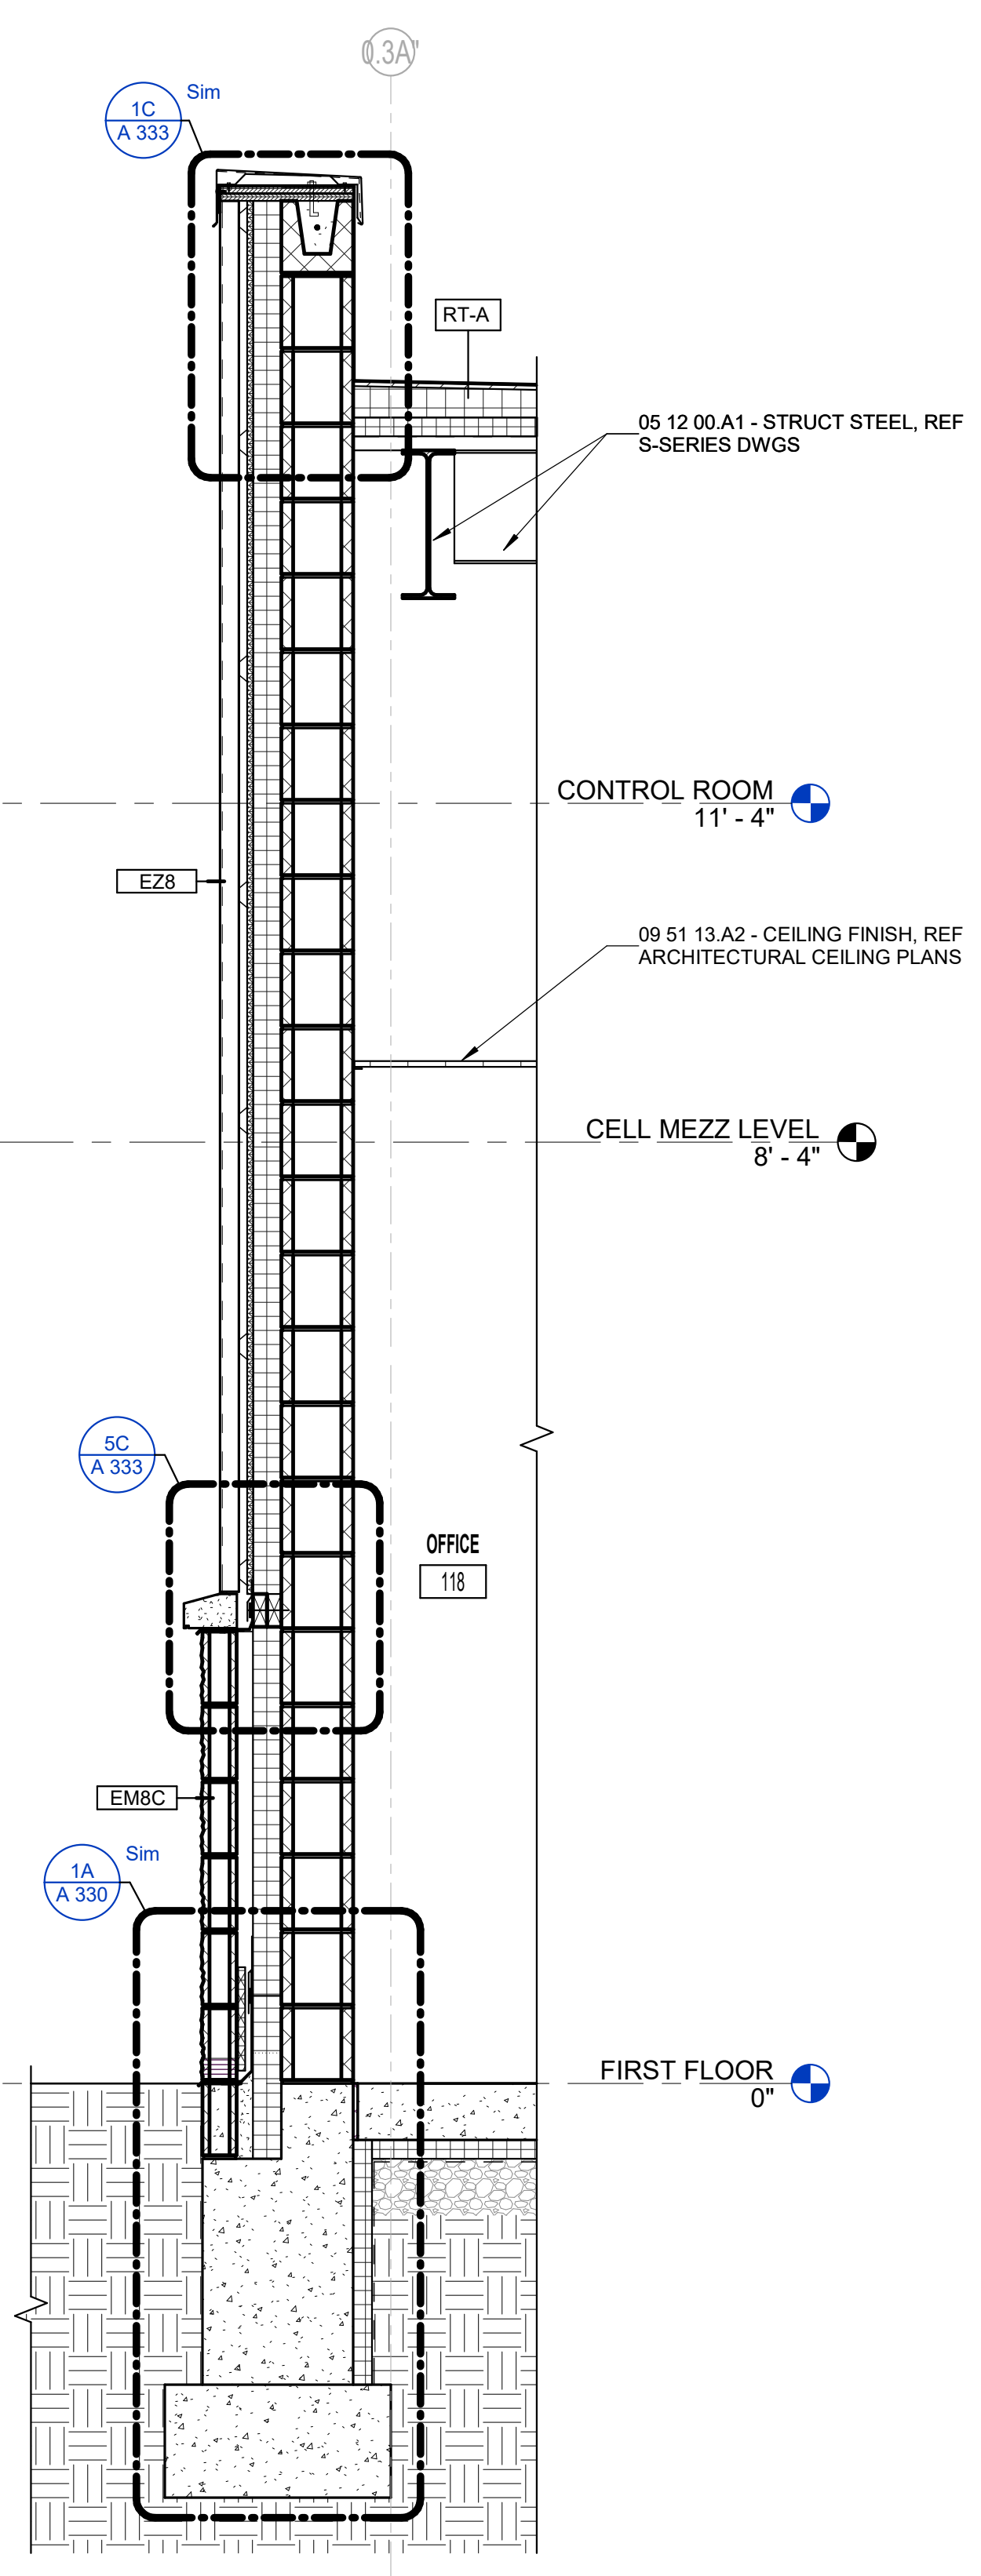

1A WALL SECTION 13.3  
3/4" = 1'-0"

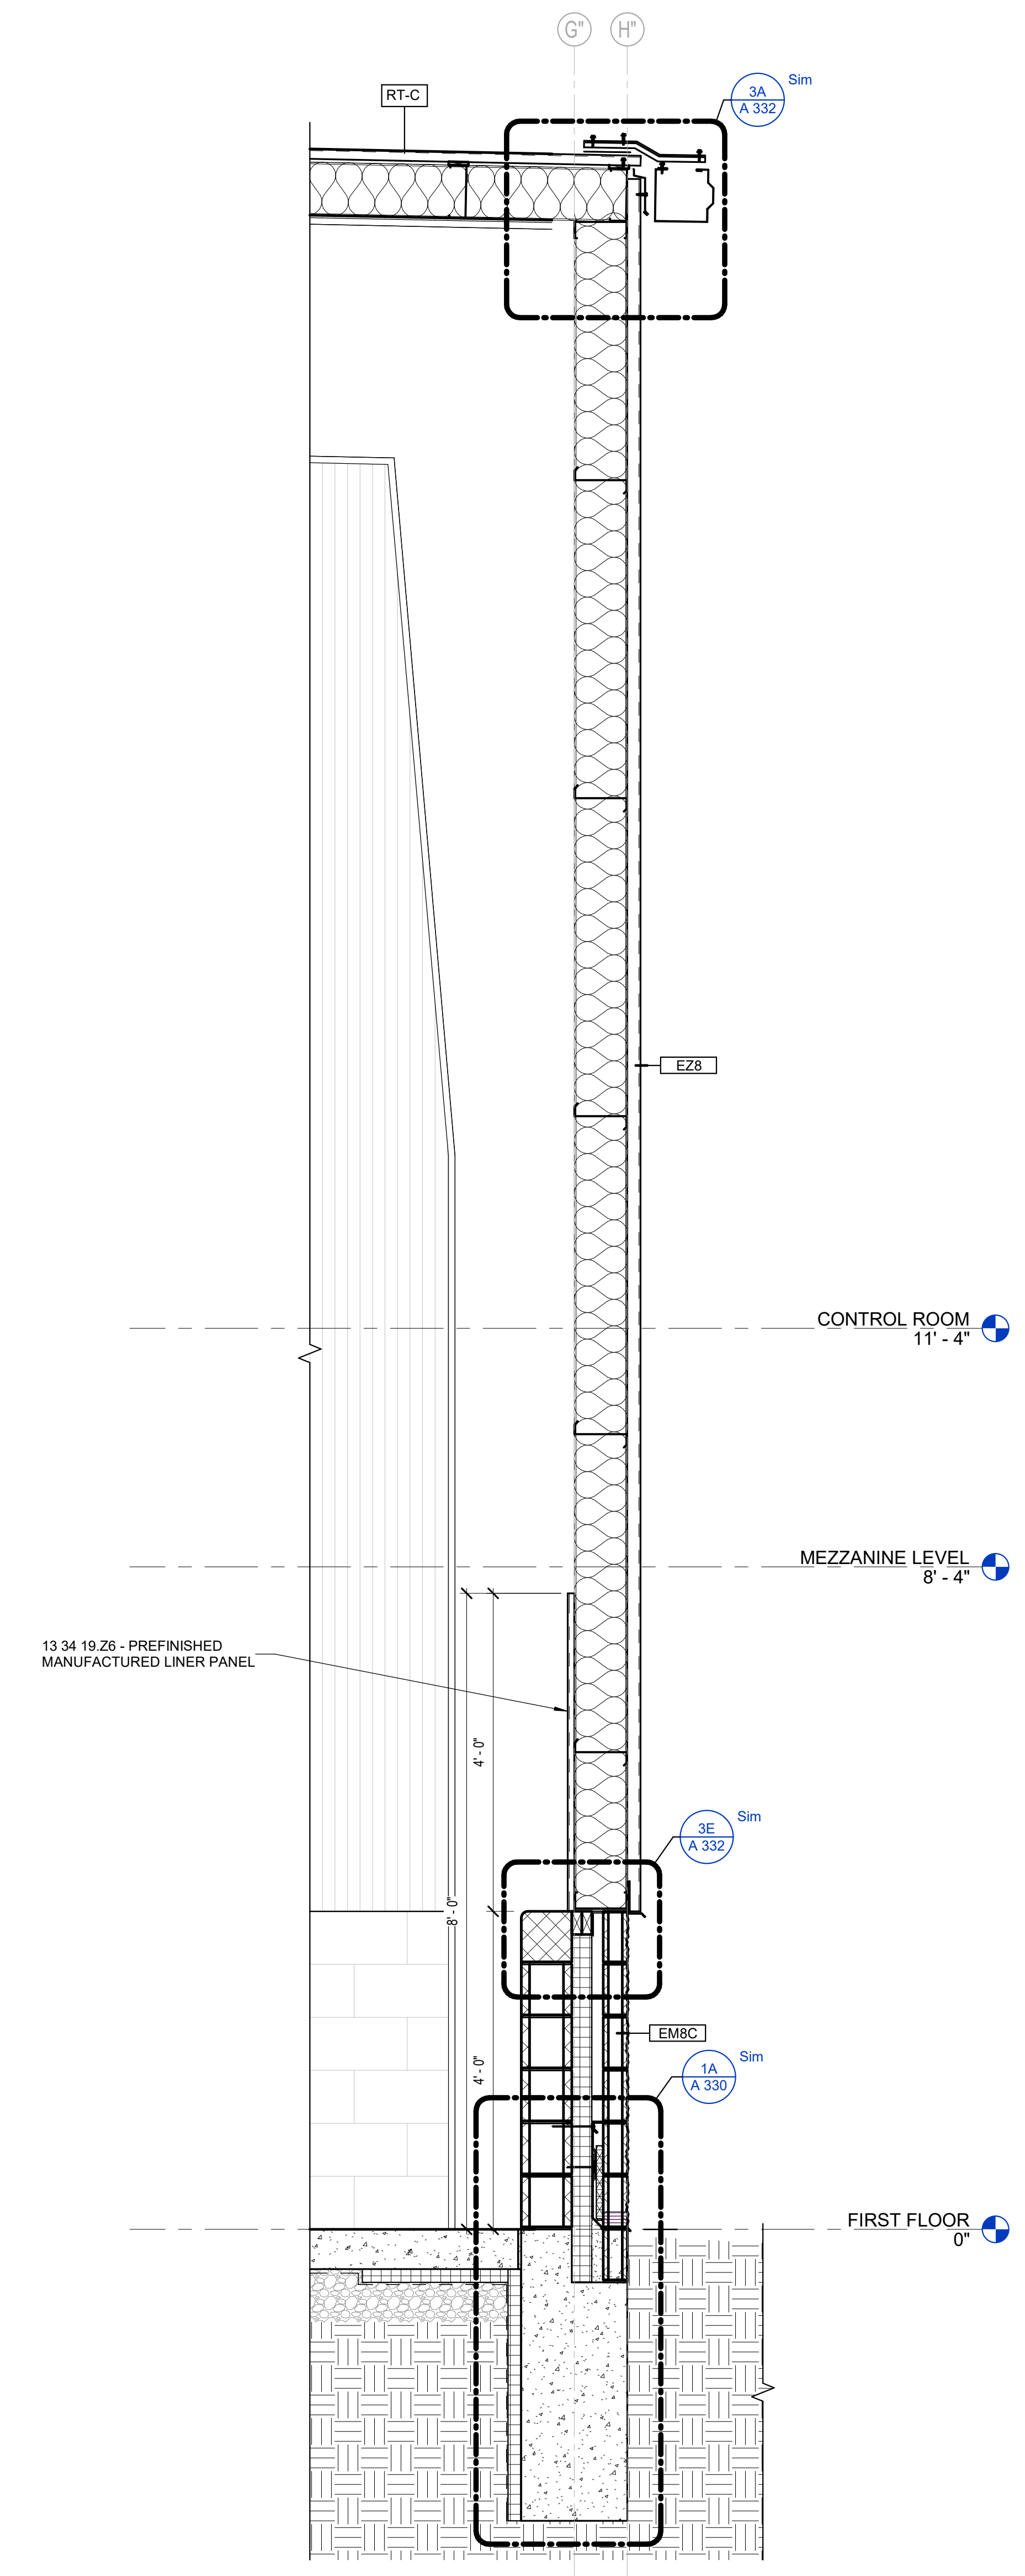



KNOX COUNTY BOARD OF COMMISSIONERS  
**KNOX COUNTY JUSTICE CAMPUS**

2375 OLD DECKER RD. VINCENNES, IN 47591

BID SET

#	Revision	Date
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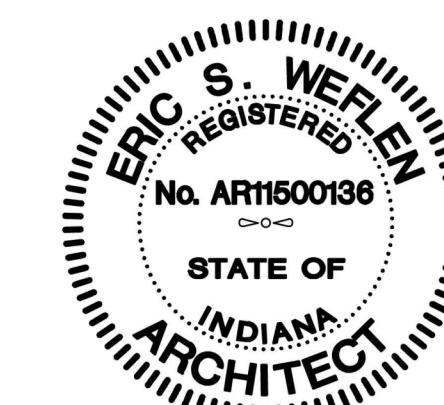
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Designed By: LD

Drawn By: CP


Checked By: LD/IV

Date: 02.04.2022




*Eric Welfen*

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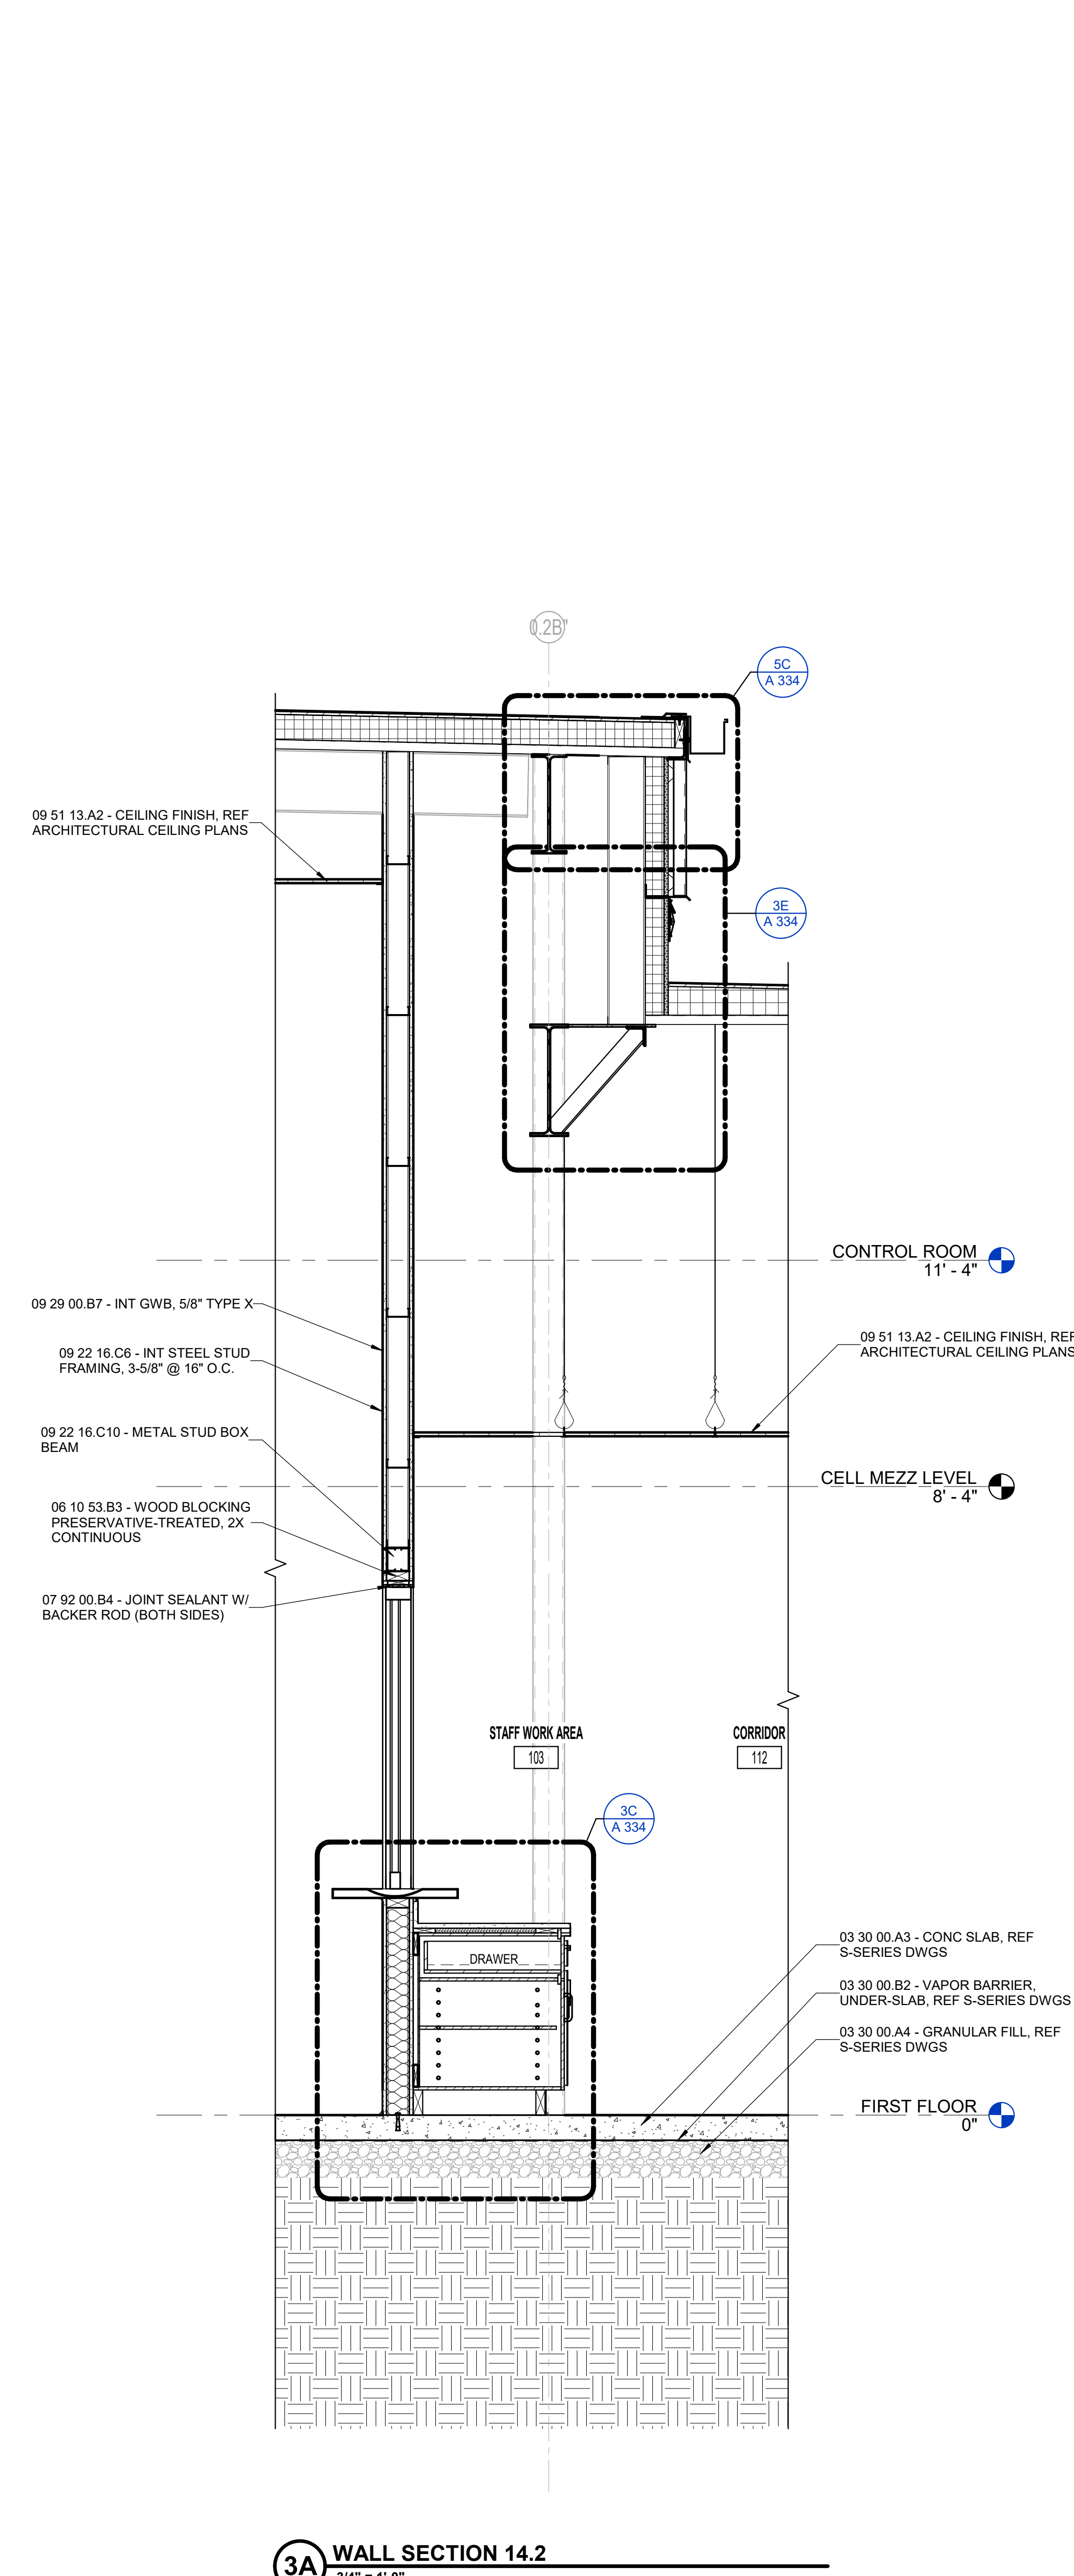


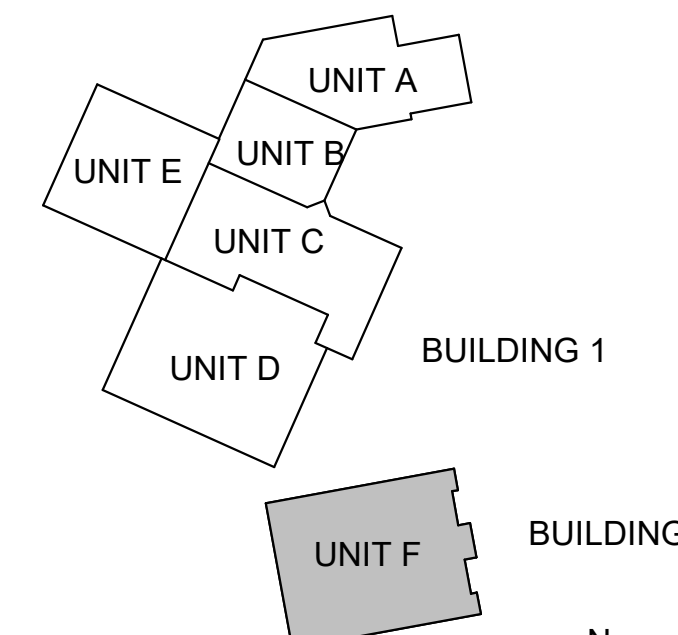WALL SECTIONS & DETAILS


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**1A** WALL SECTION 14.3  
3/4\"/>

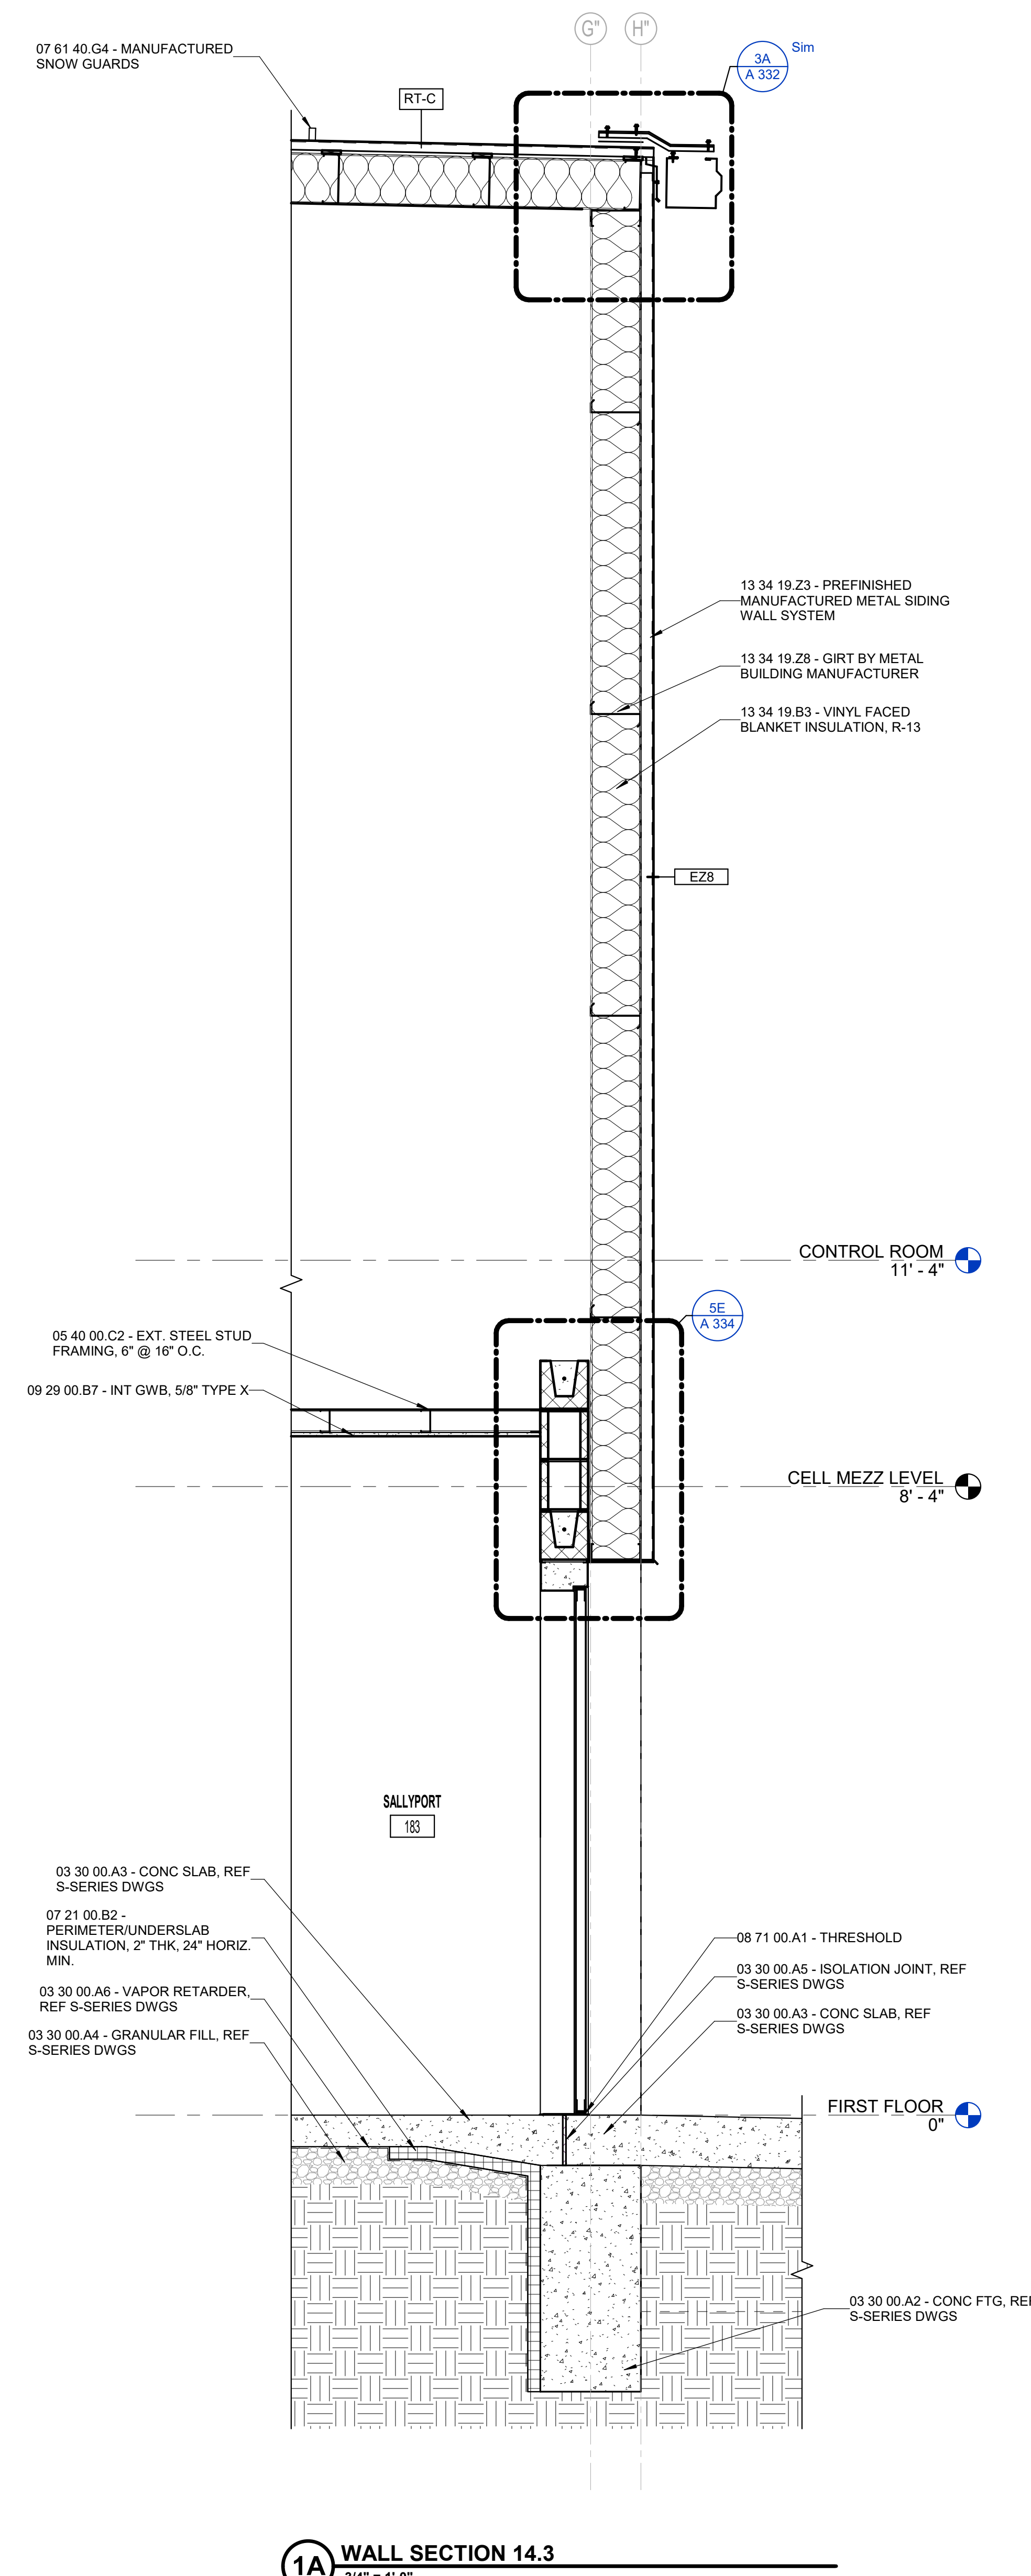


**3A** WALL SECTION 14.2  
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**5A** WALL SECTION 14.1  
3/4\"/>



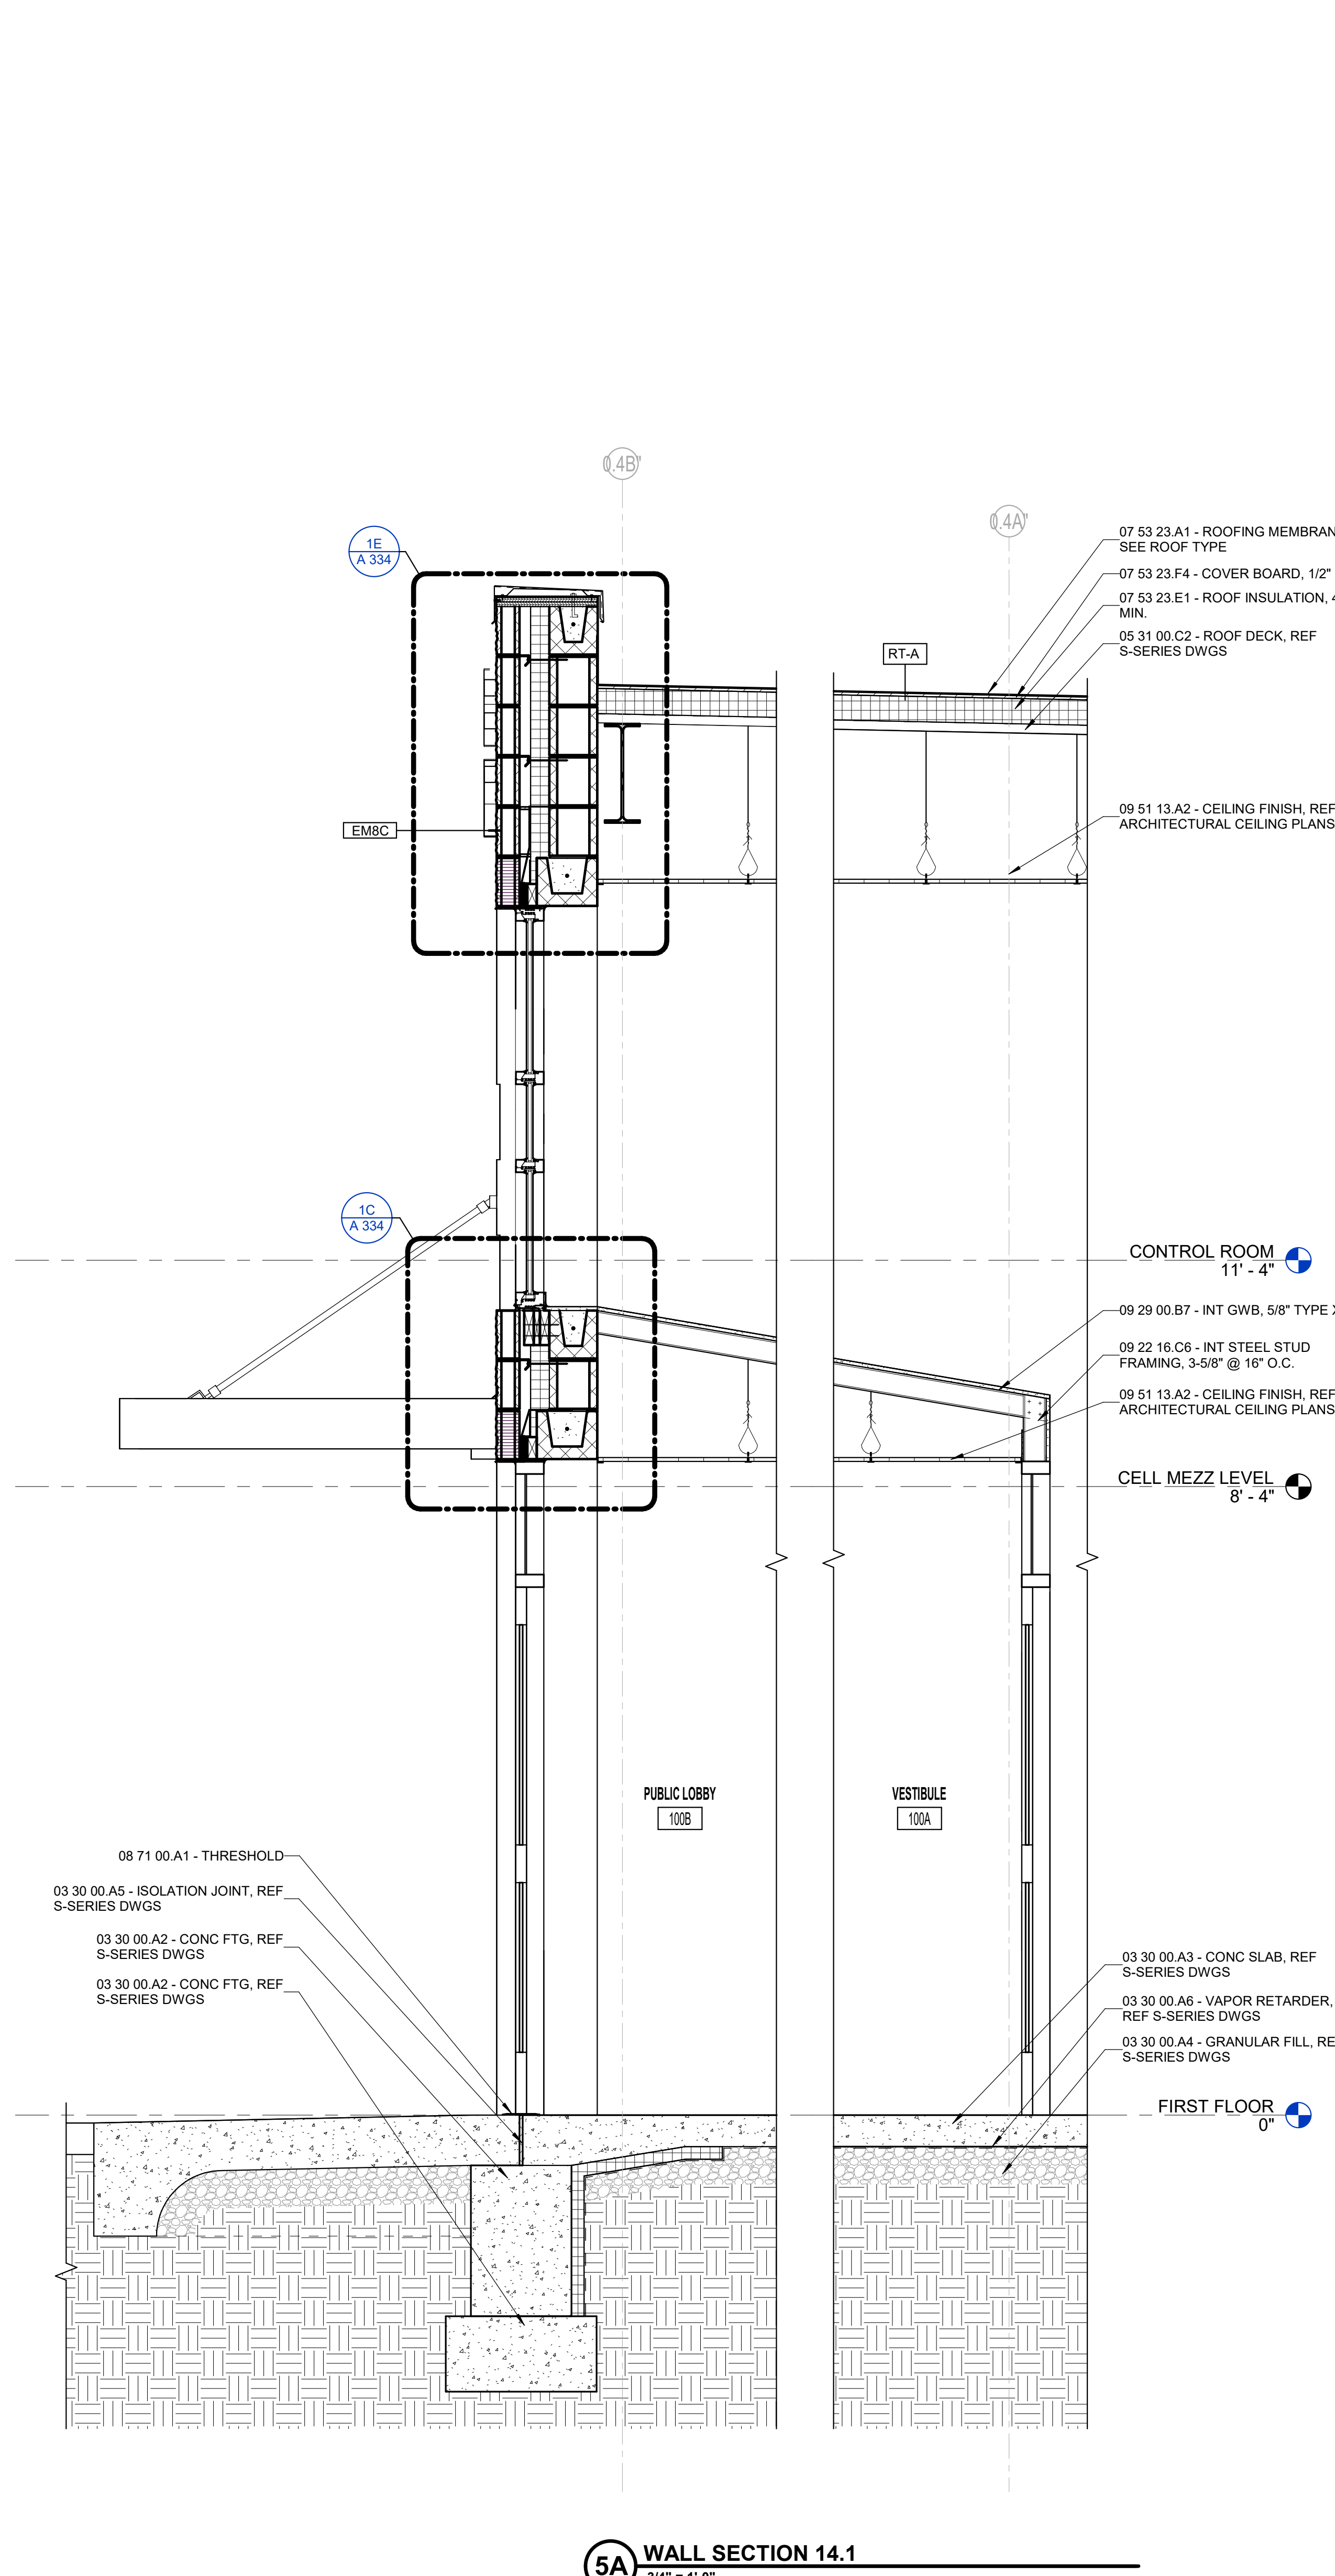


#	Revision	Date
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Project #: 20-700-151-2  
Designed By: LD/SP  
Drawn By: CP  
Checked By: CP  
Date: 02.04.2022

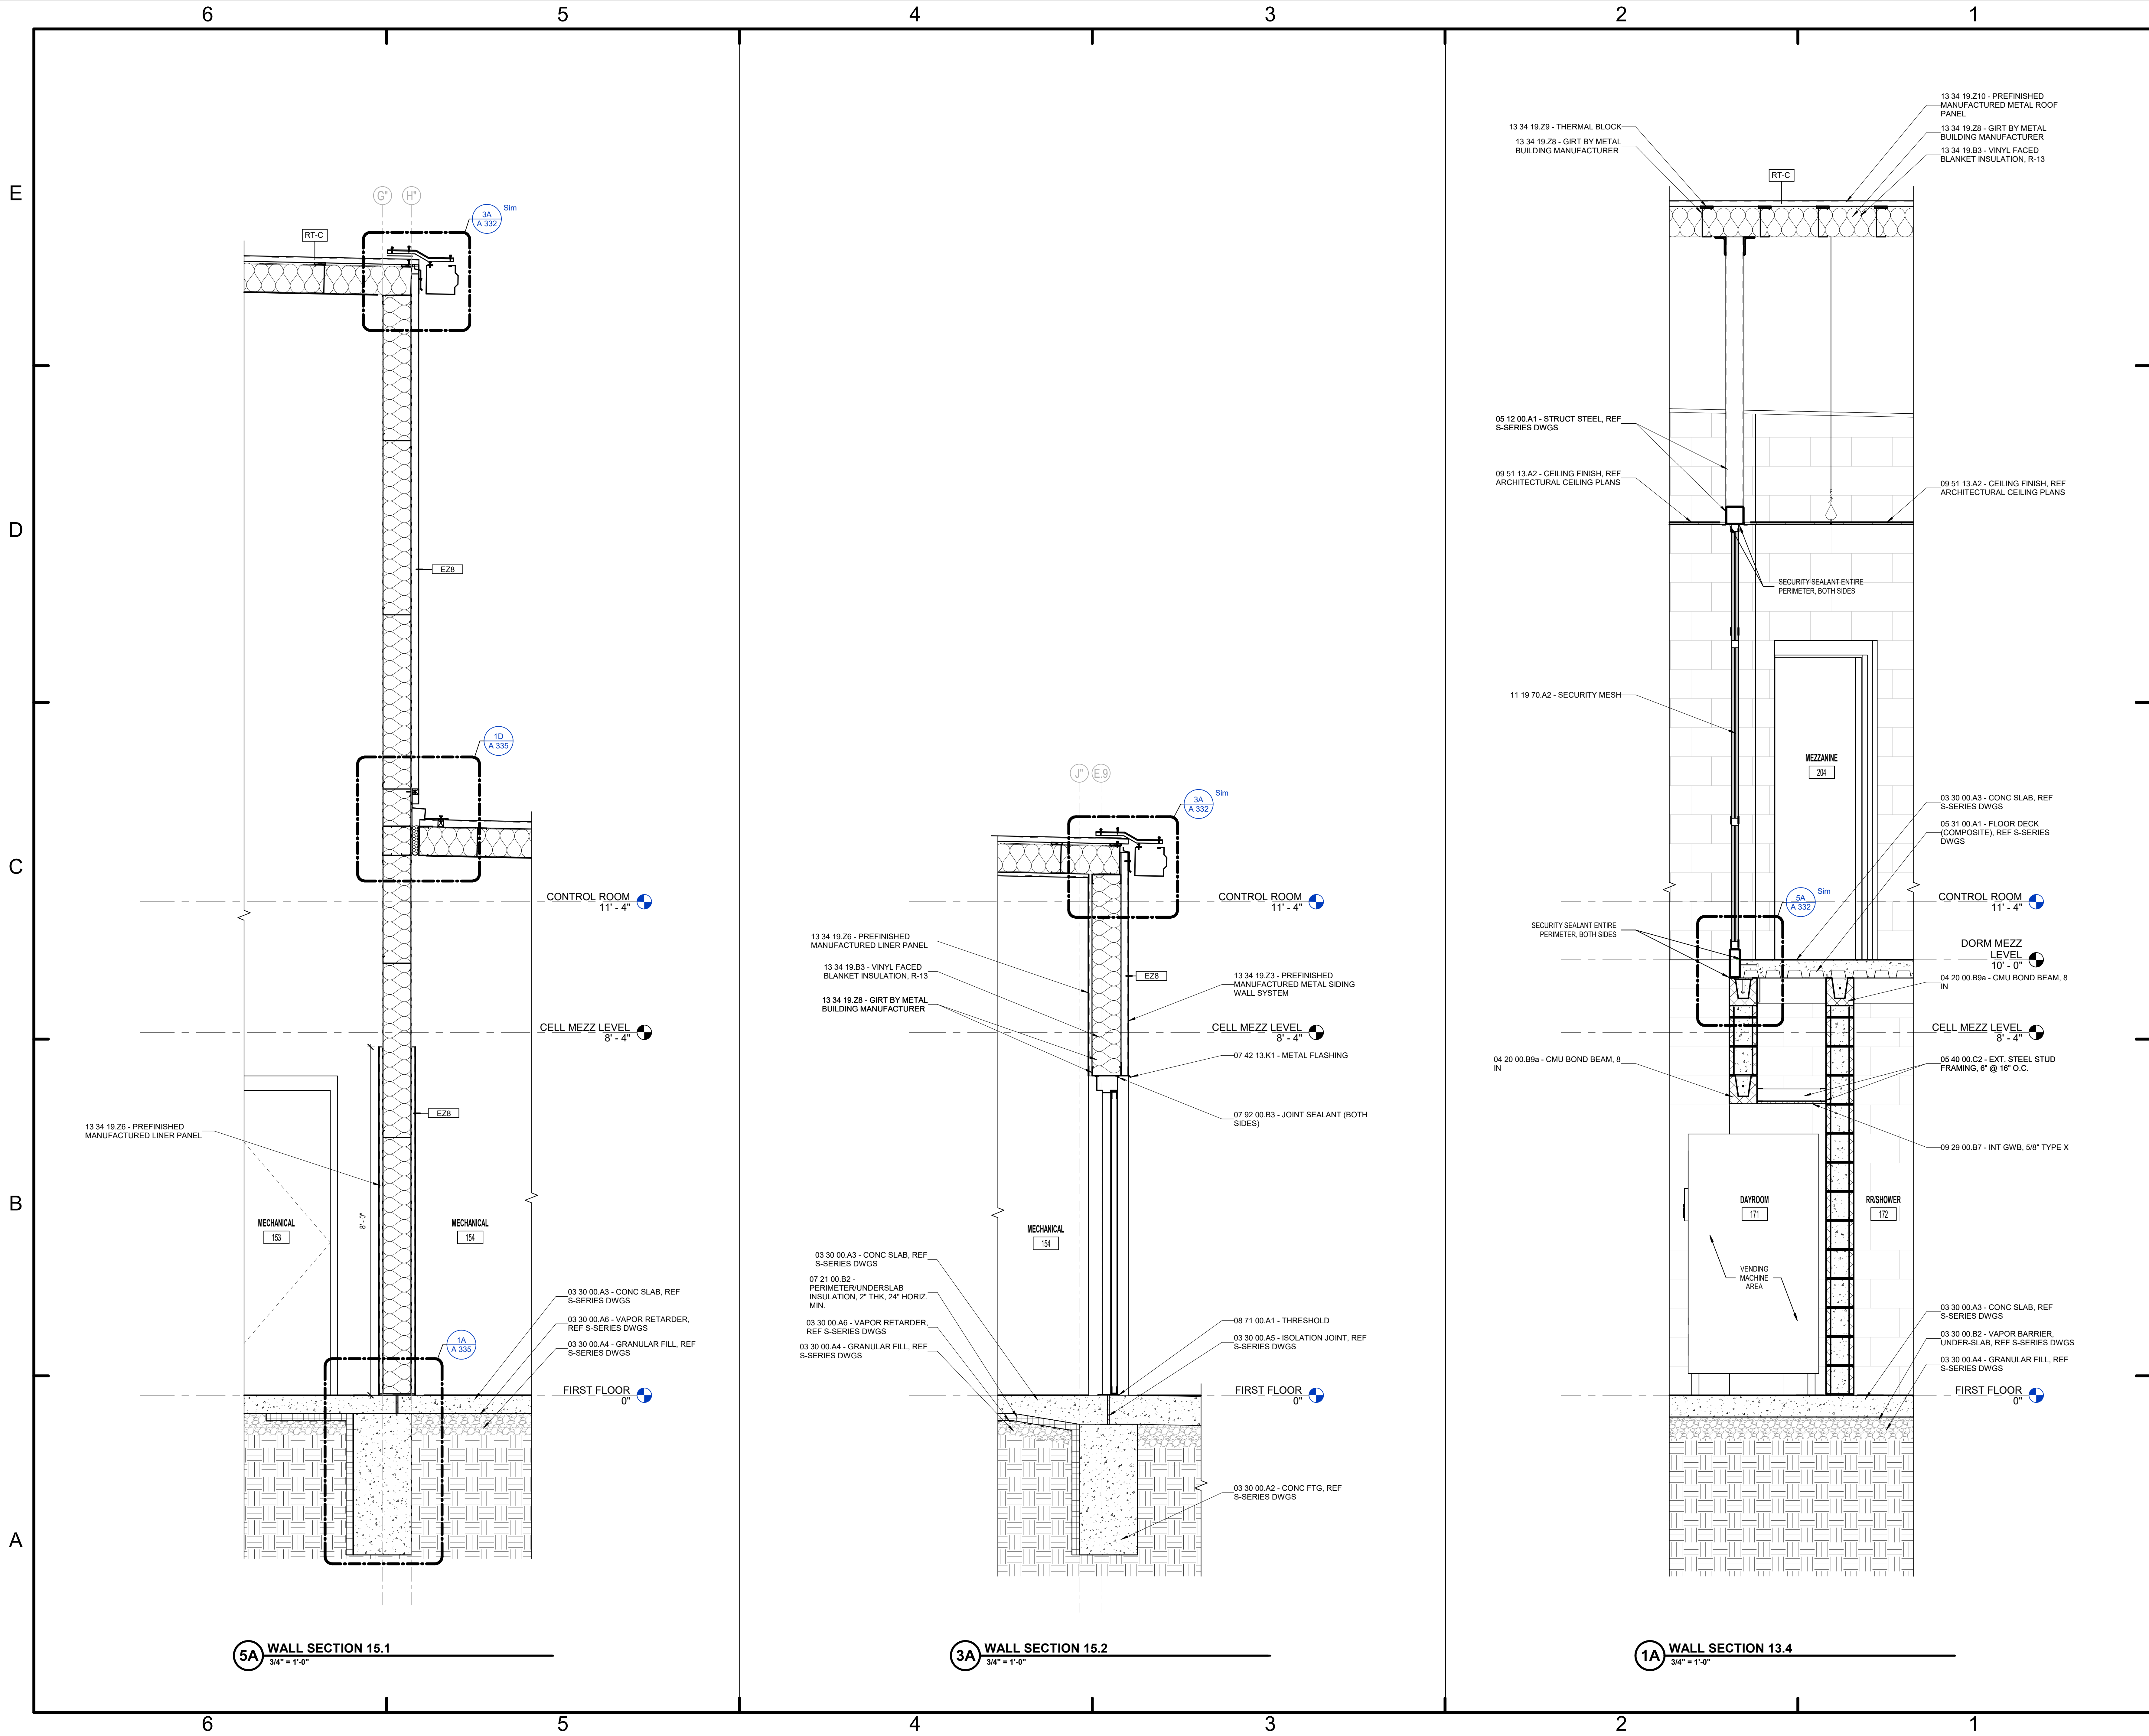

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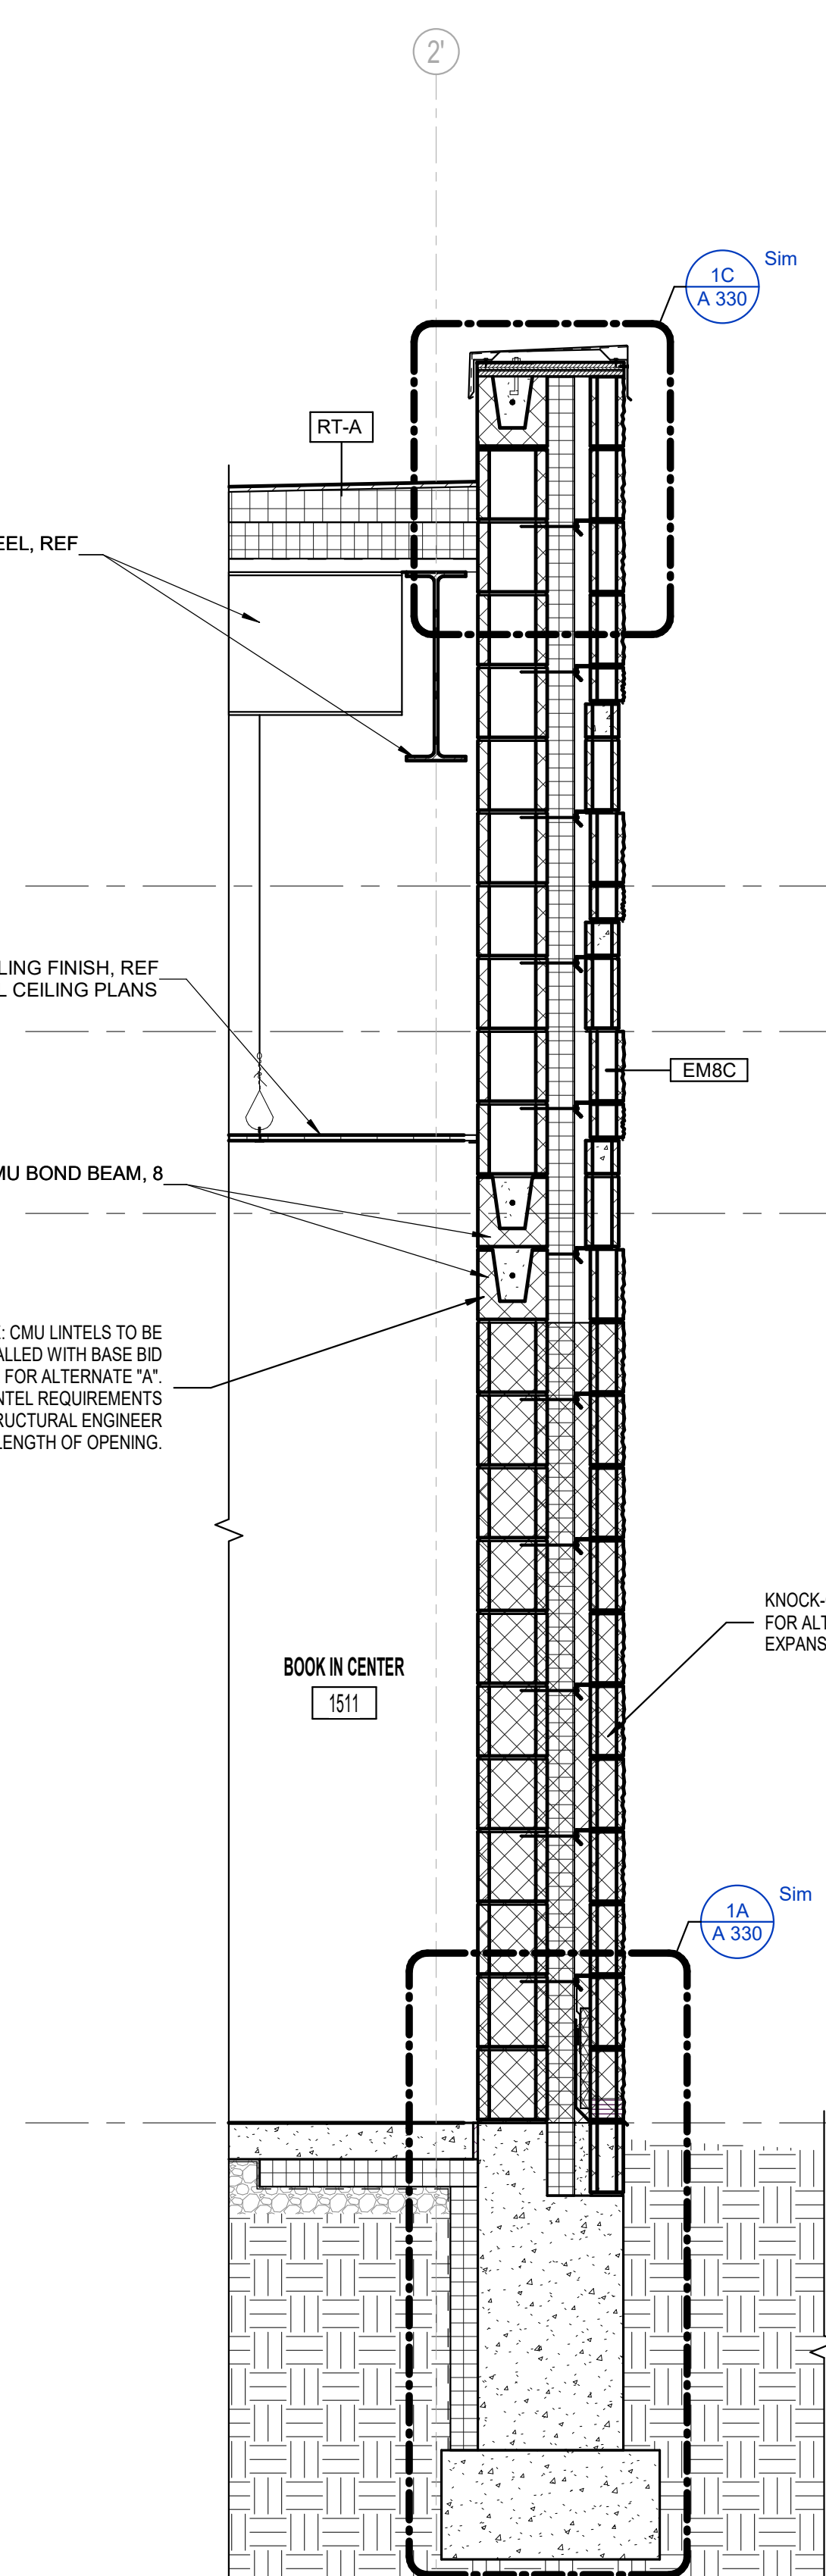
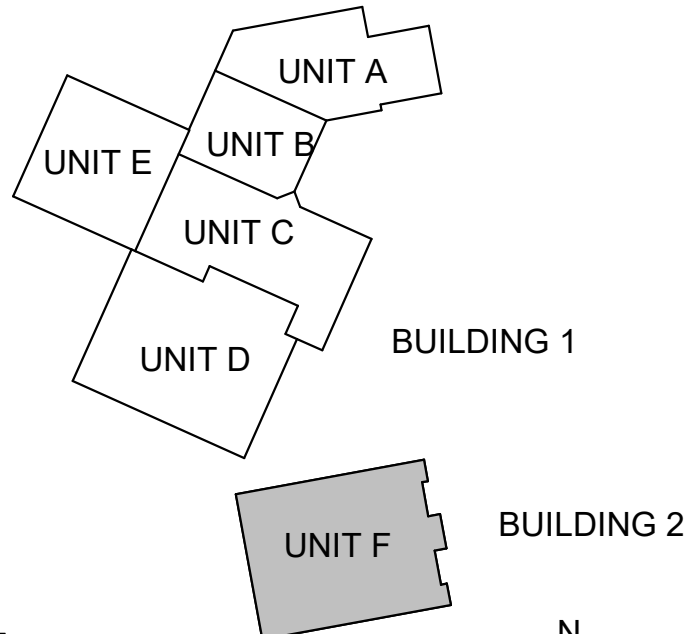


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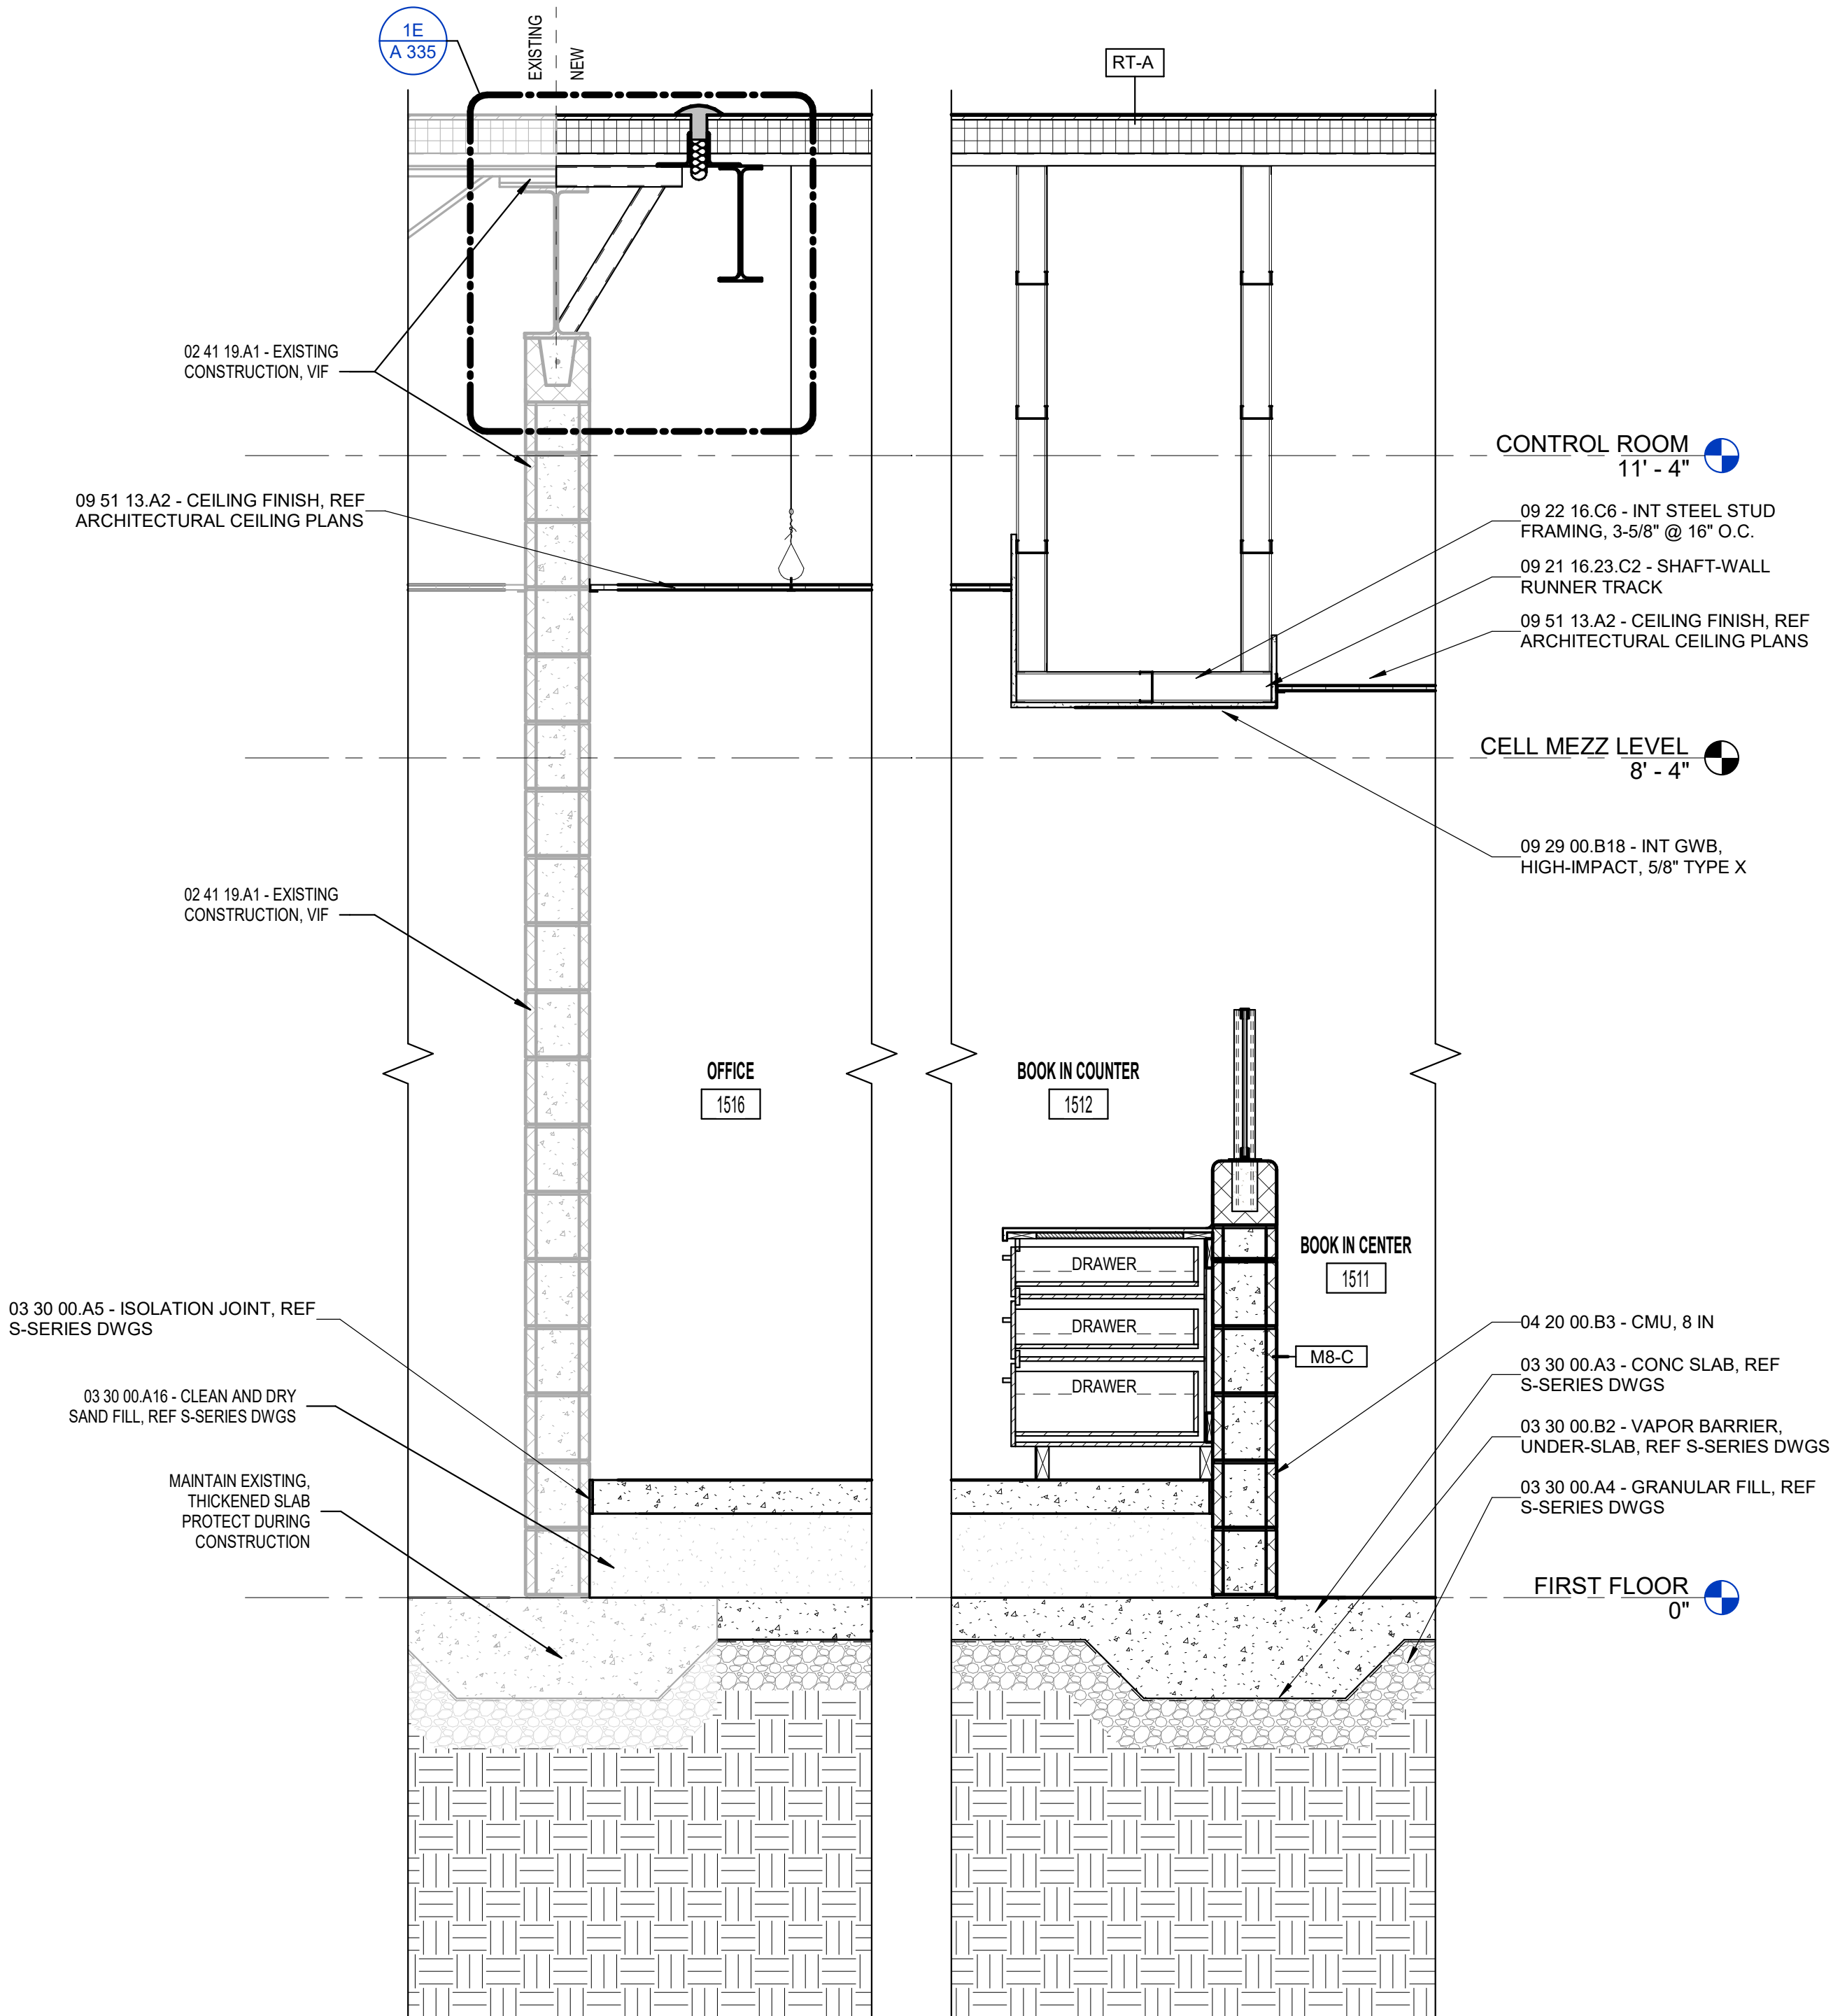
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Designed By: LD  
Drawn By: CP  
Checked By: LD/IV  
Date: 02.04.2022

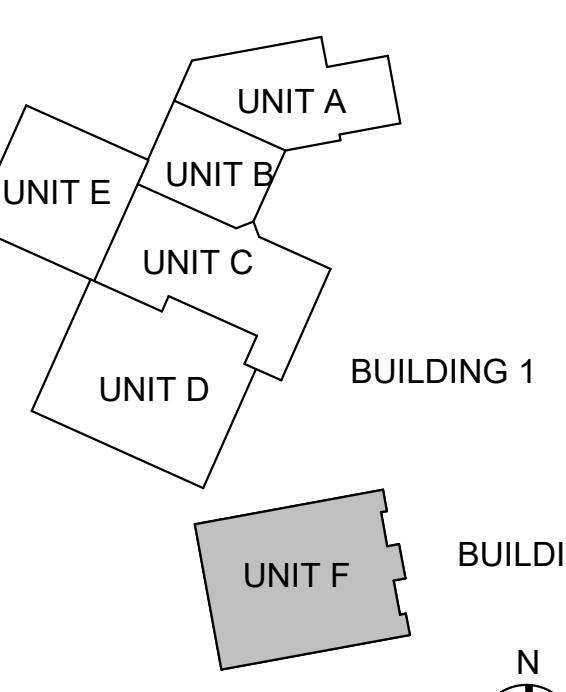


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5A BOOK-IN CENTER WALL SECTION 2  
3/4" = 1'-0"




3A BOOK-IN CENTER WALL SECTION 1  
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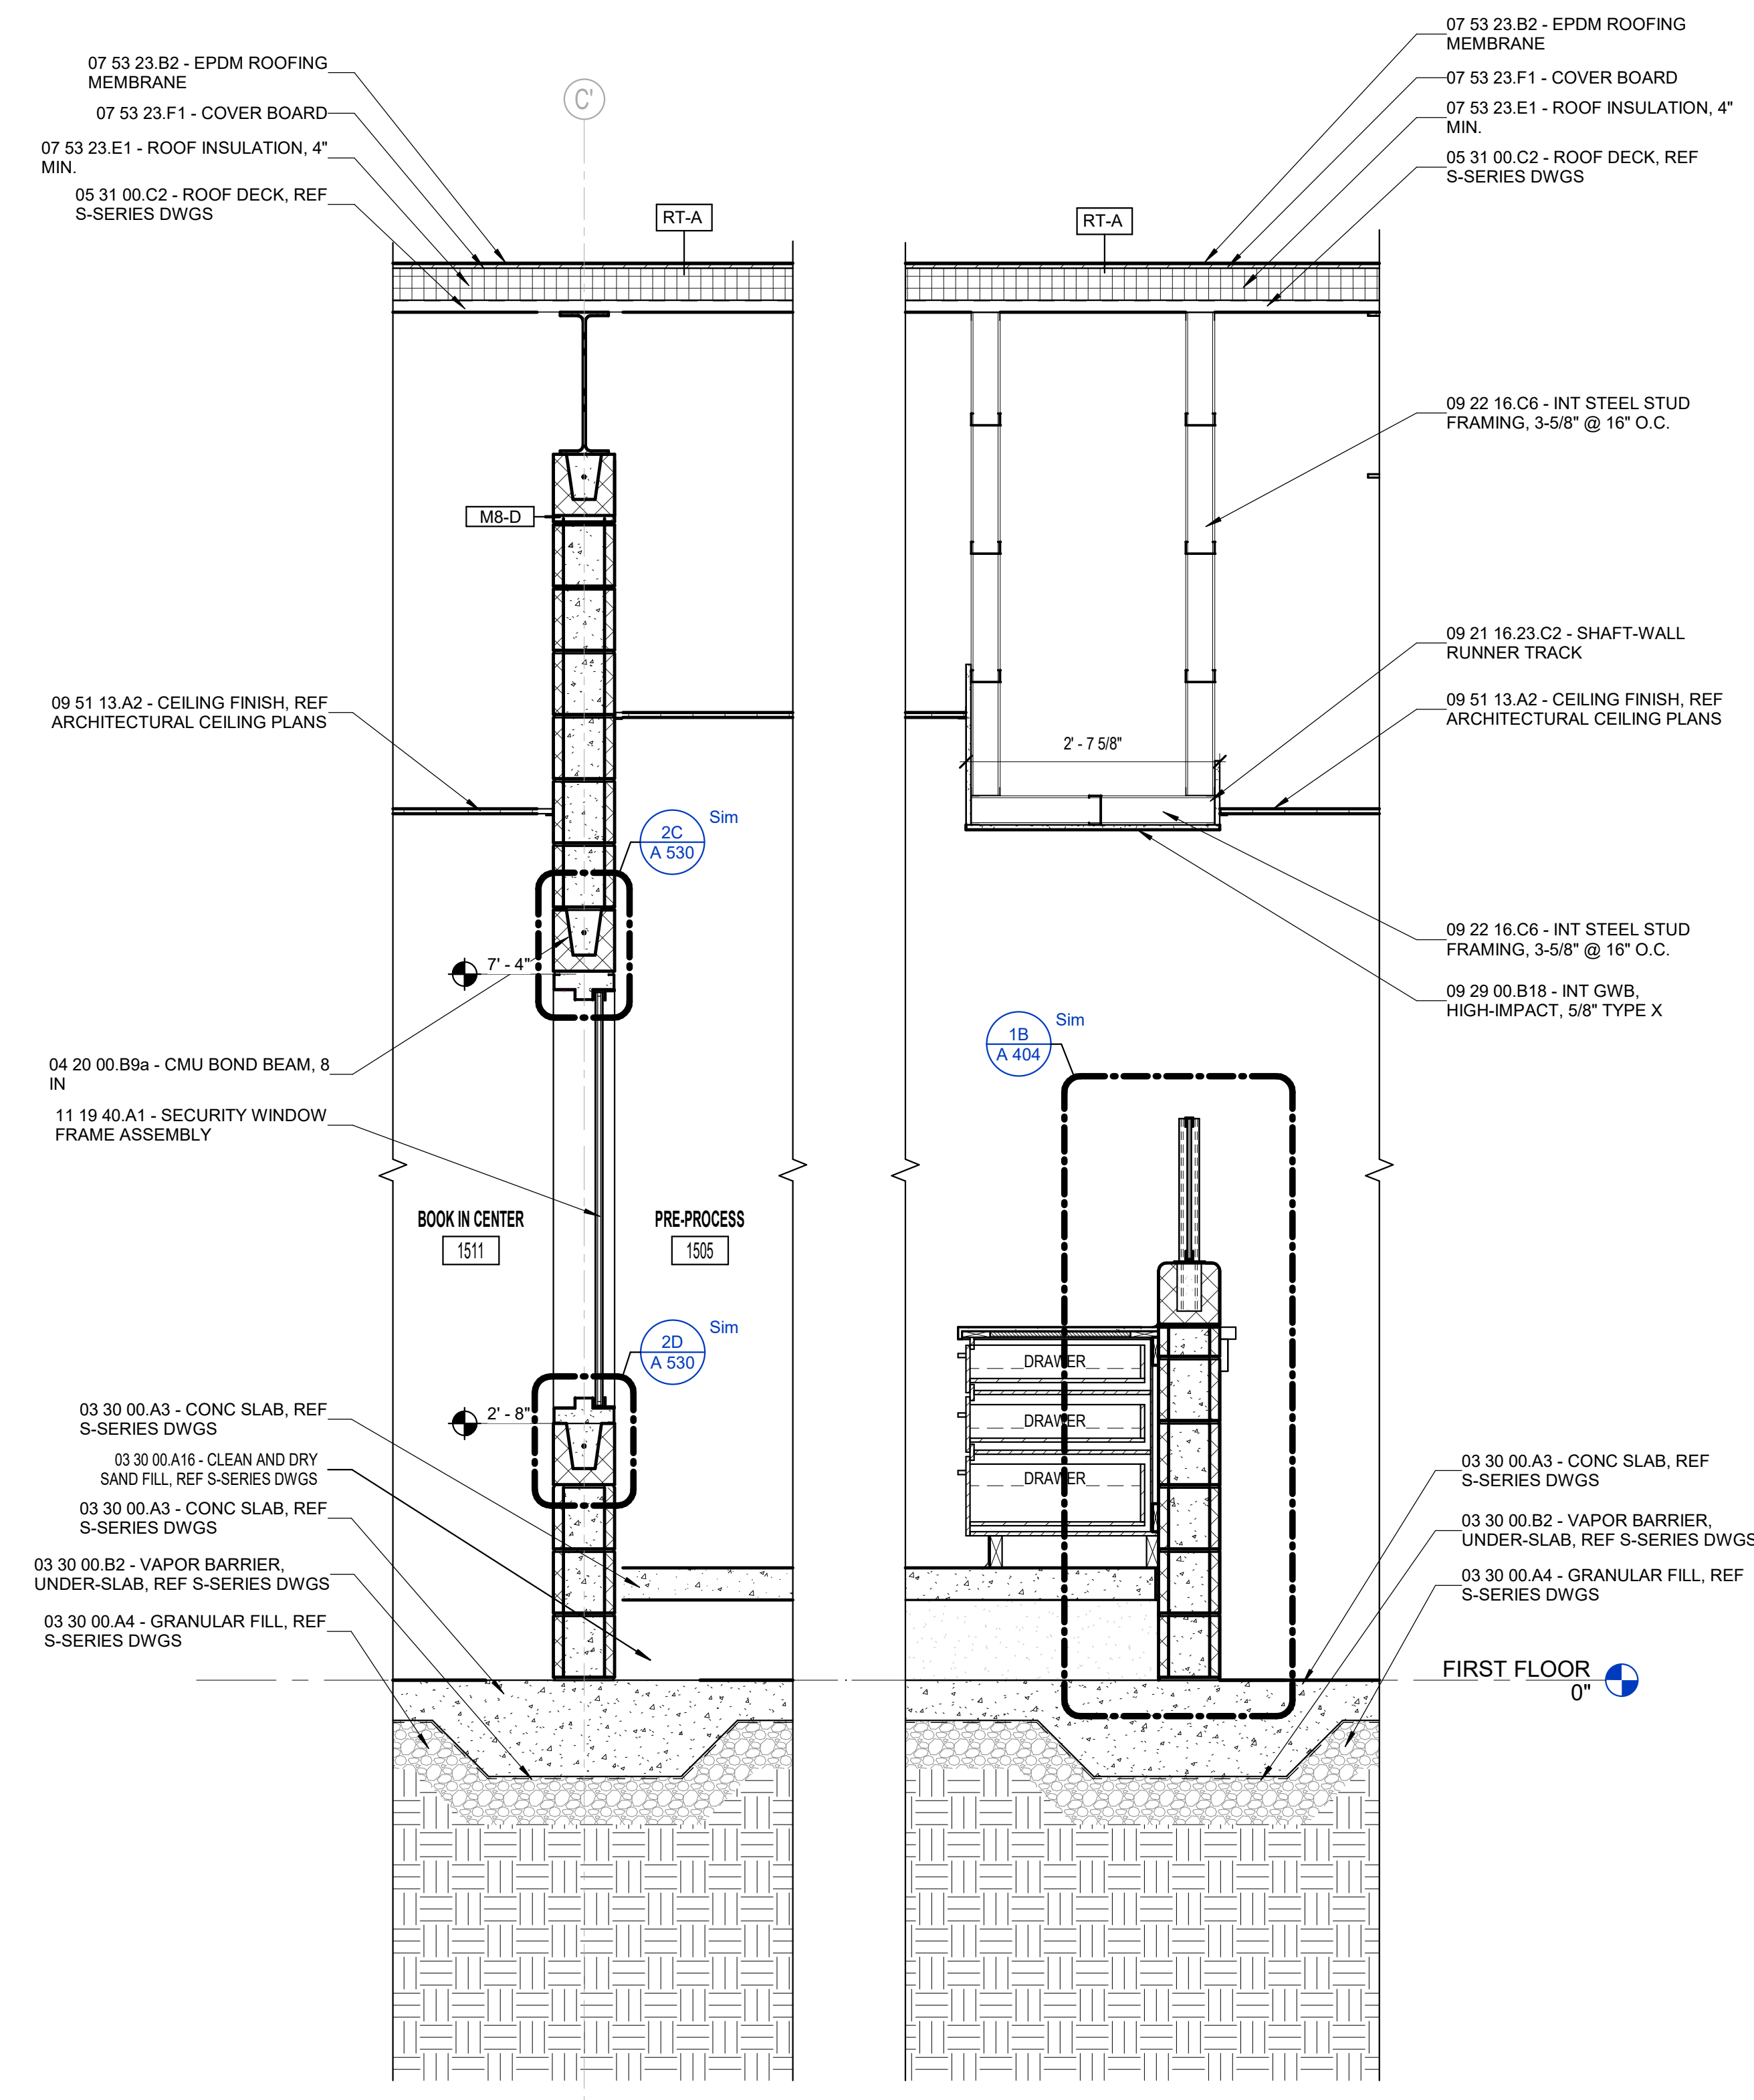


1A WALL SECTION KITCHEN/STORAGE 1533  
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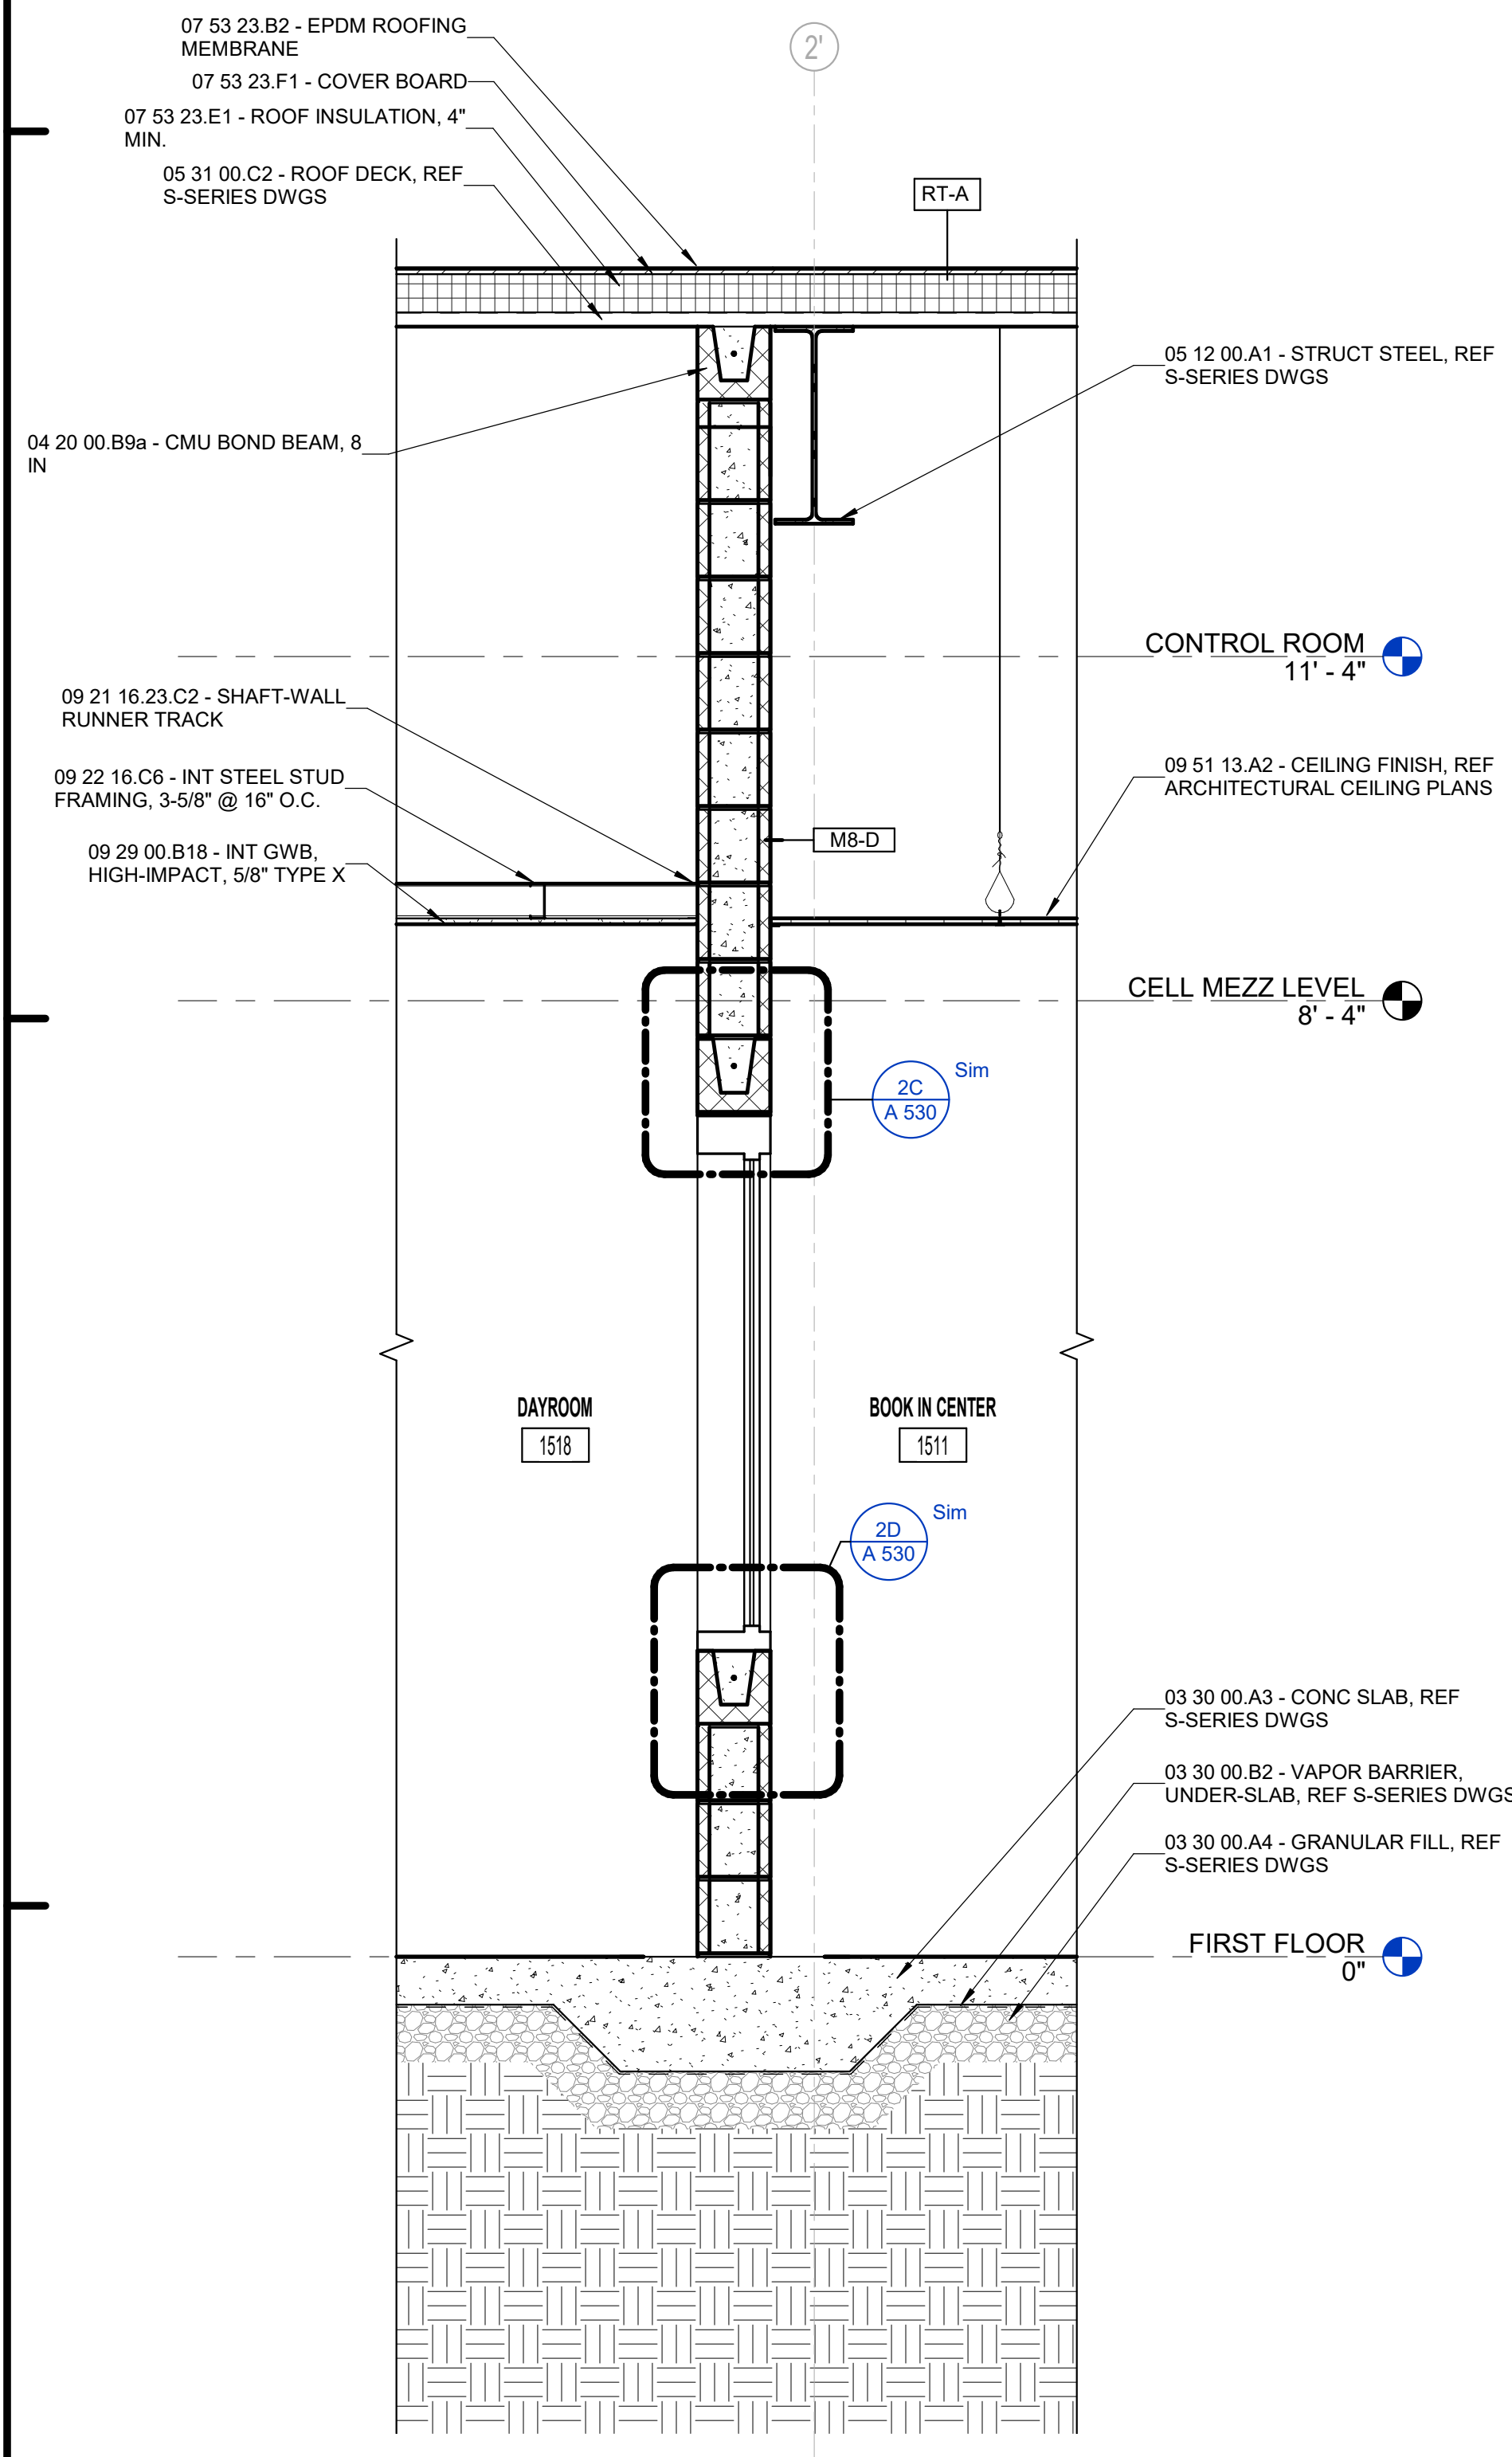


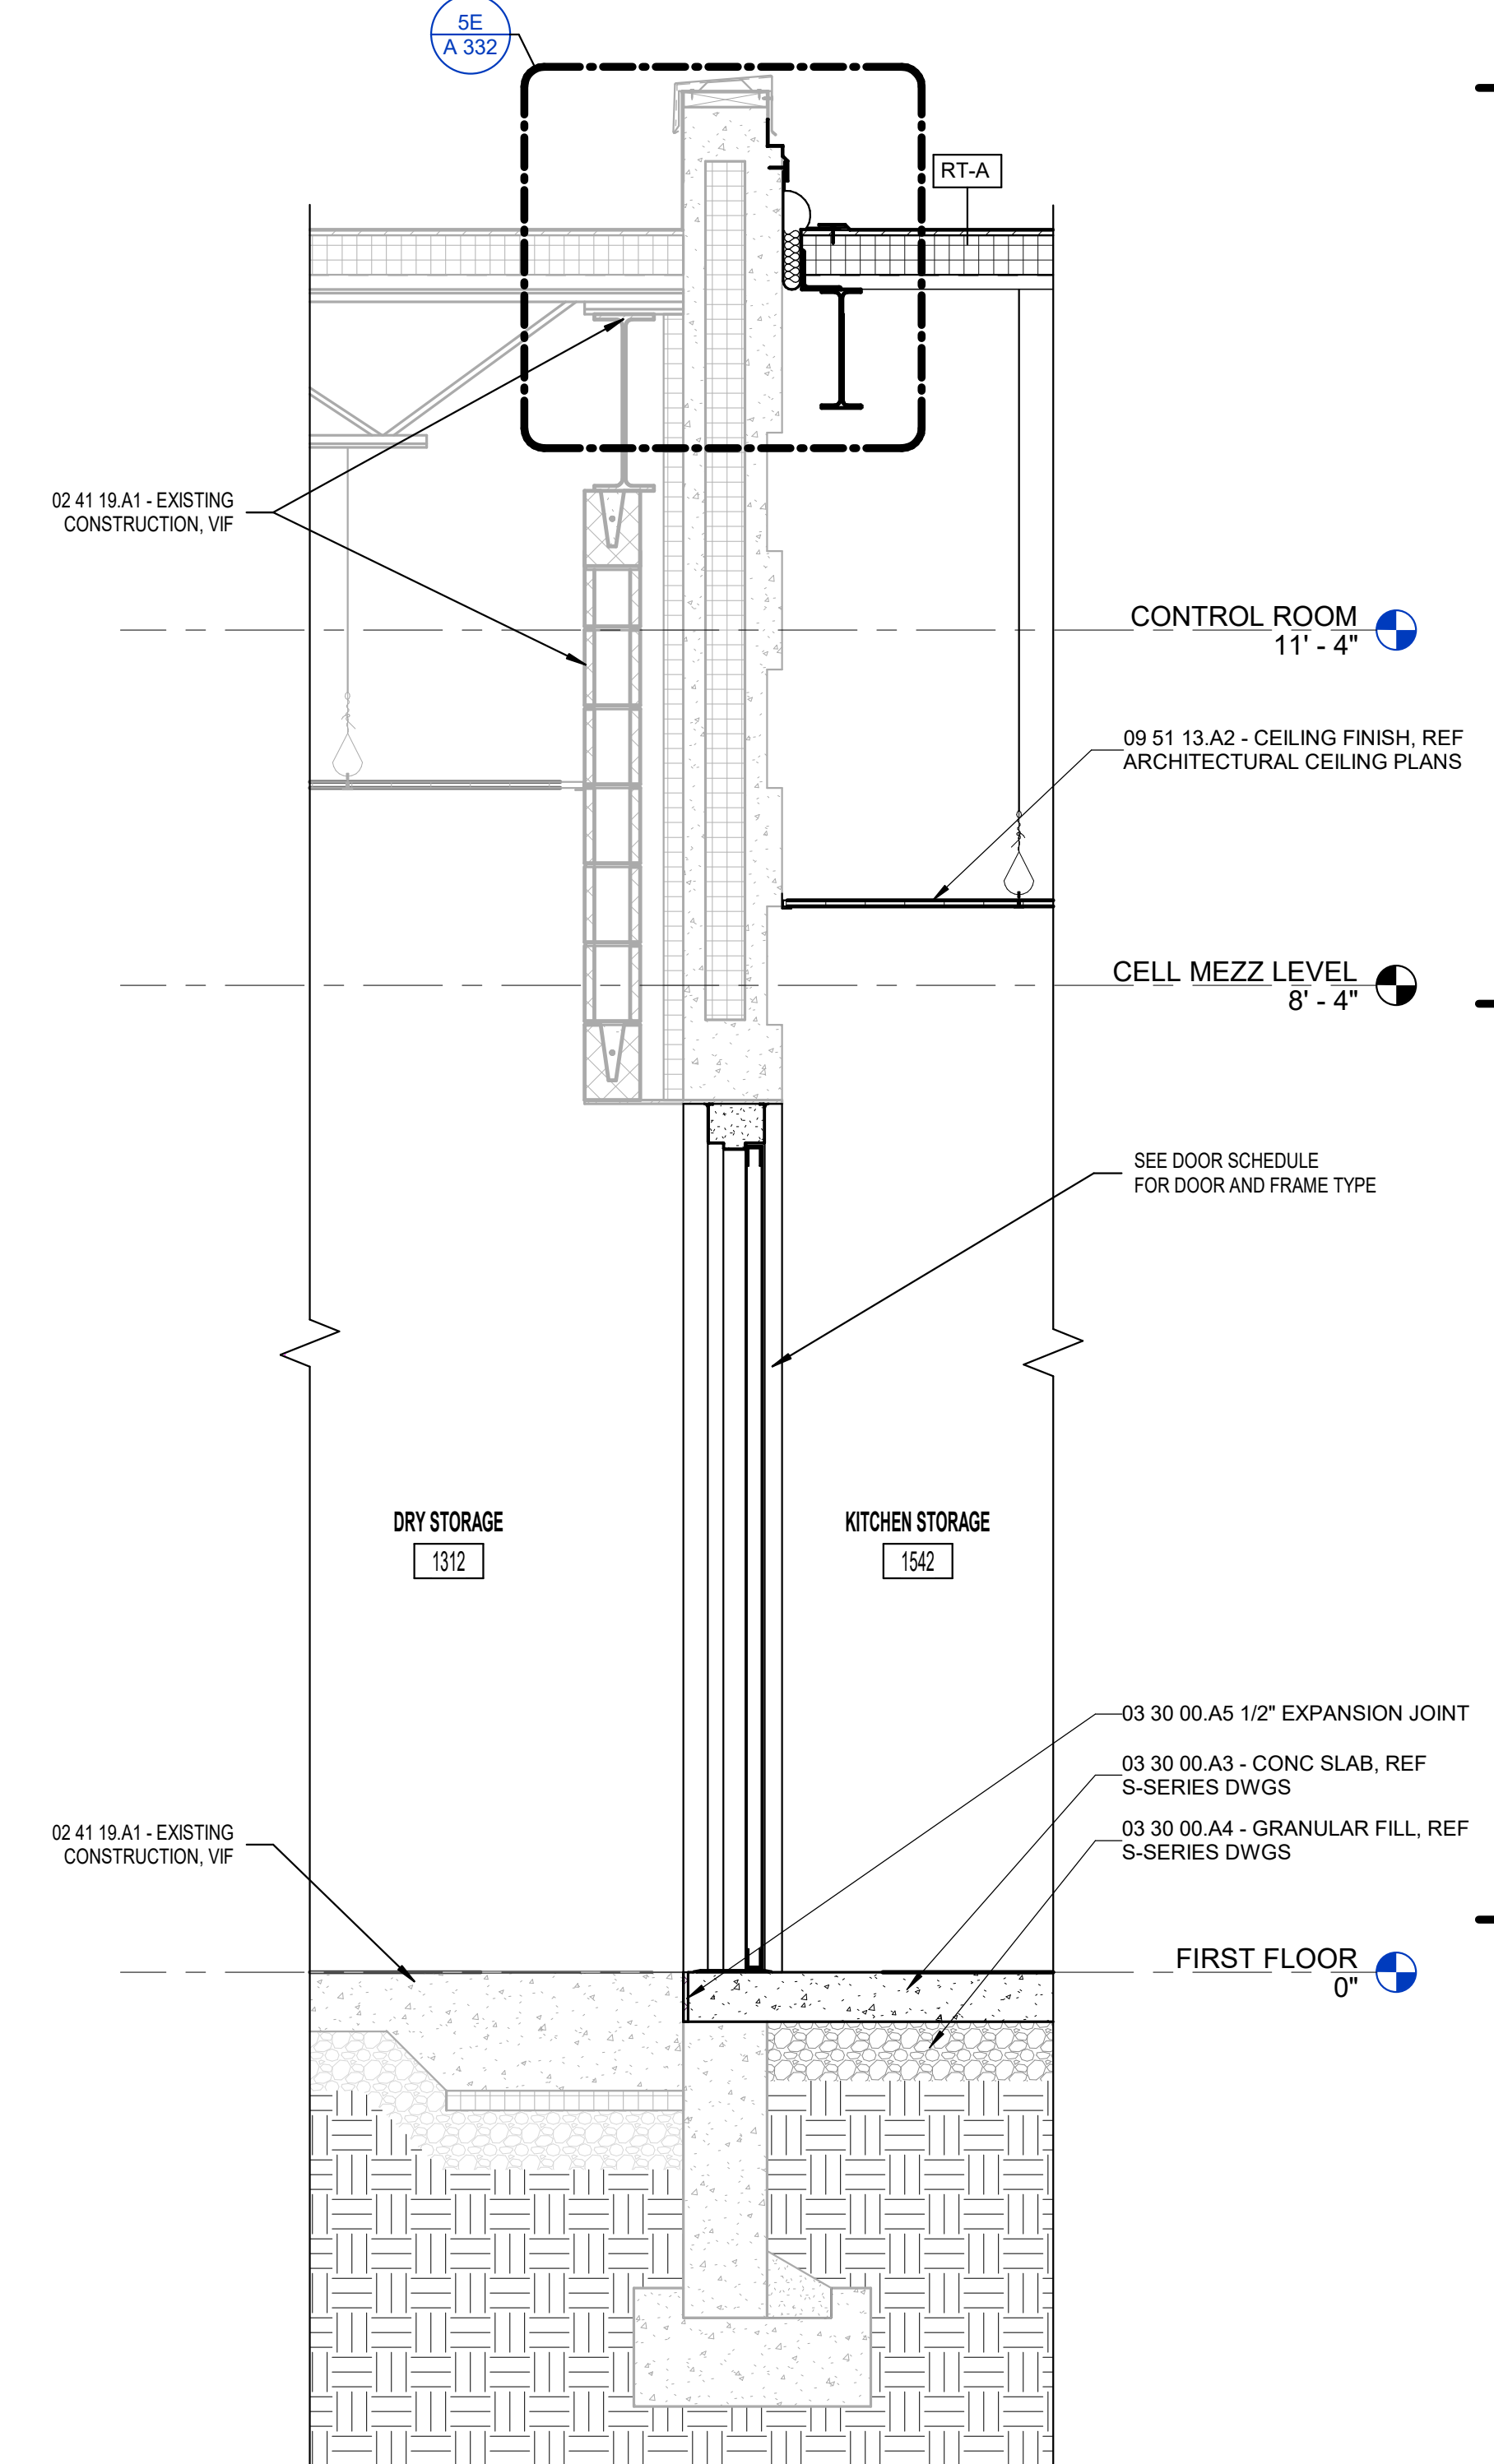

1A ENTRY CANOPY WALL SECTION  
3/4" = 1'-0"

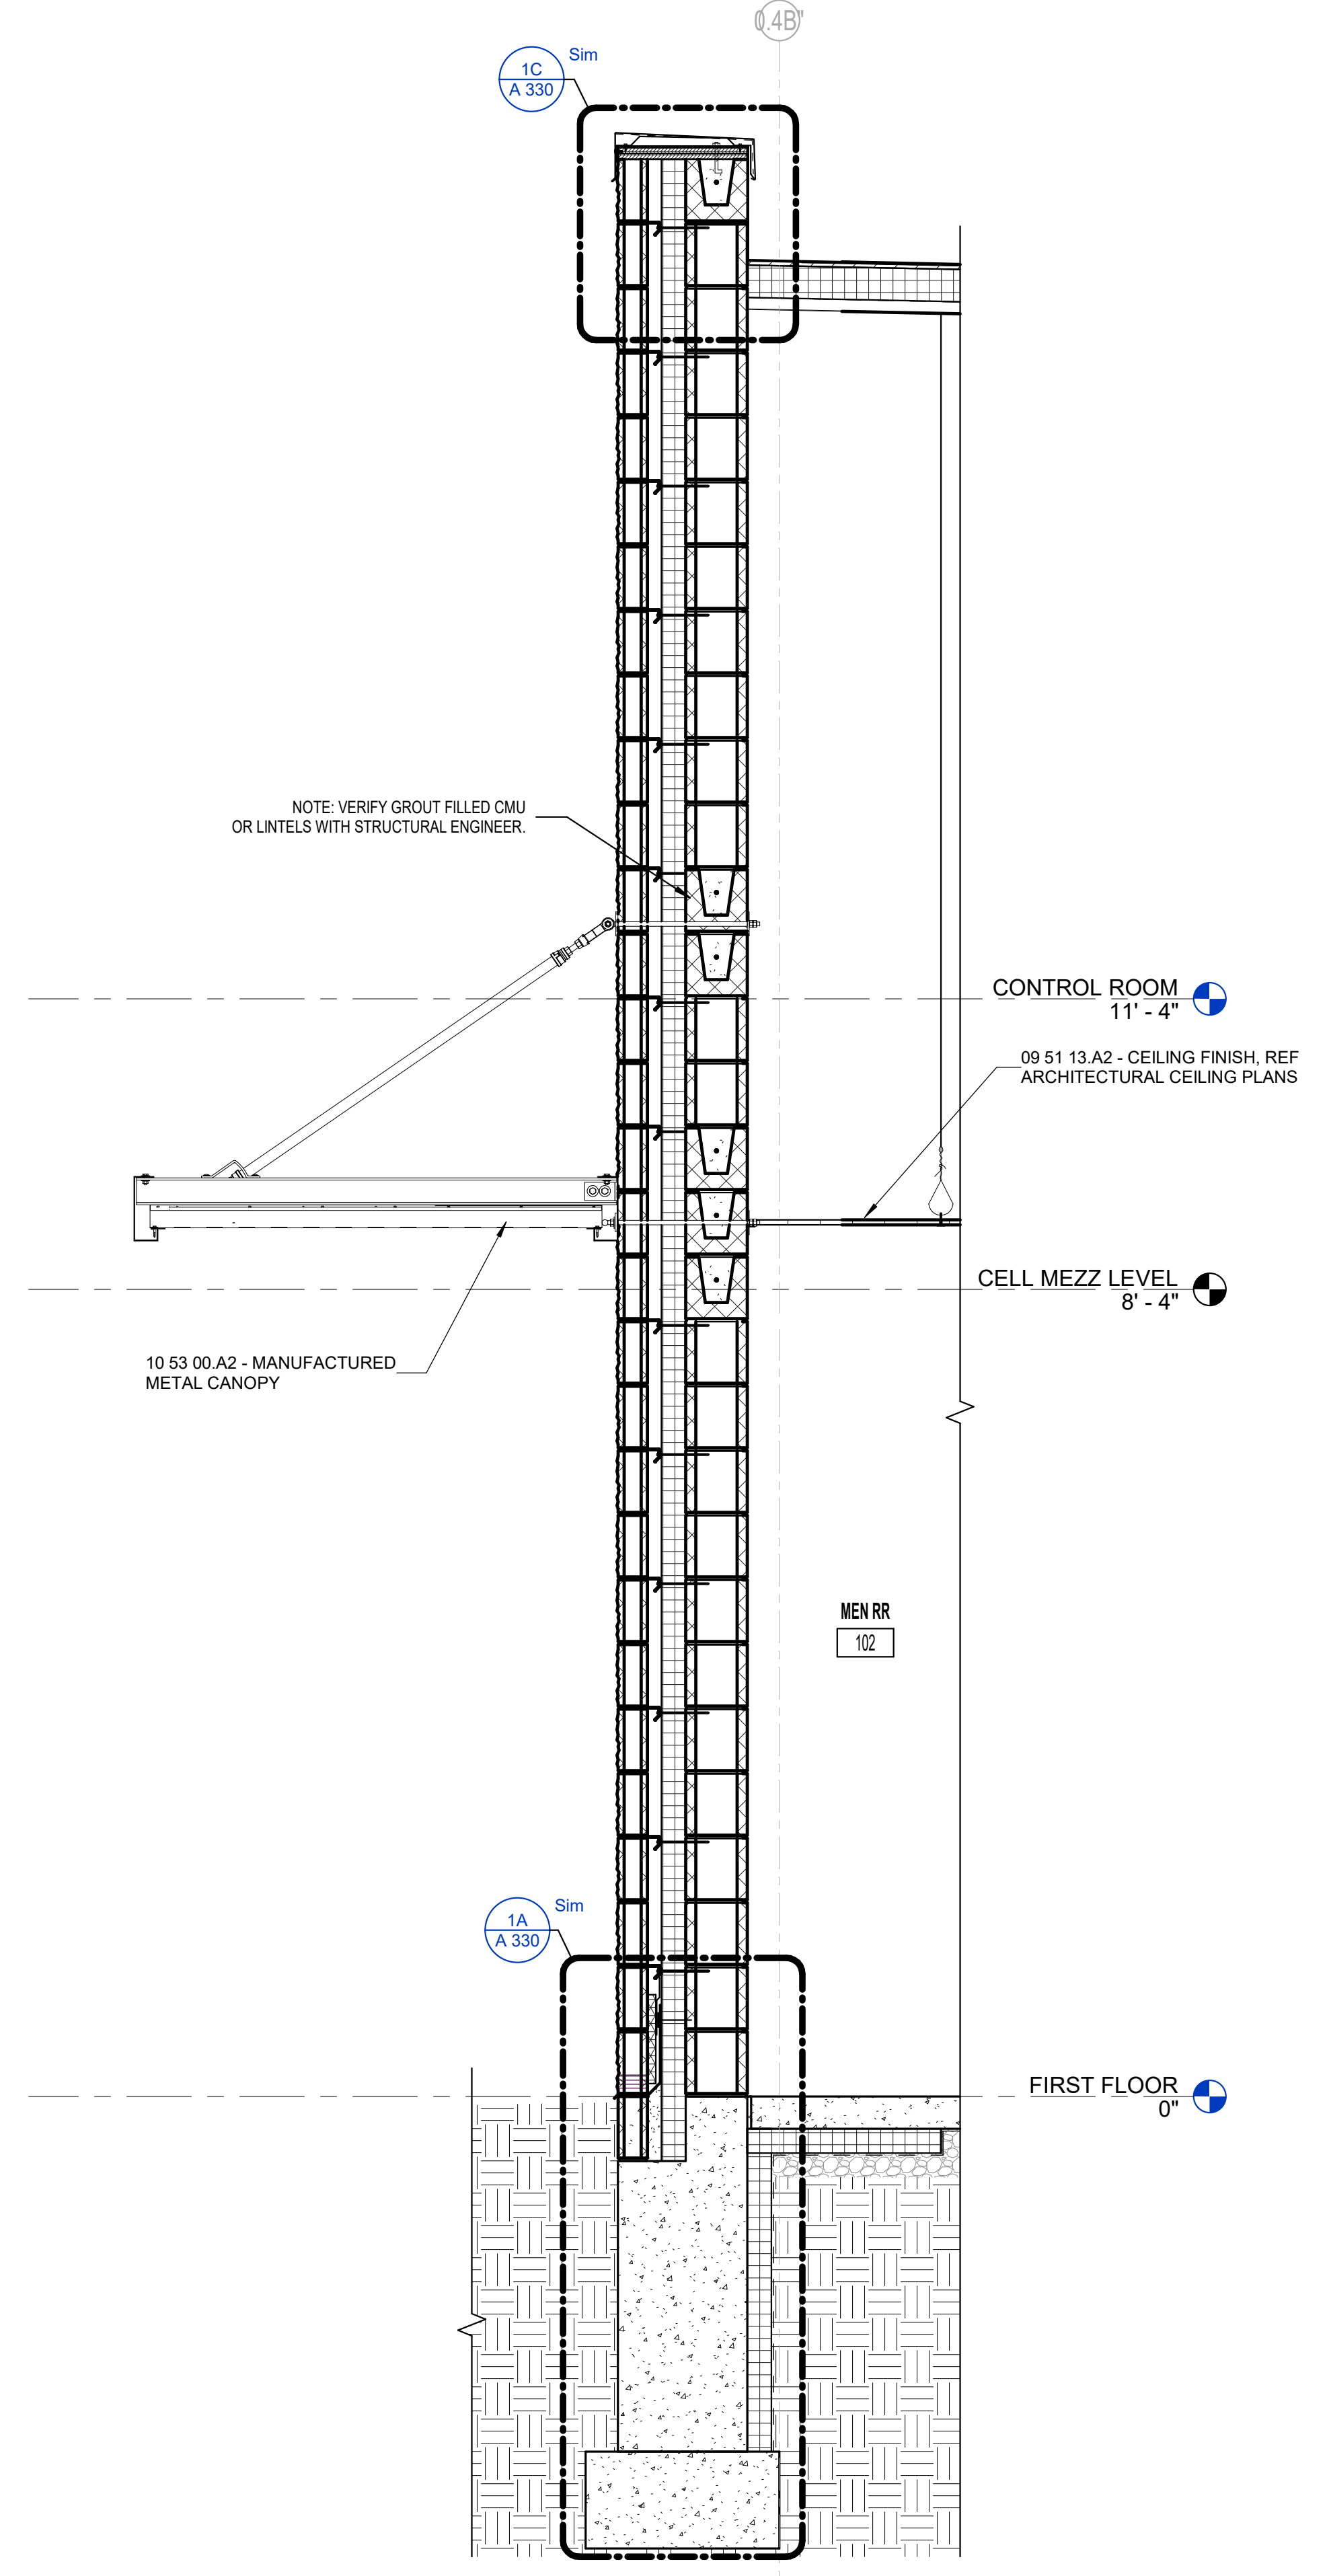

3A PRE-PROCESS 1505 WALL SECTION  
3/4" = 1'-0"



5A DAYROOM 1518 WALL SECTION  
3/4" = 1'-0"



Project #: 20-700-151-2

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Designed By: JW

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Drawn By: JW

---

Checked By: LD

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Date: 02.04.2022



The diagram shows two buildings, Building 1 and Building 2, with their respective units. Building 1 is a larger structure containing five units: Unit A, Unit B, Unit C, Unit D, and Unit E. Building 2 is a smaller structure containing one unit: Unit F. The units are arranged in a staggered grid pattern, with Building 1 units generally to the left and Building 2 units to the right. A north arrow is located at the bottom right of the diagram.





#	Revision	Date
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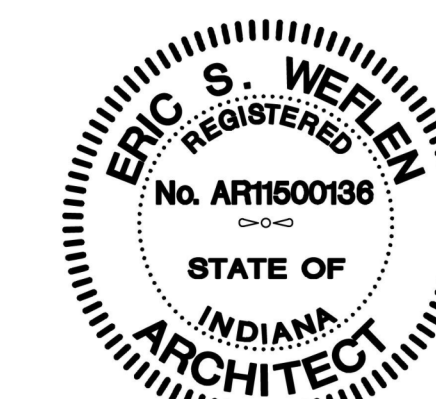
Project #: 20-700-151-2

Designed By: Designer

Drawn By: Author


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Date: 02.04.2022




Erin Wefler

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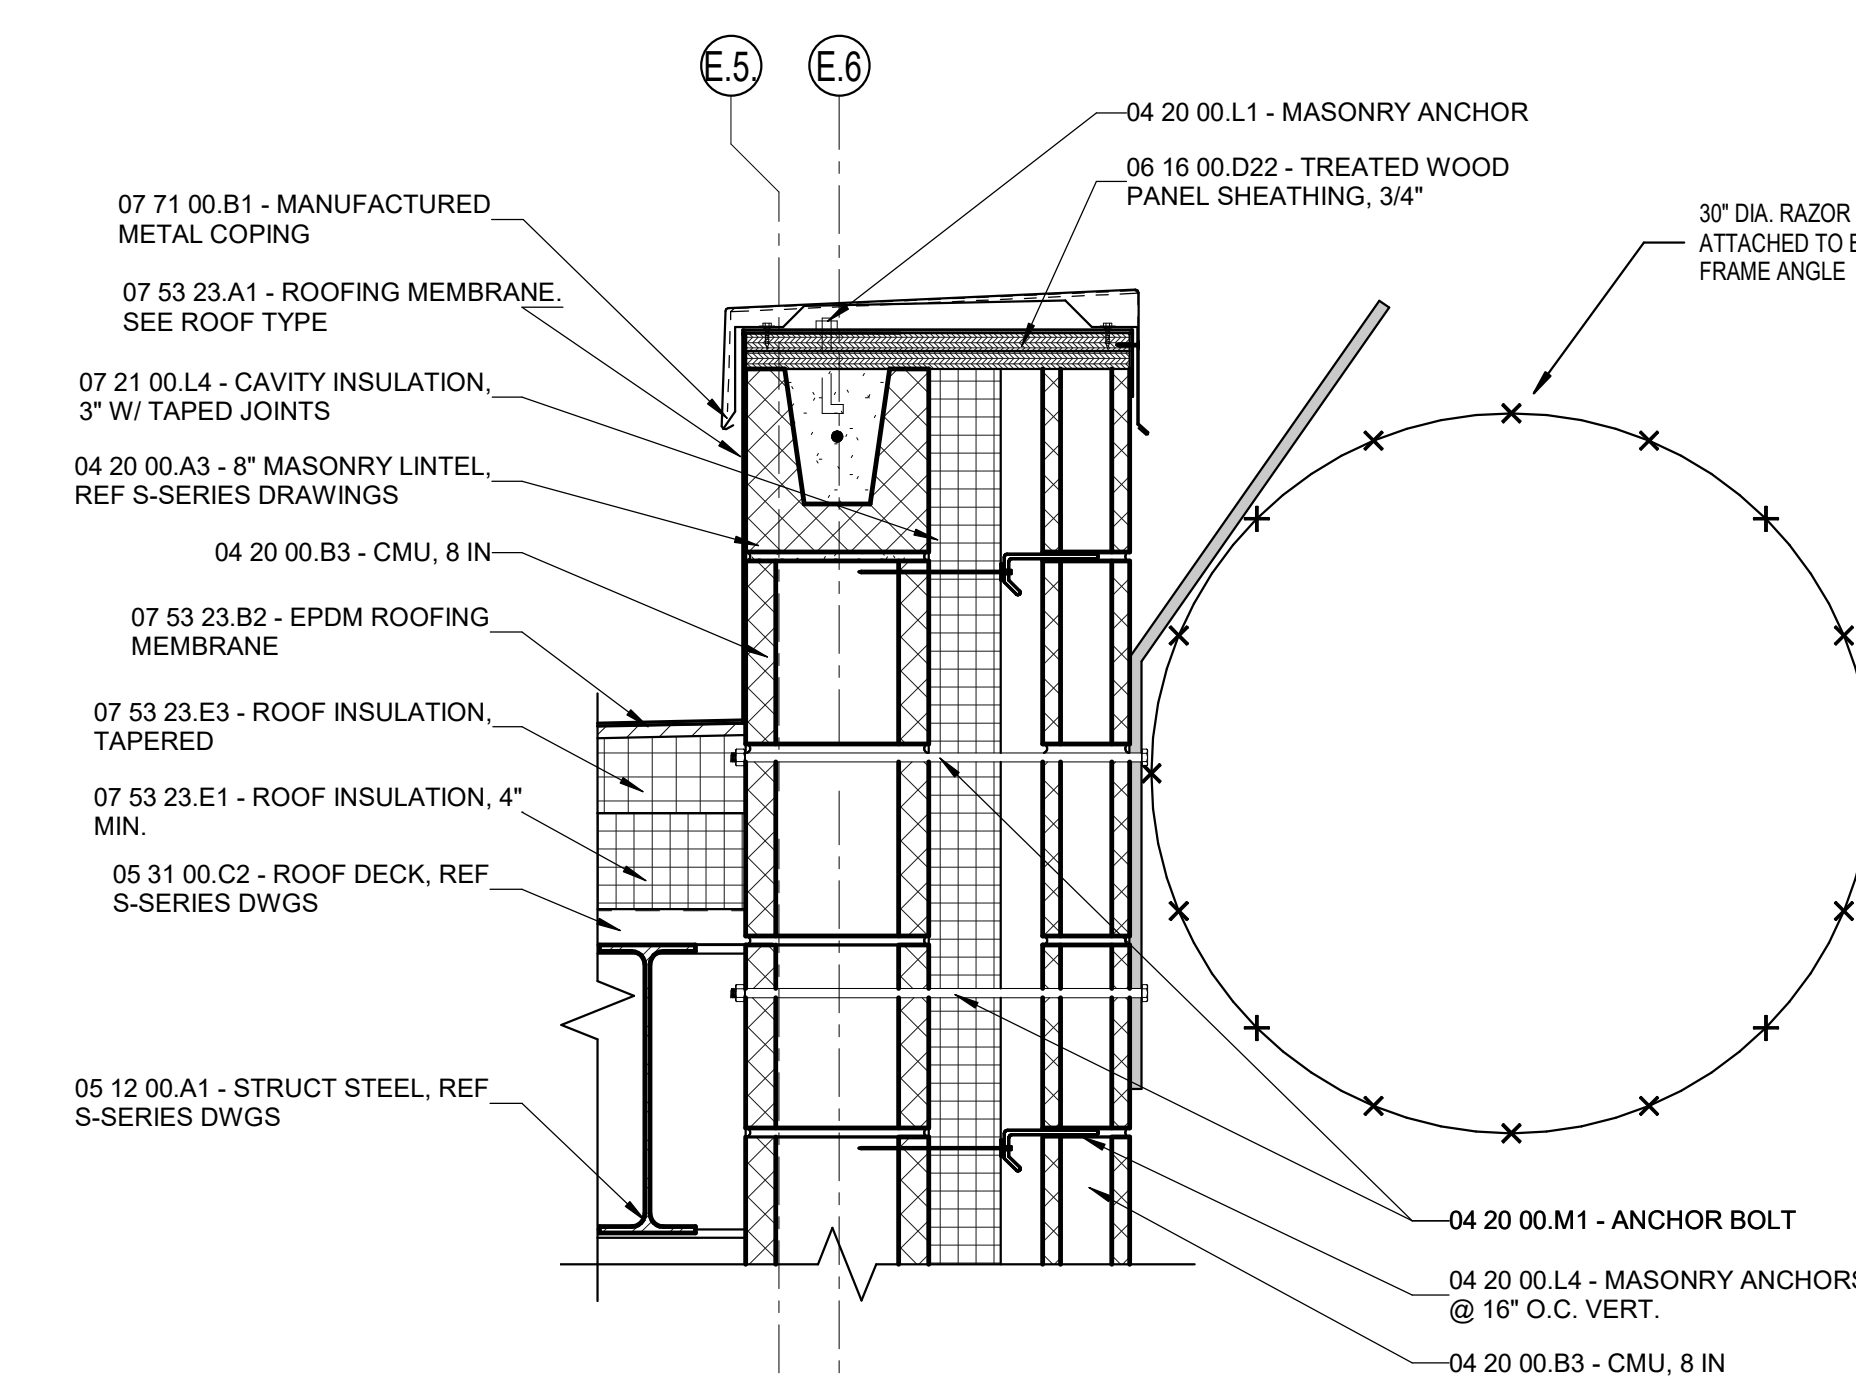


WALL SECTION DETAILS

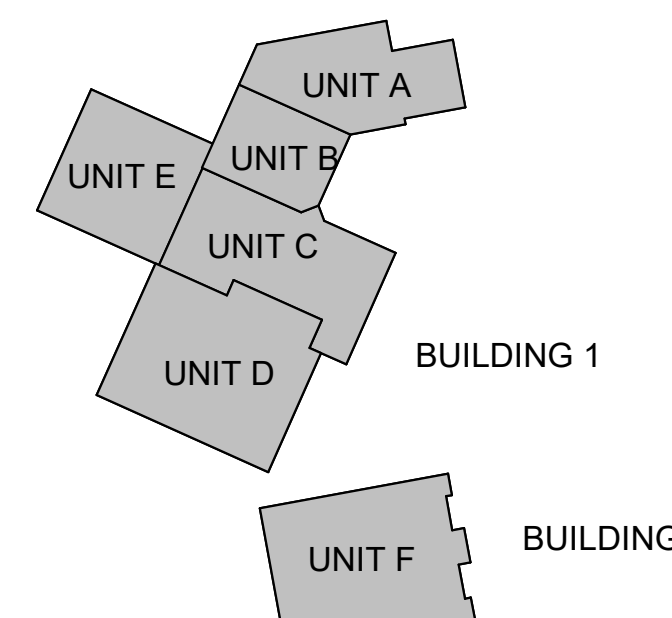
A 331

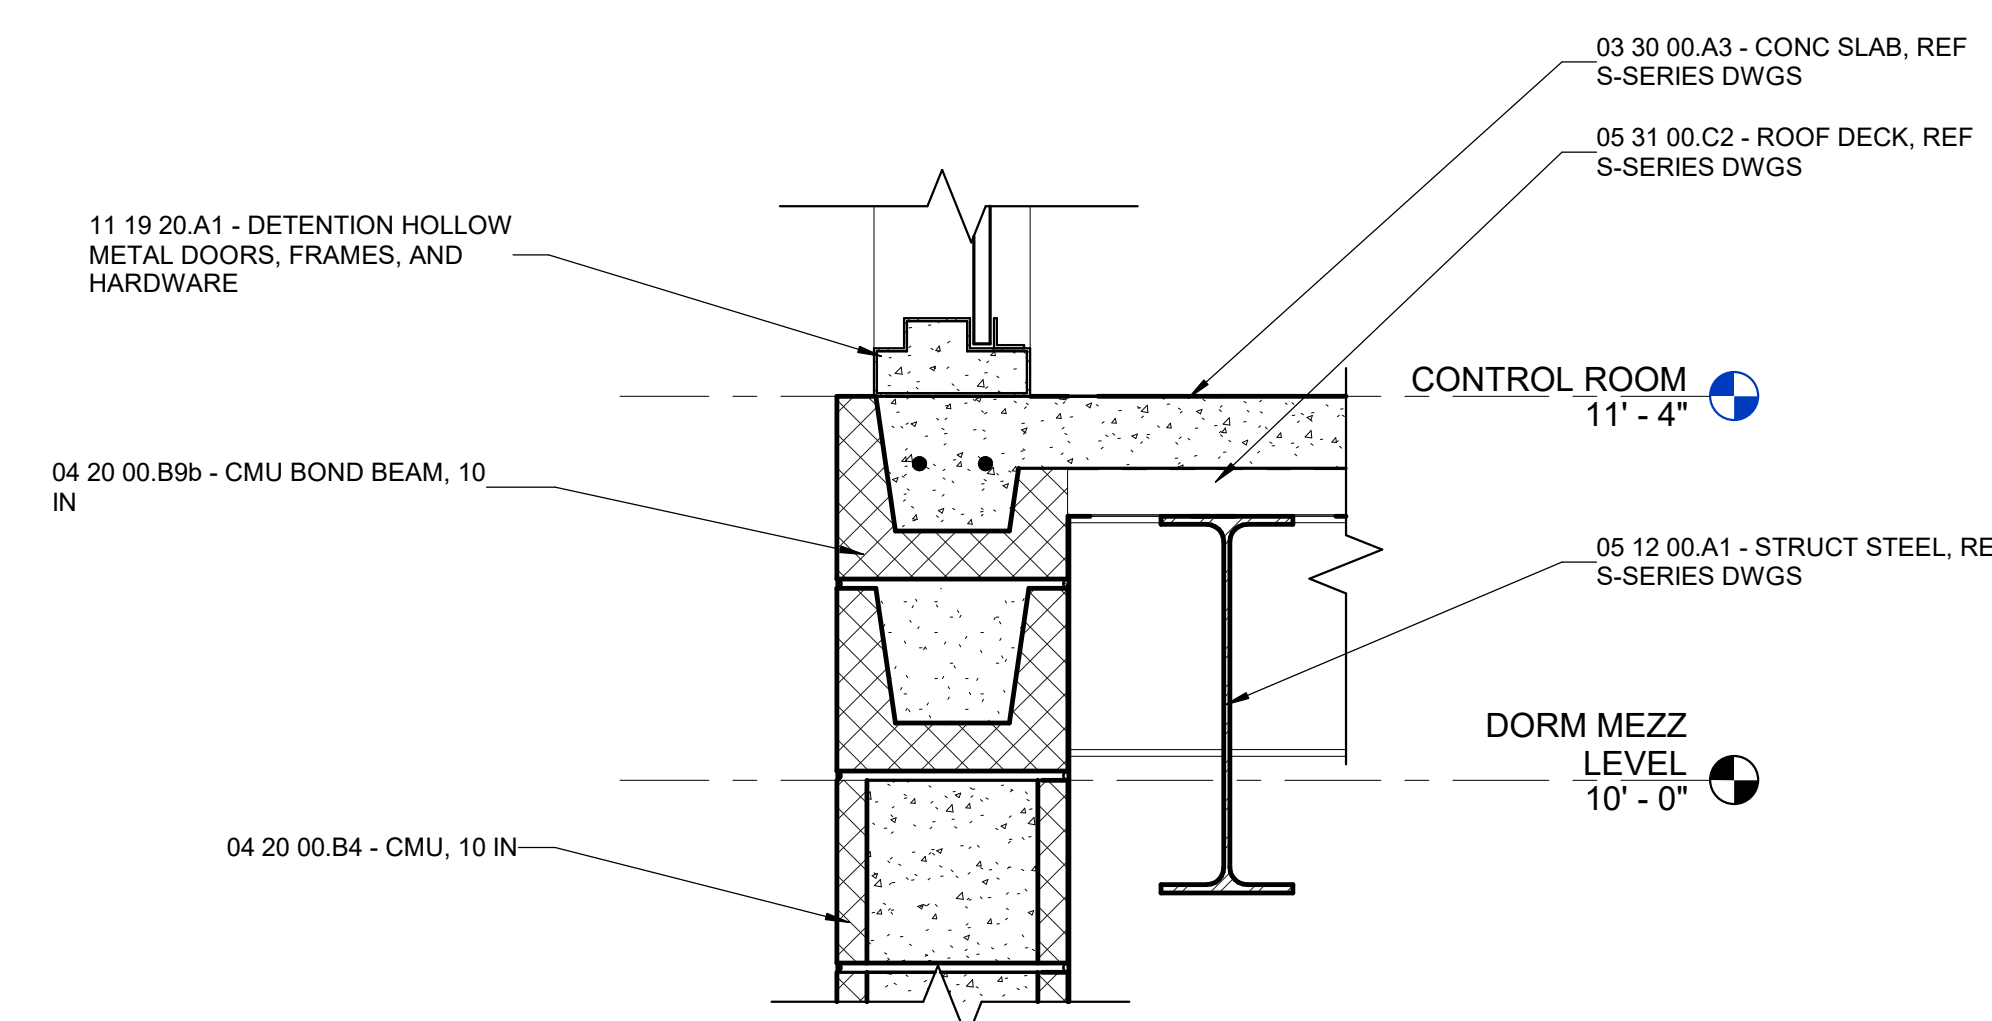


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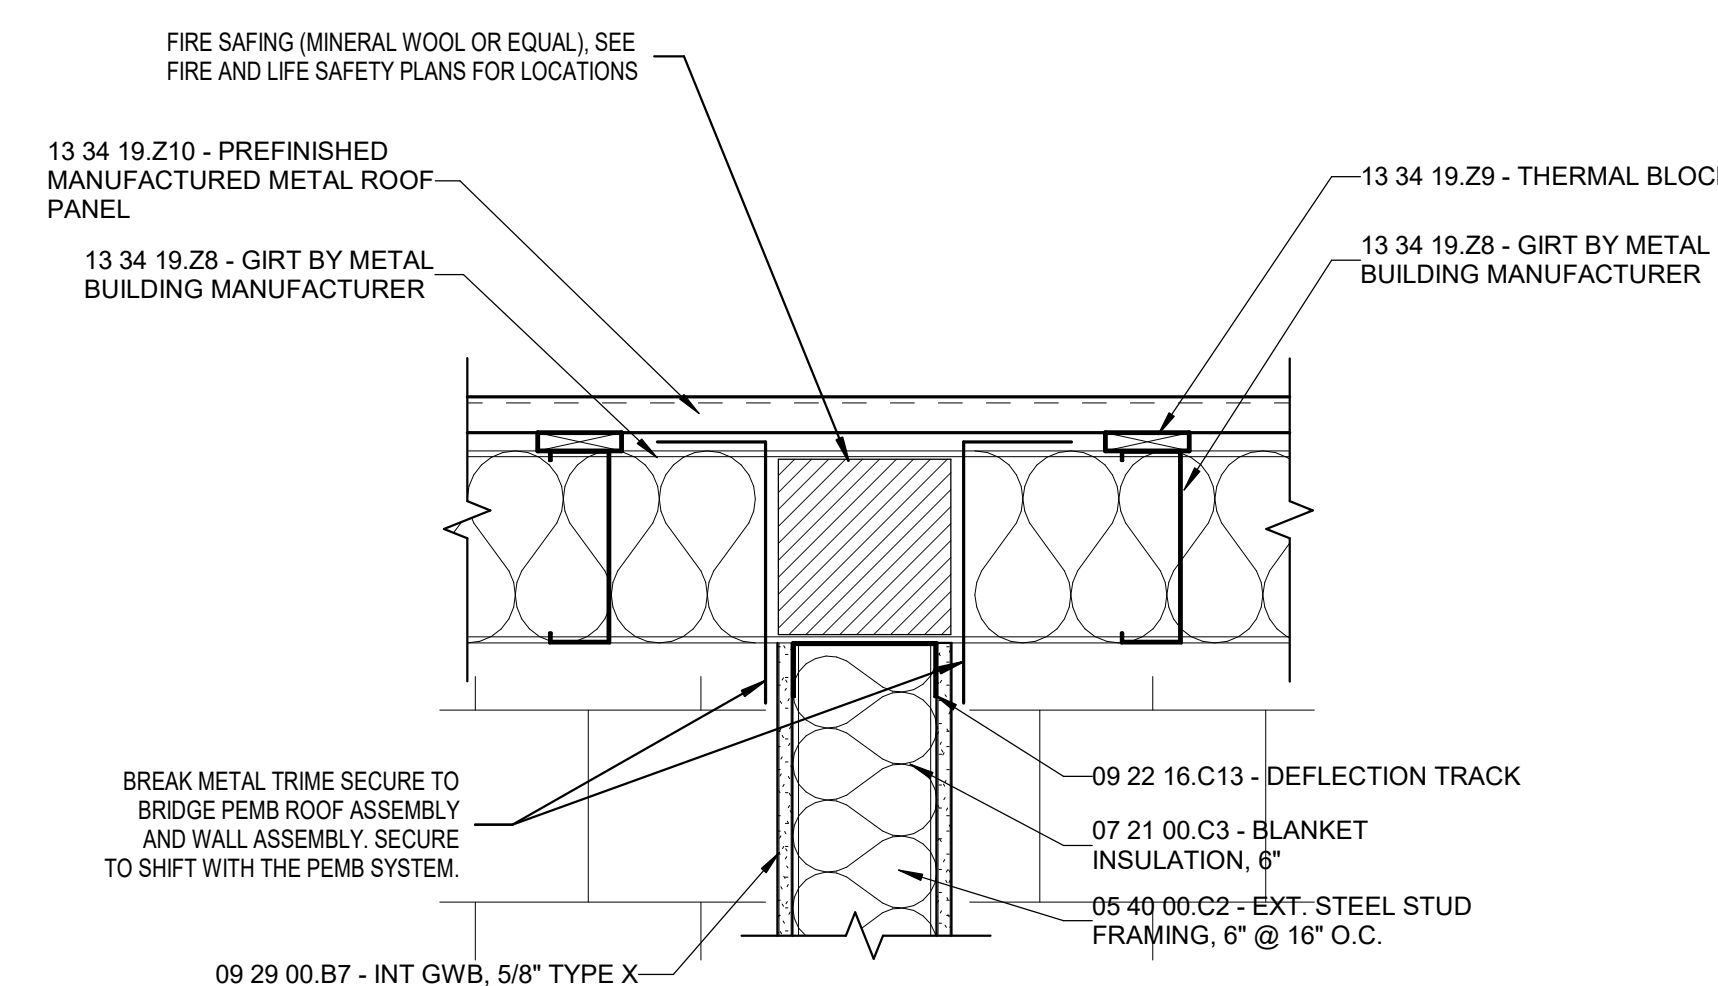
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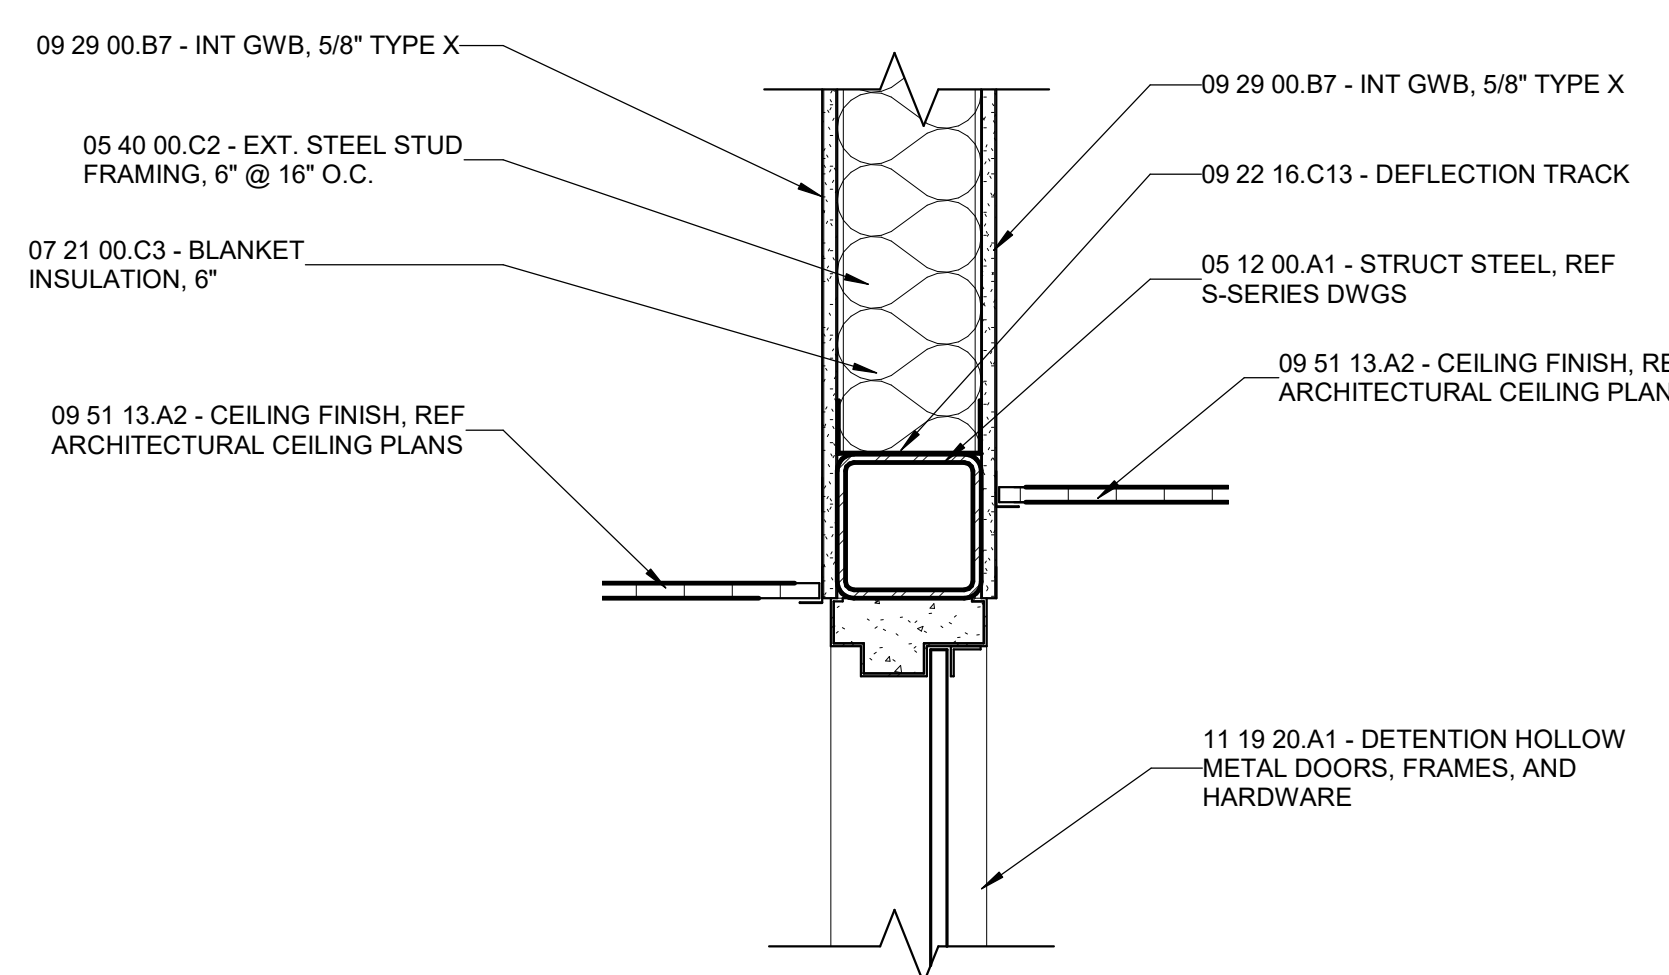
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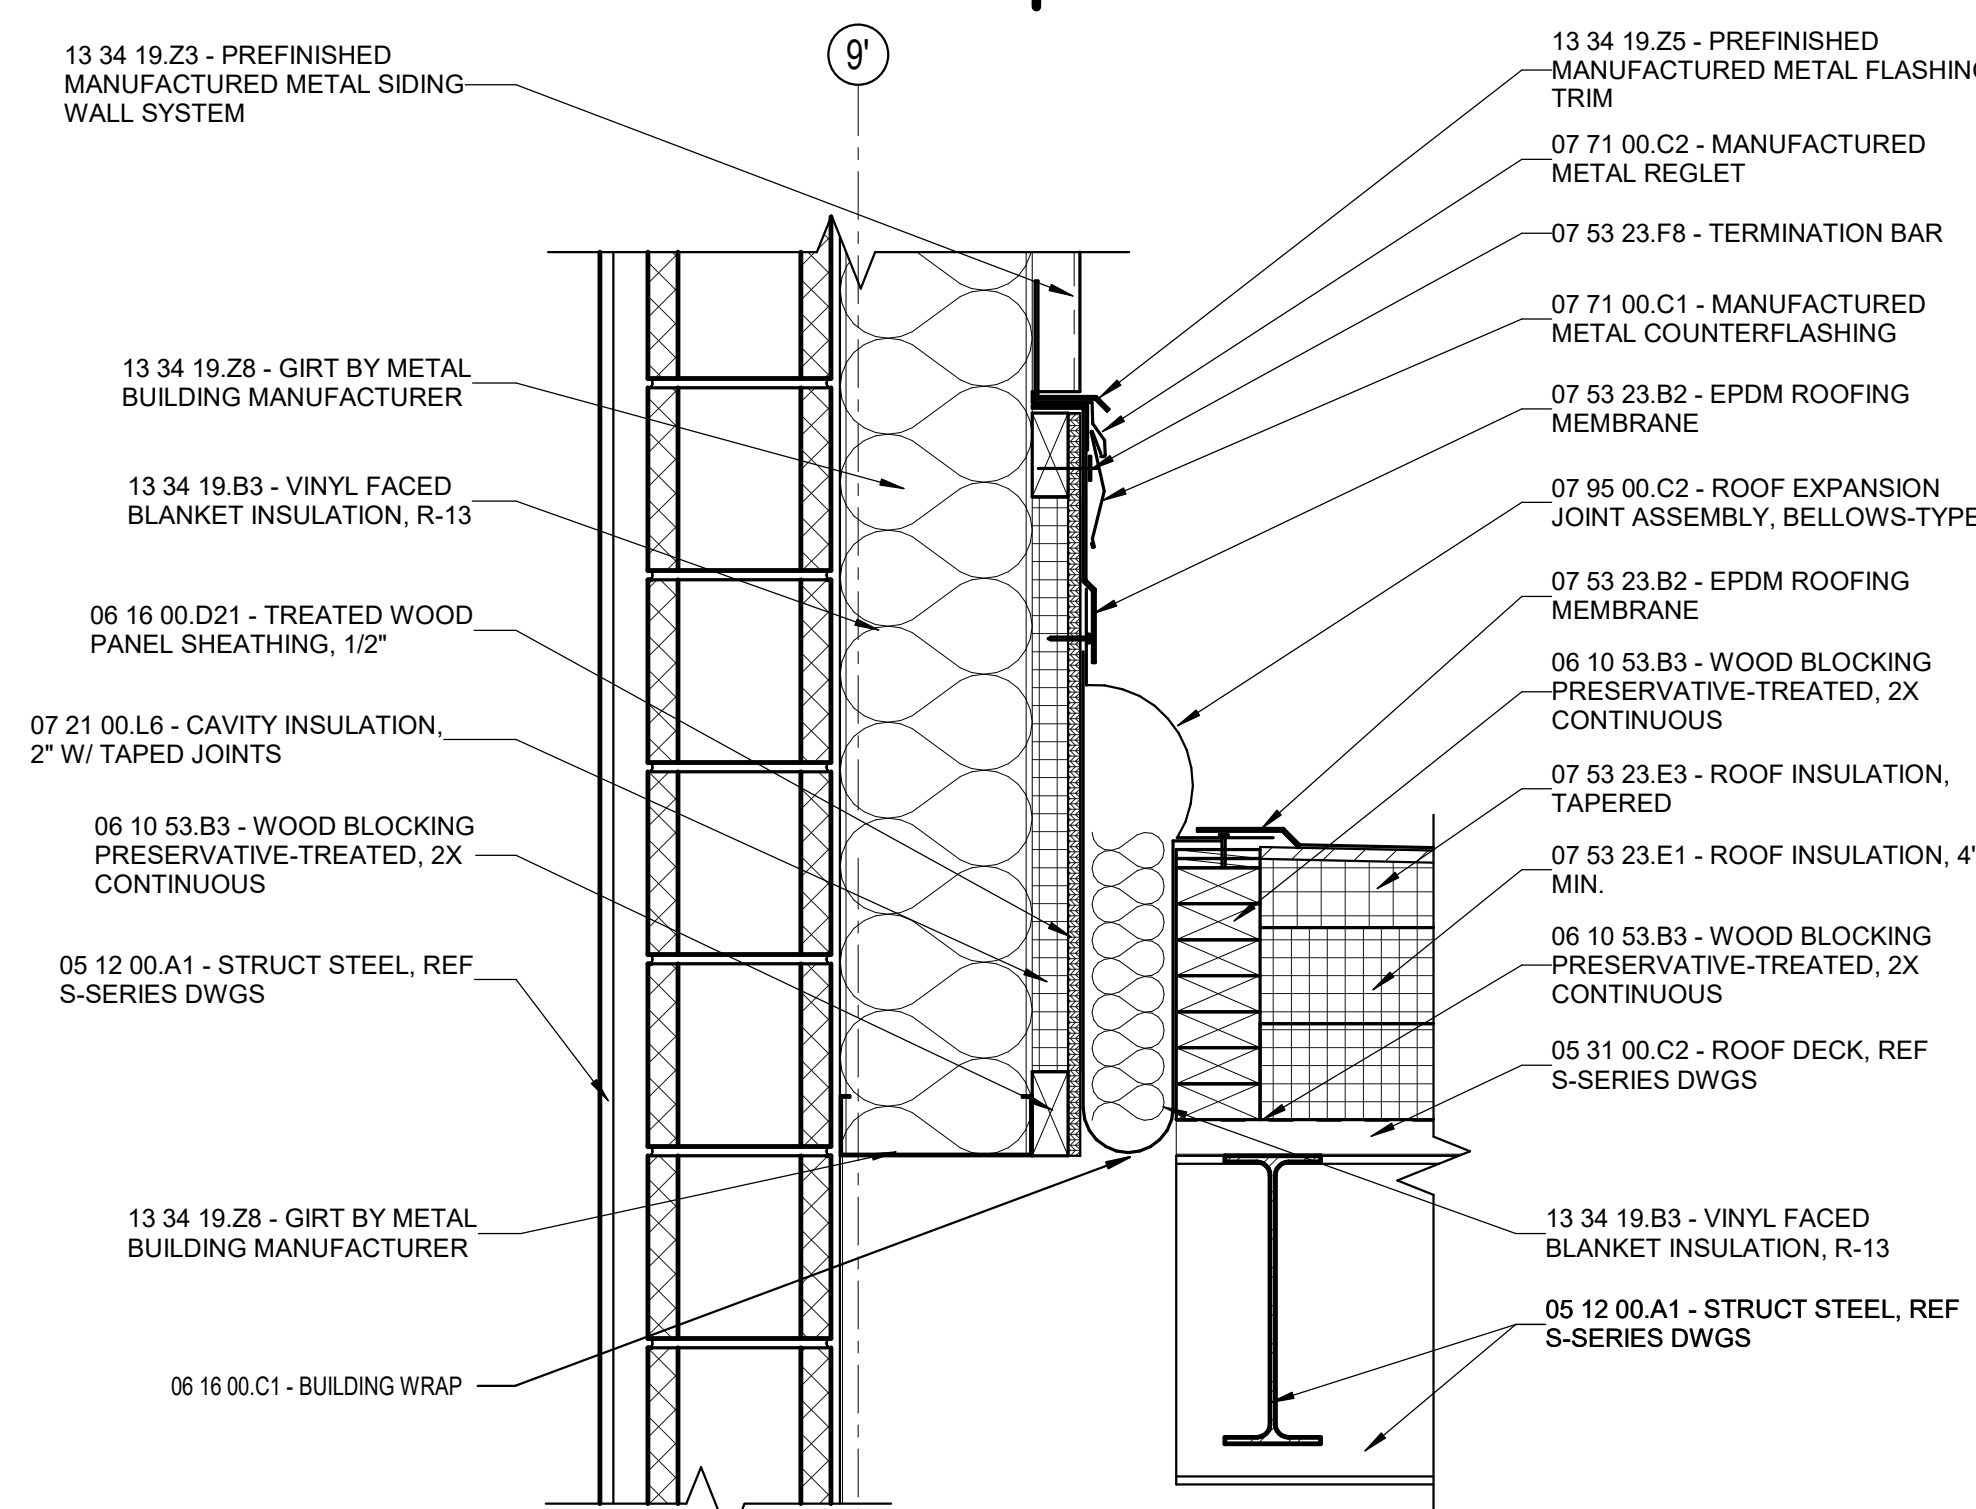
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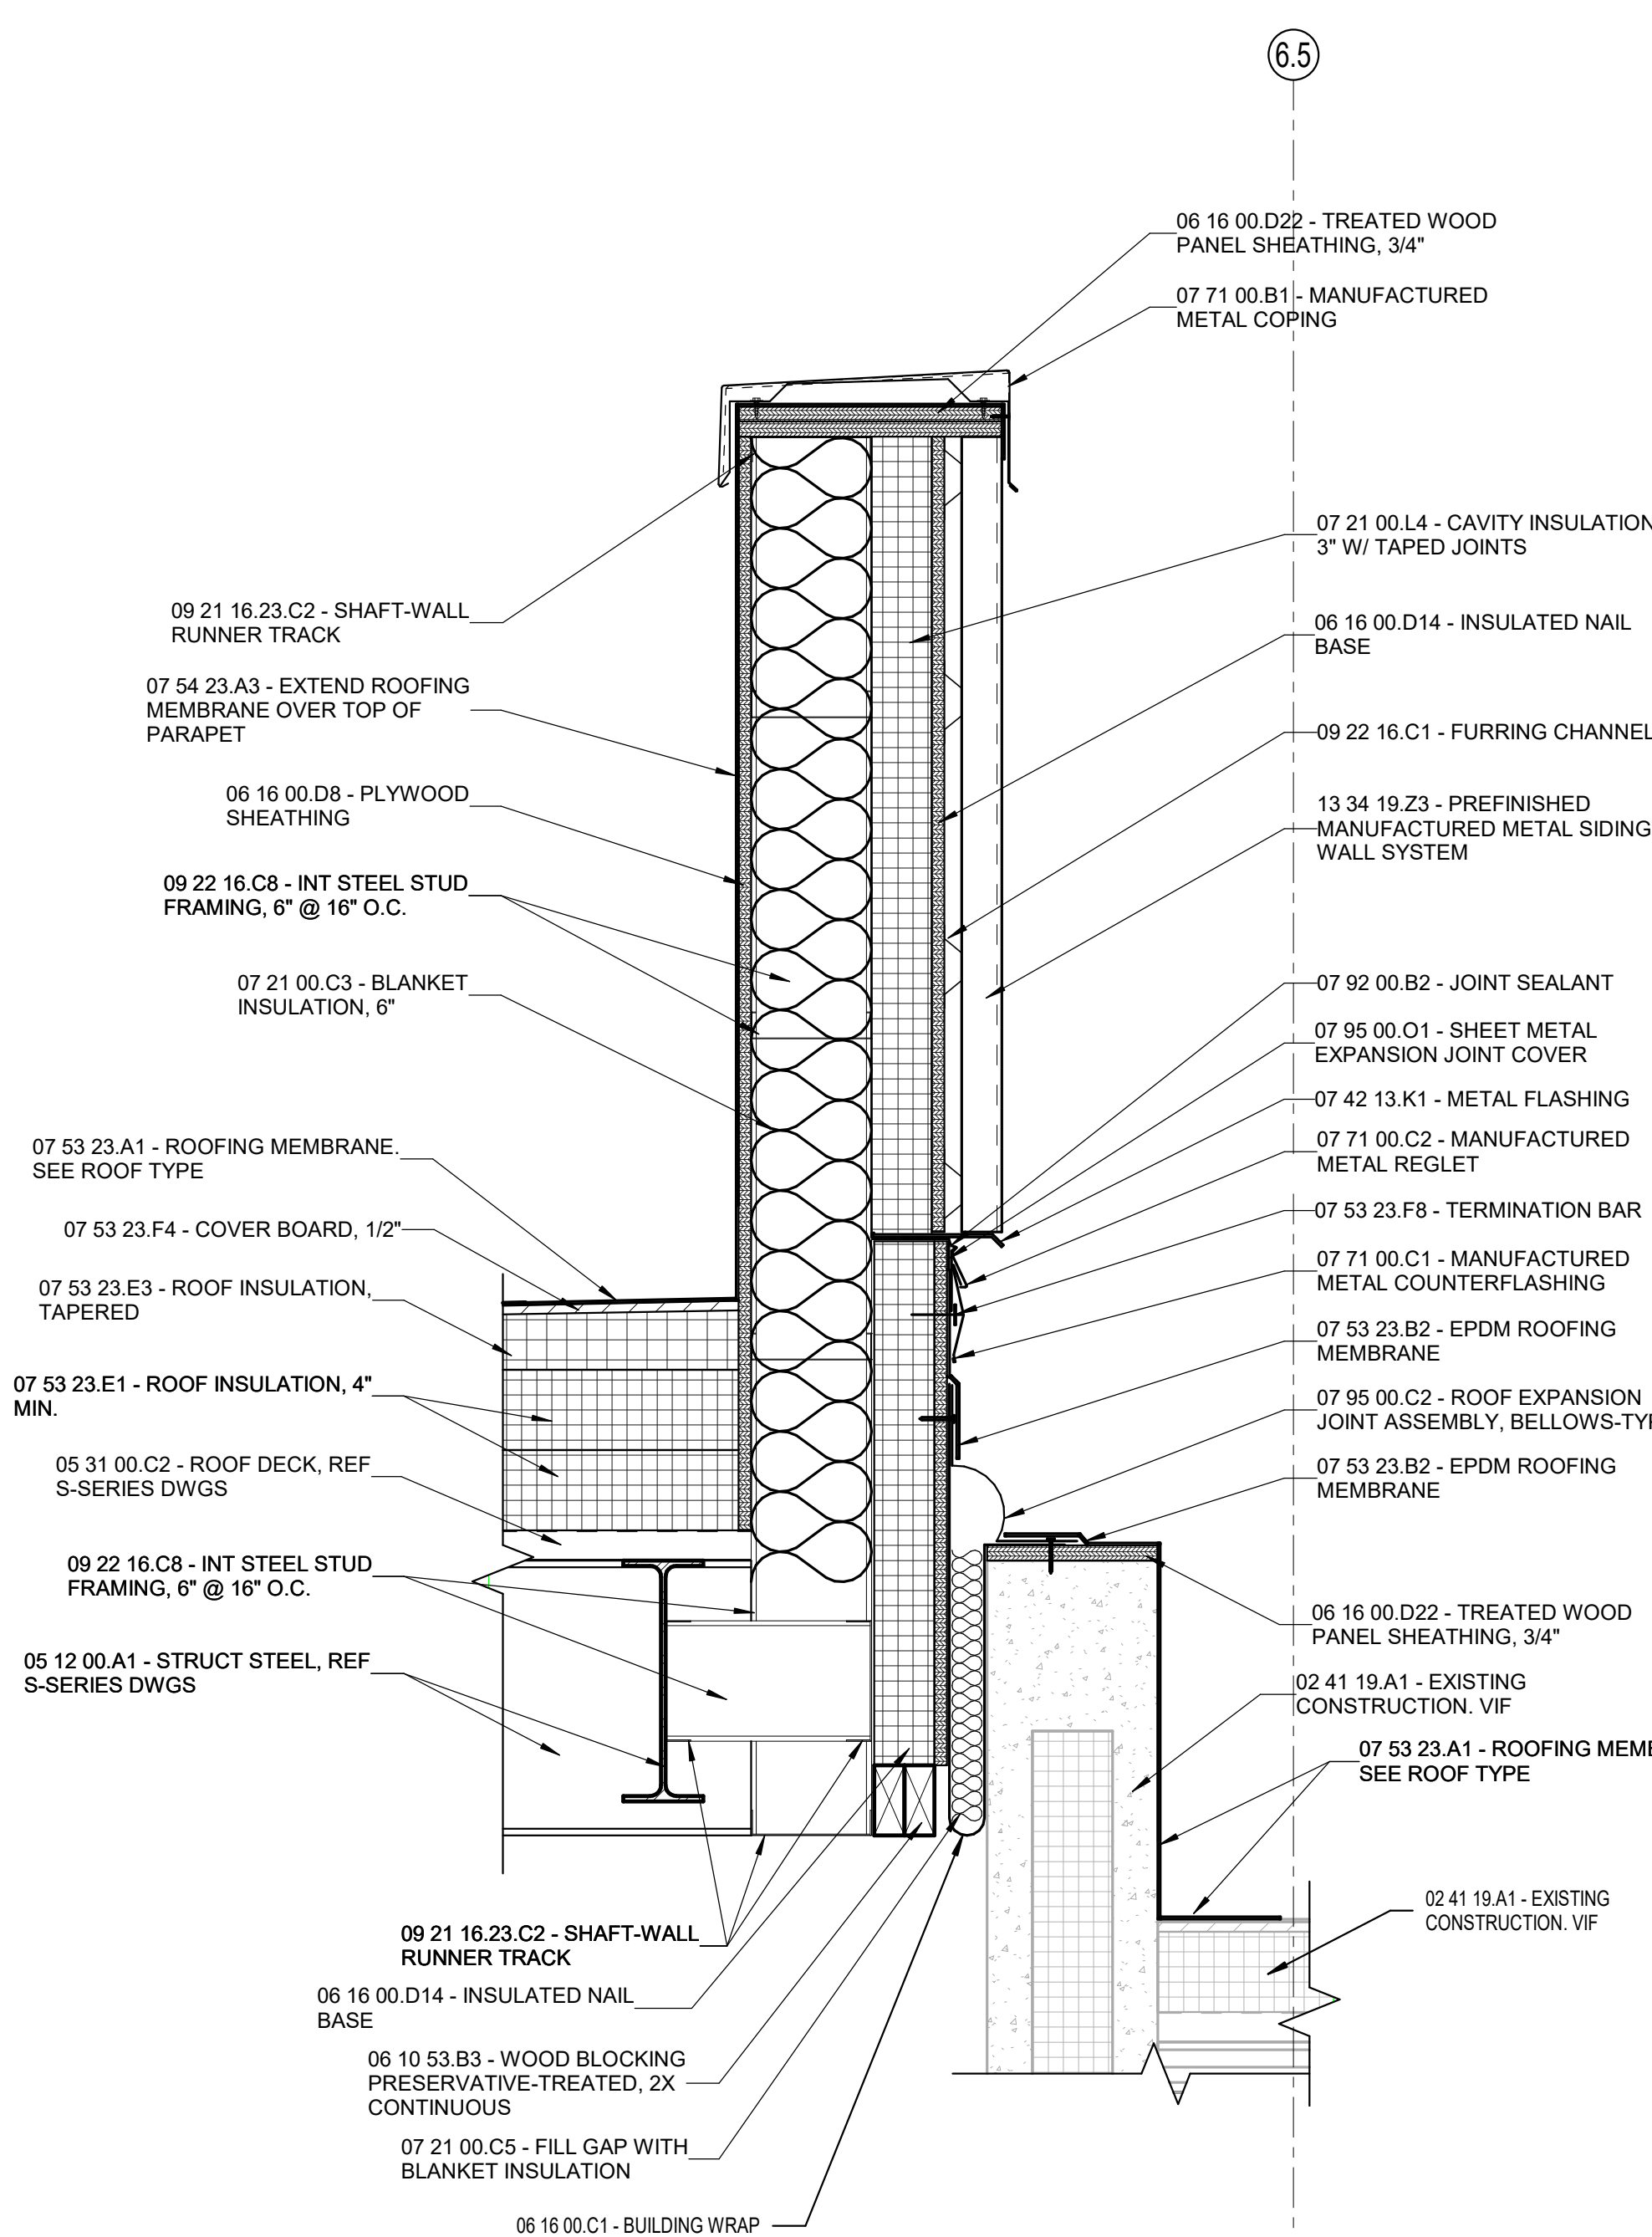
**3C WALL SECTION DETAIL 6.1.3**  
1 1/2" = 1'-0"



**3A WALL SECTION DETAIL 6.1.2**  
1 1/2" = 1'-0"

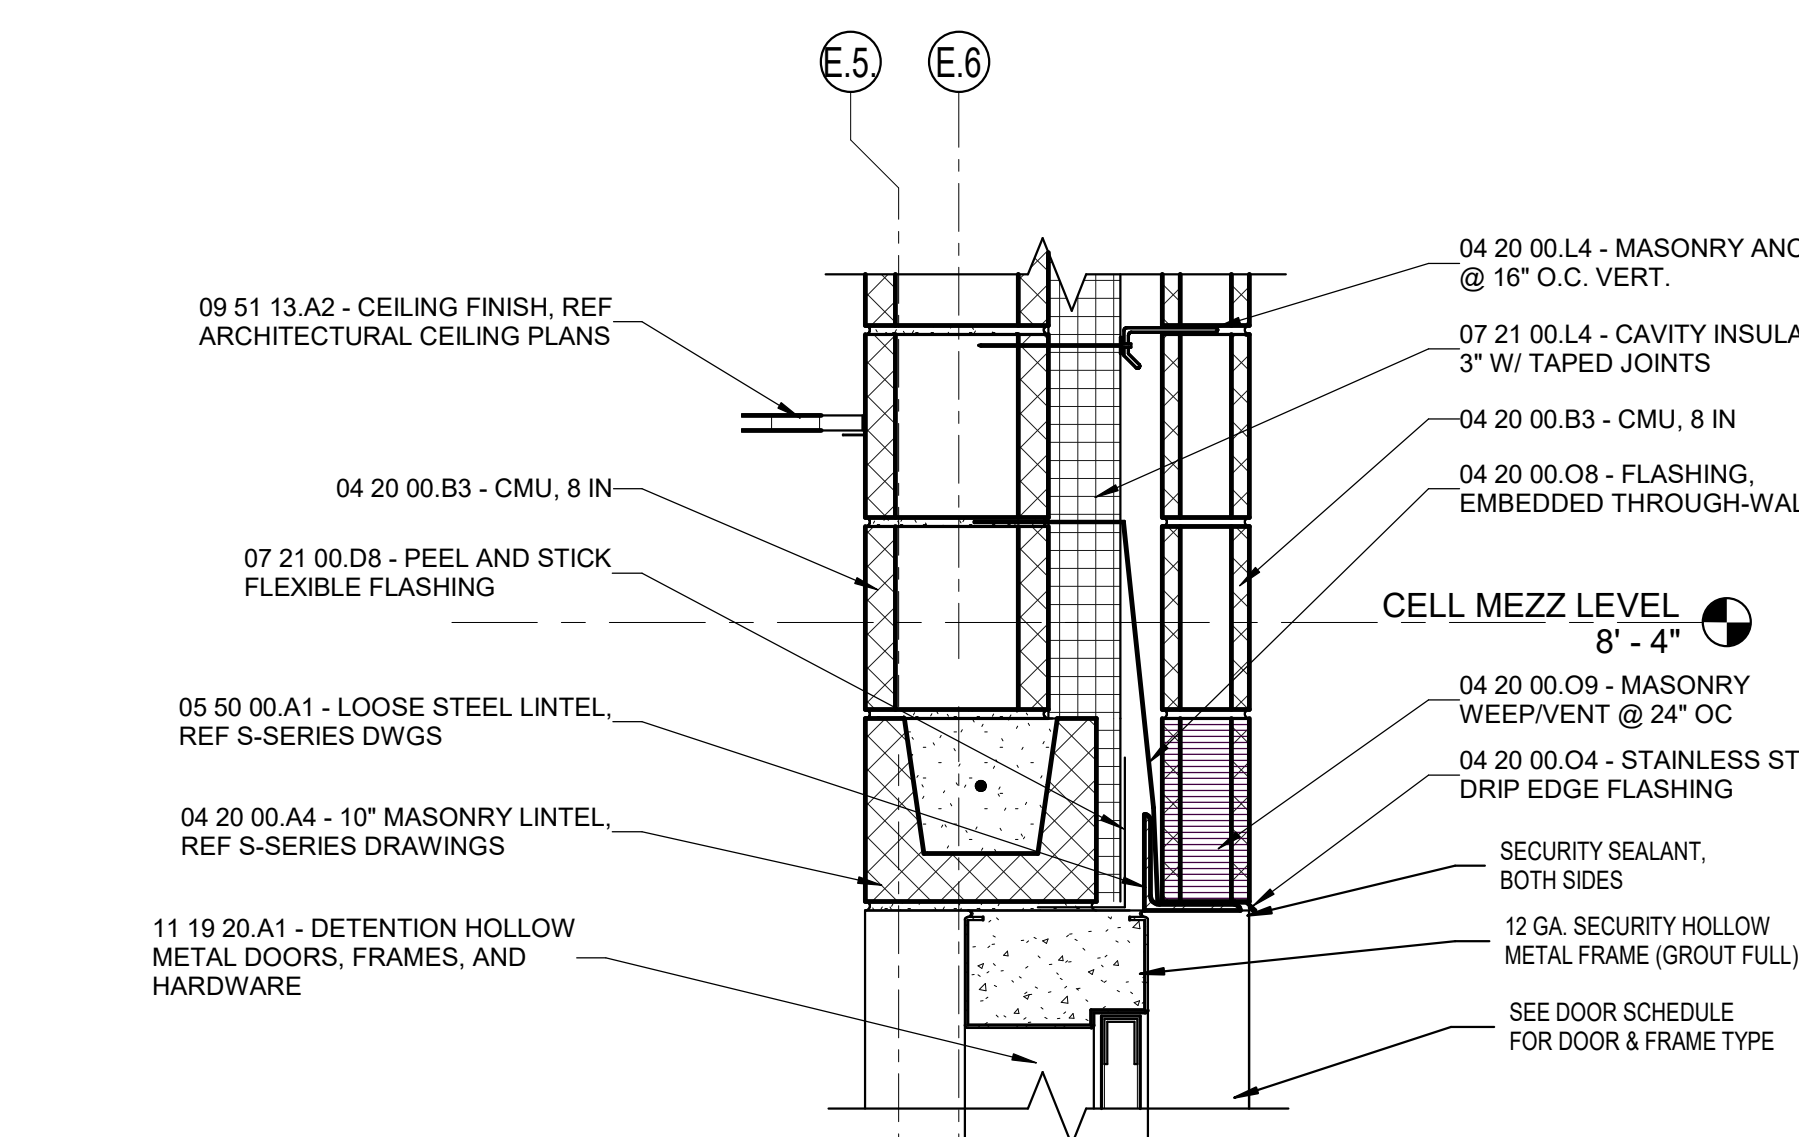

**5E WALL SECTION DETAIL 7.2.1**  
1 1/2" = 1'-0"

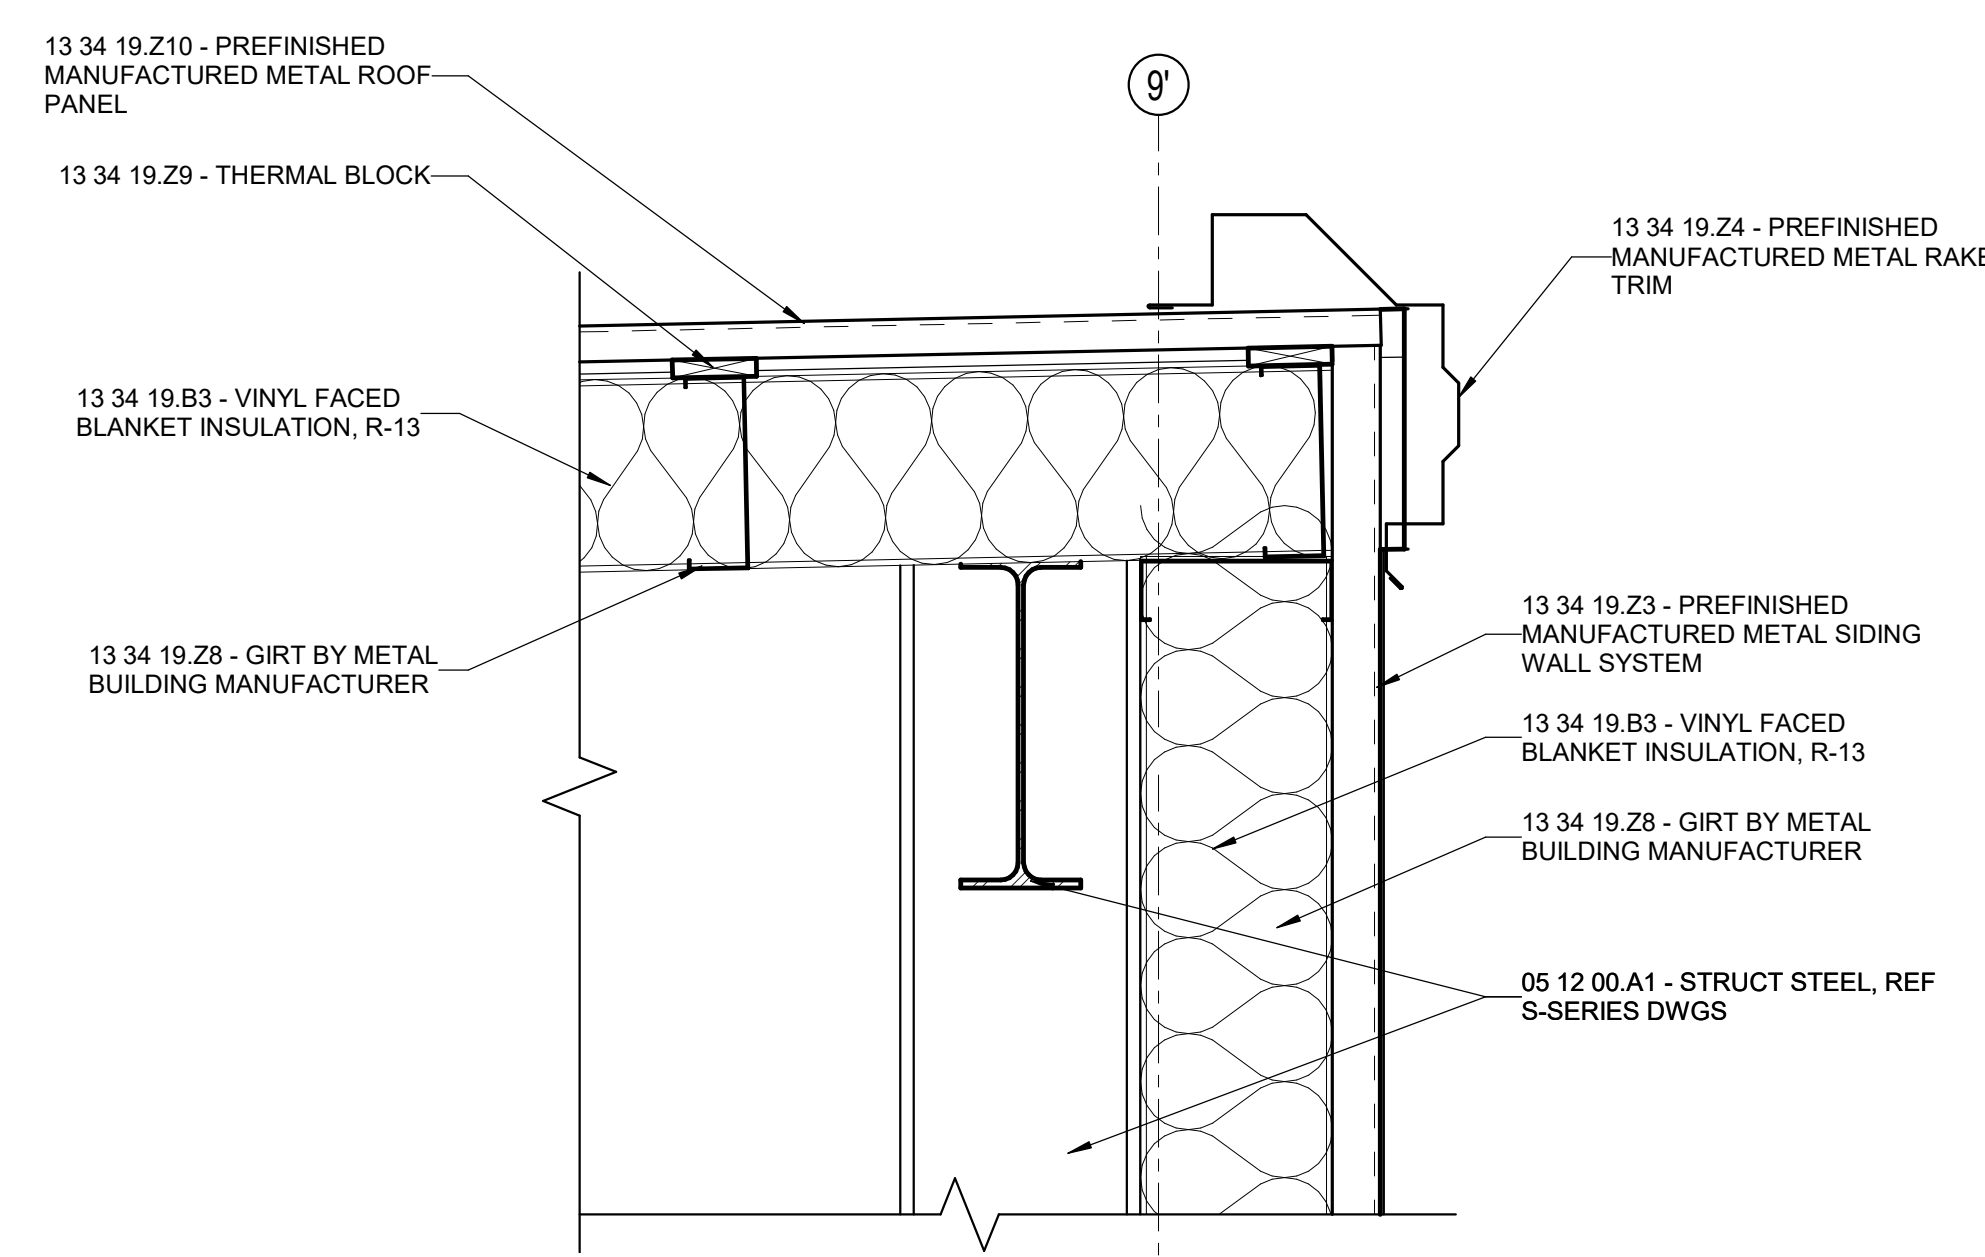

**5A** WALL SECTION DETAIL 7.3.1  
1 1/2" = 1'-0"








#	Revision	Date

Project #: 20-700-151-2  
Designed By: Designer  
Drawn By: Author  
Checked By: Checker  
Date: 02.04.2022




*Eric Weisen*


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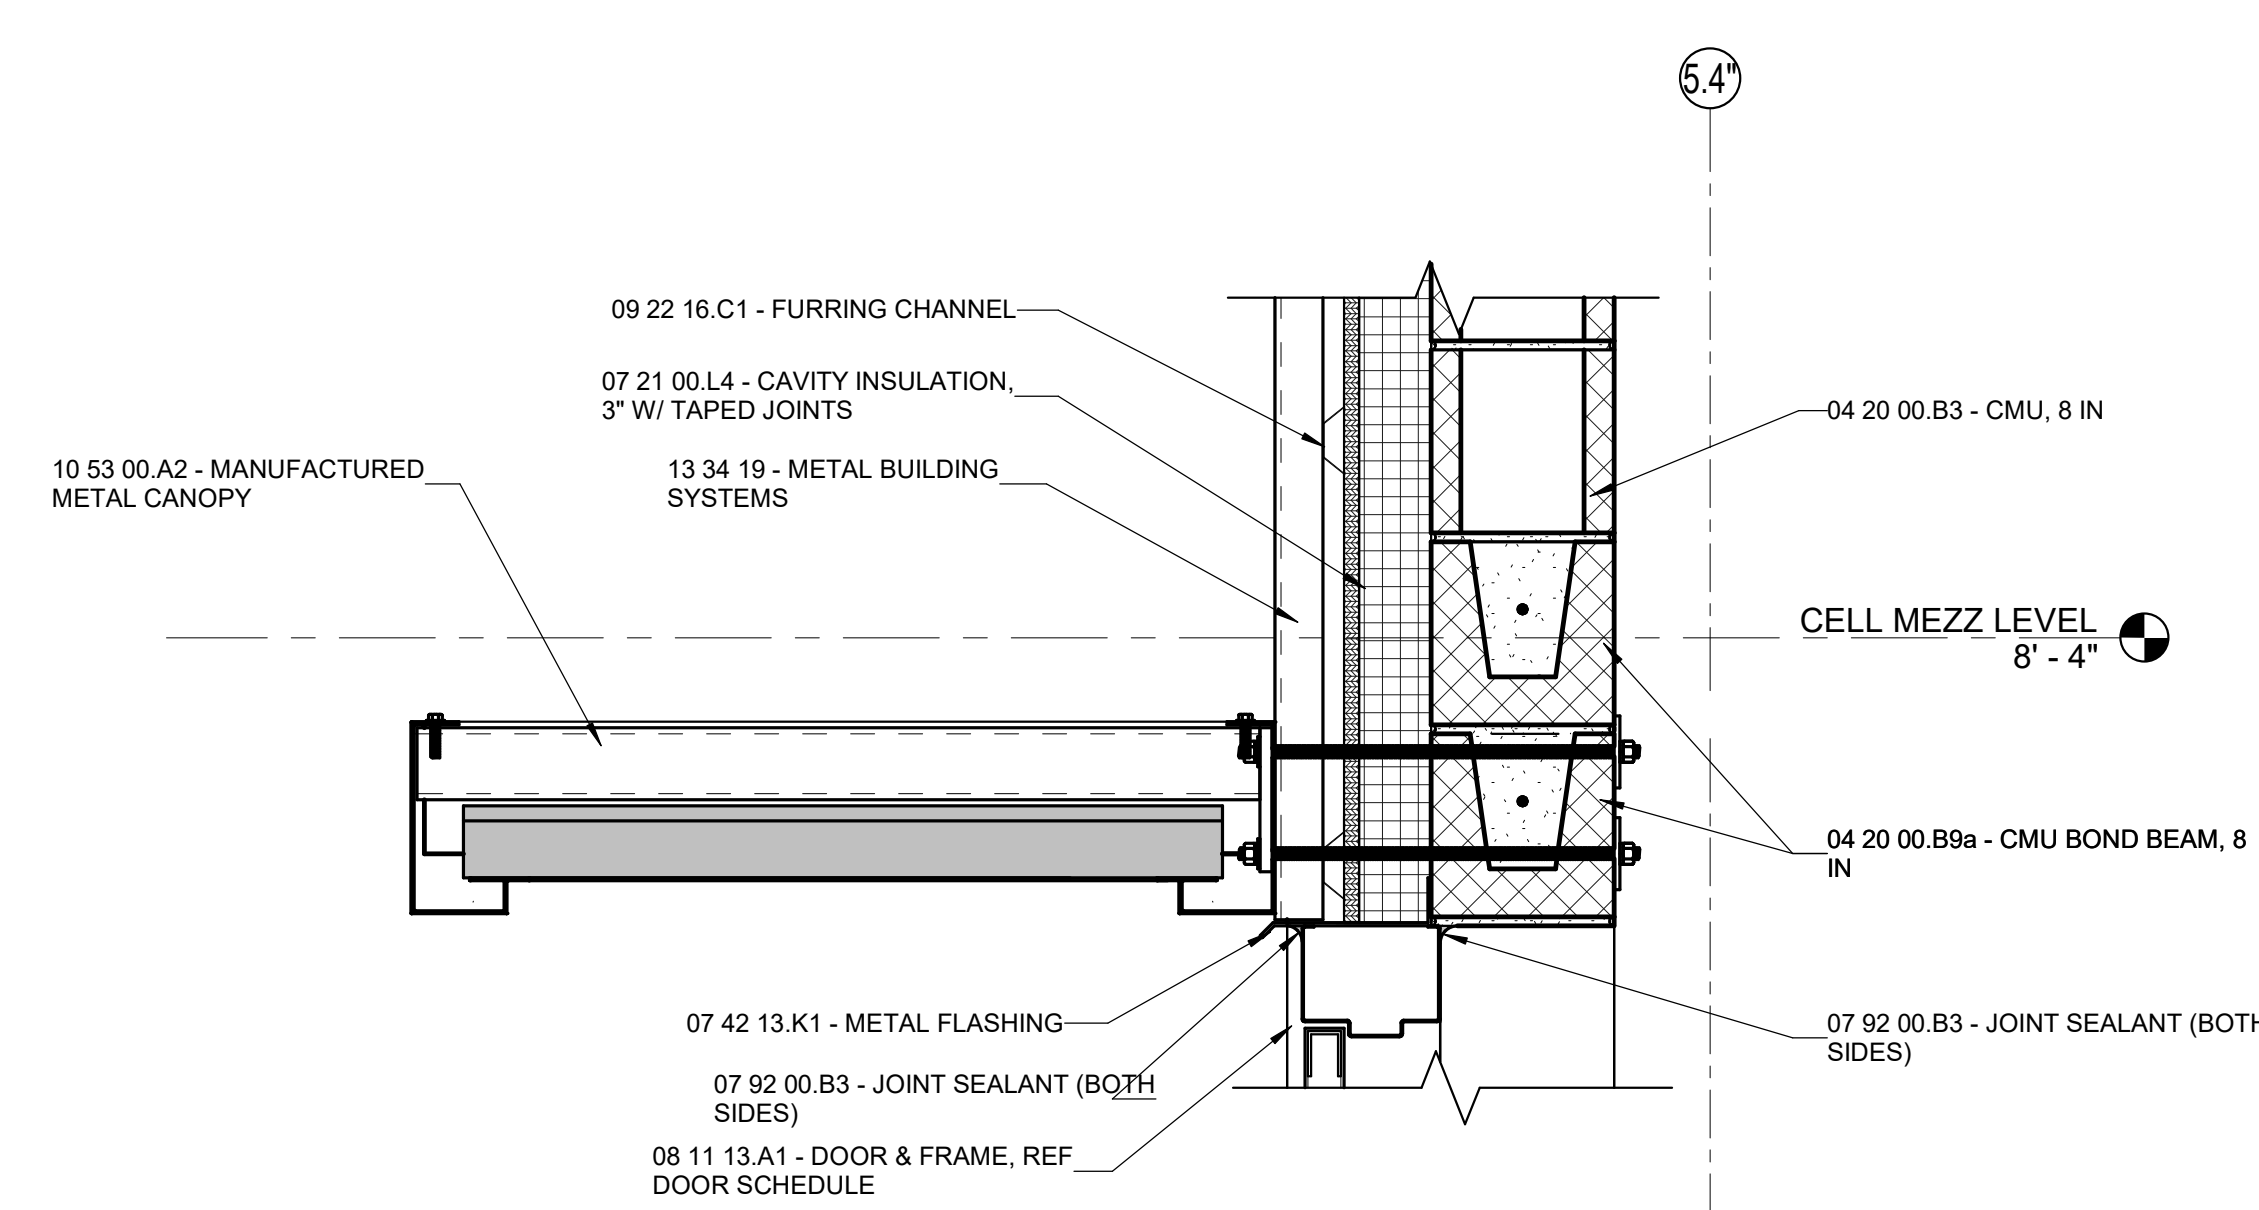
WALL SECTION DETAILS

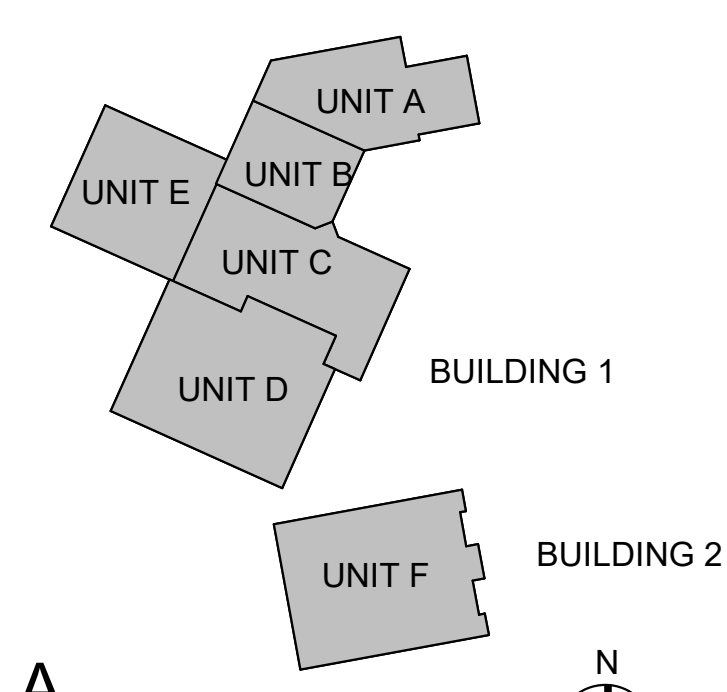


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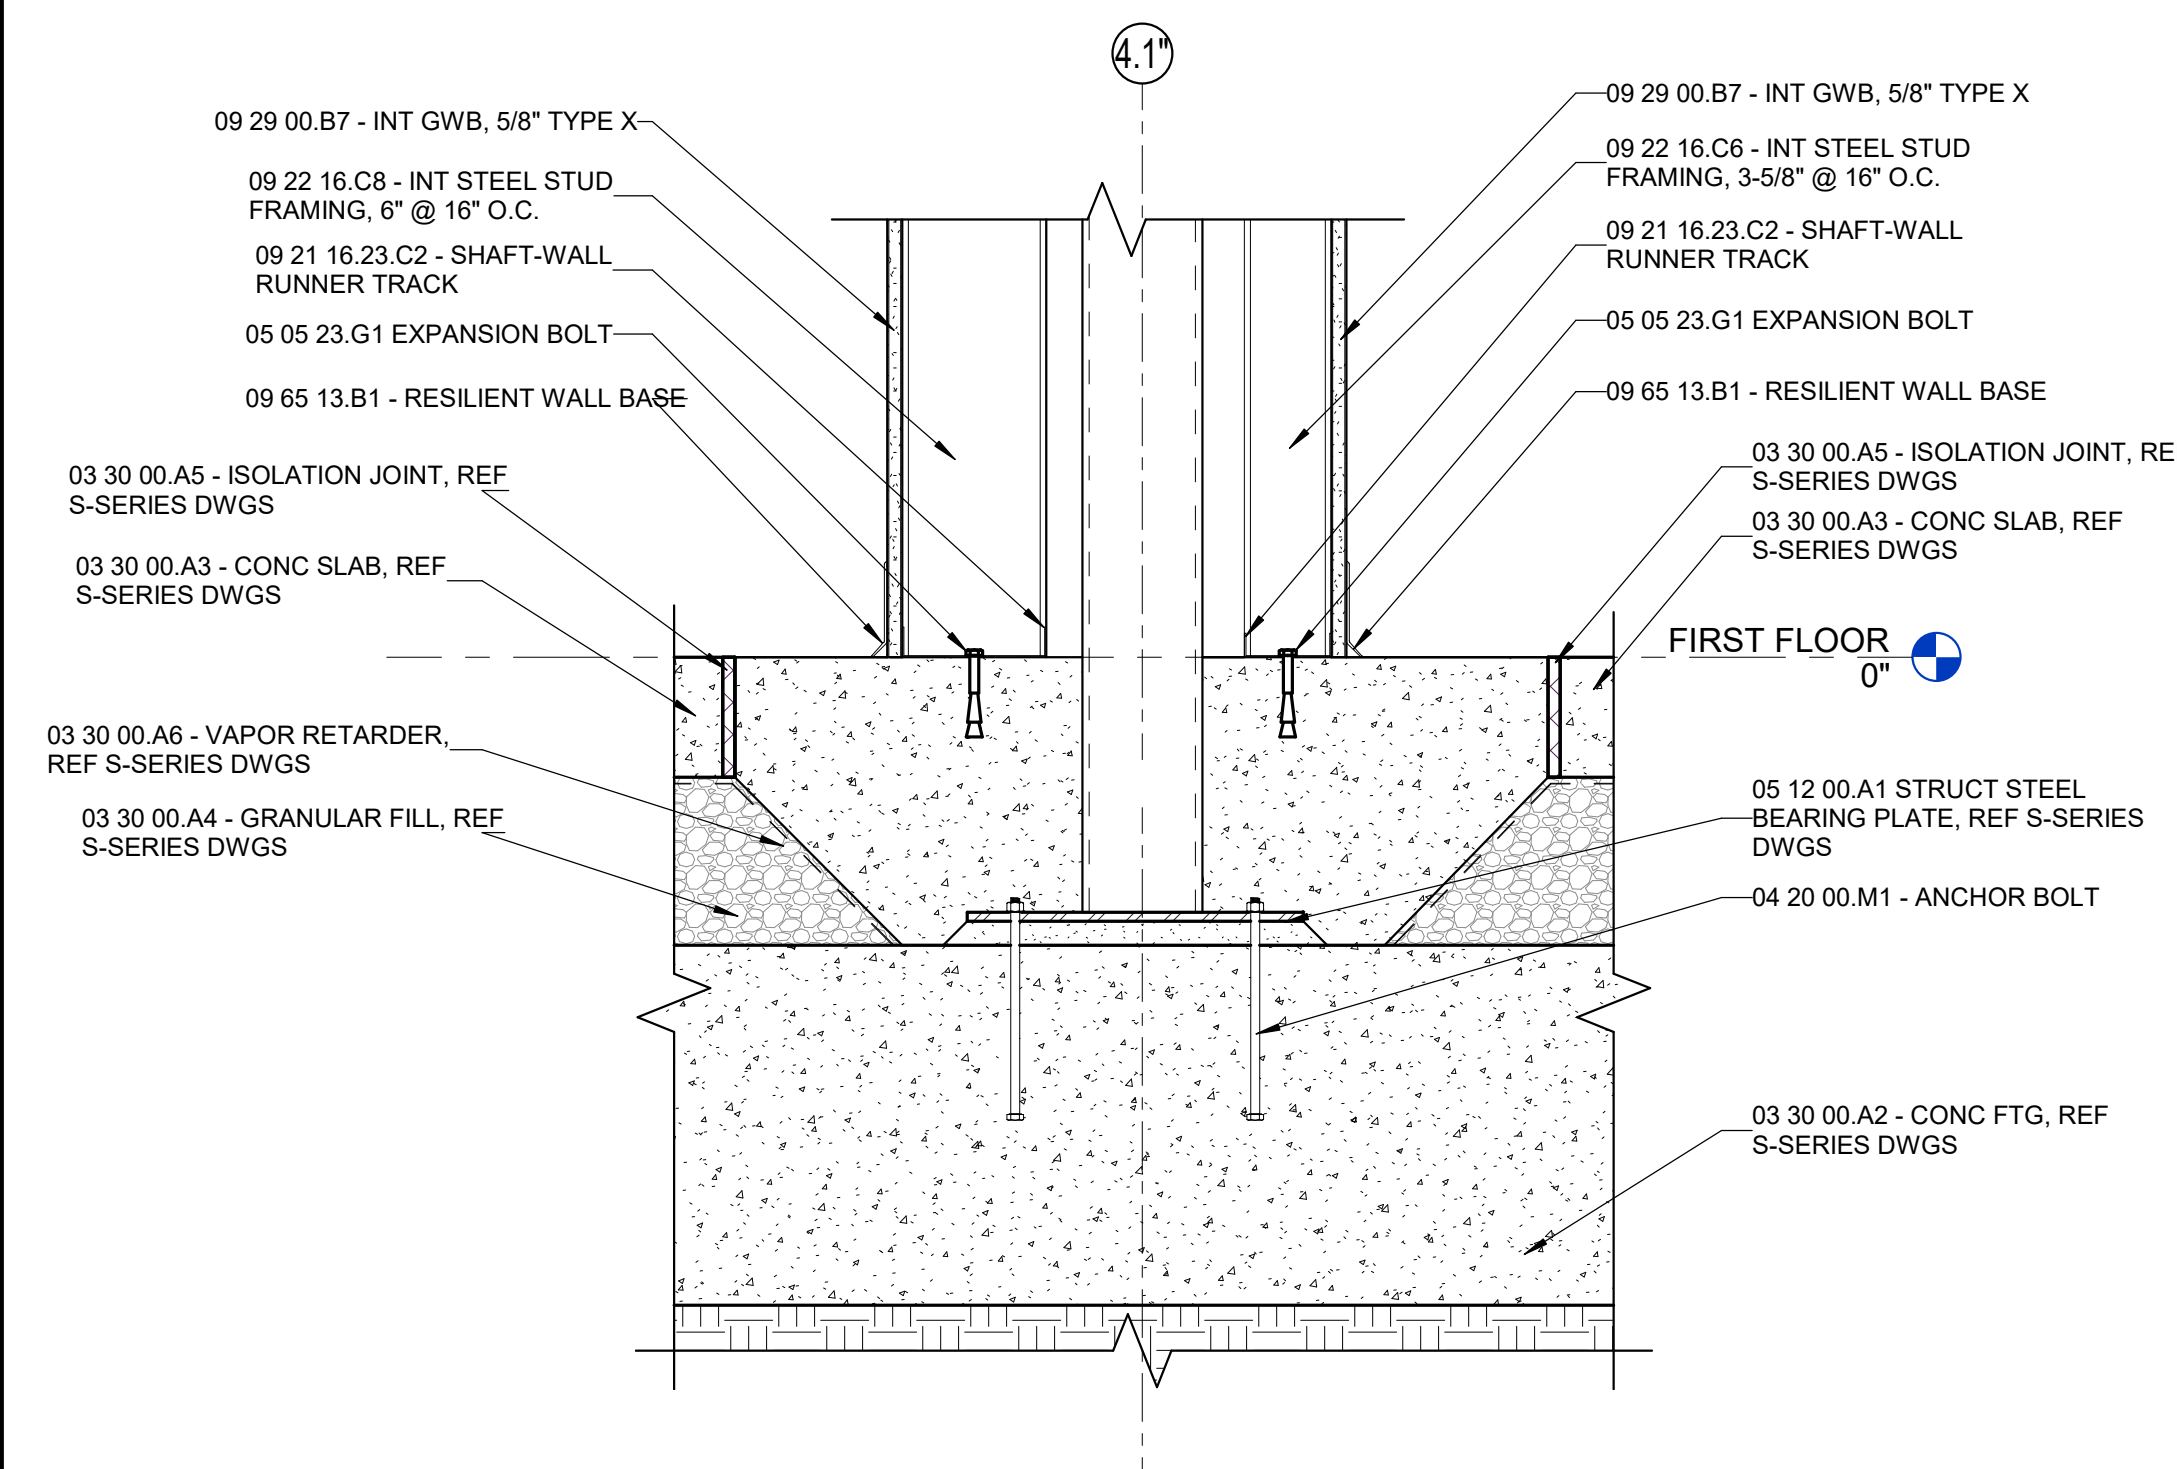
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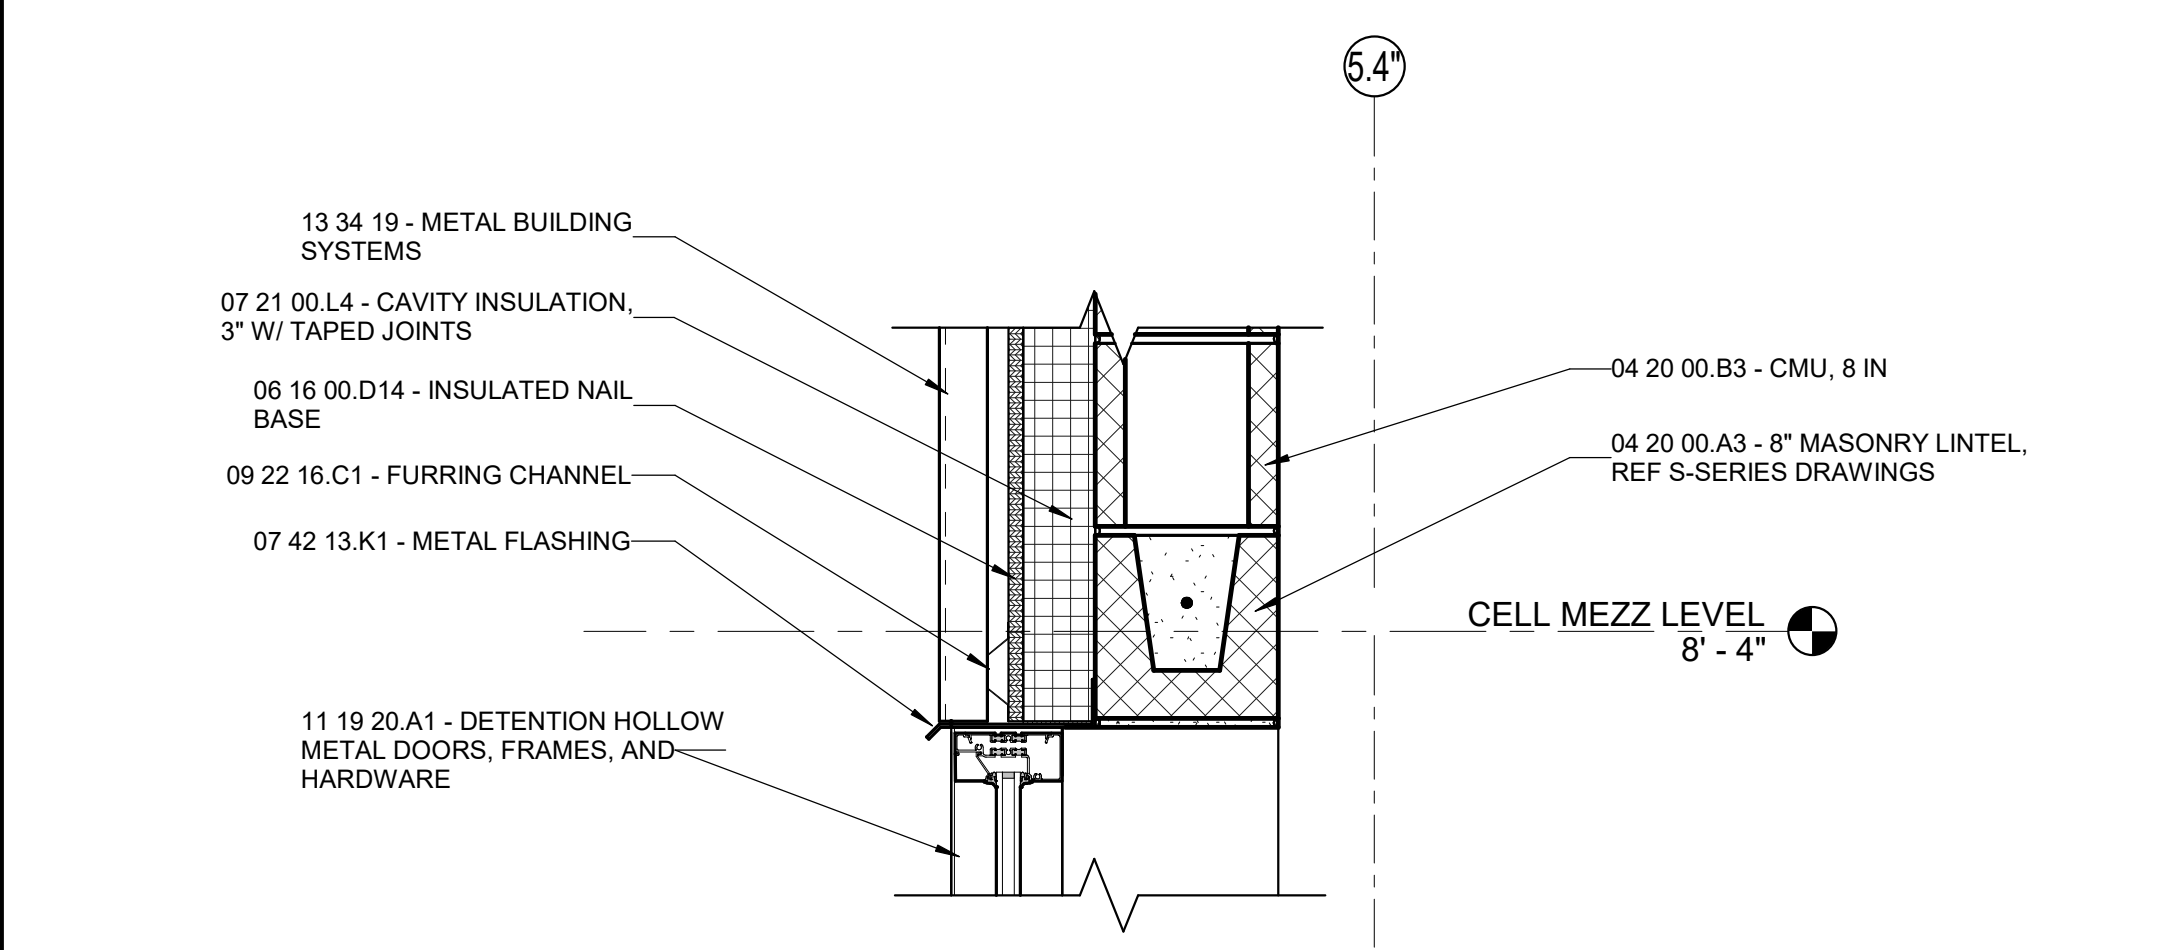
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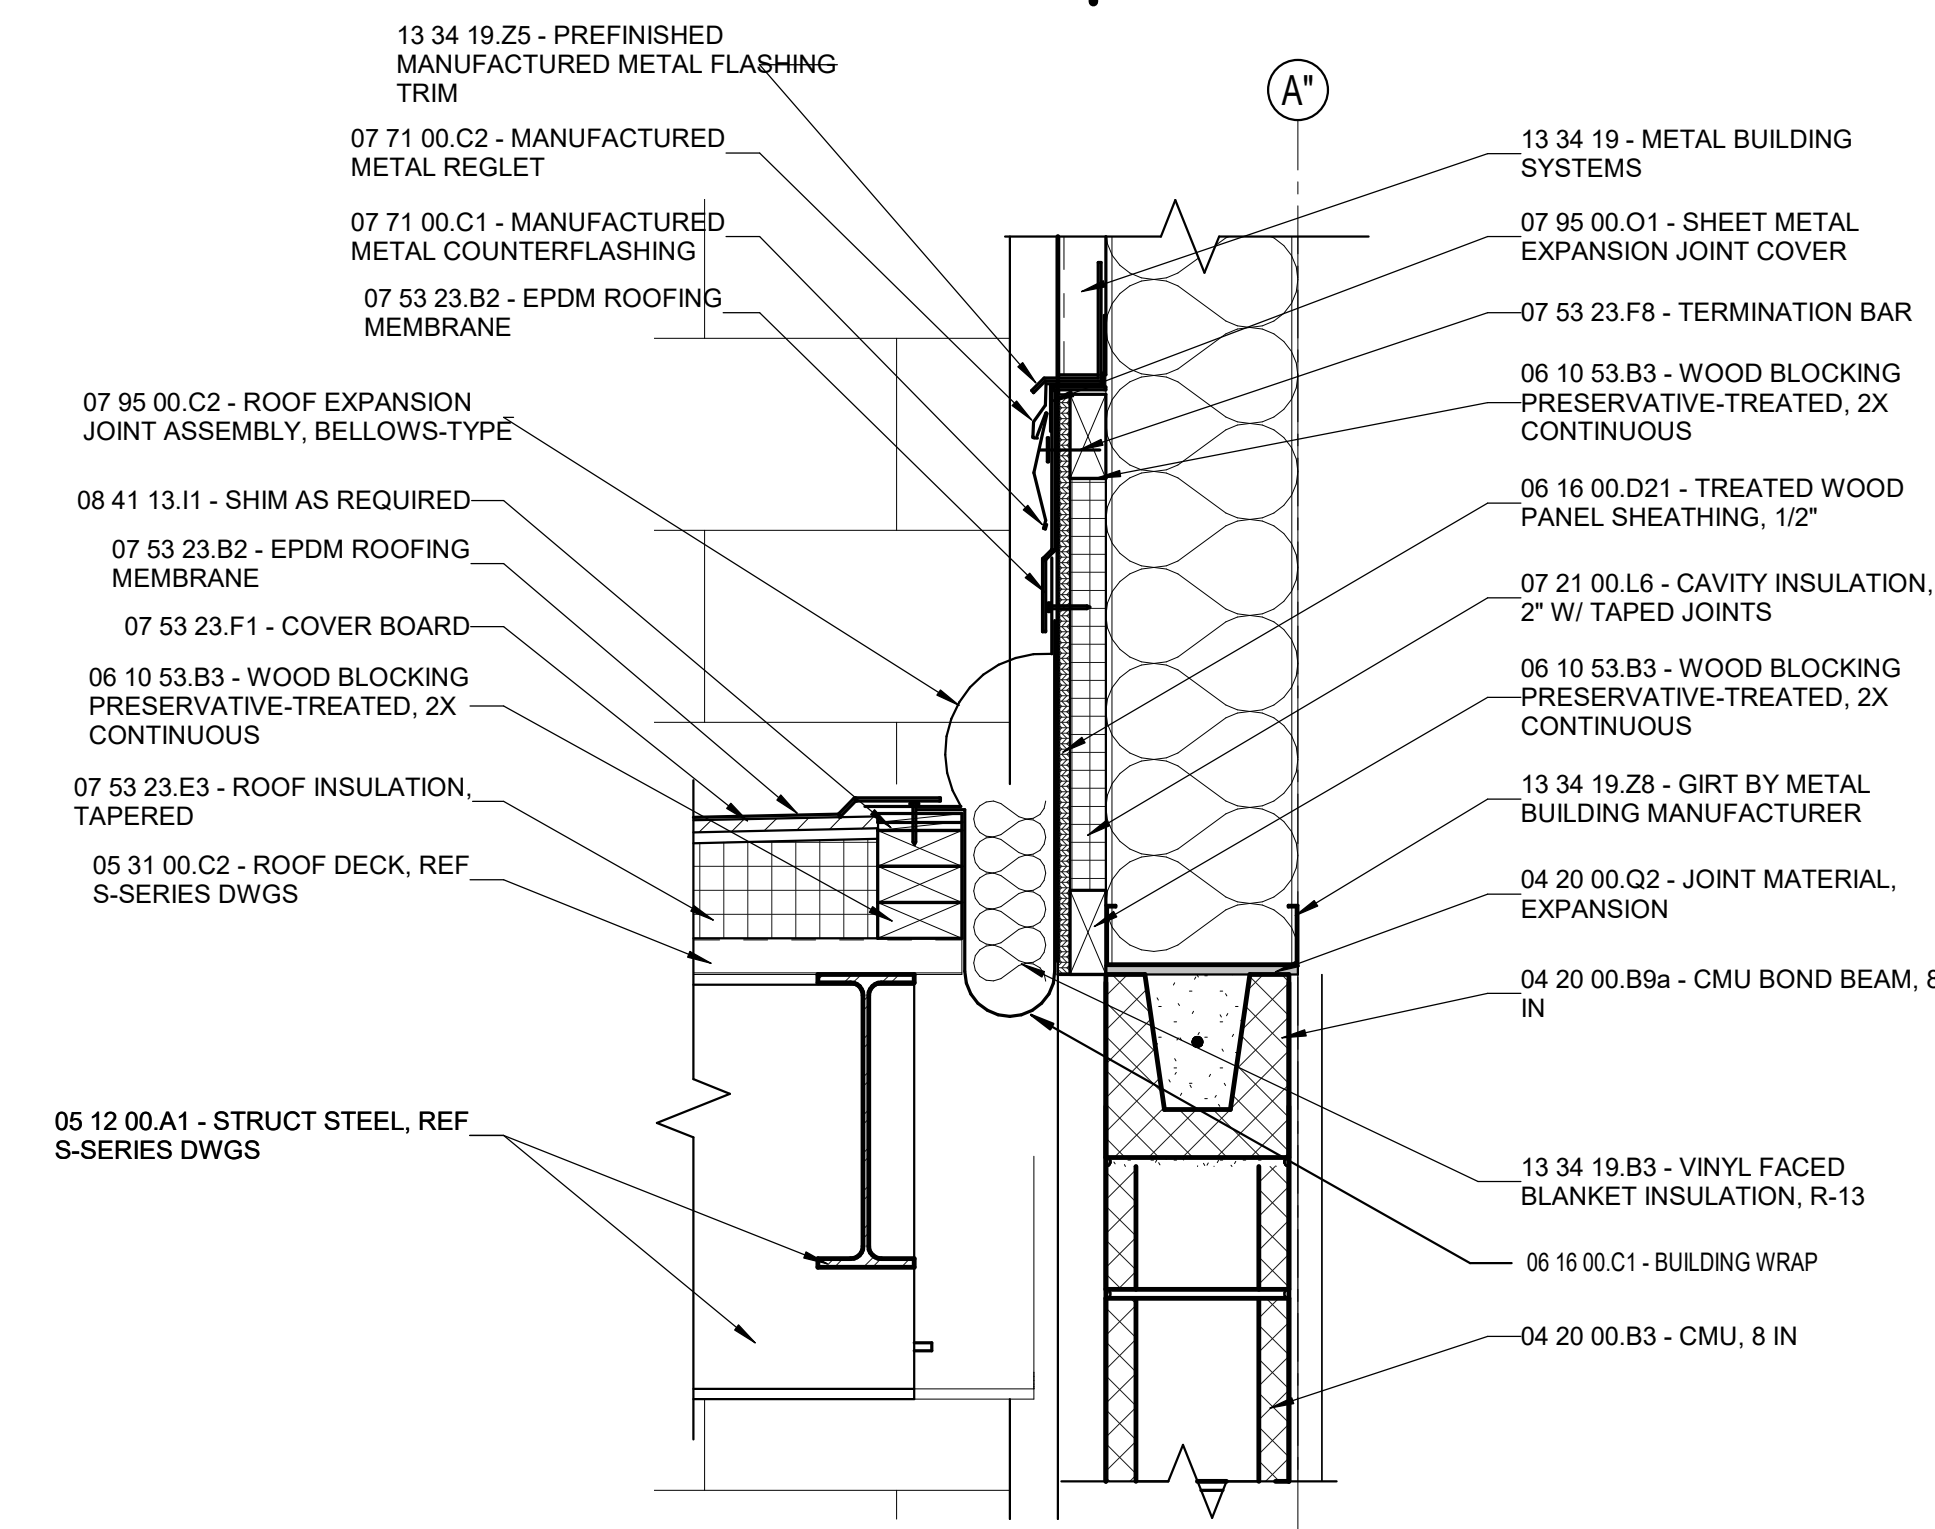
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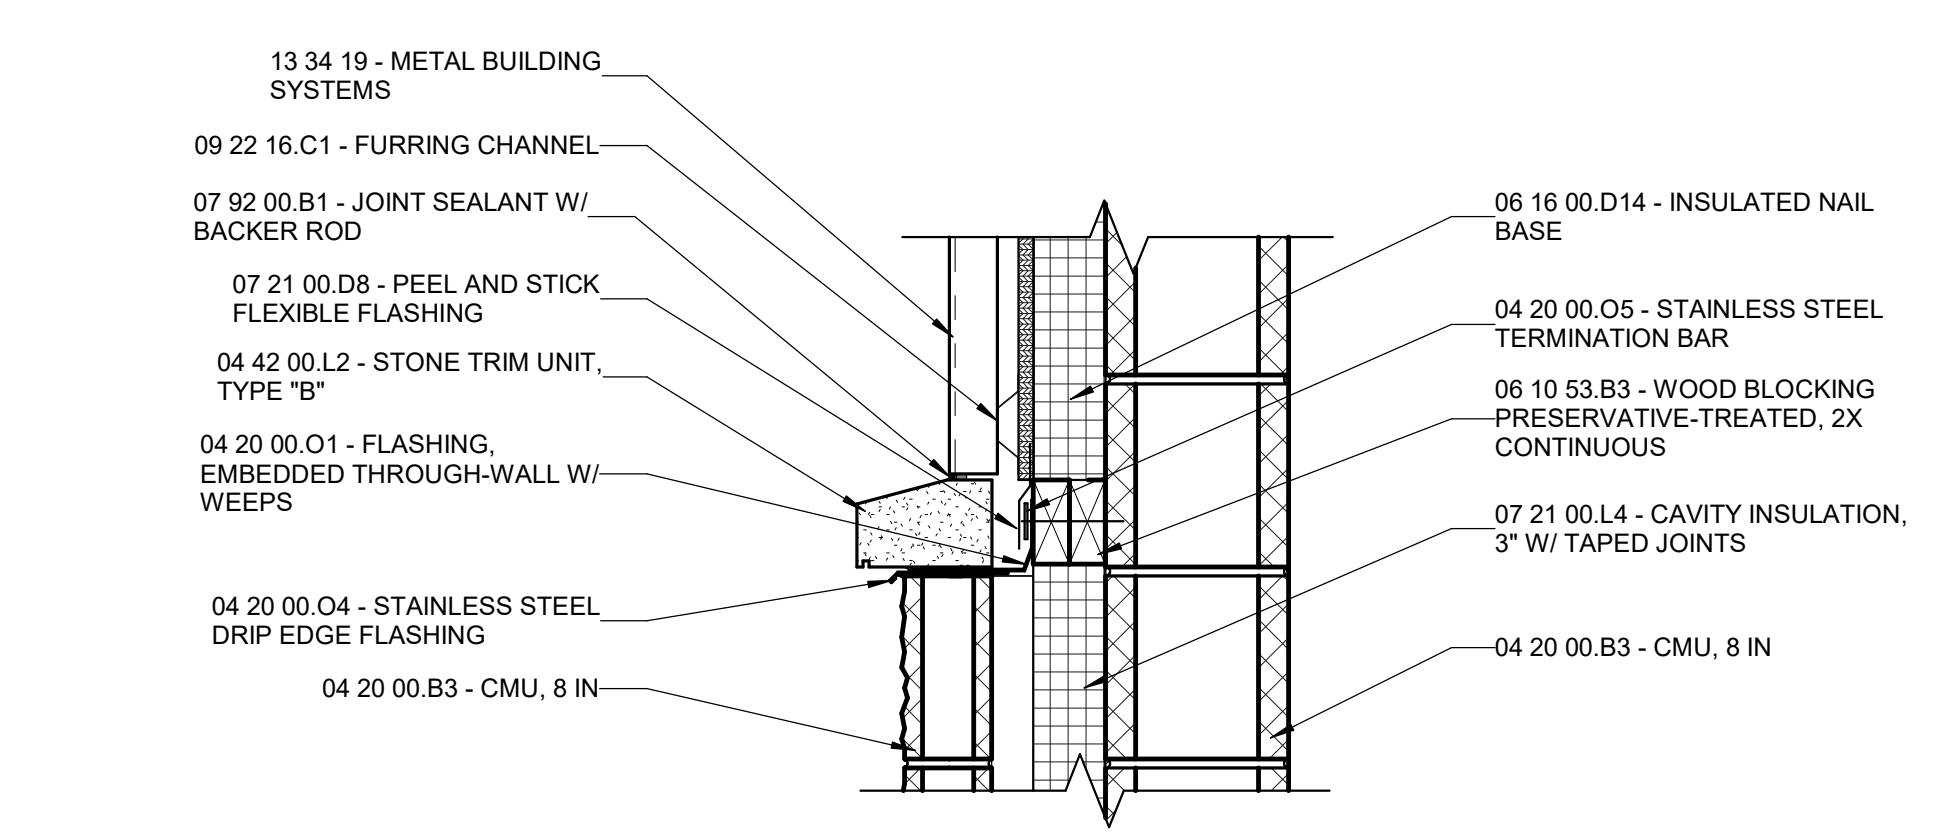
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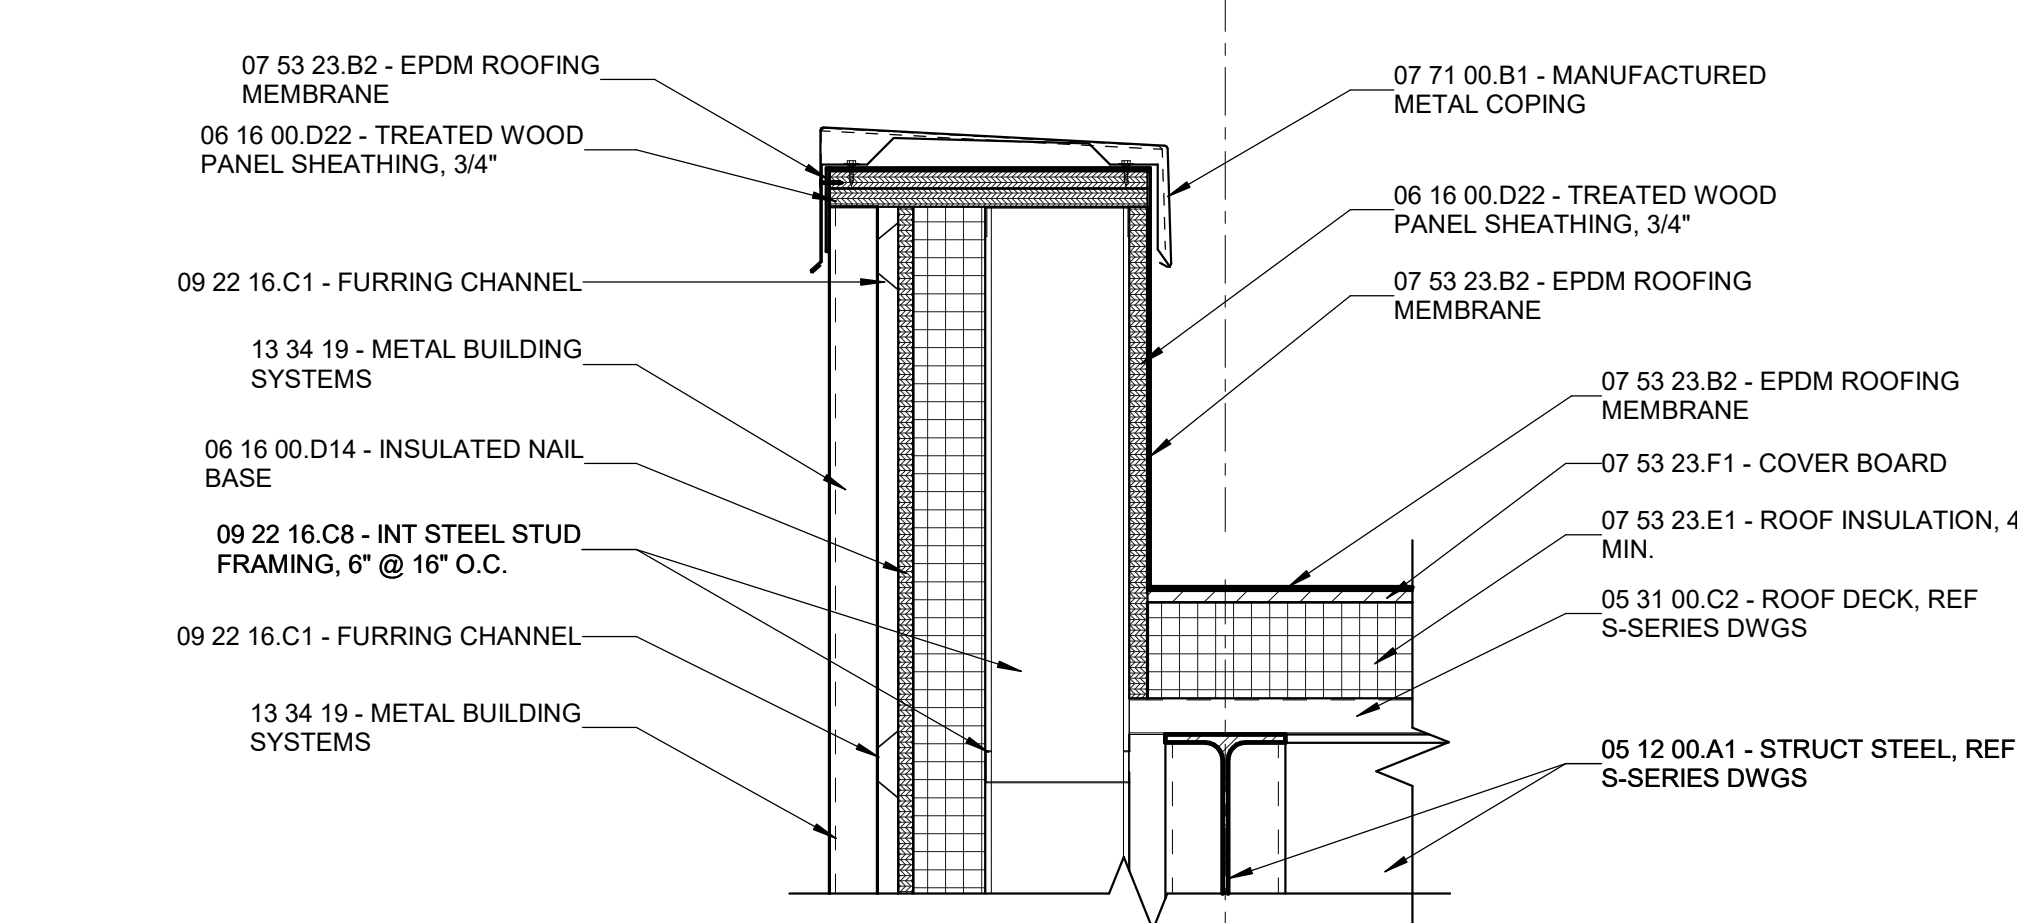
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**5E WALL SECTION DETAIL 13.2.1**  
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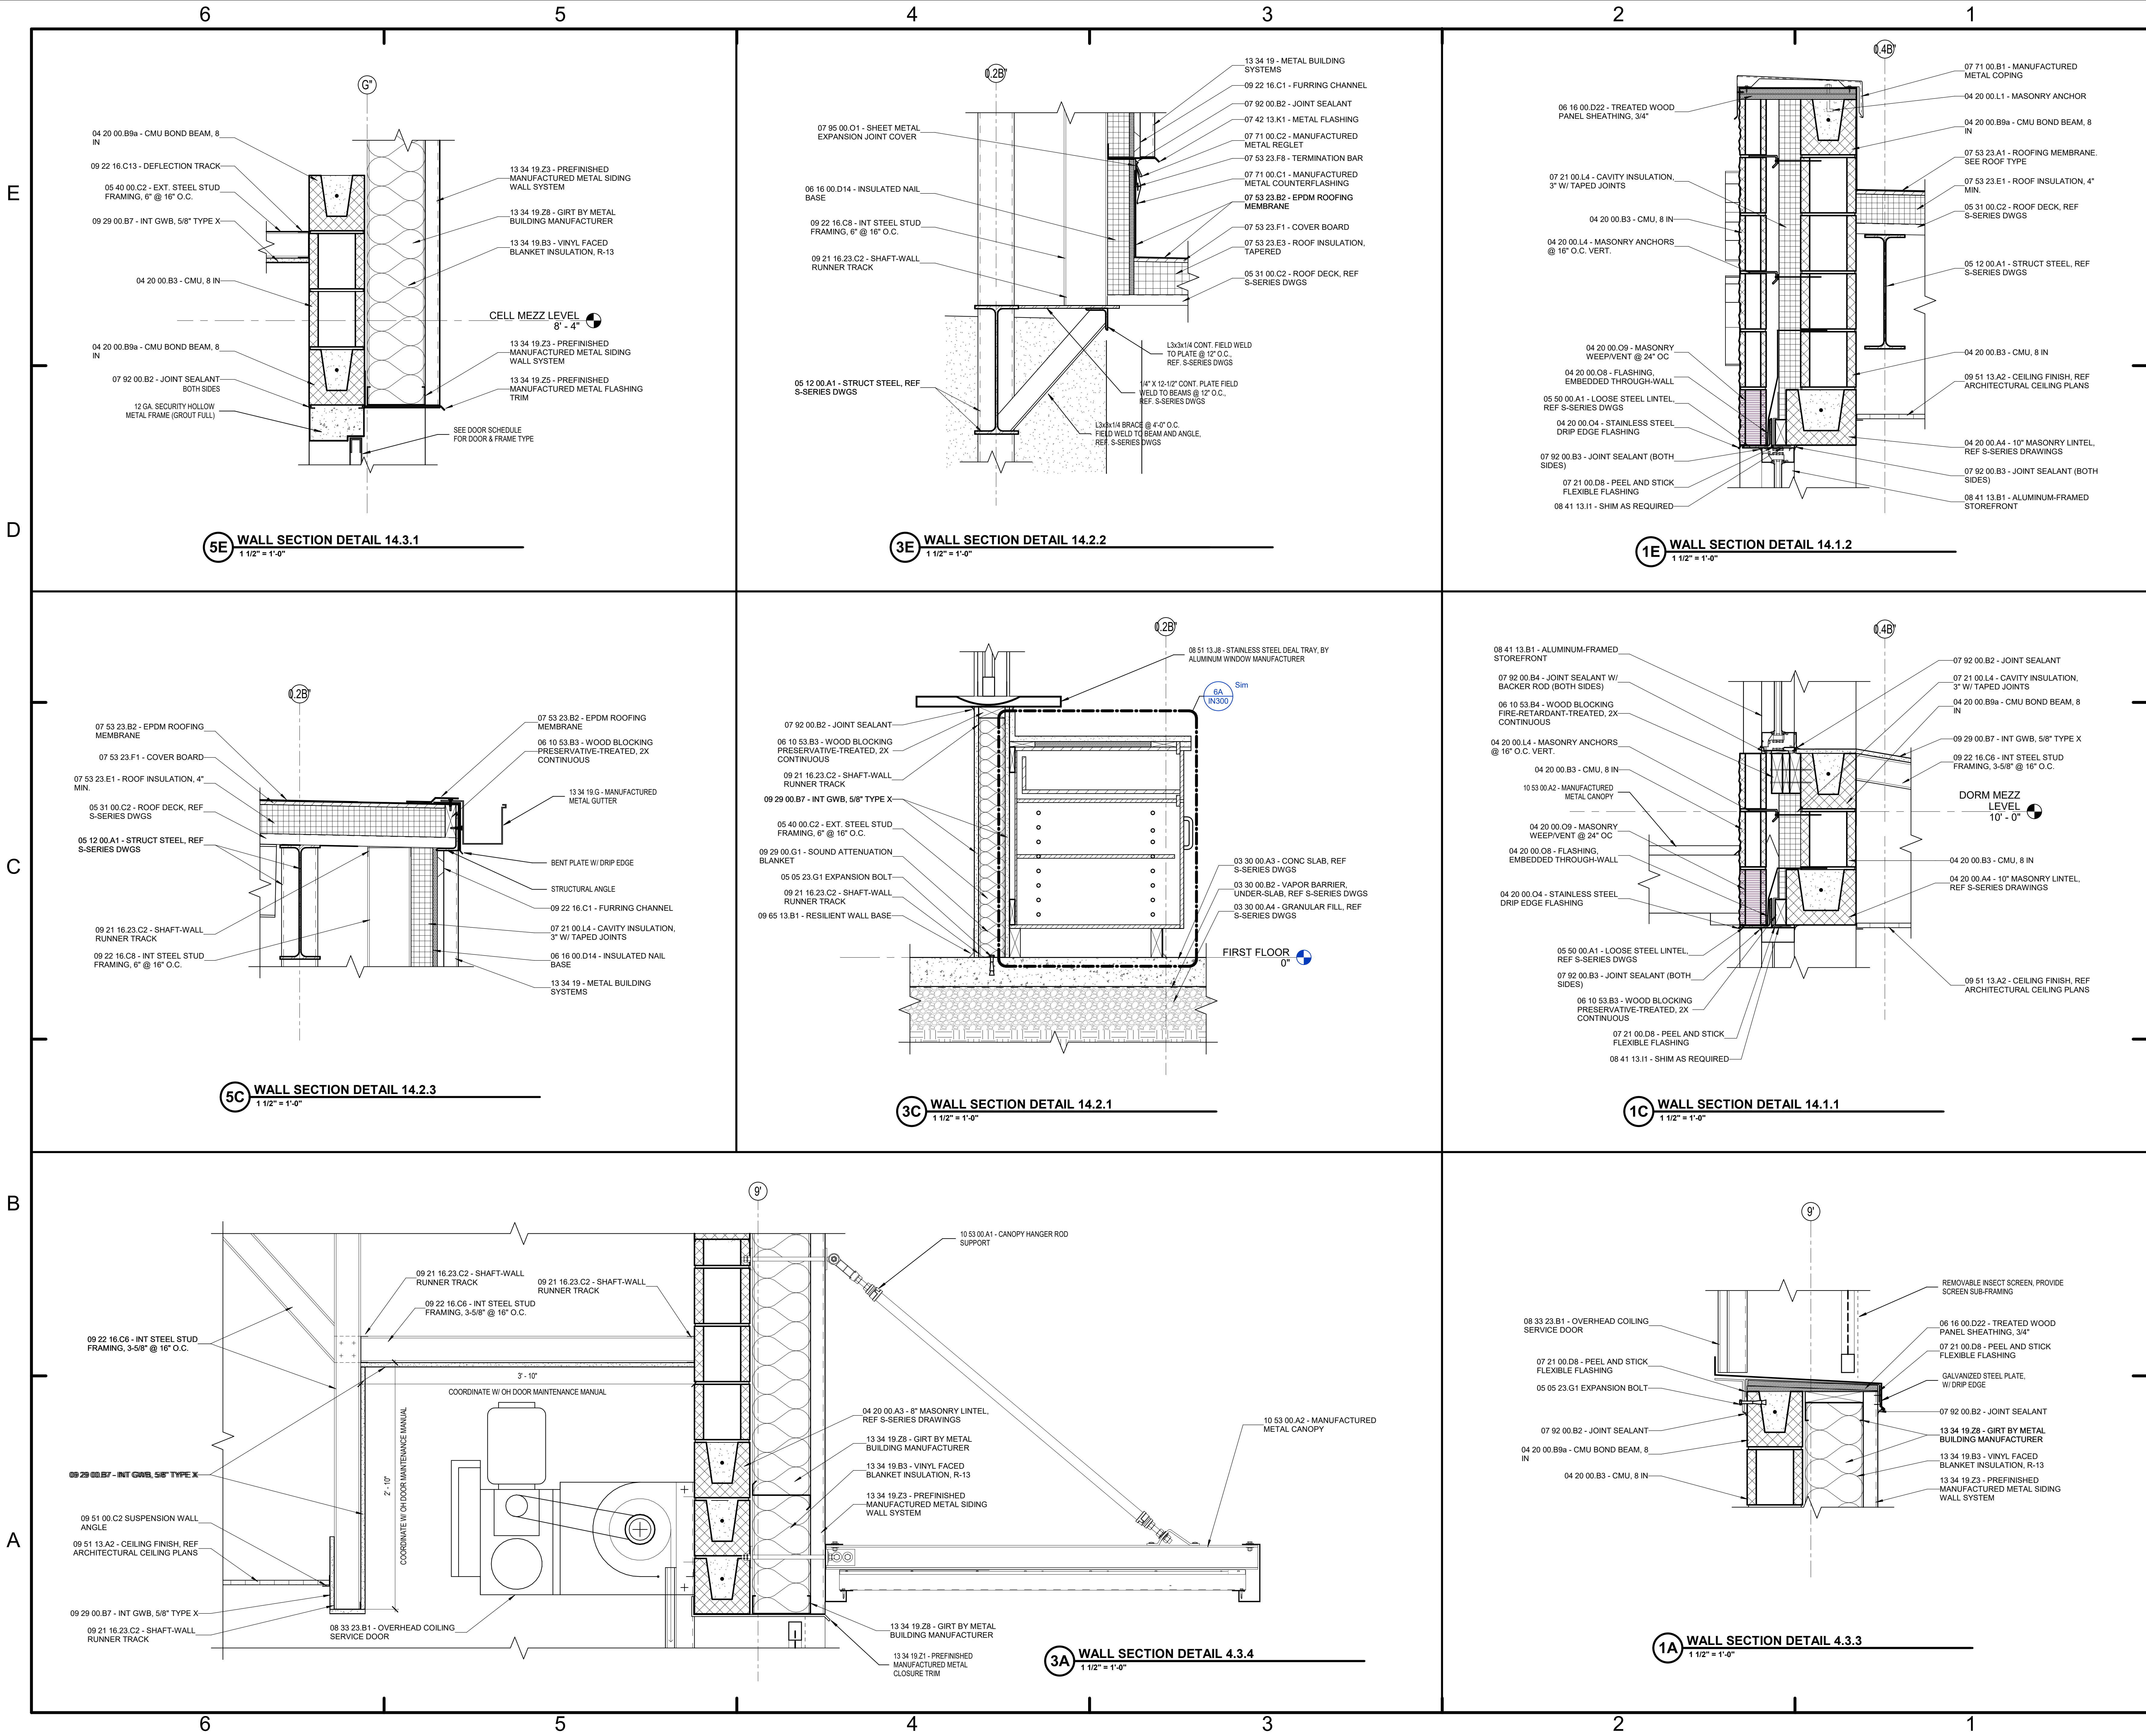


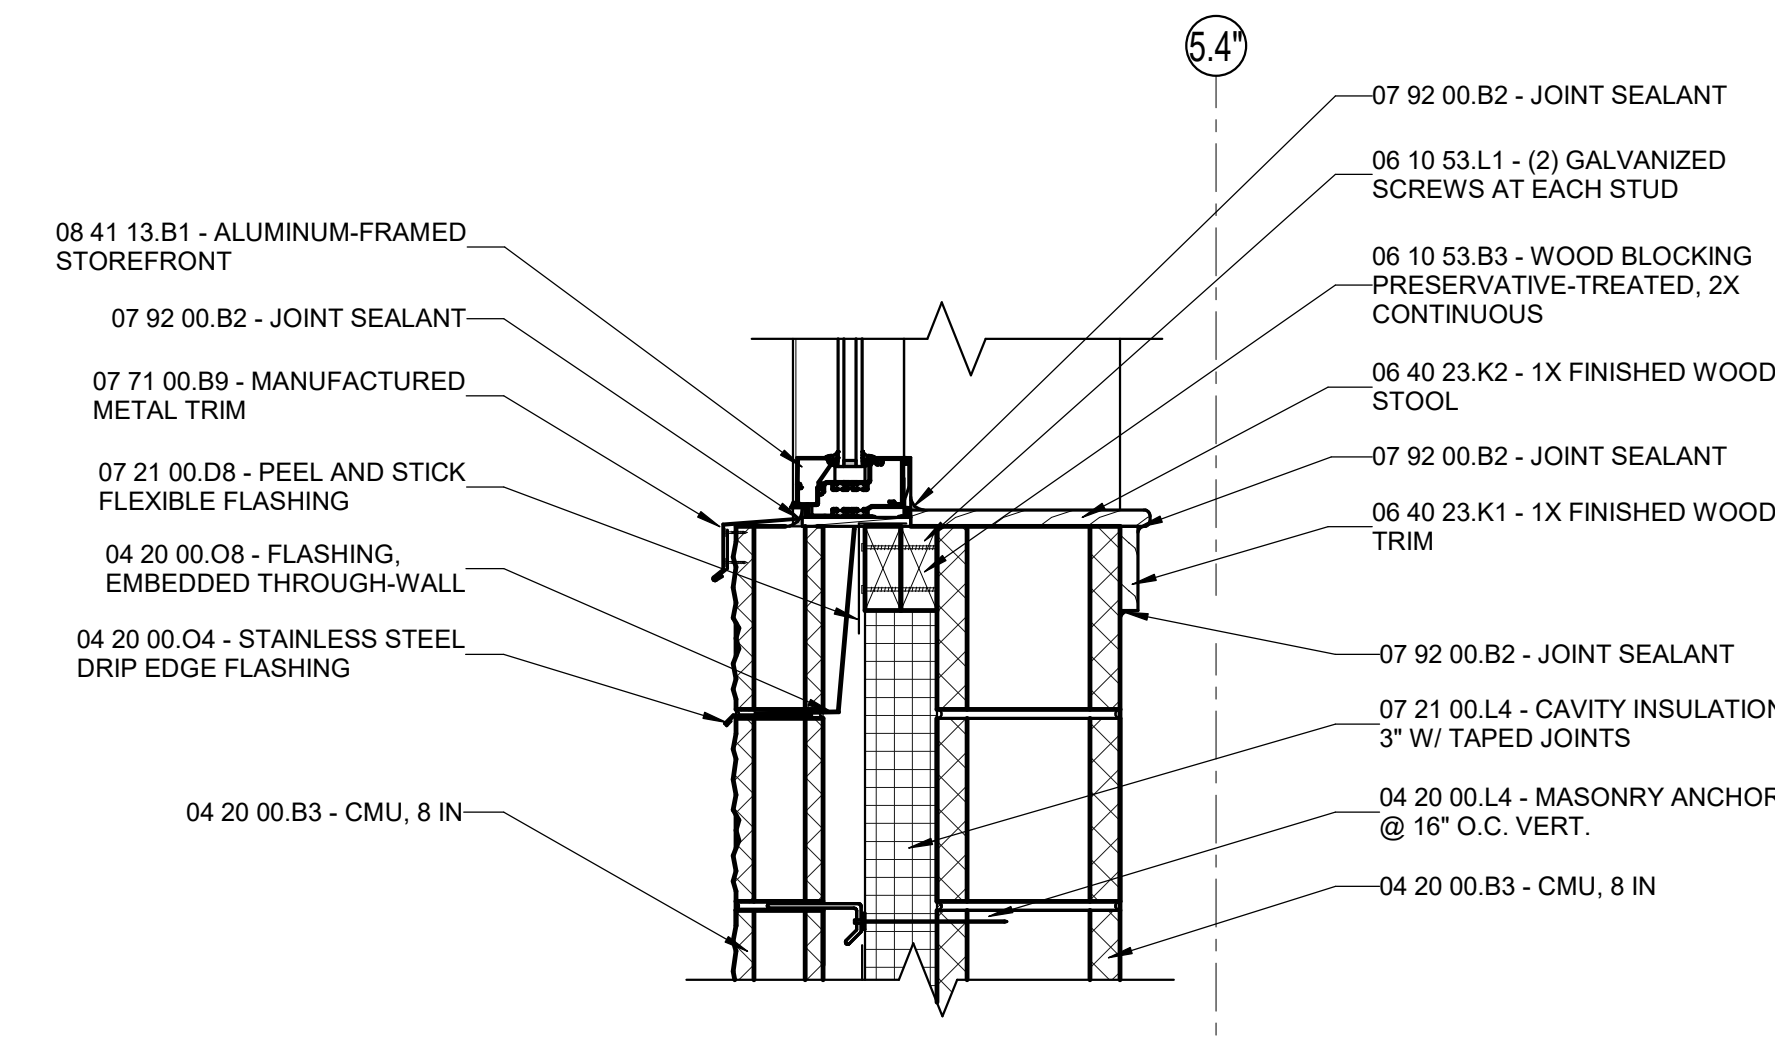**5C WALL SECTION DETAIL 13.1.1**  
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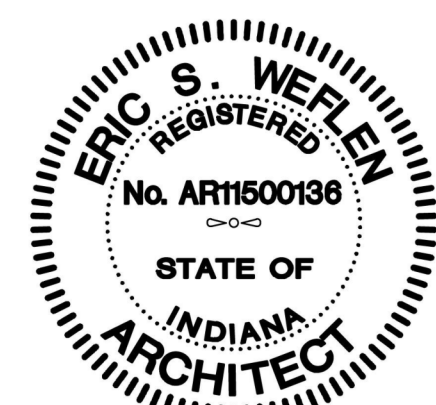
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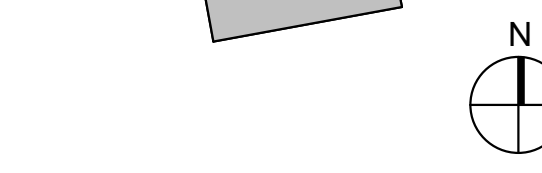
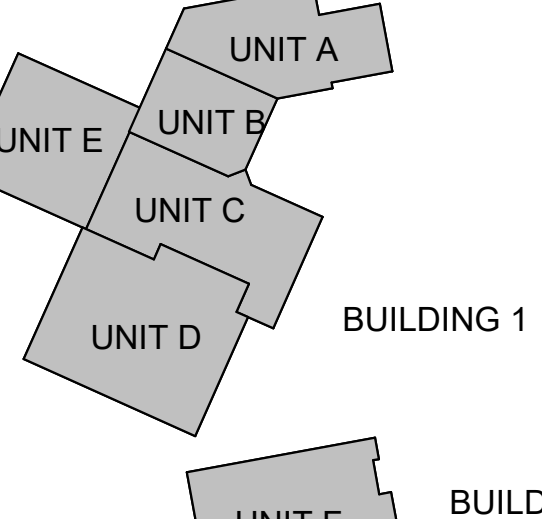
#	Revision	Date
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Project #: 20-700-151-2  
Designed By: Designer  
Drawn By: Author  
Checked By: Checker  
Date: 02.04.2022

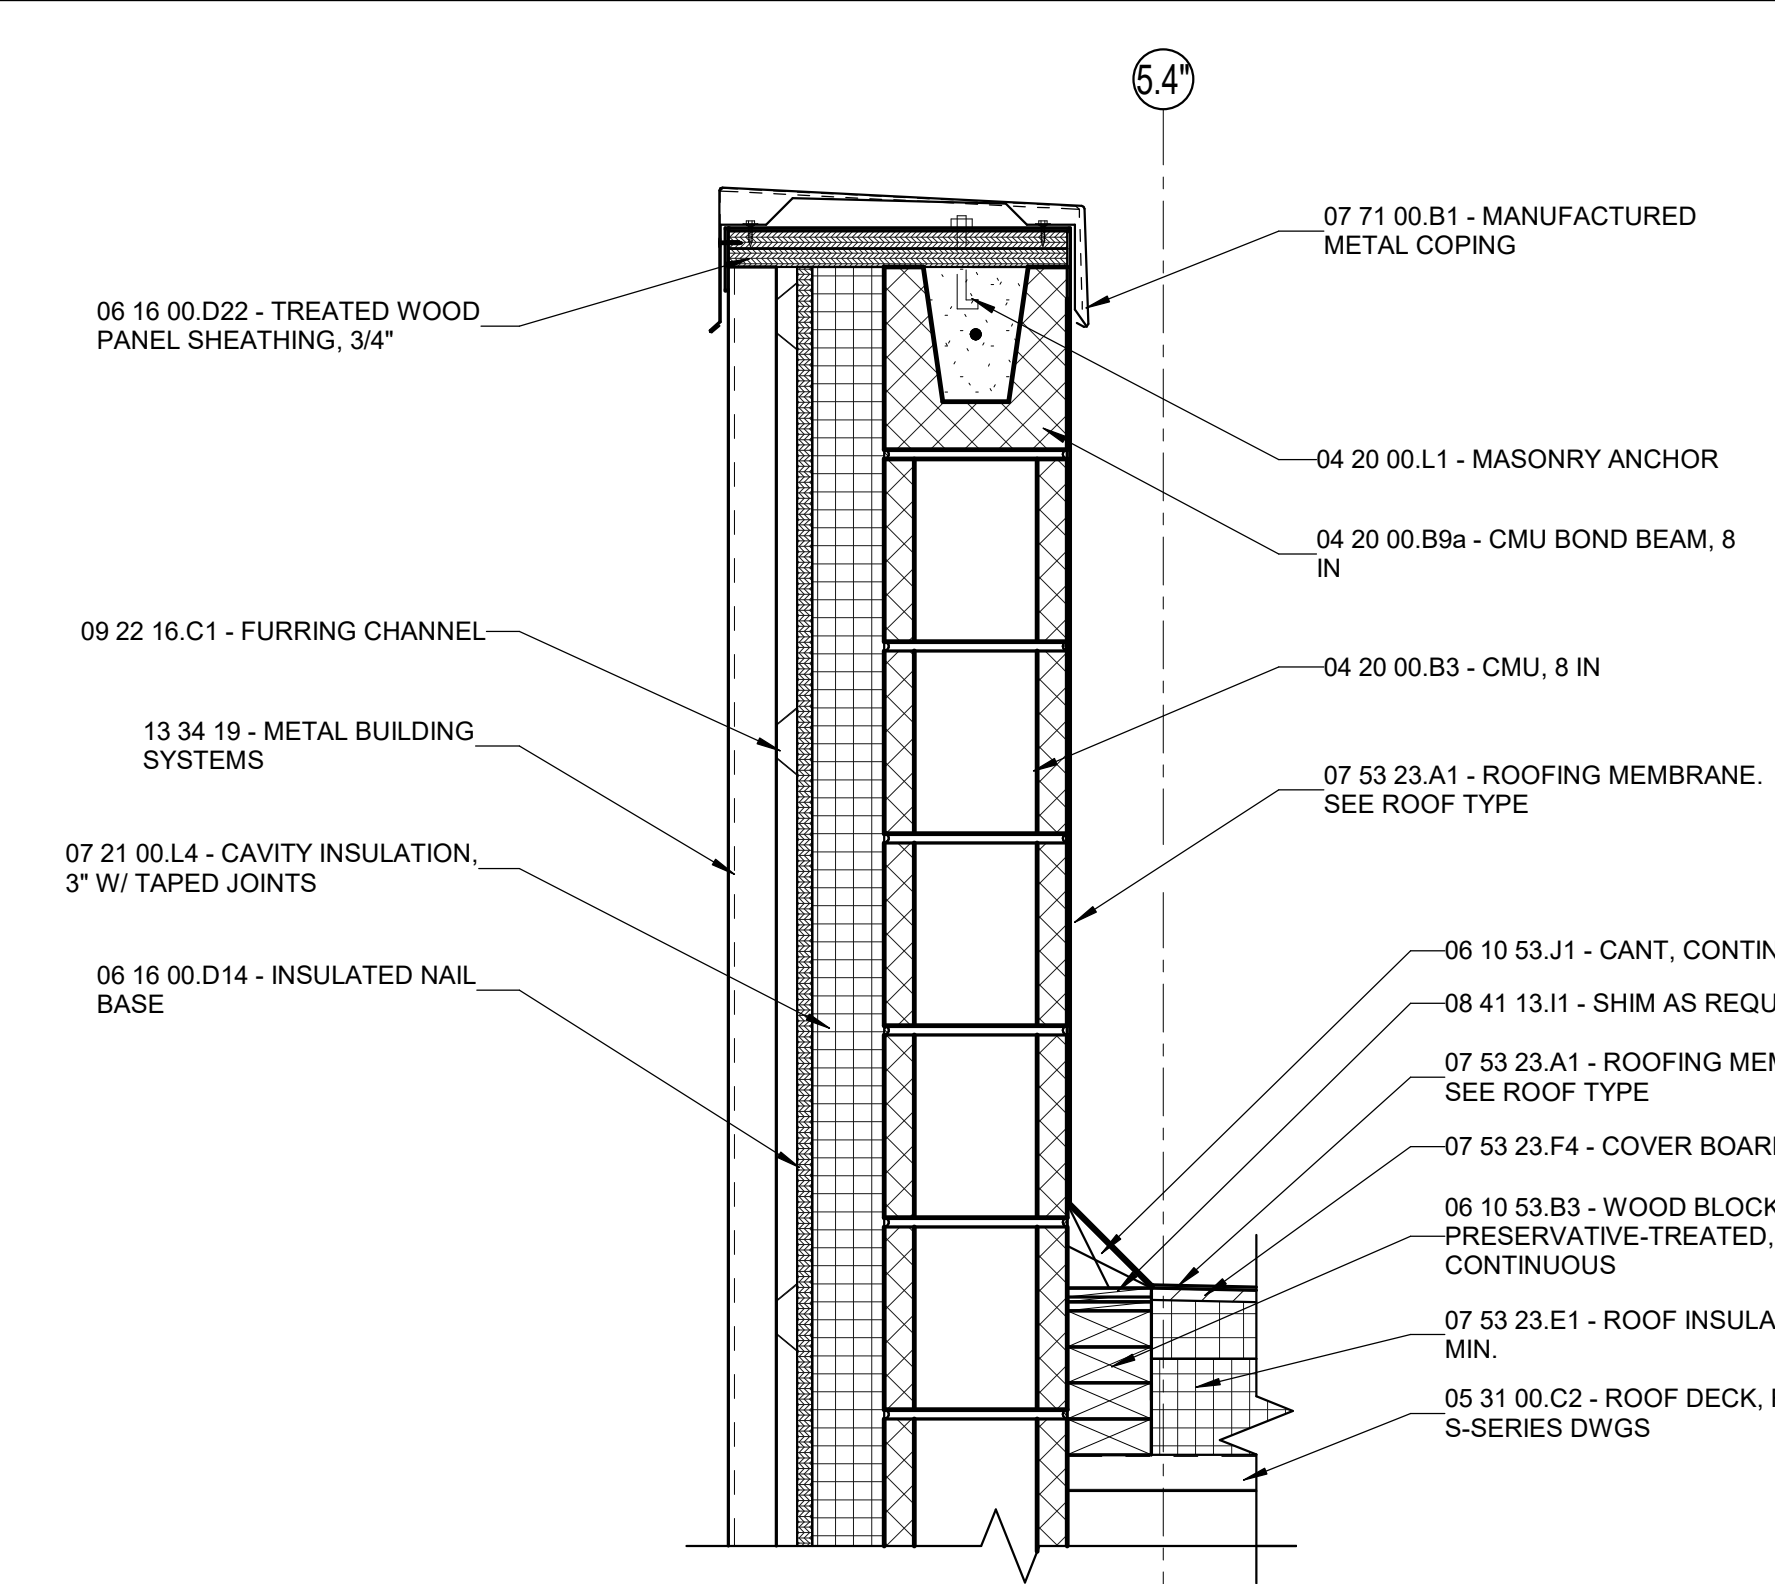


Eric Weisenborn

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WALL SECTION DETAILS

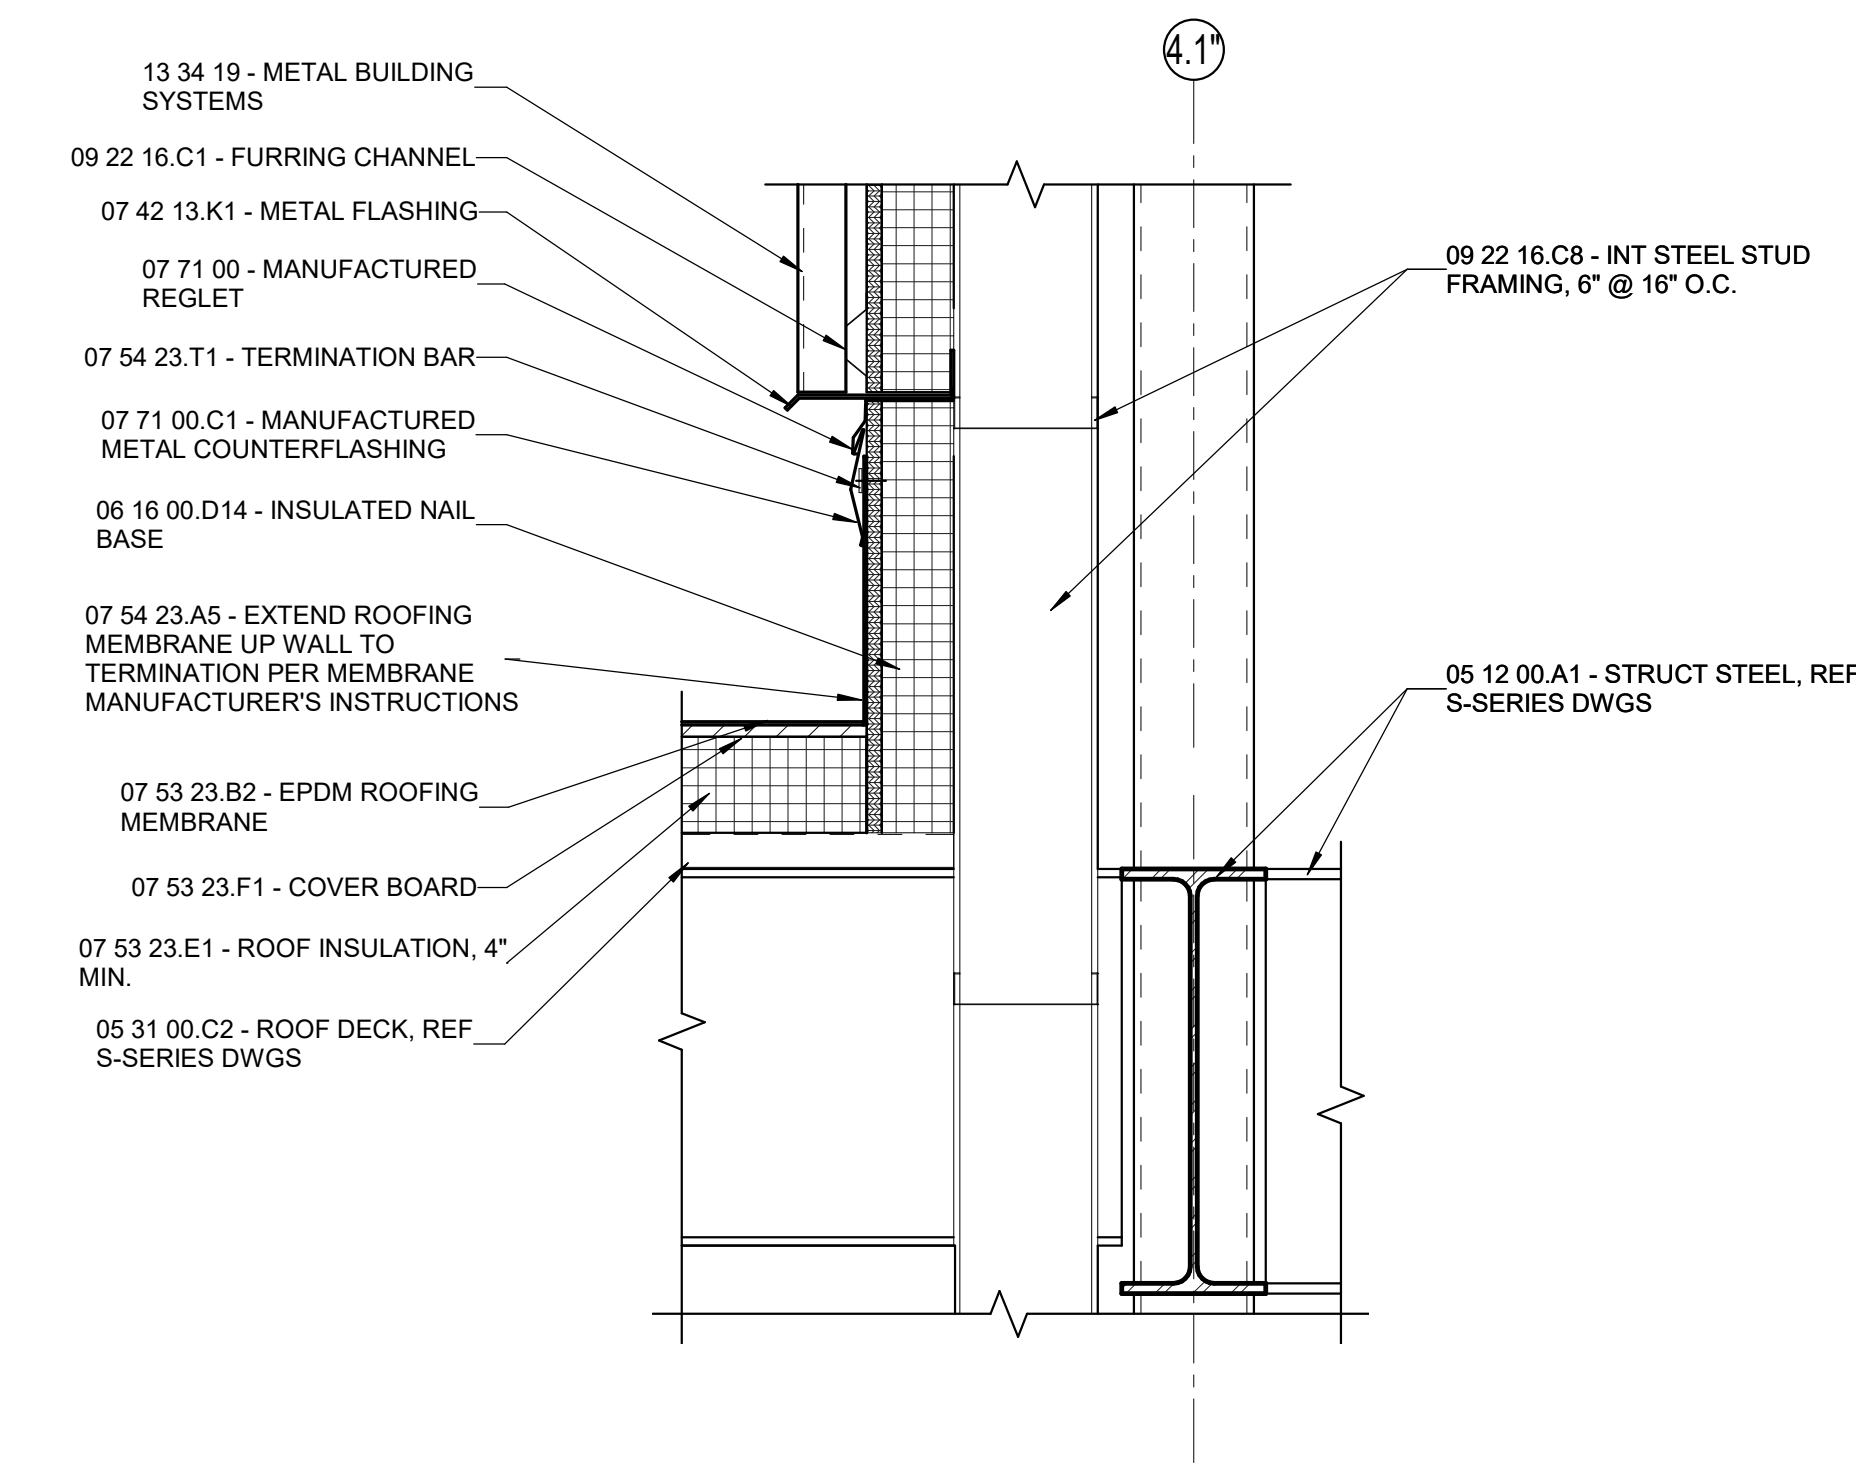




#	Revision	Date
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Project #: 20-700-151-2  
Designed By: Designer  
Drawn By: Author  
Checked By: Checker  
Date: 02.04.2022

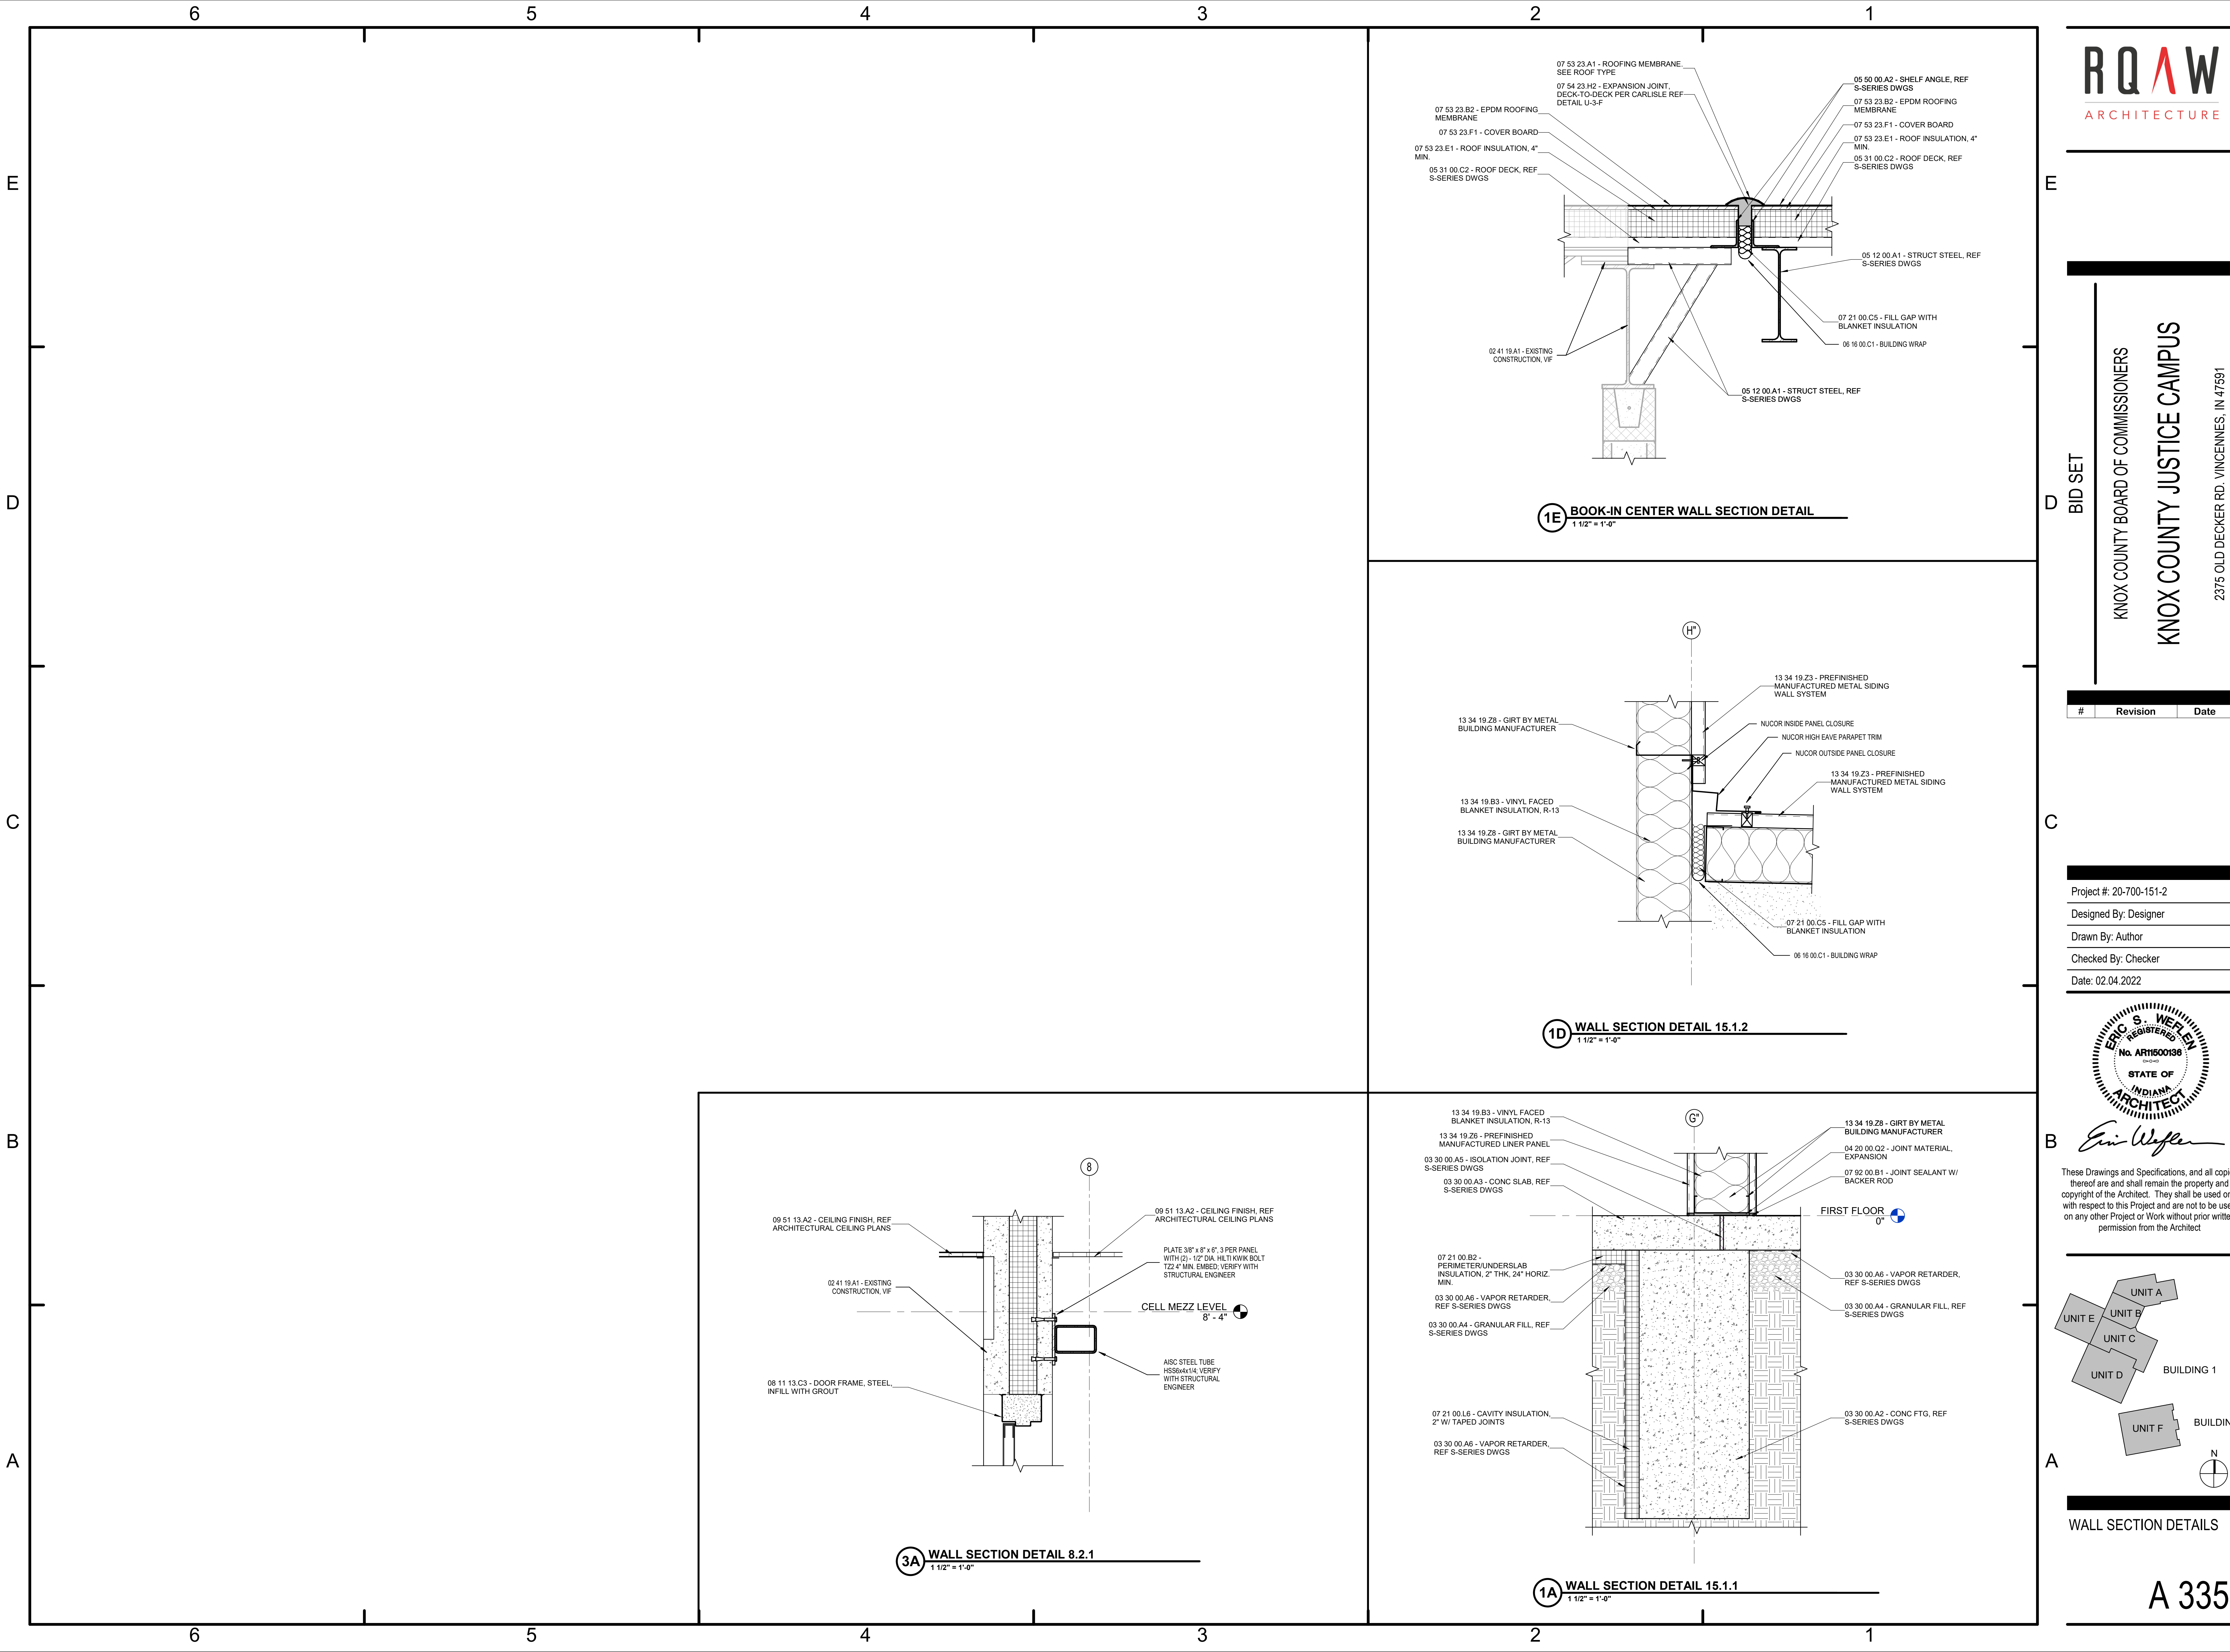

Eric Weyler

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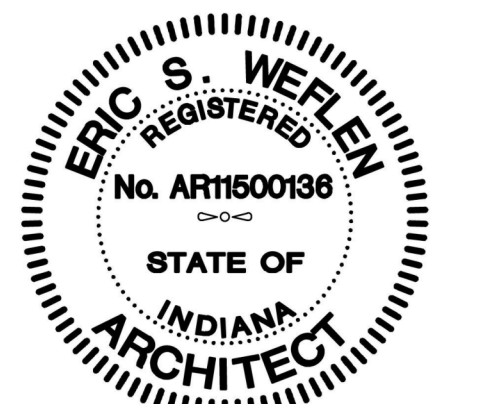


WALL SECTION DETAILS

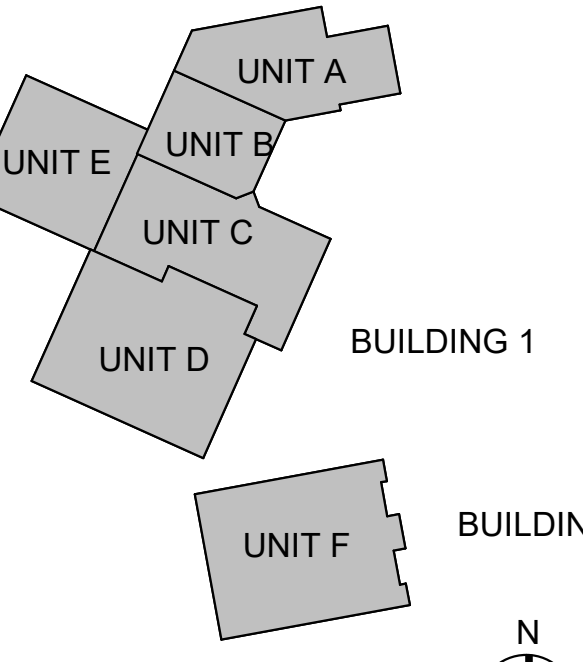


#	Revision	Date
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Project #: 20-700-151-2  
Designed By: LD  
Drawn By: WD  
Checked By: LD/IV  
Date: 01.28.2022


















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ENLARGED STAIR PLANS  
AND DETAILS


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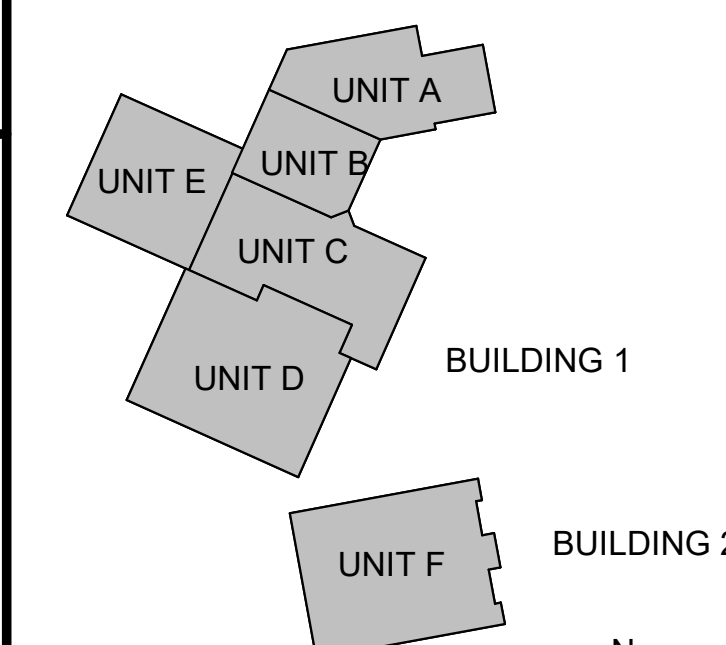

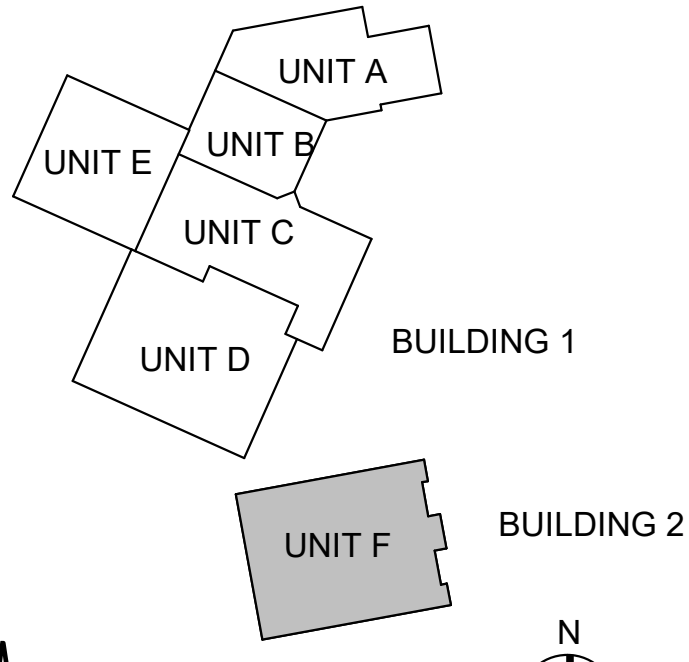
#	Revision	Date
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Project #: 20-700-151-2  
Designed By: Designer  
Drawn By: Author  
Checked By: Checker  
Date: 01.28.2022

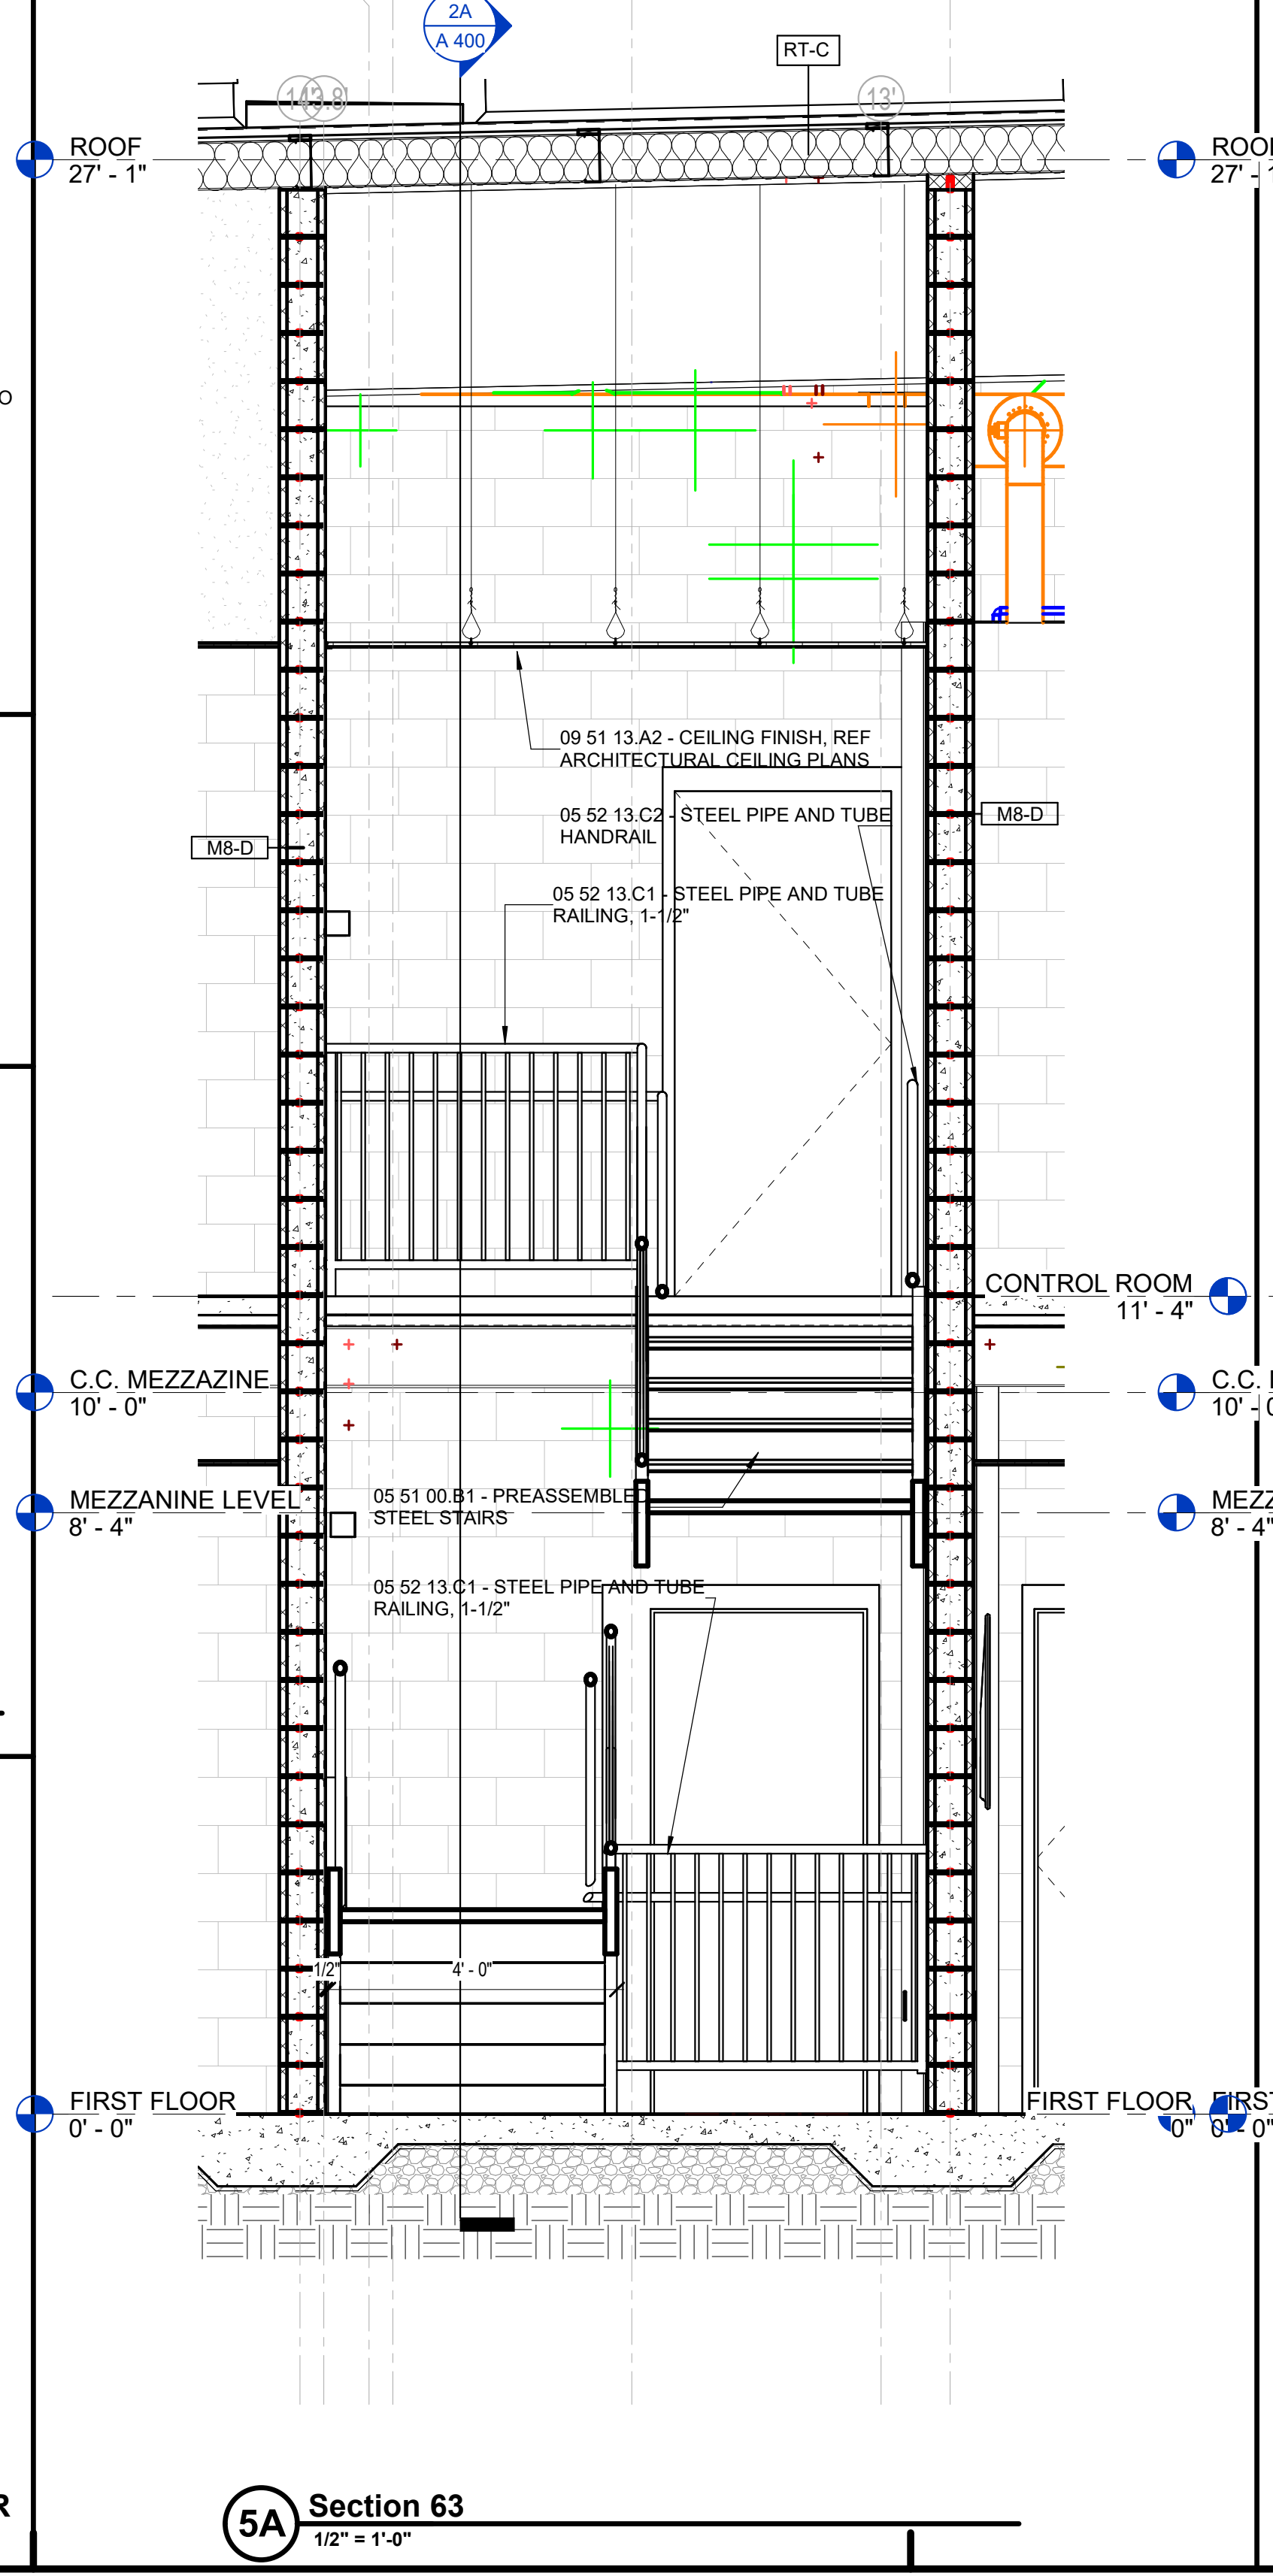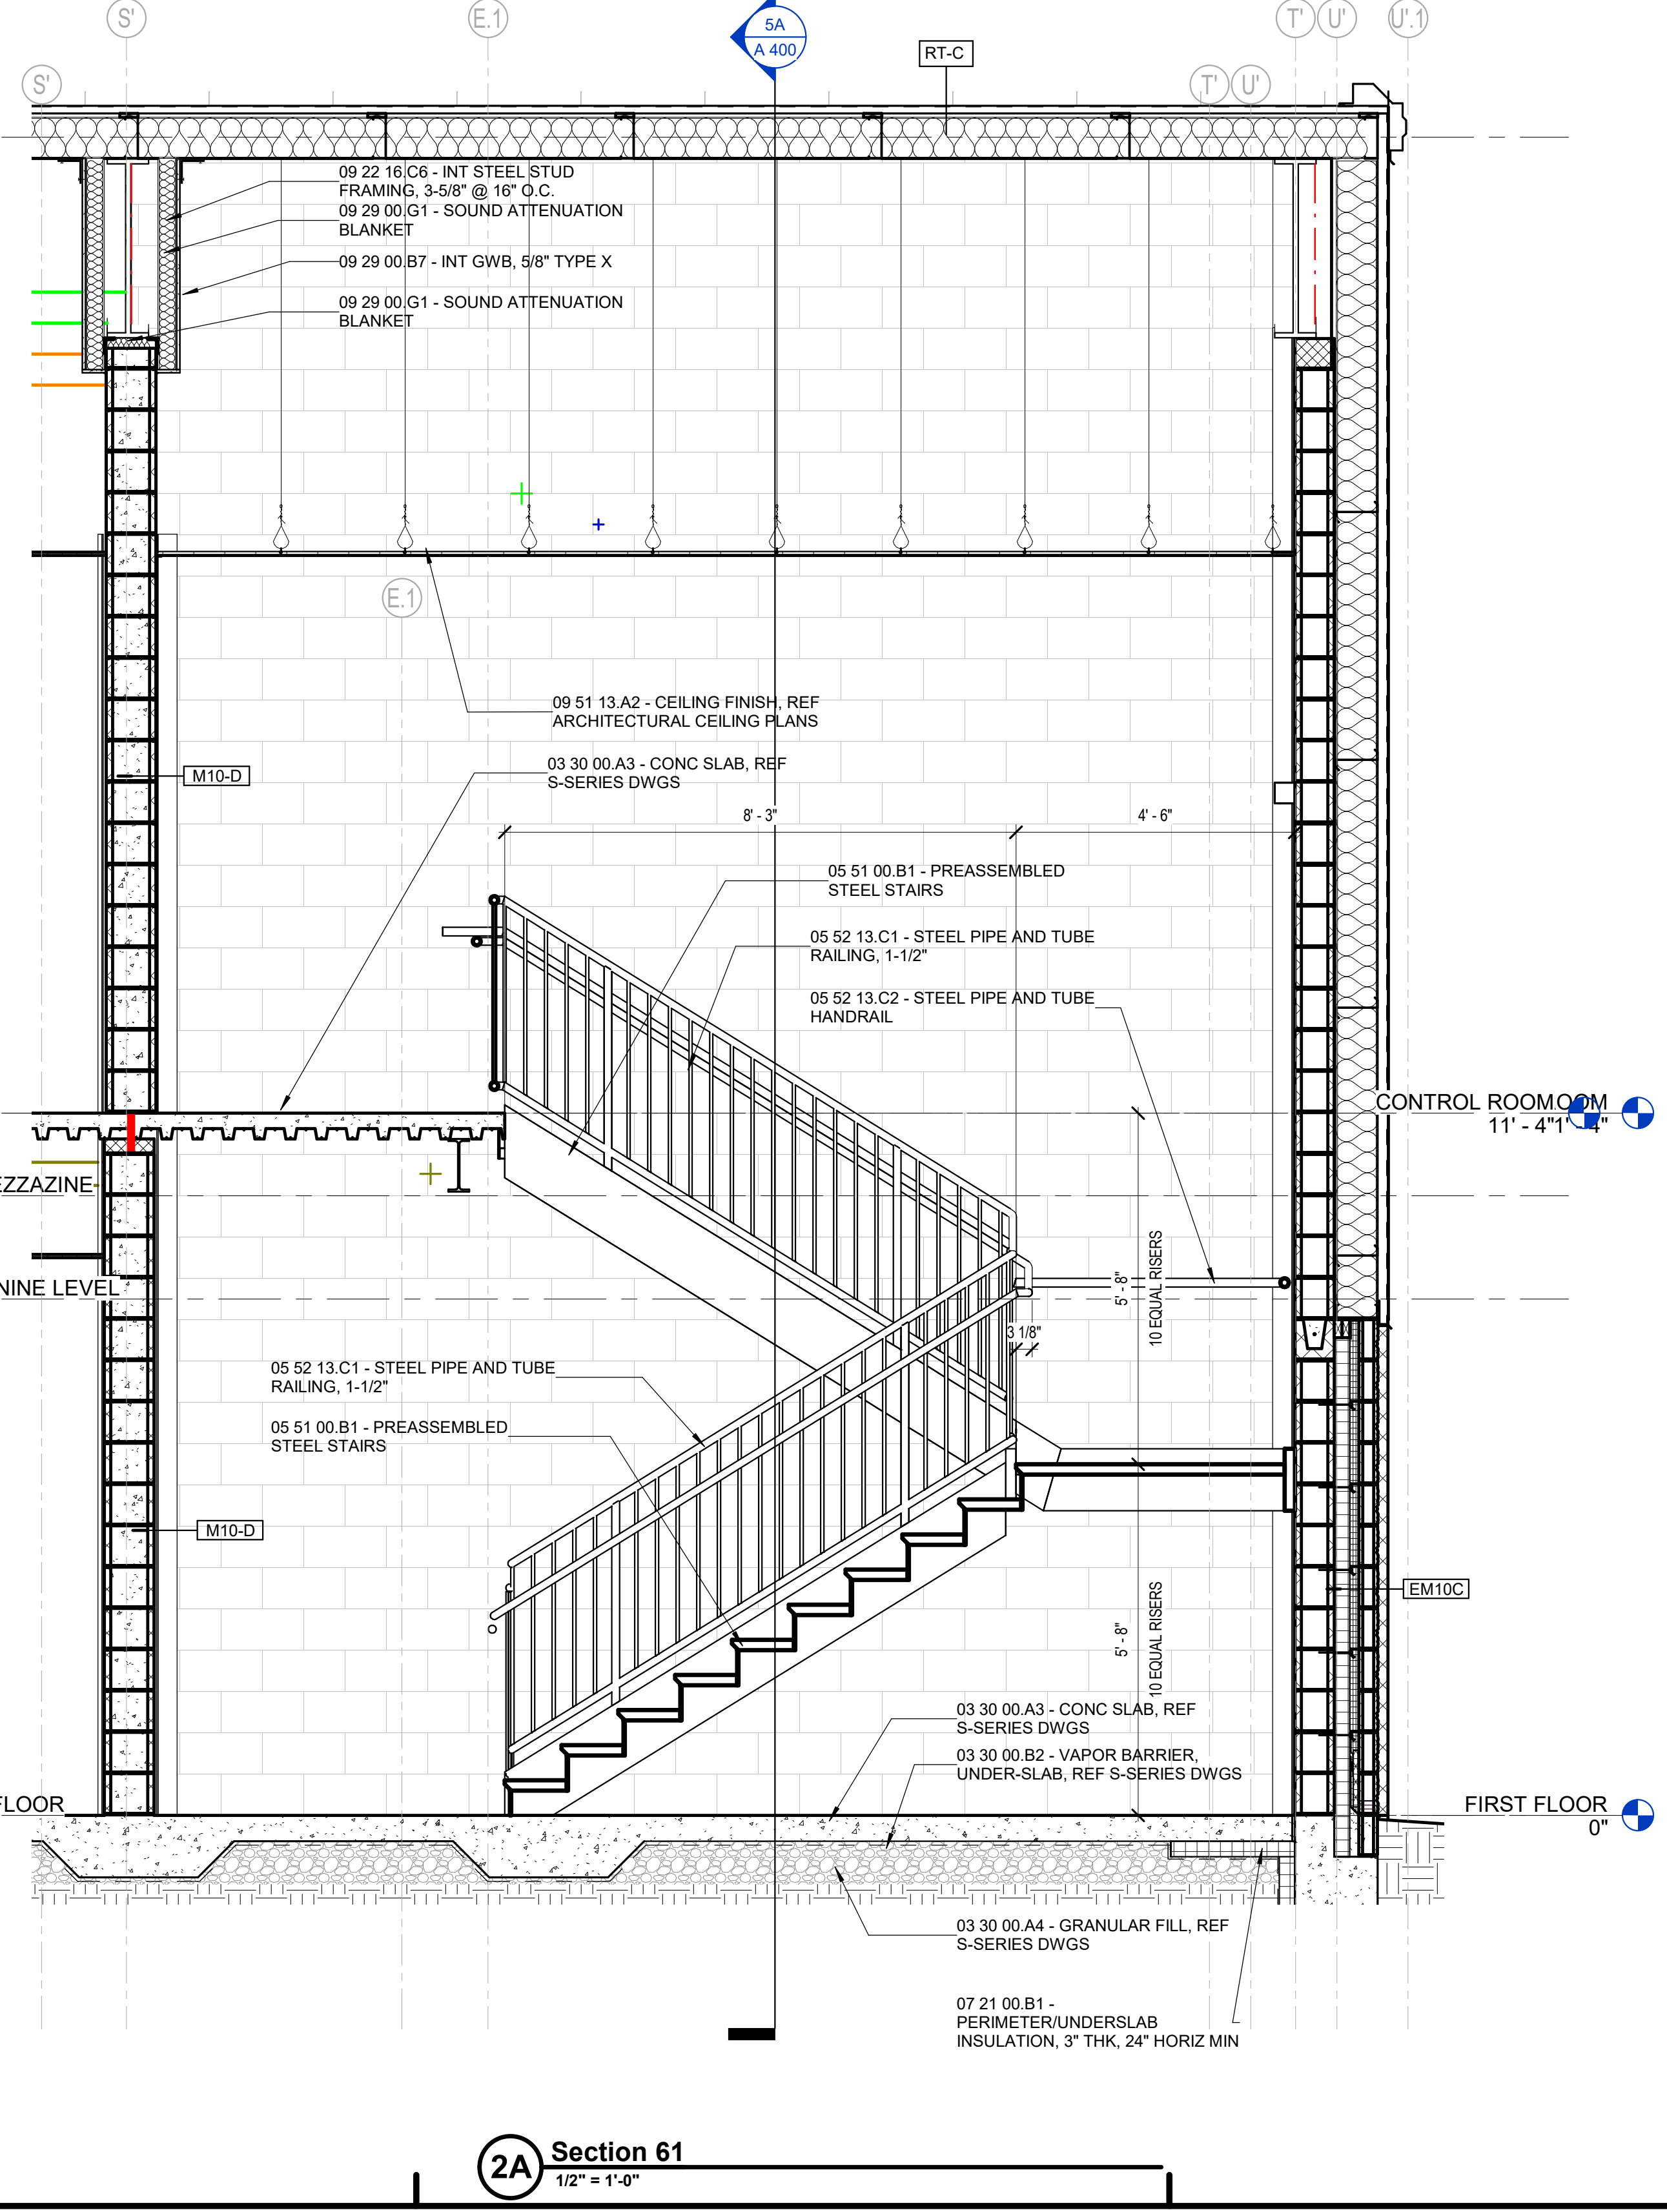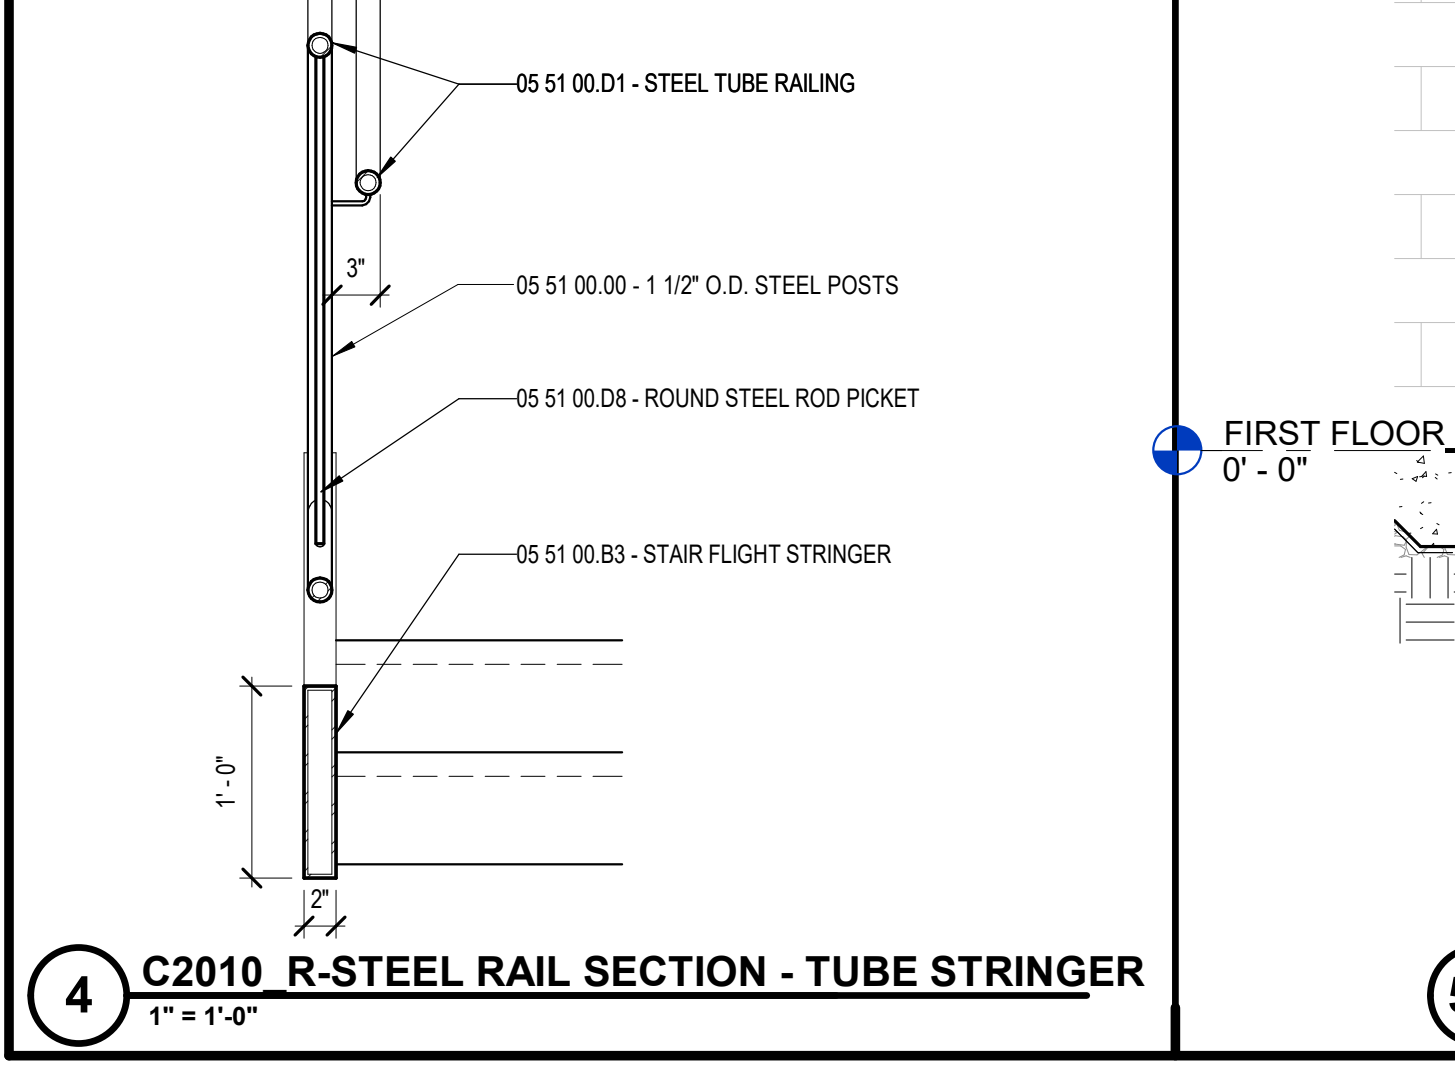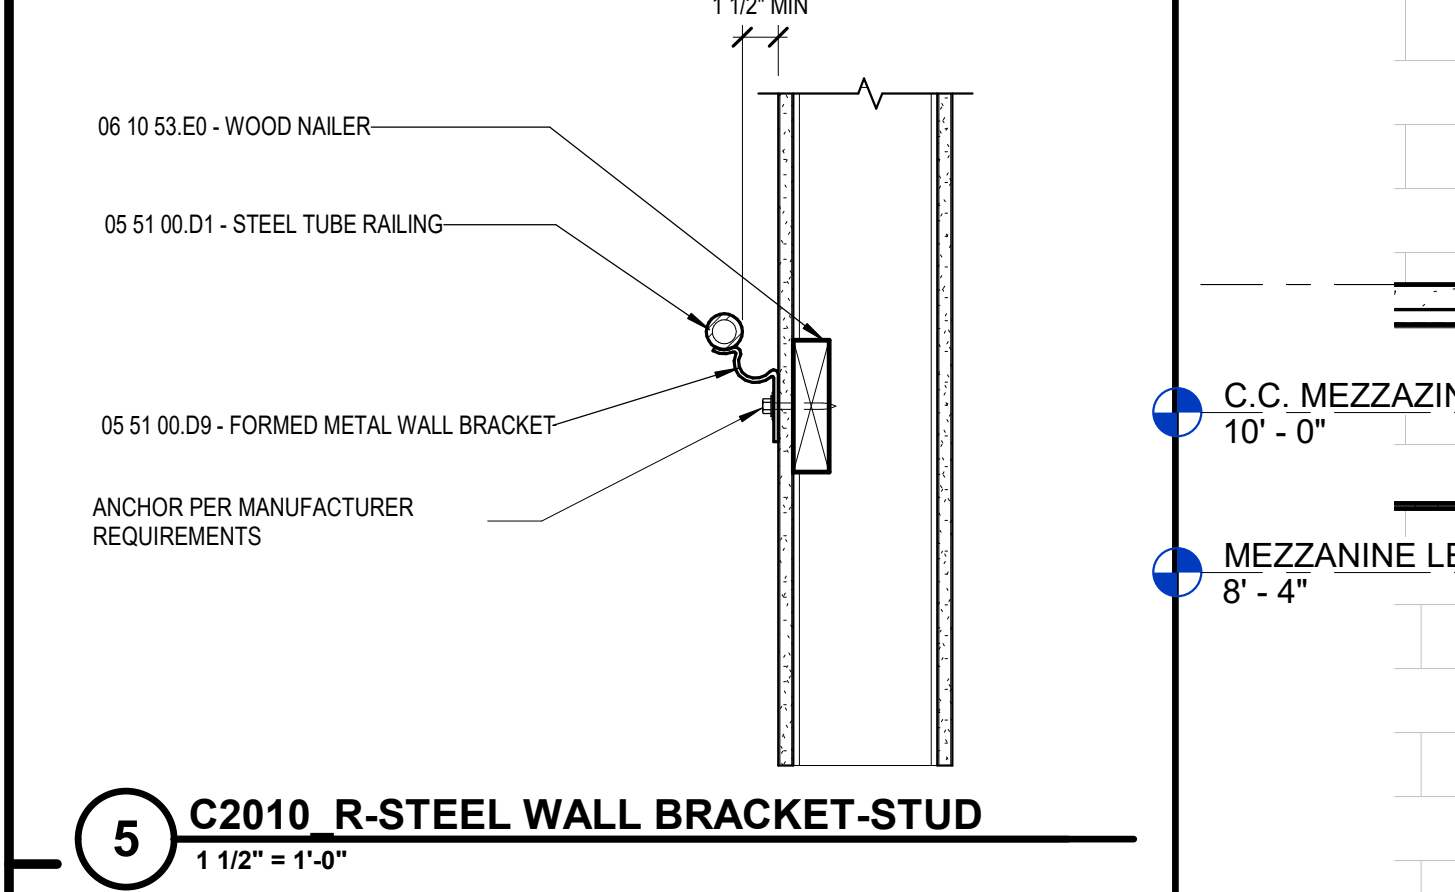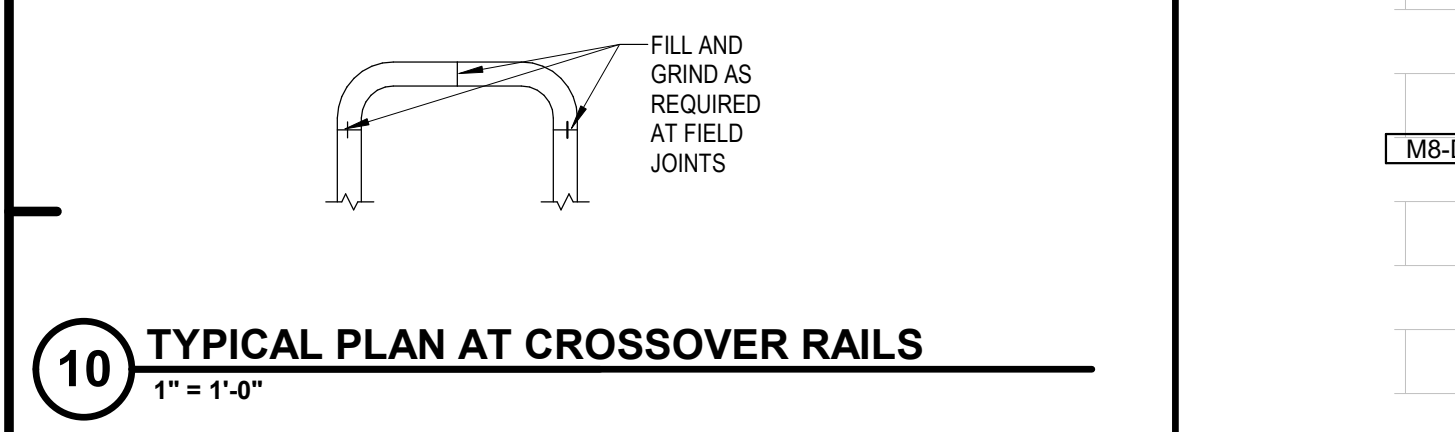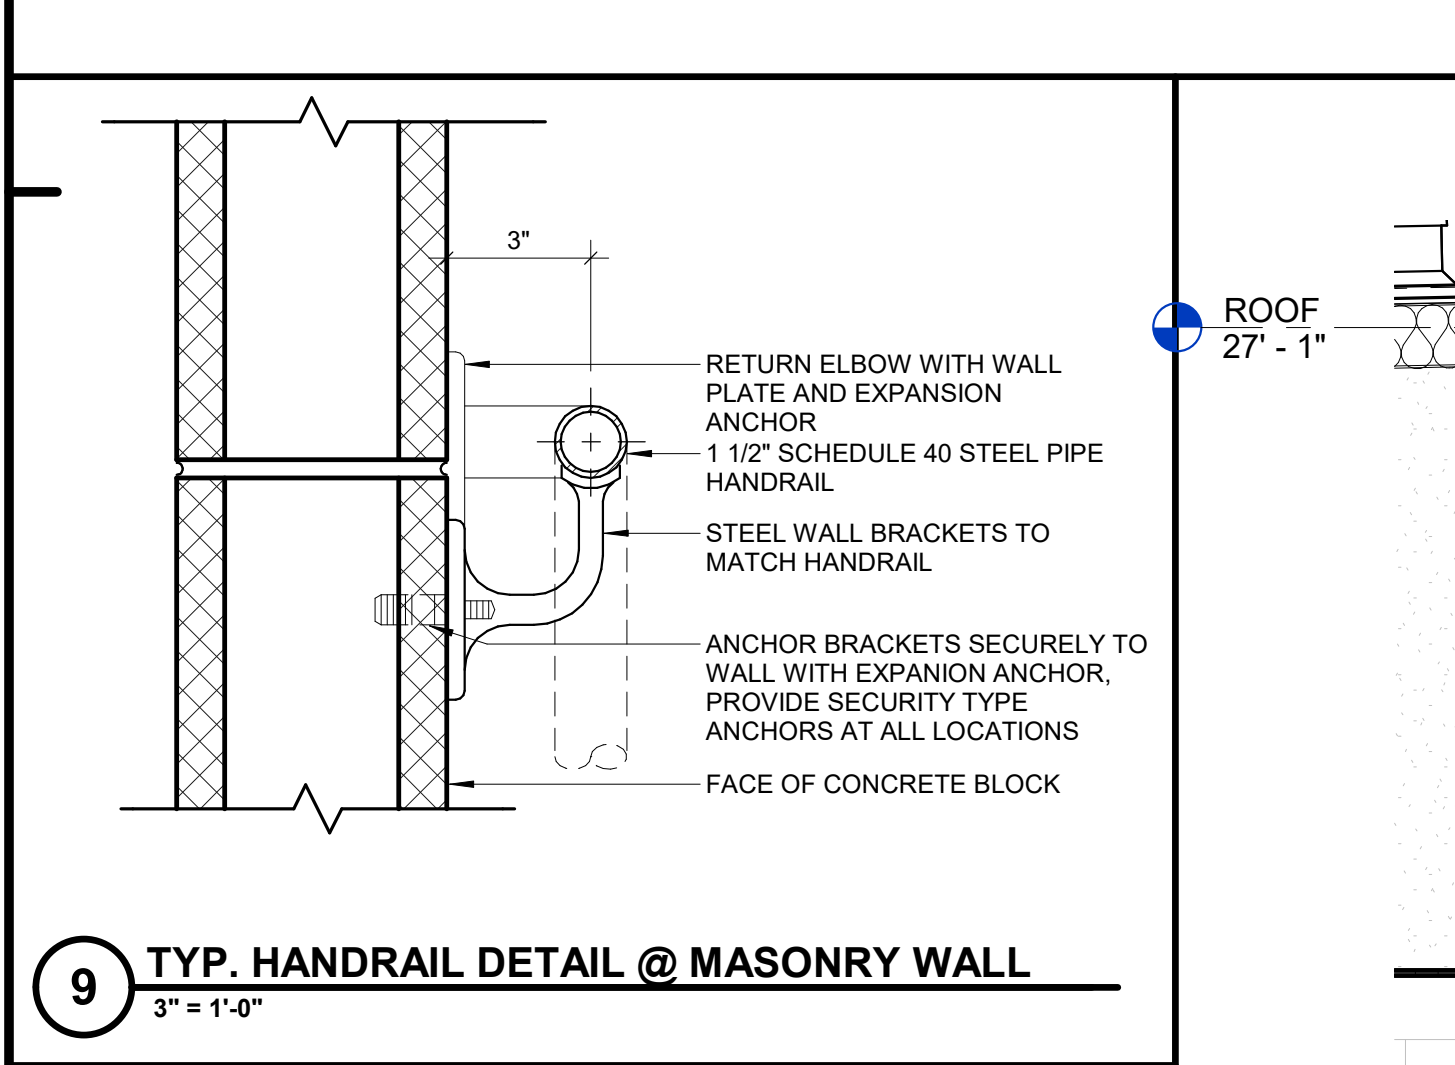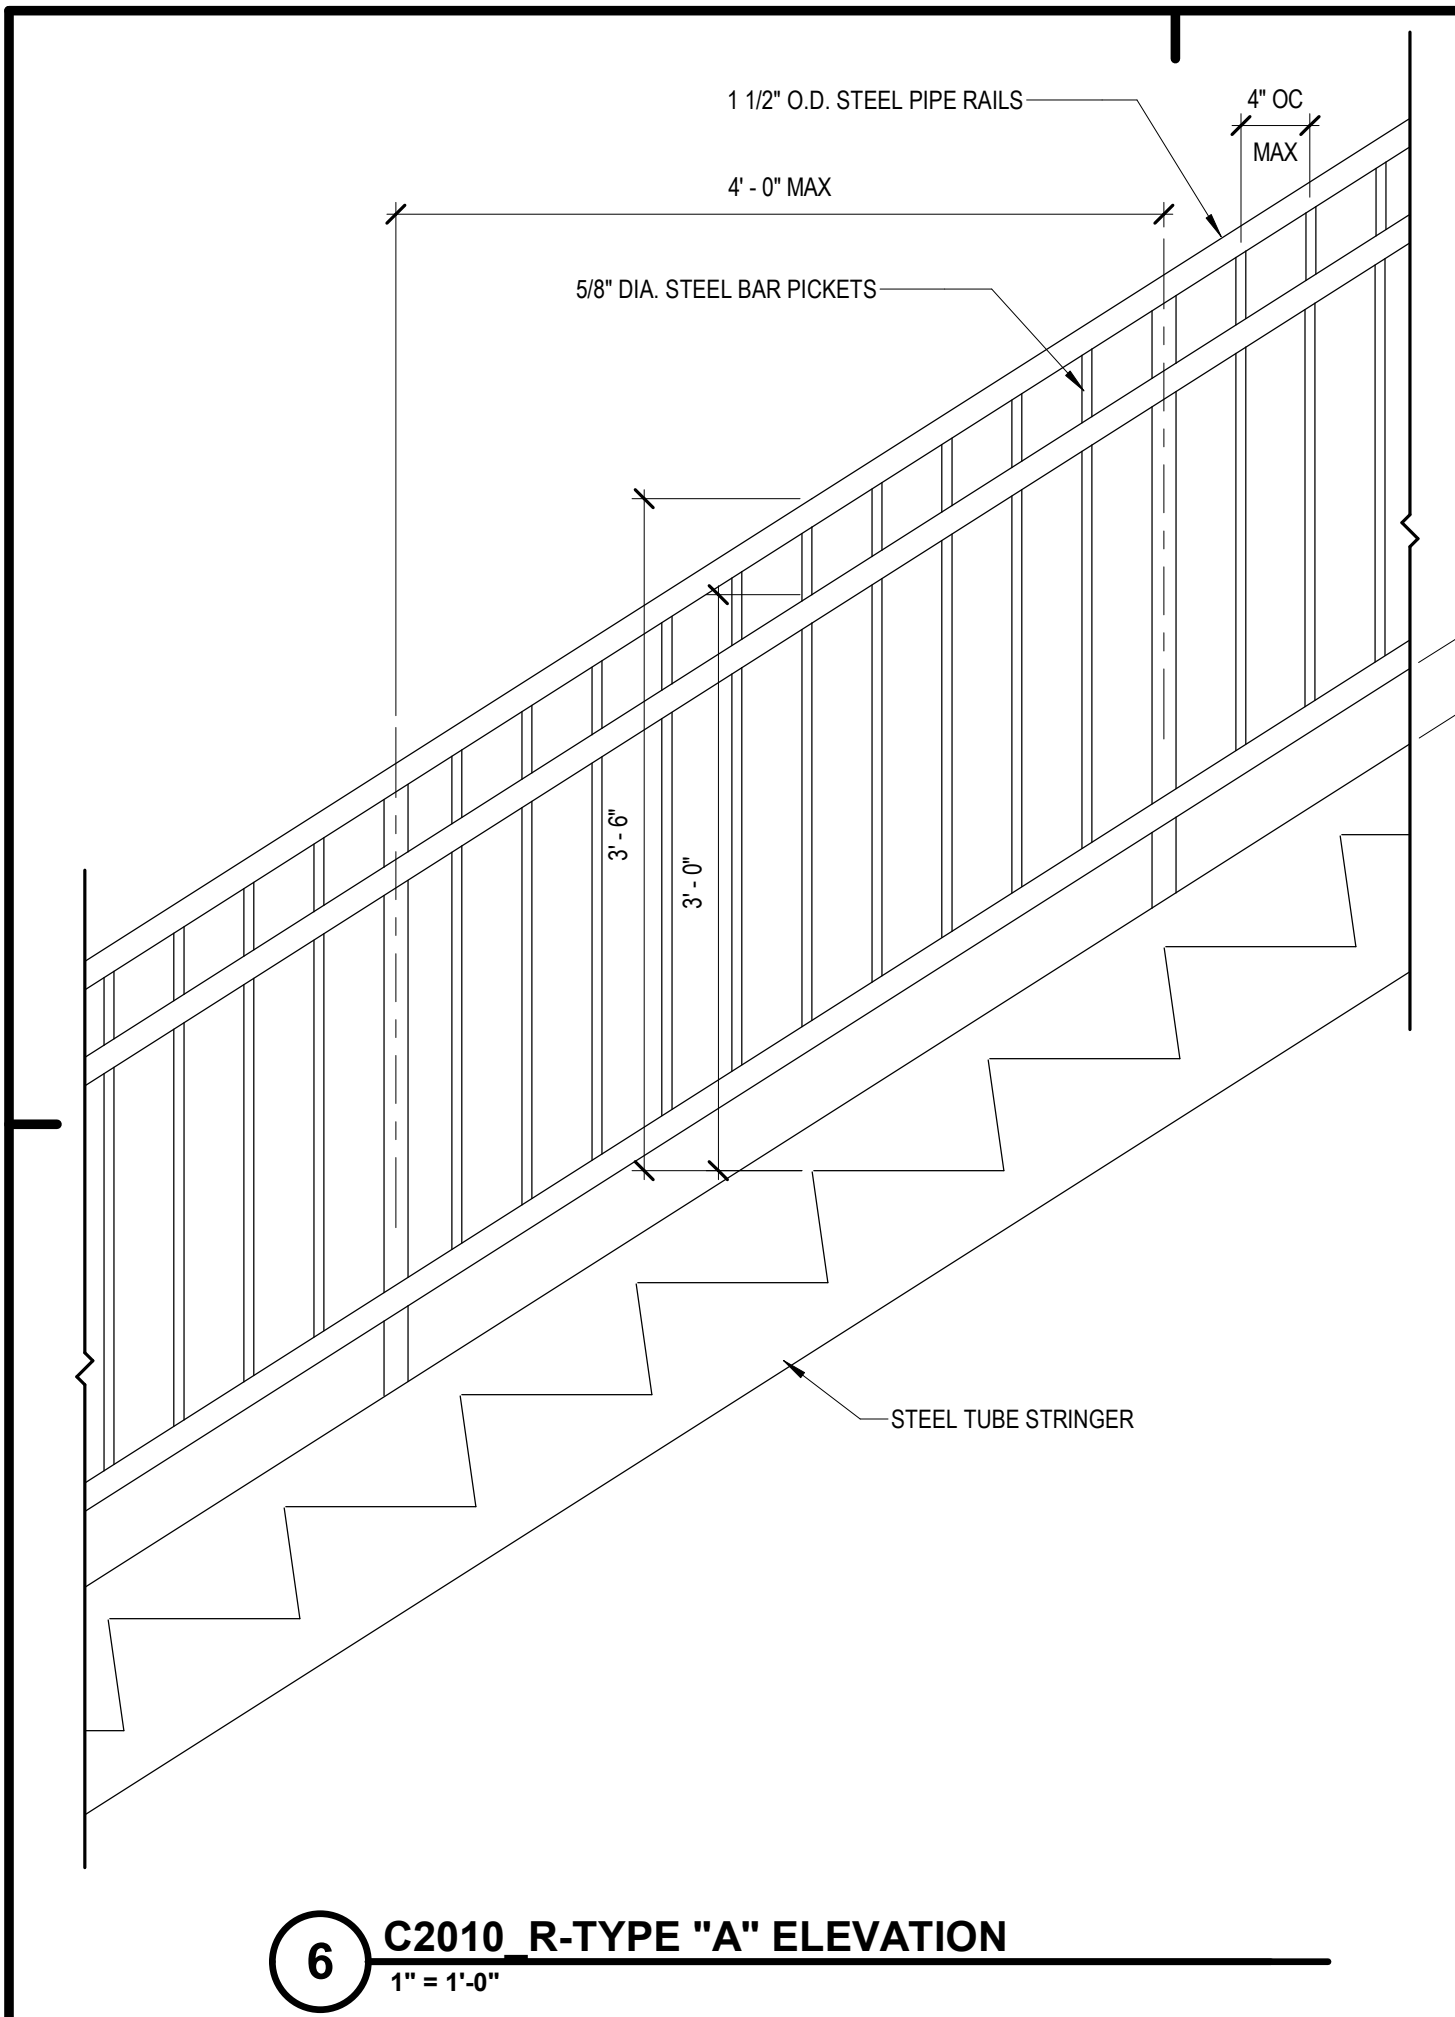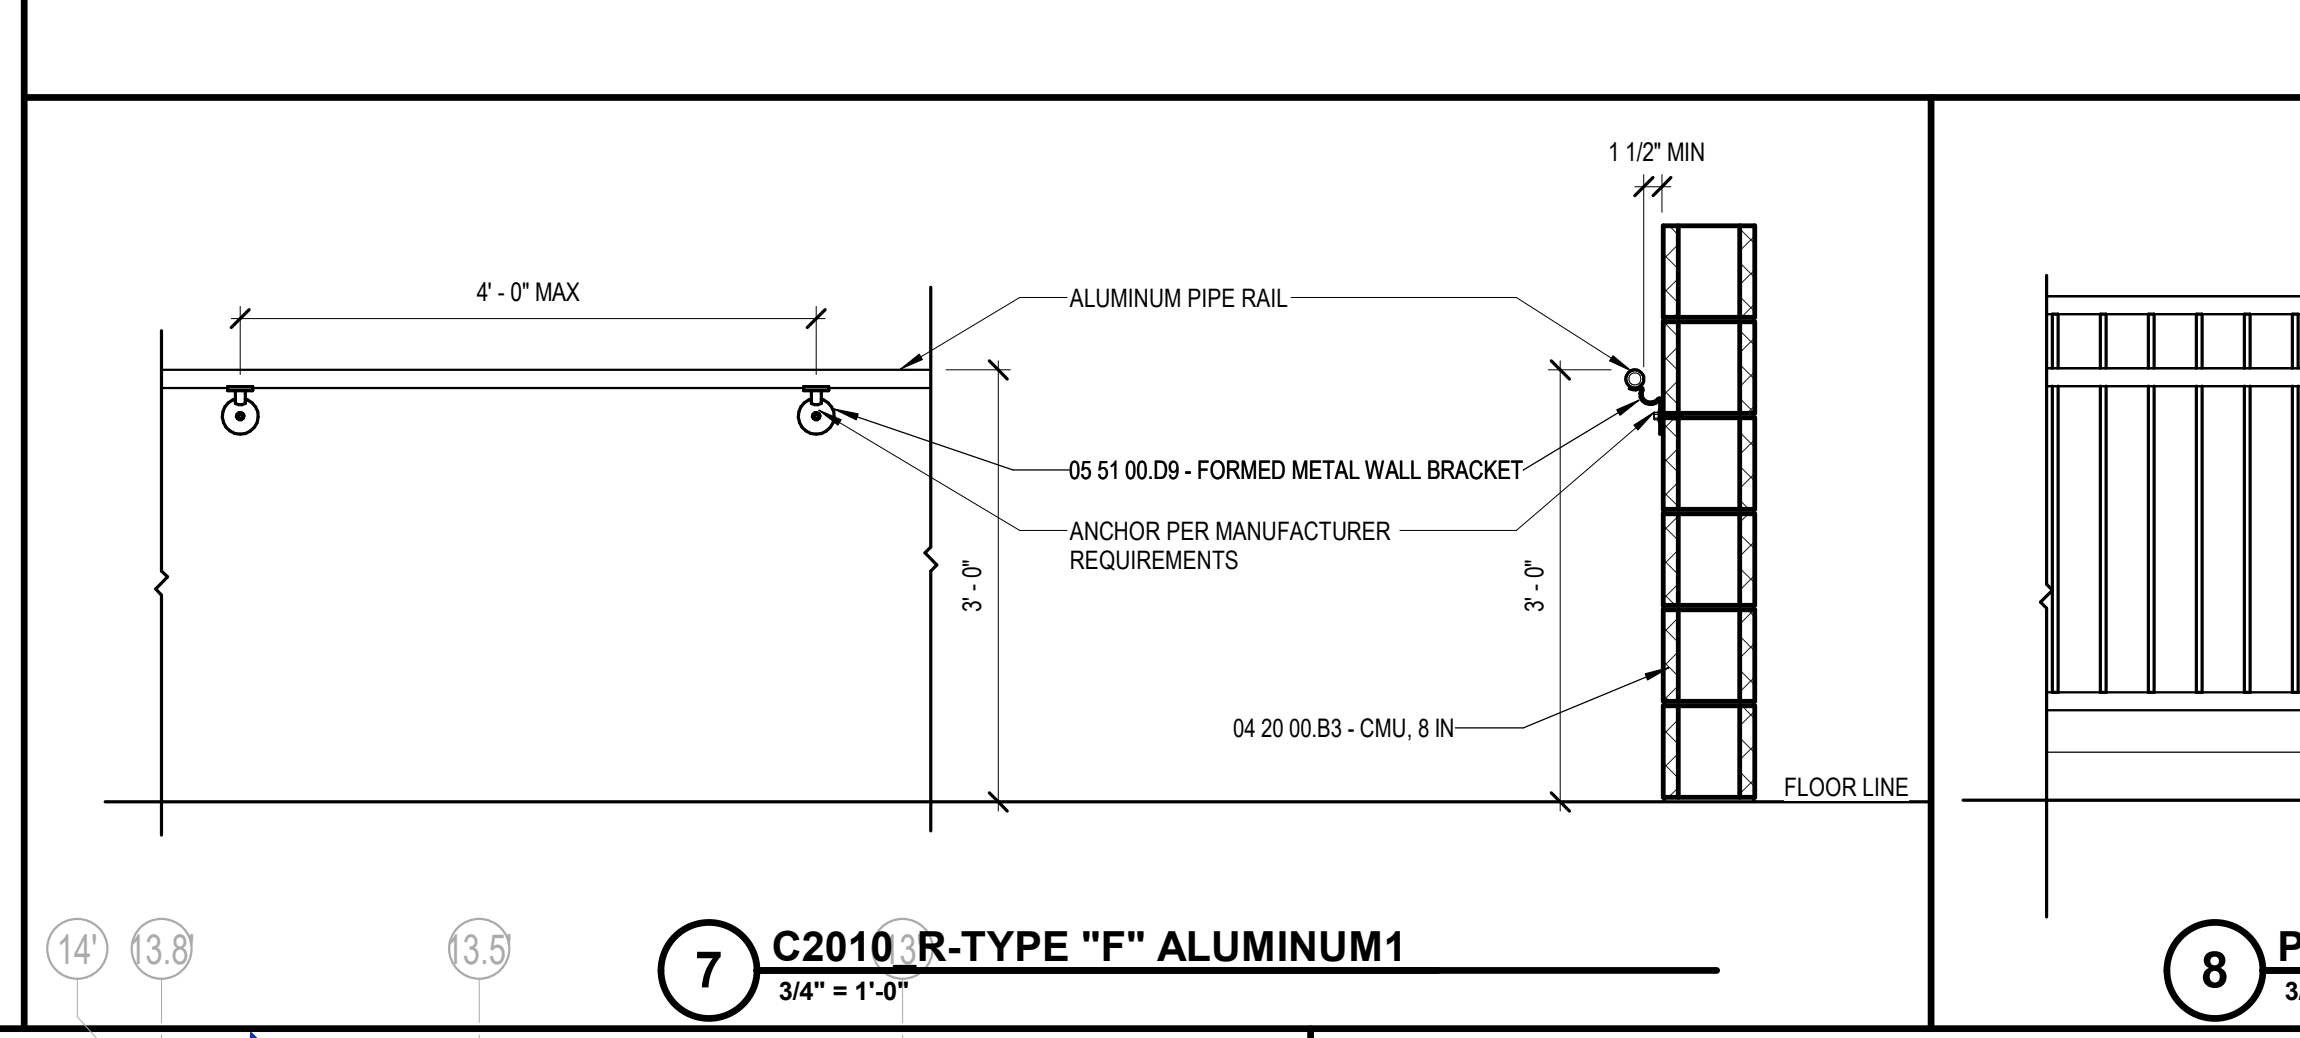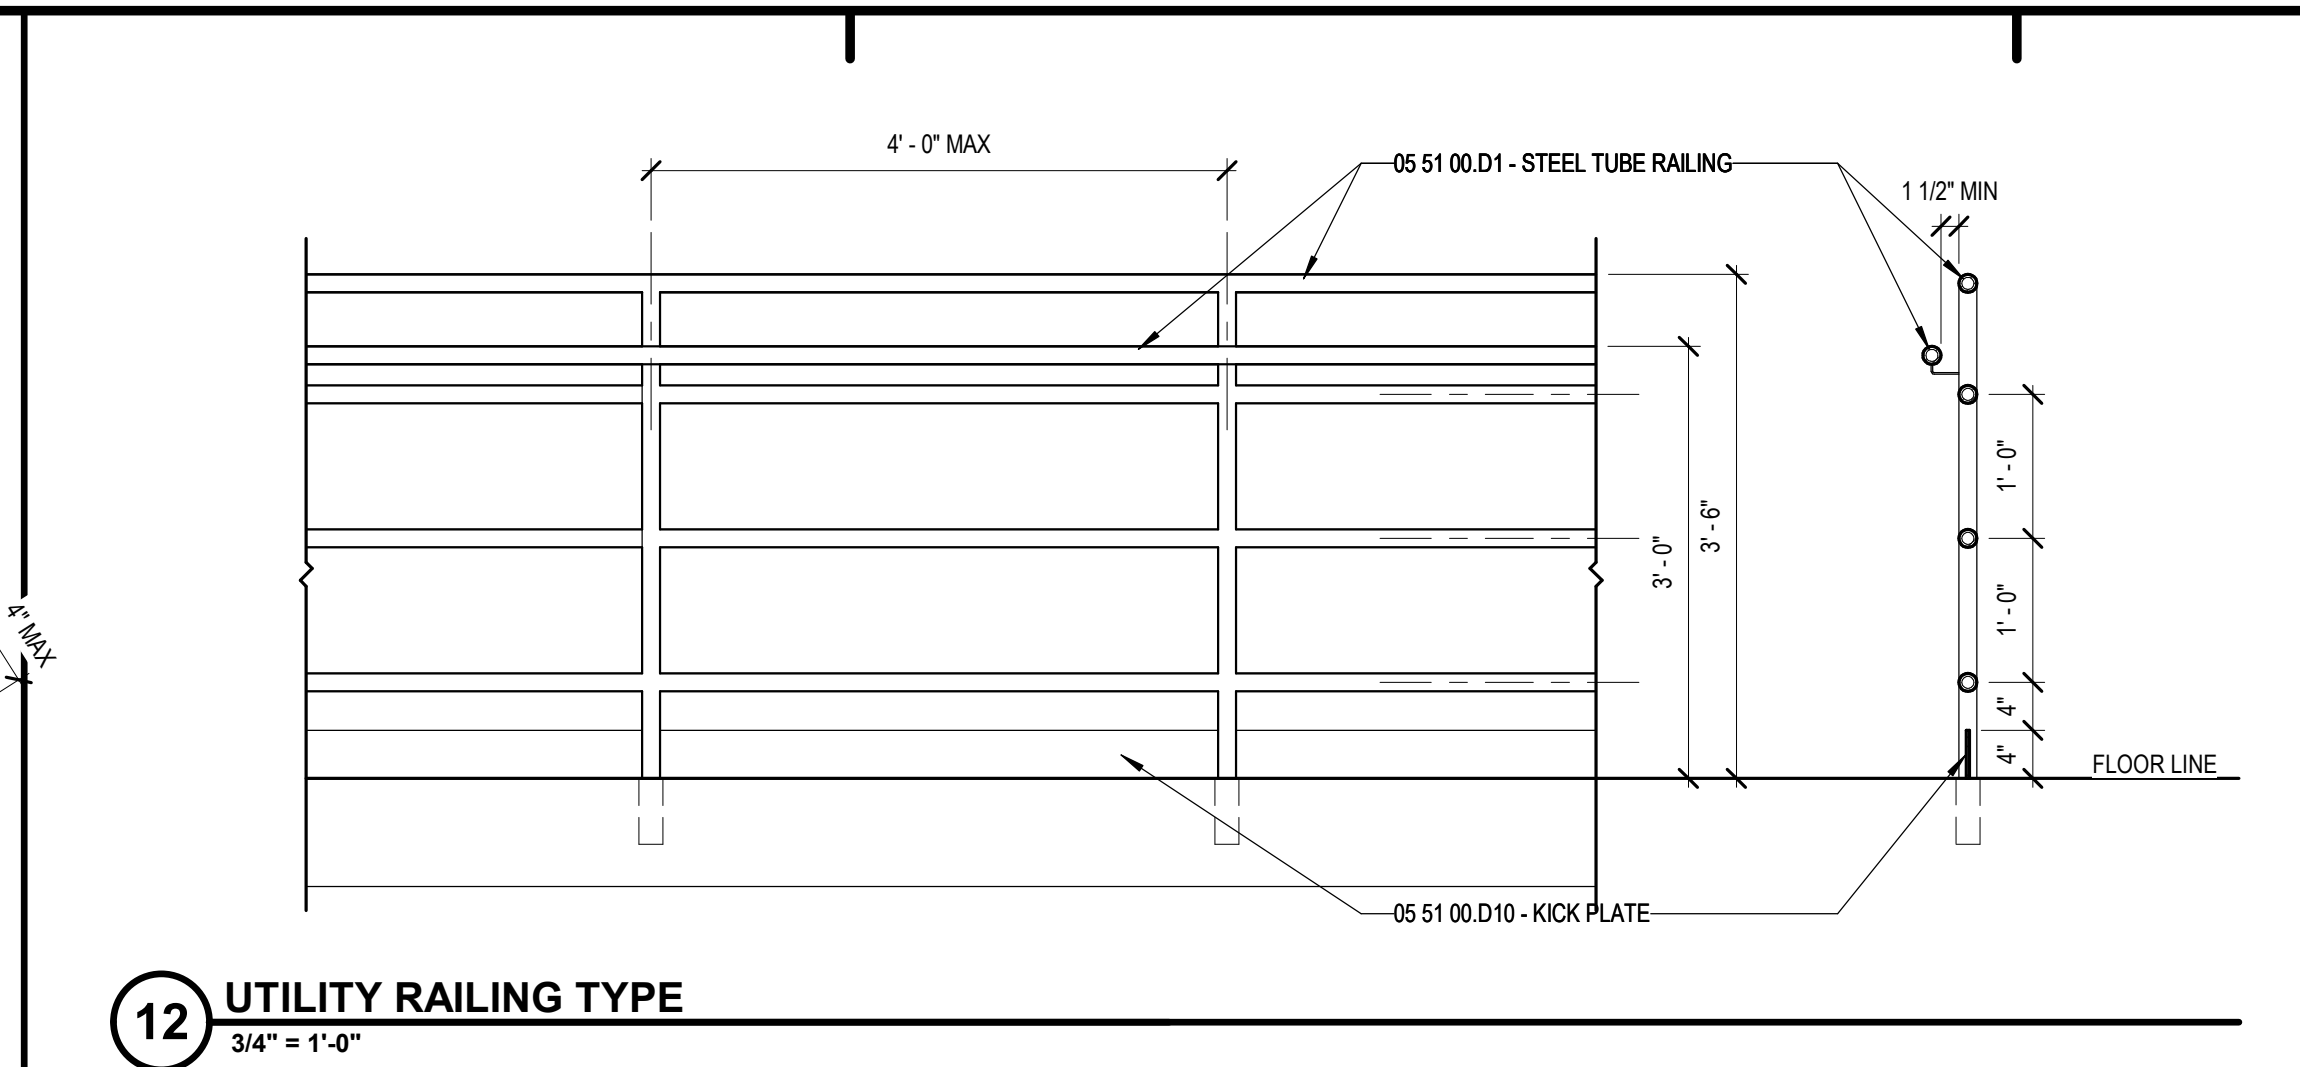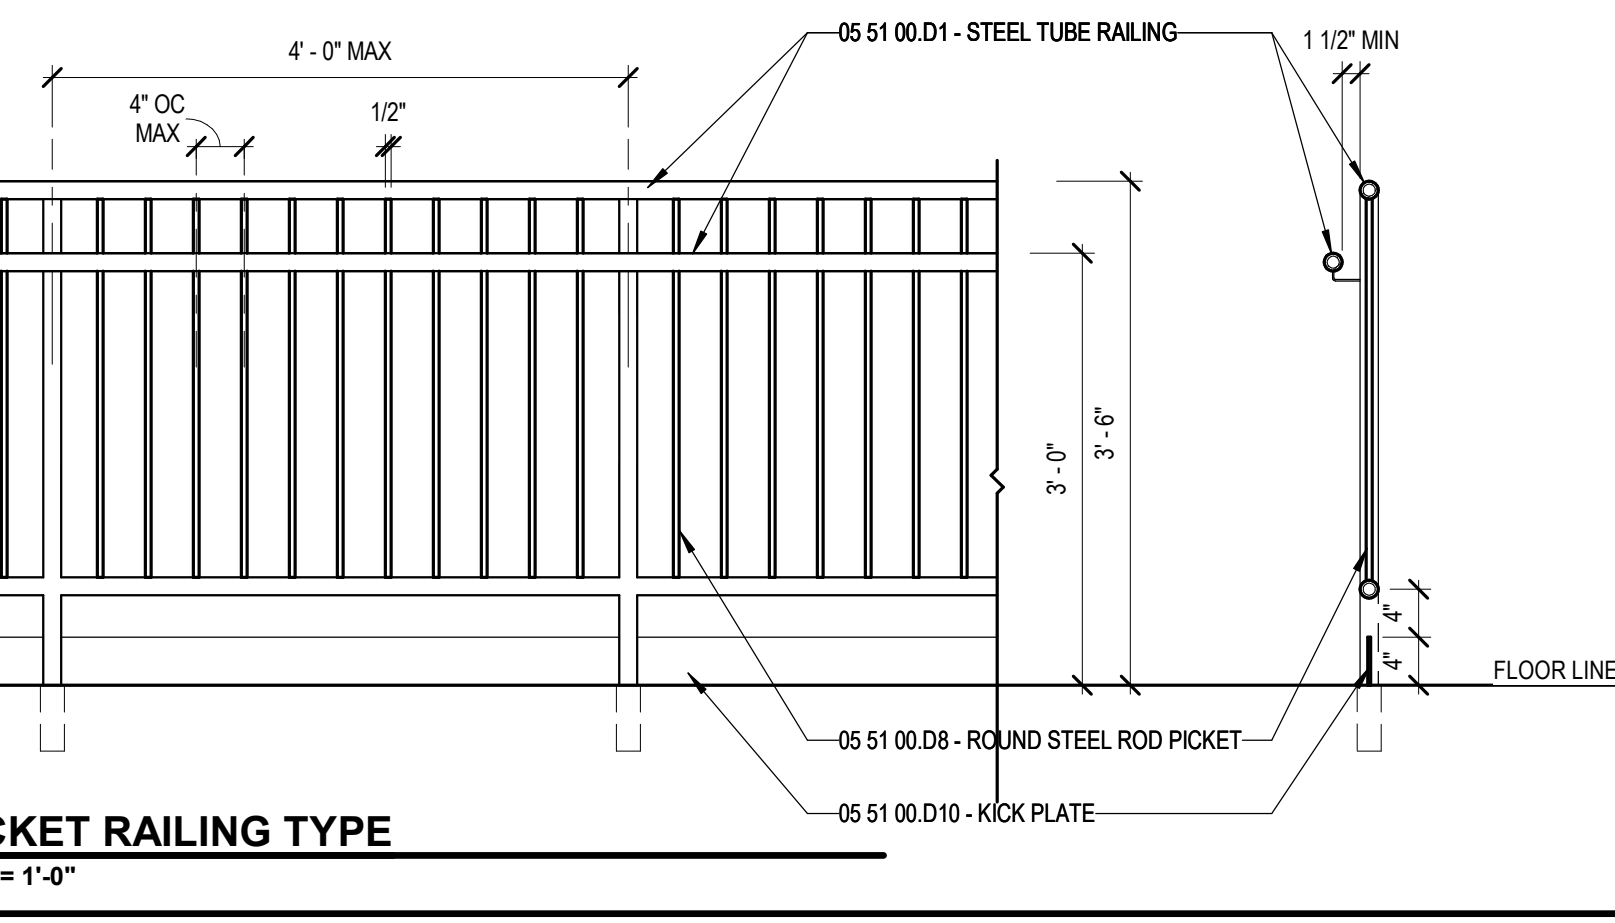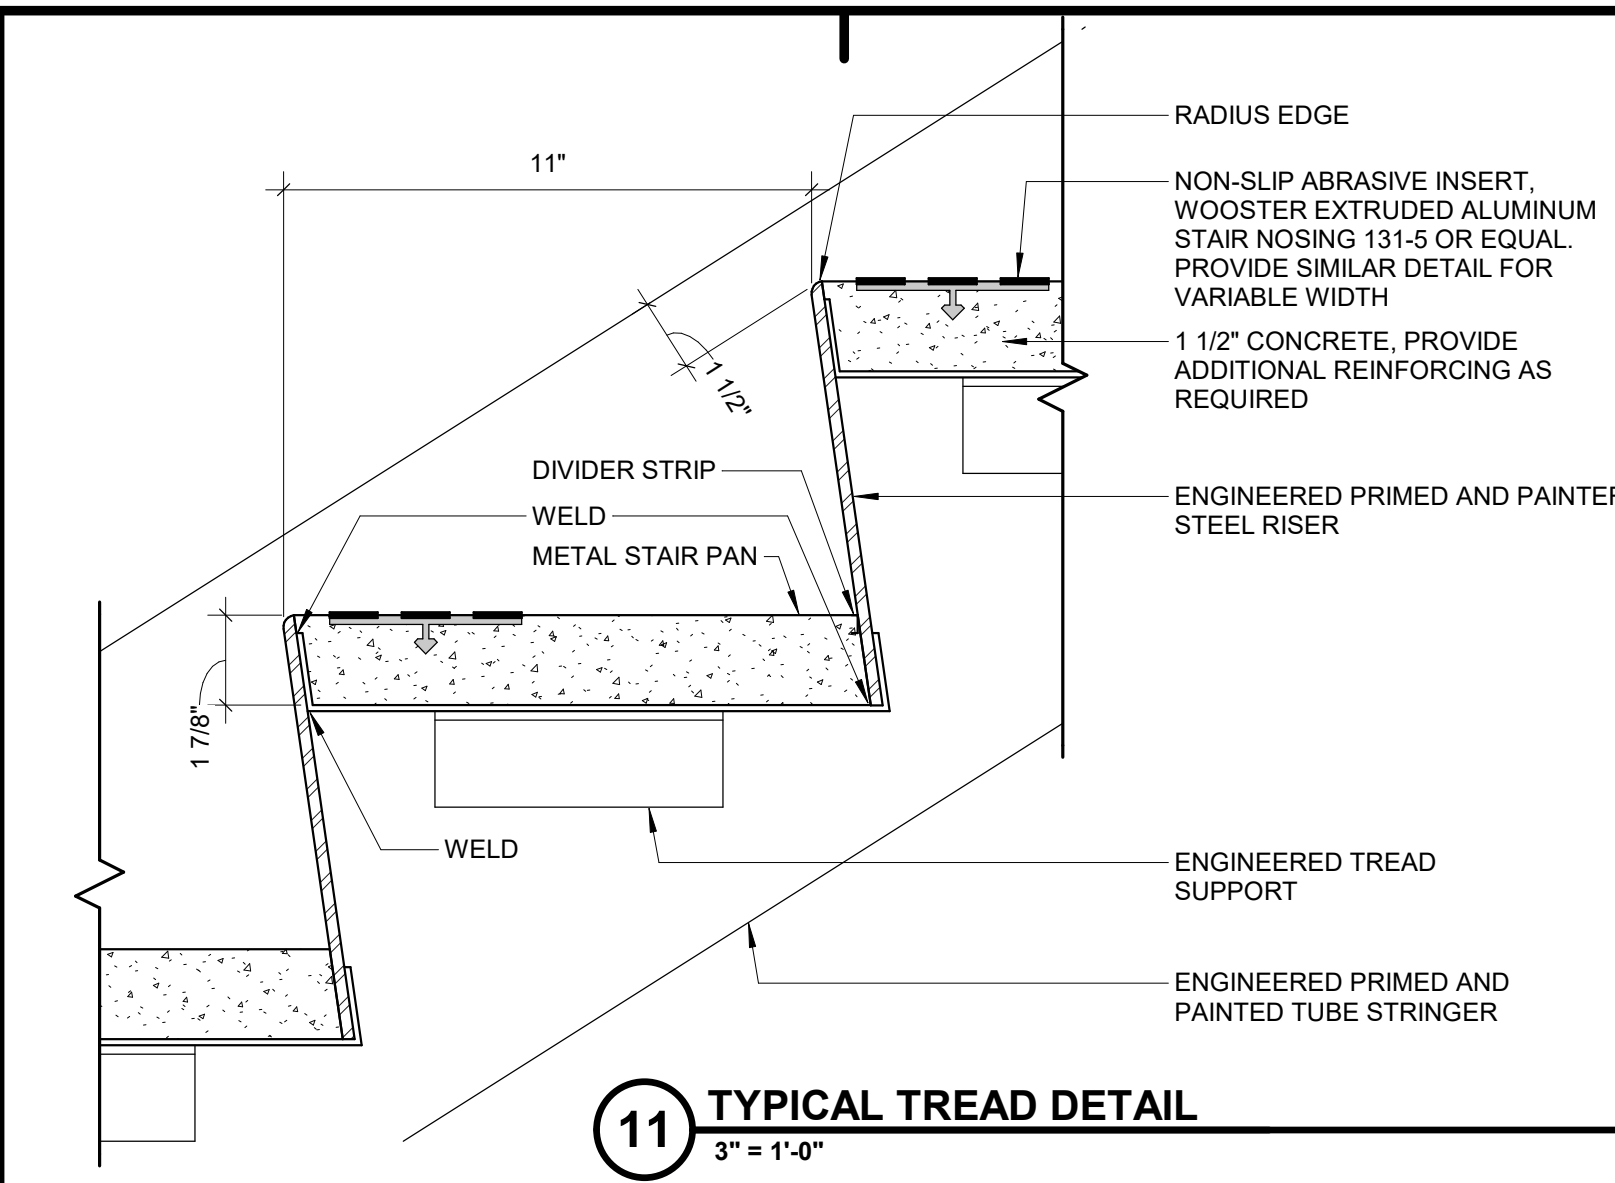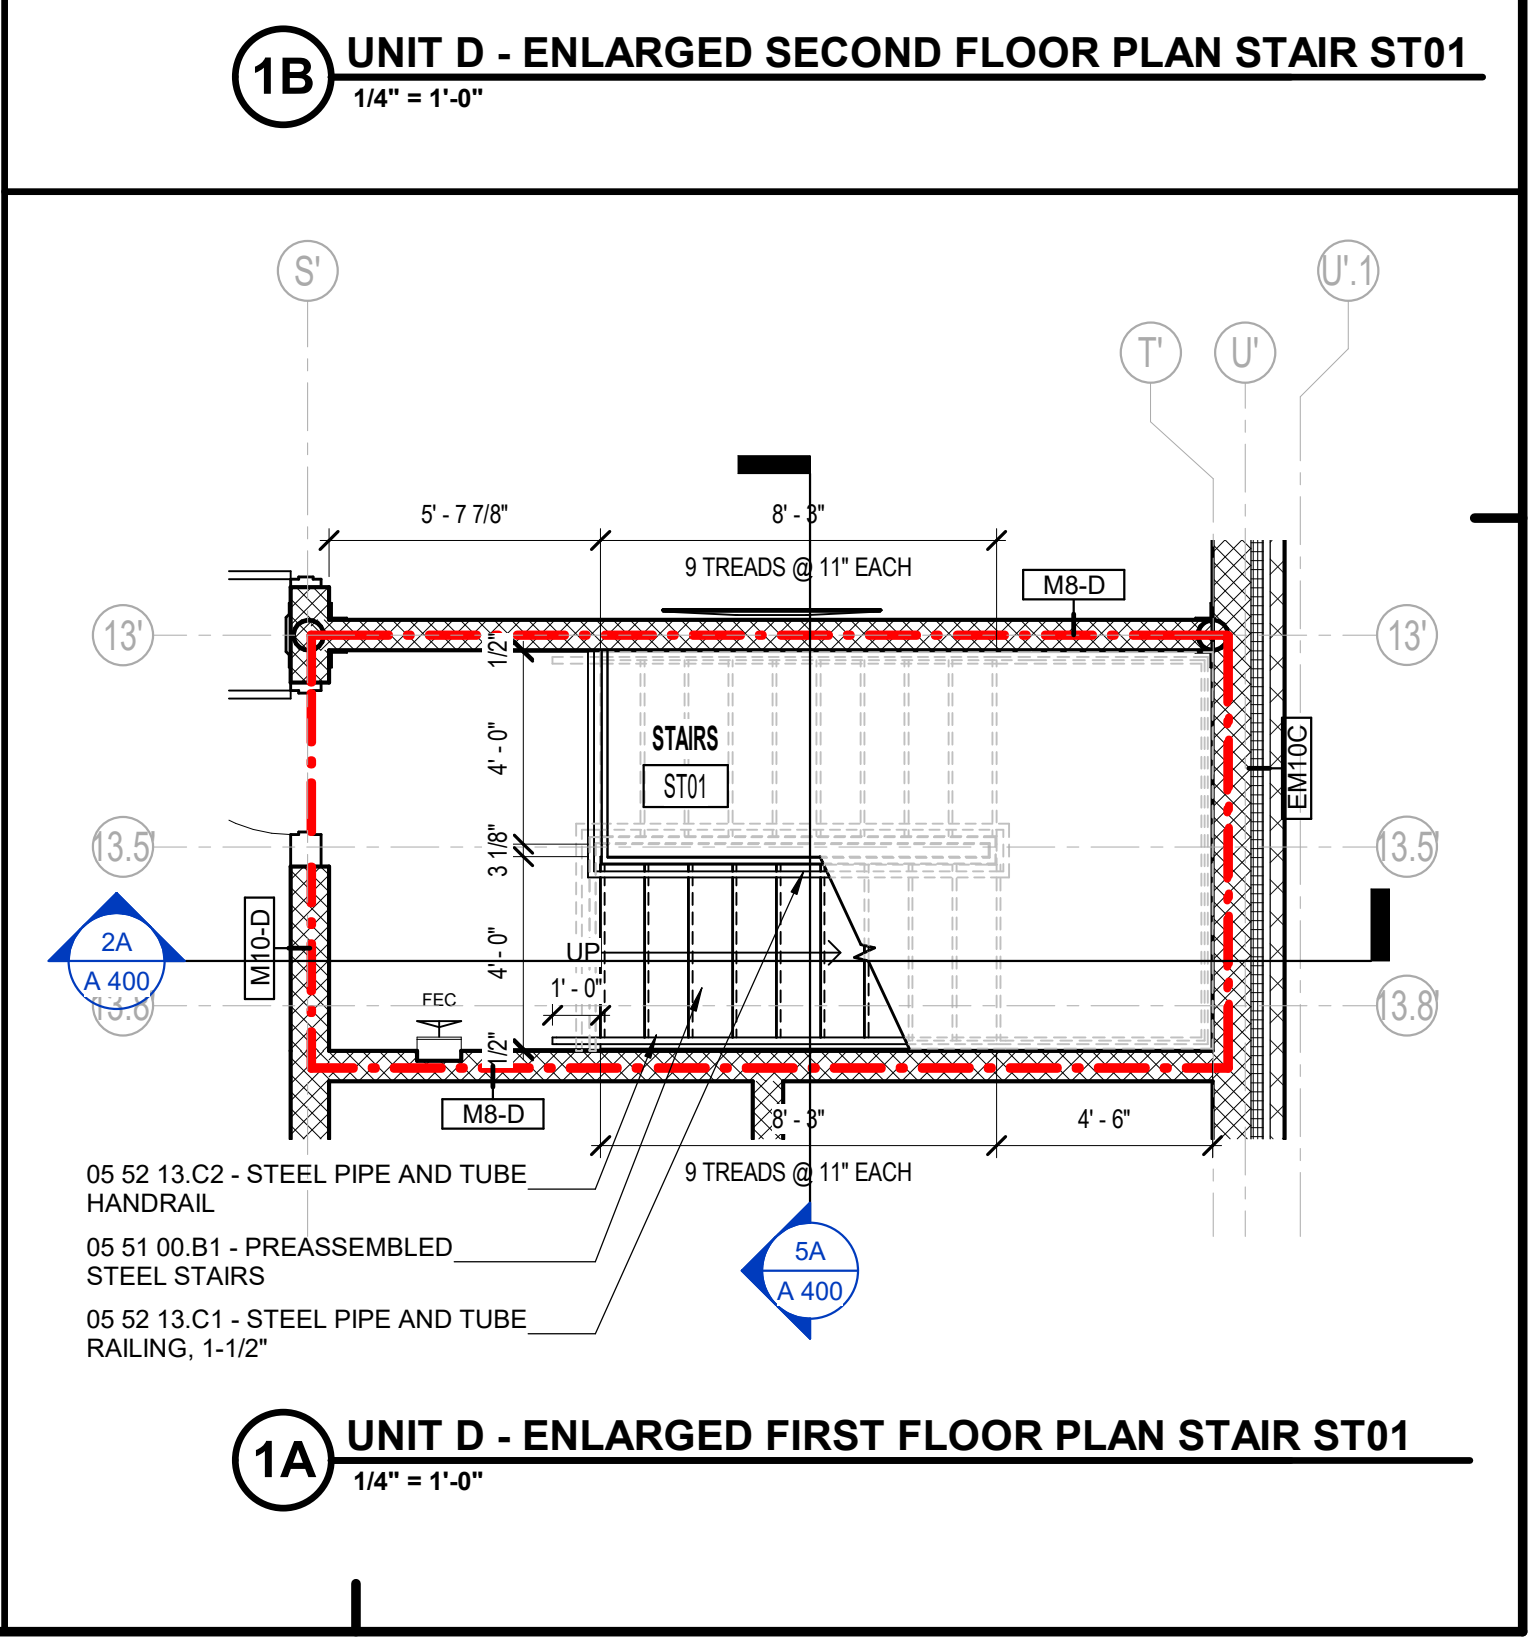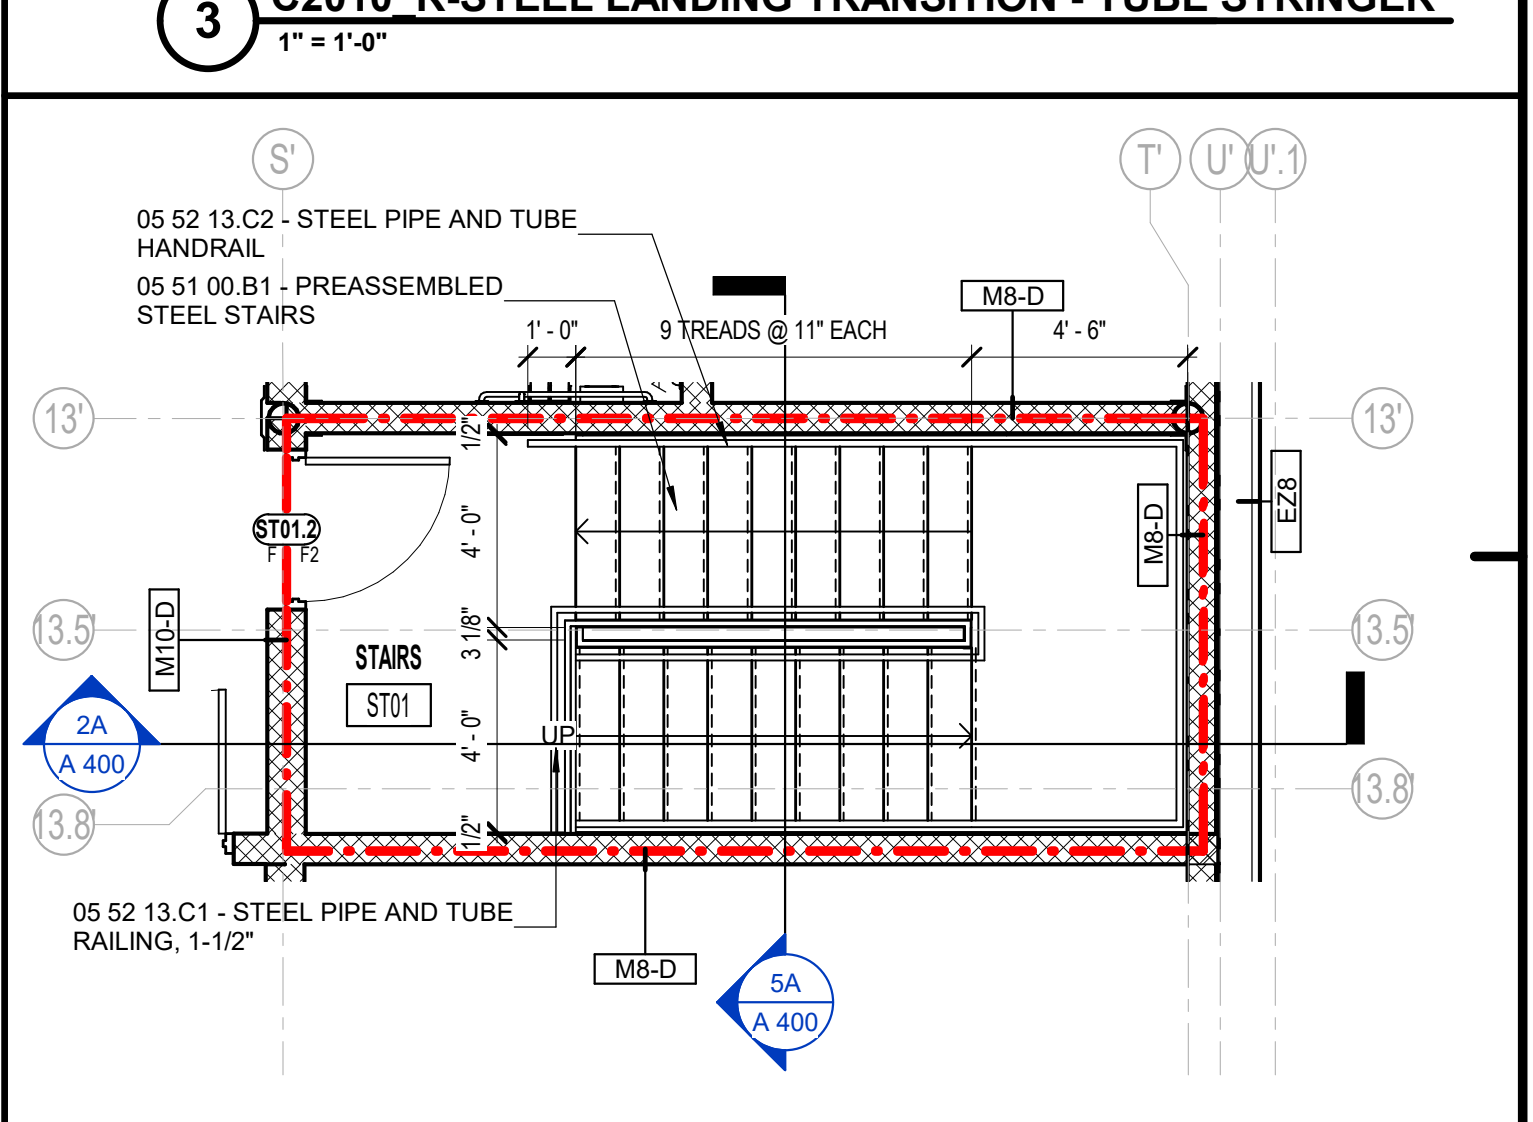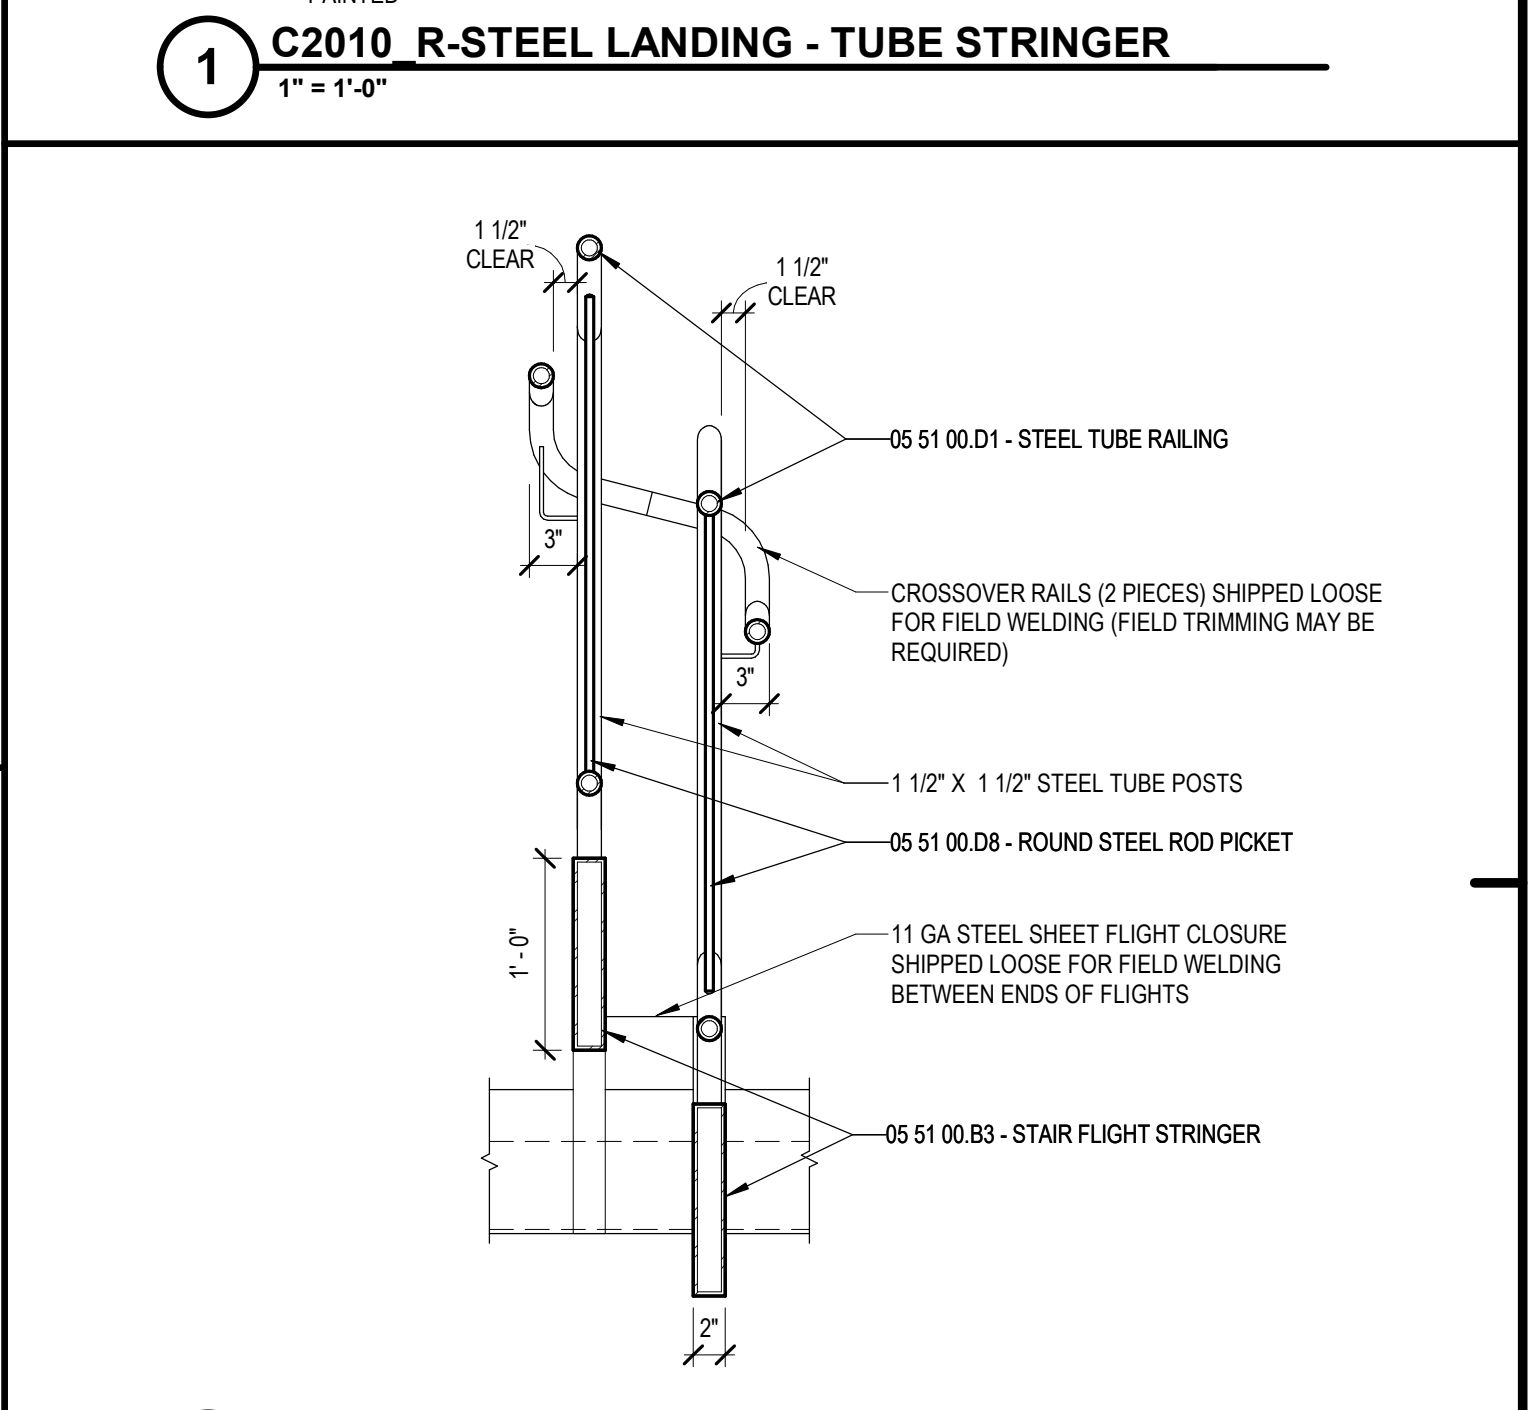
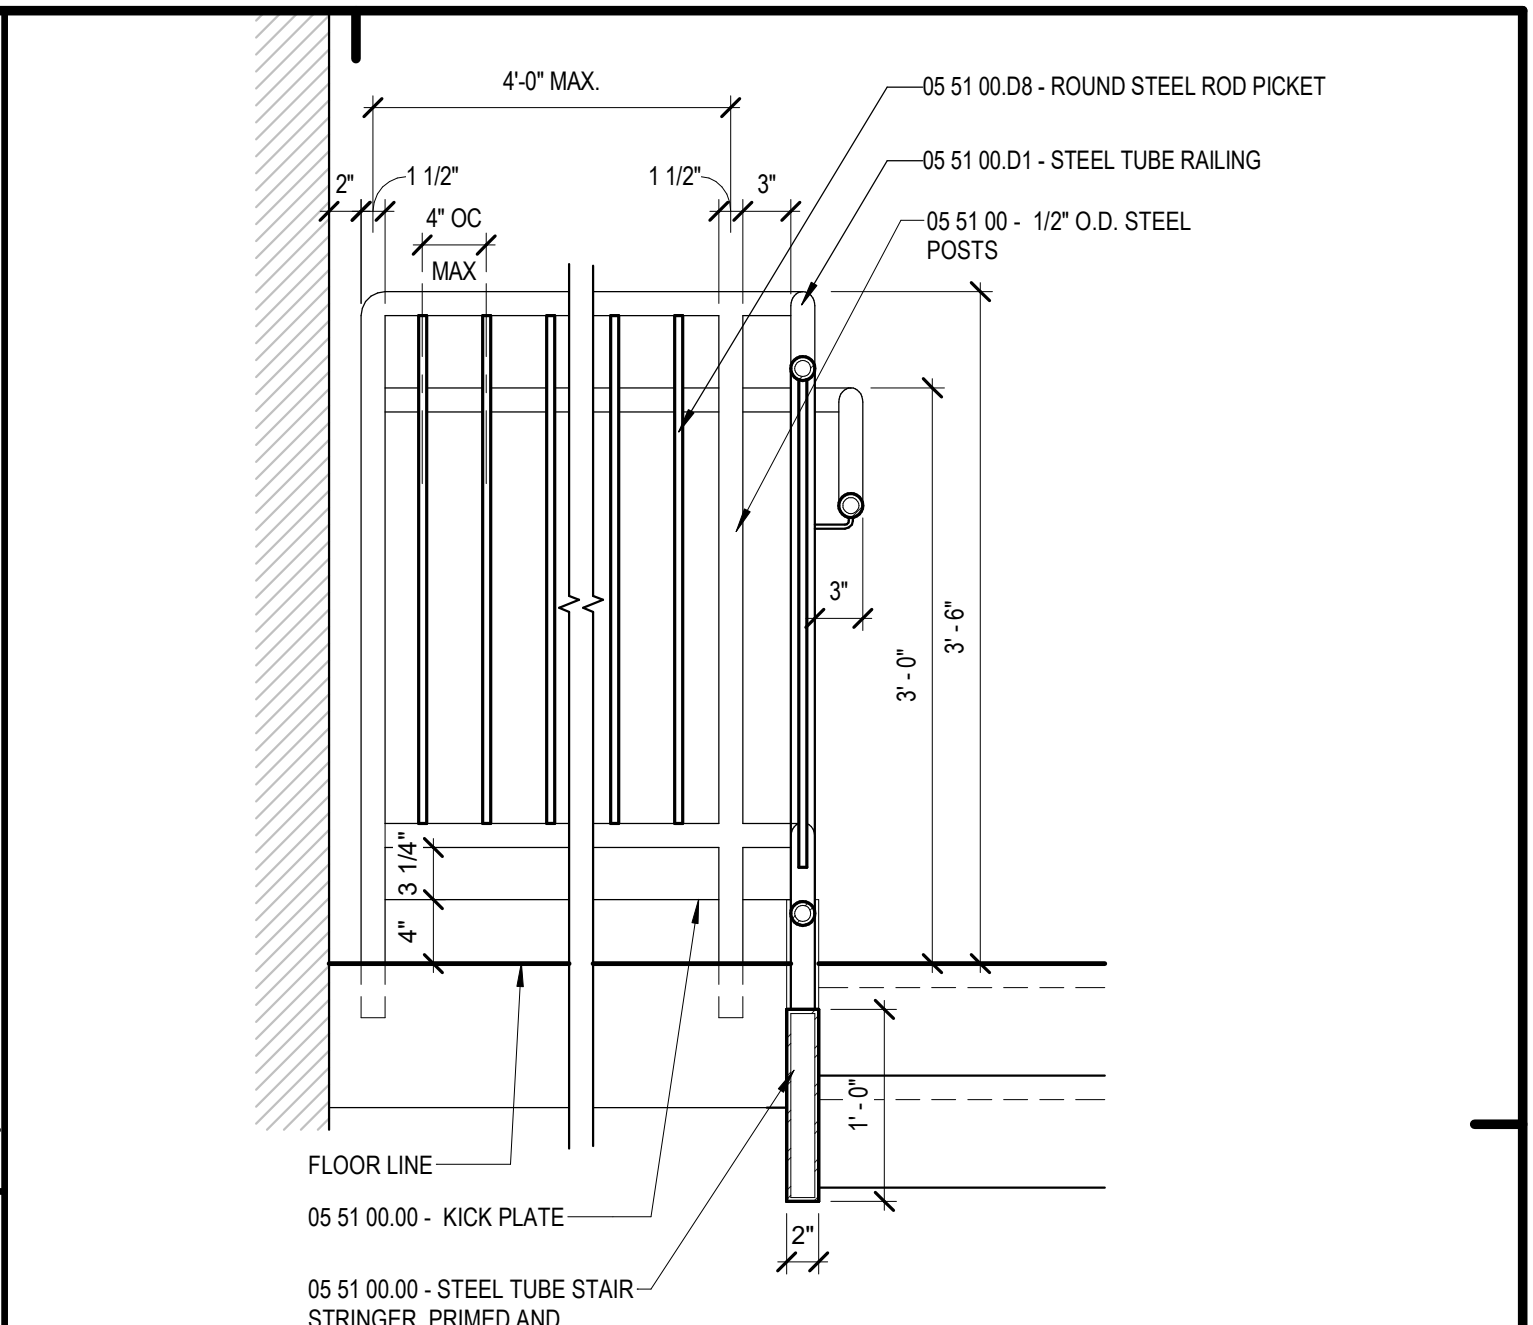


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ENLARGED STAIR PLANS  
AND DETAILS

**A 401**

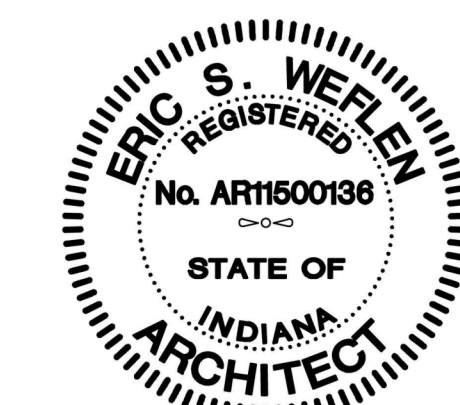

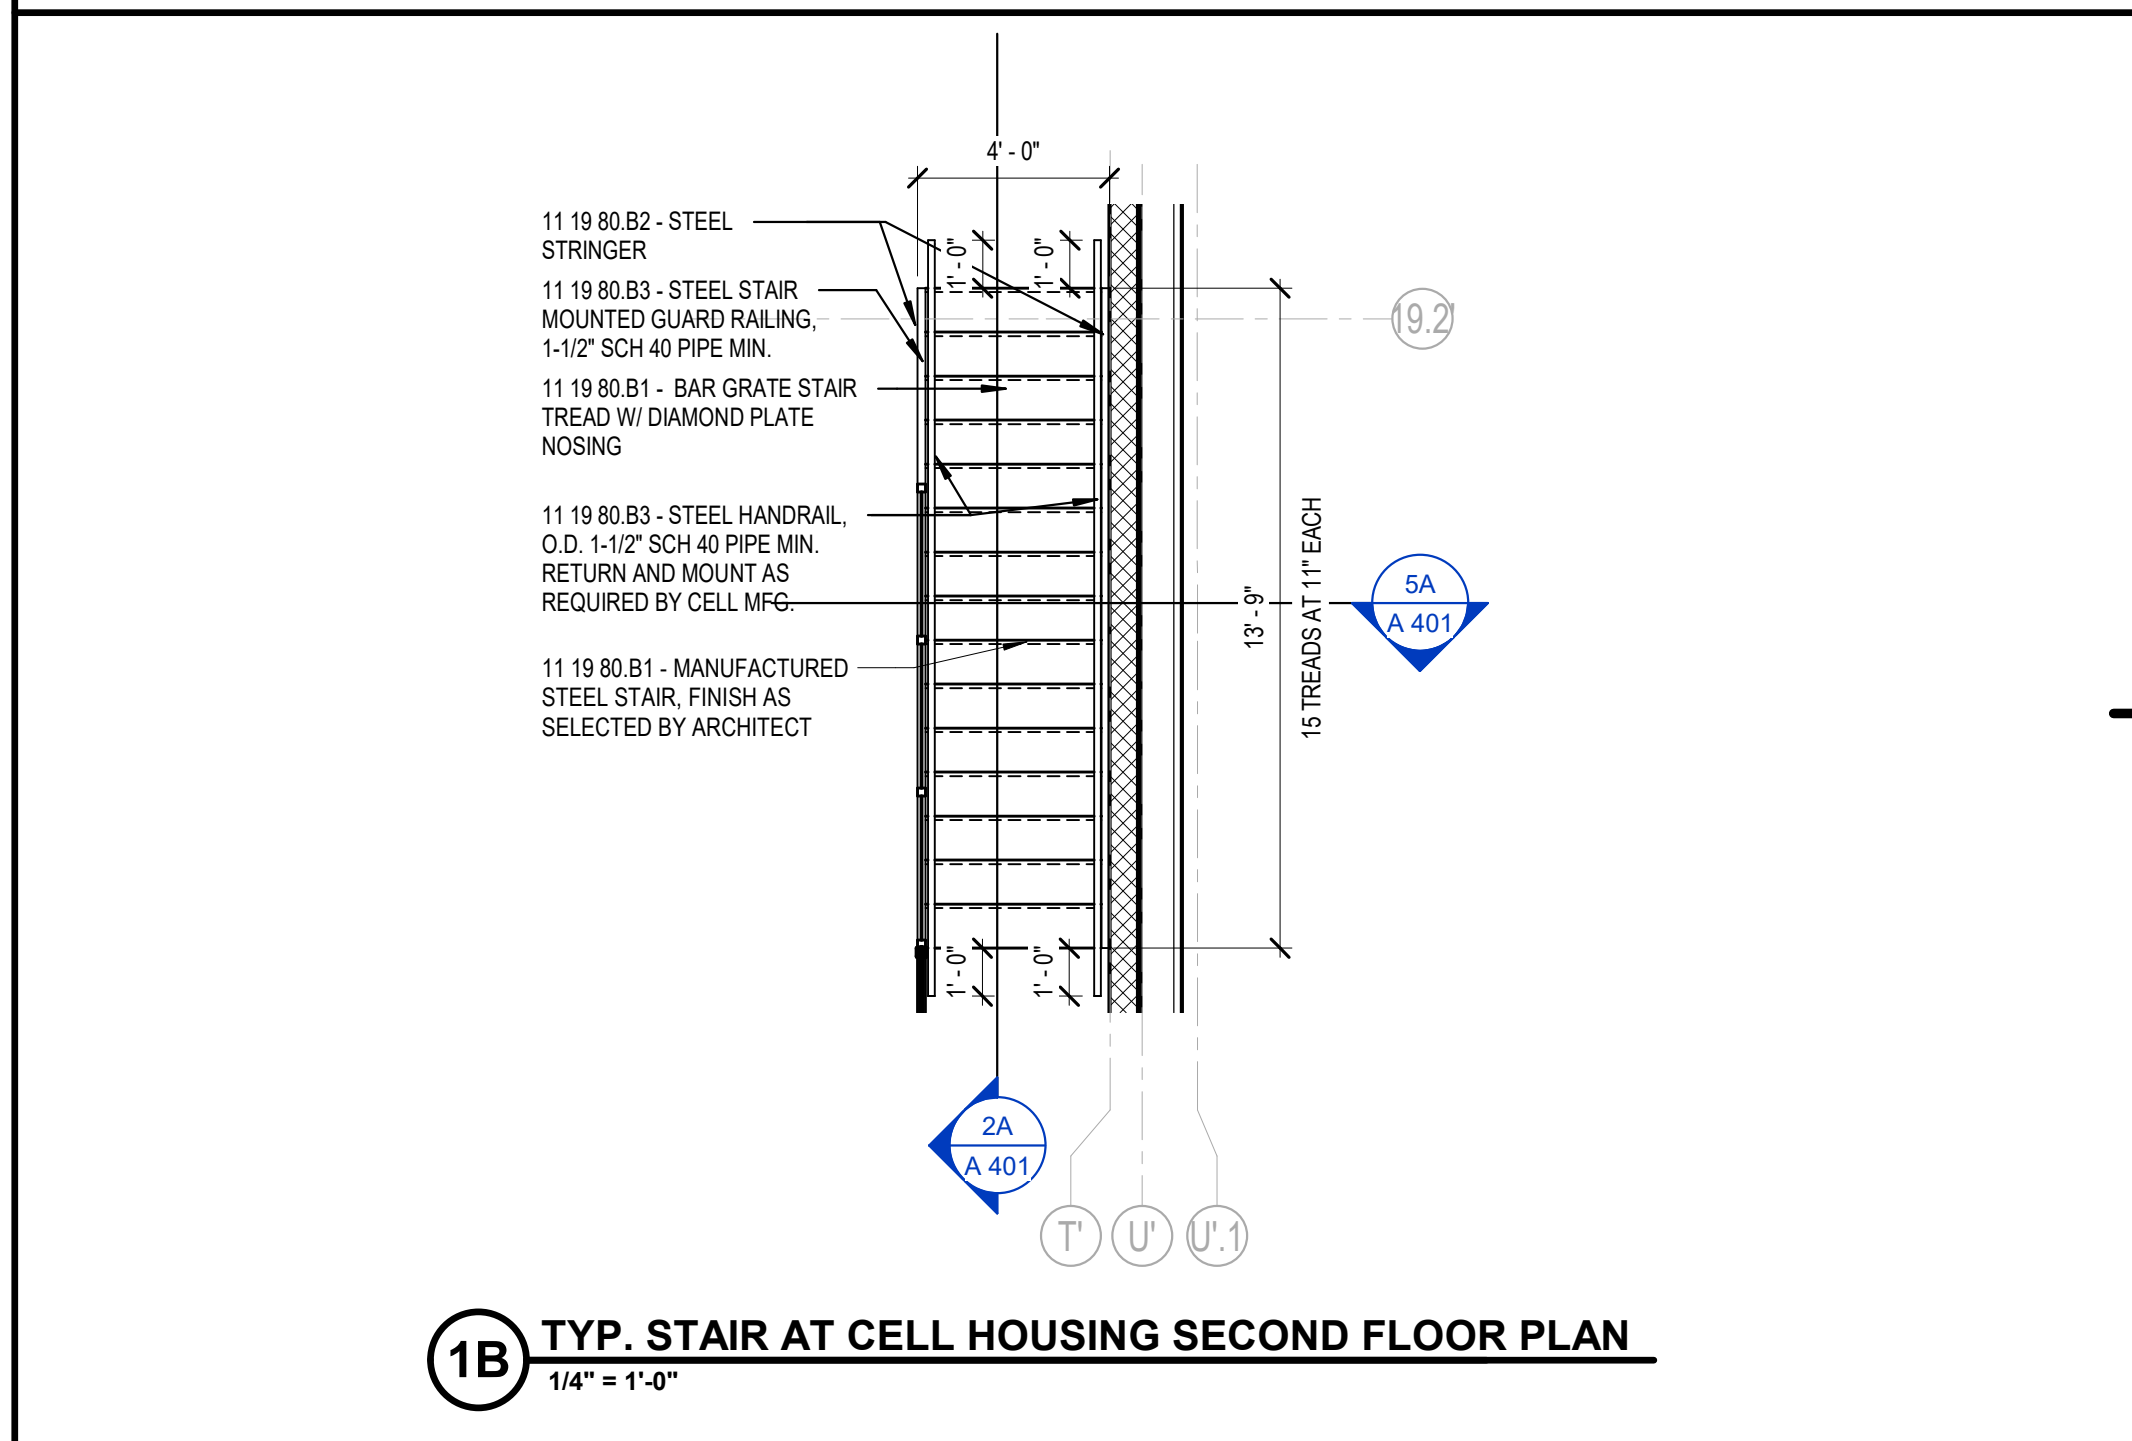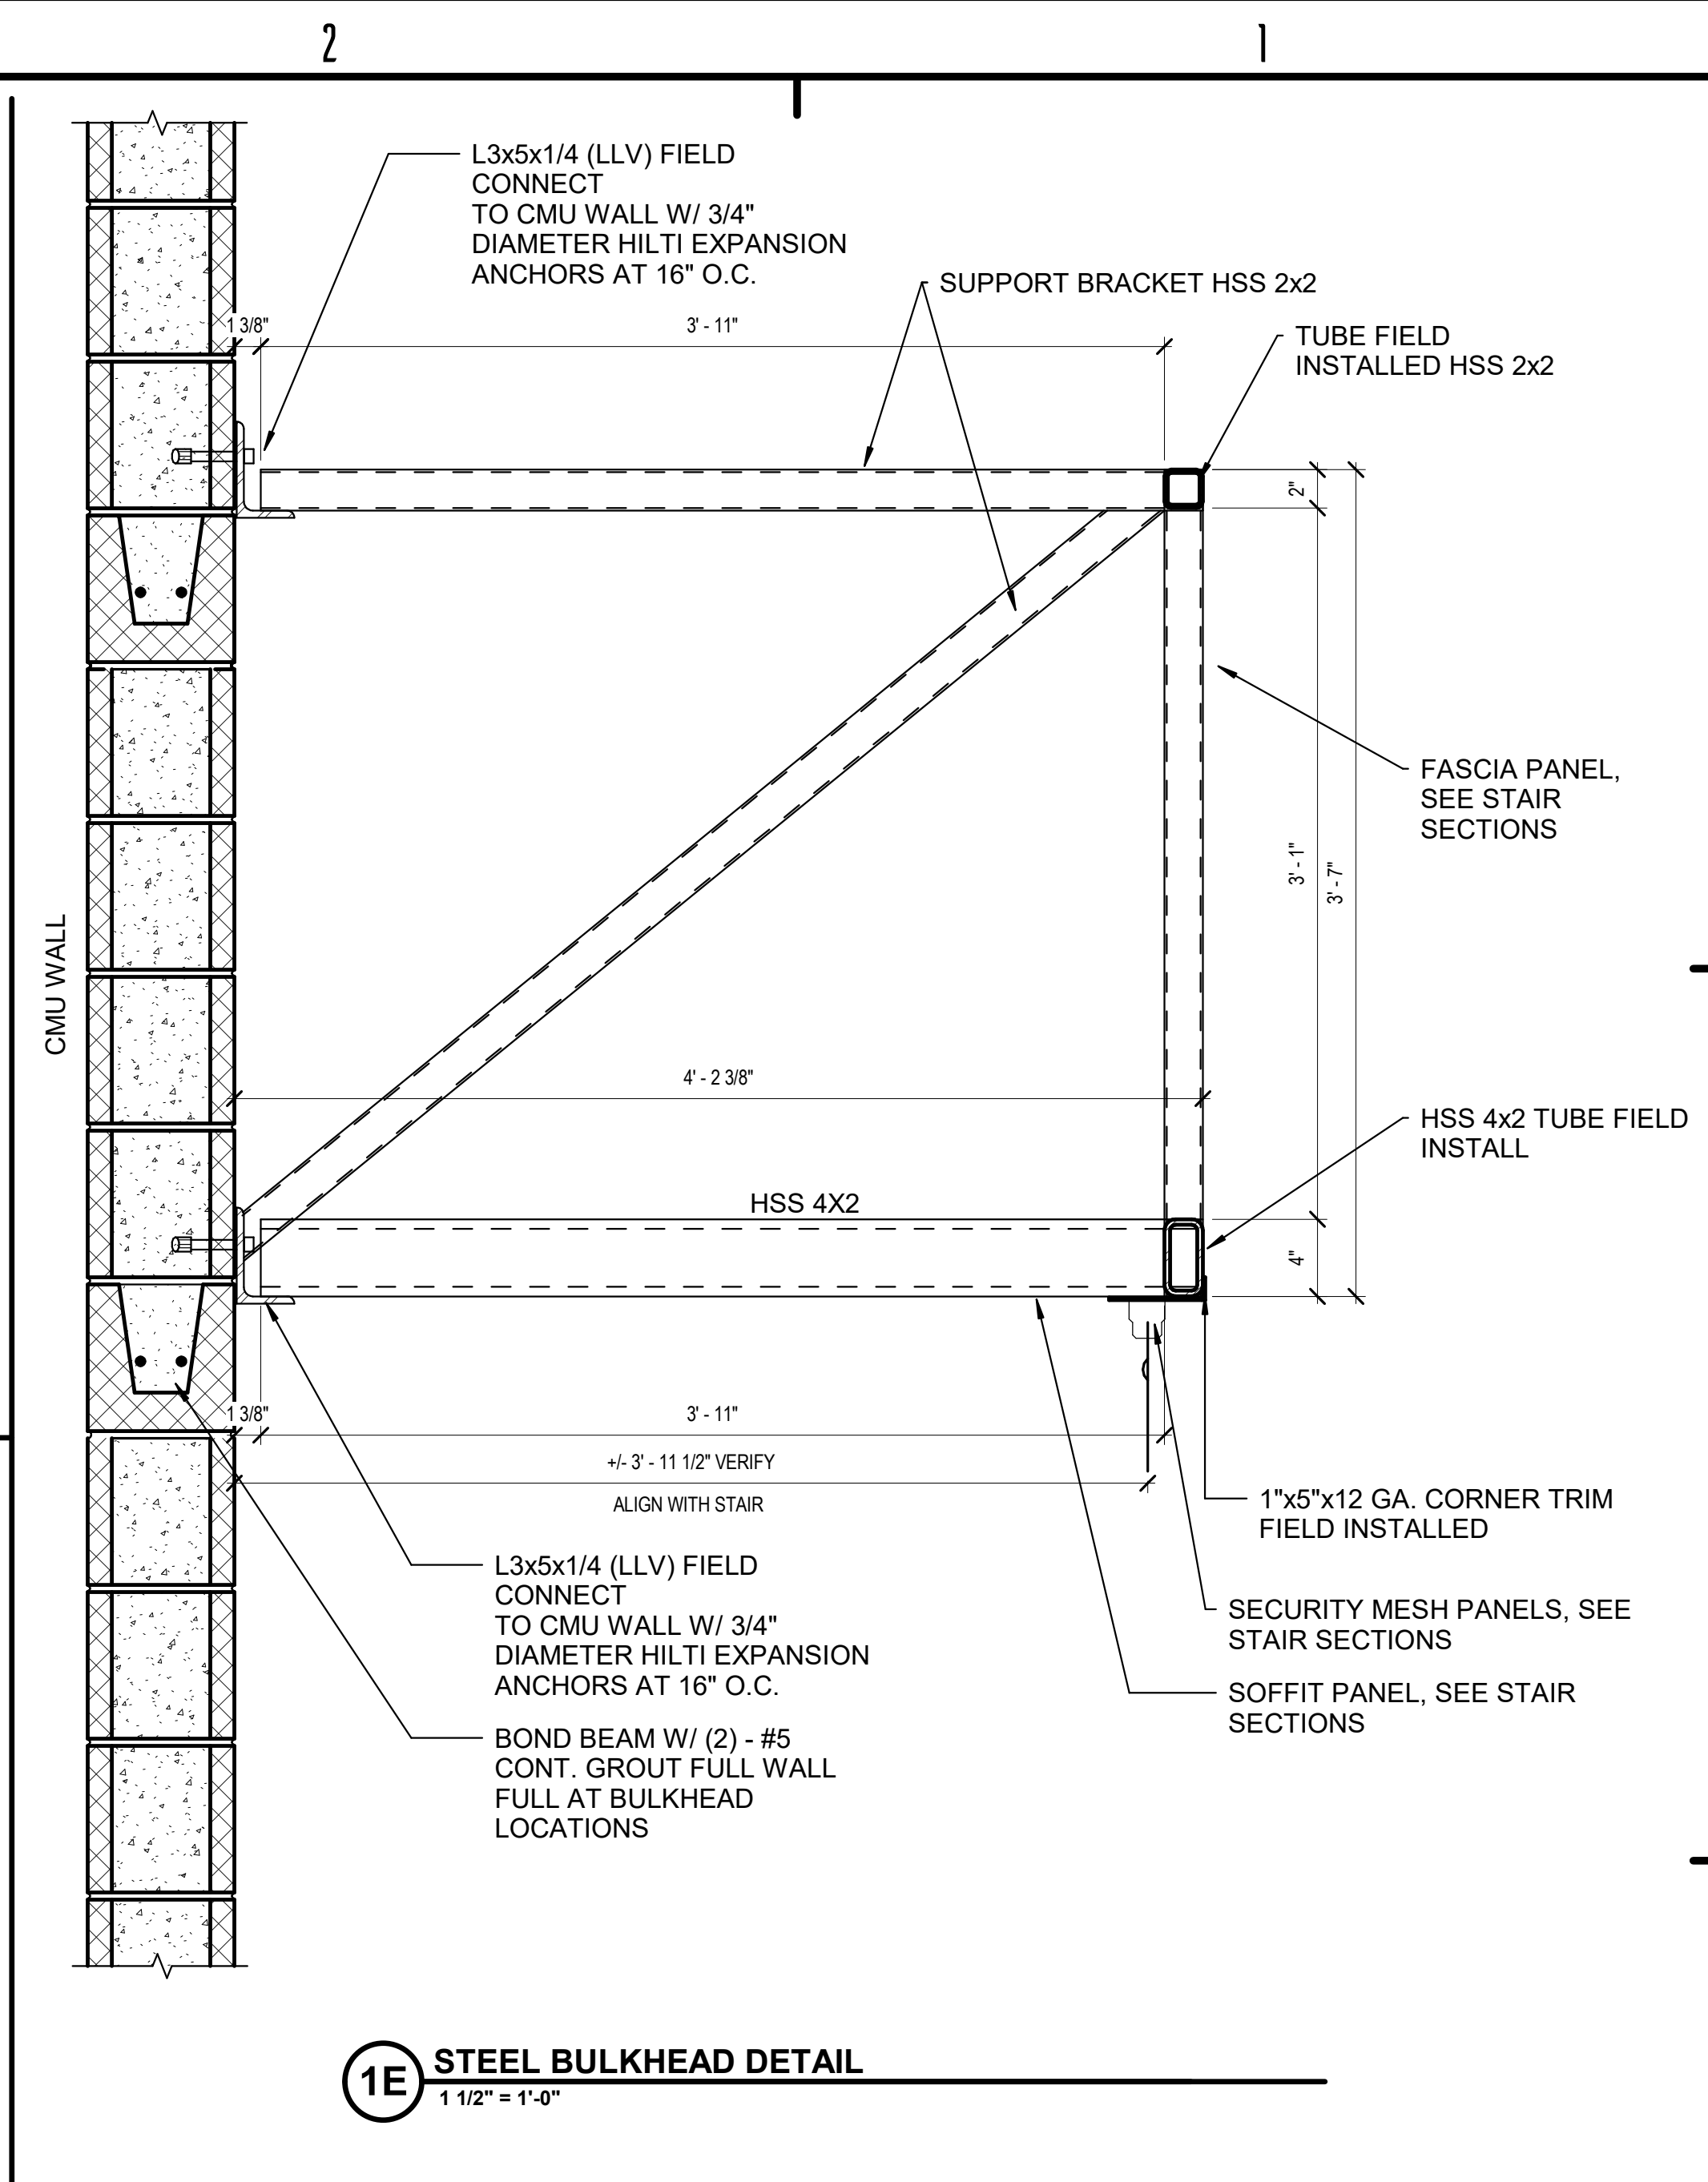


#	Revision	Date
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Project # 20-700-151-2  
Designed By: Designer  
Drawn By: Author  
Checked By: Checker  
Date: 01.28.2022




Eric Wepler  
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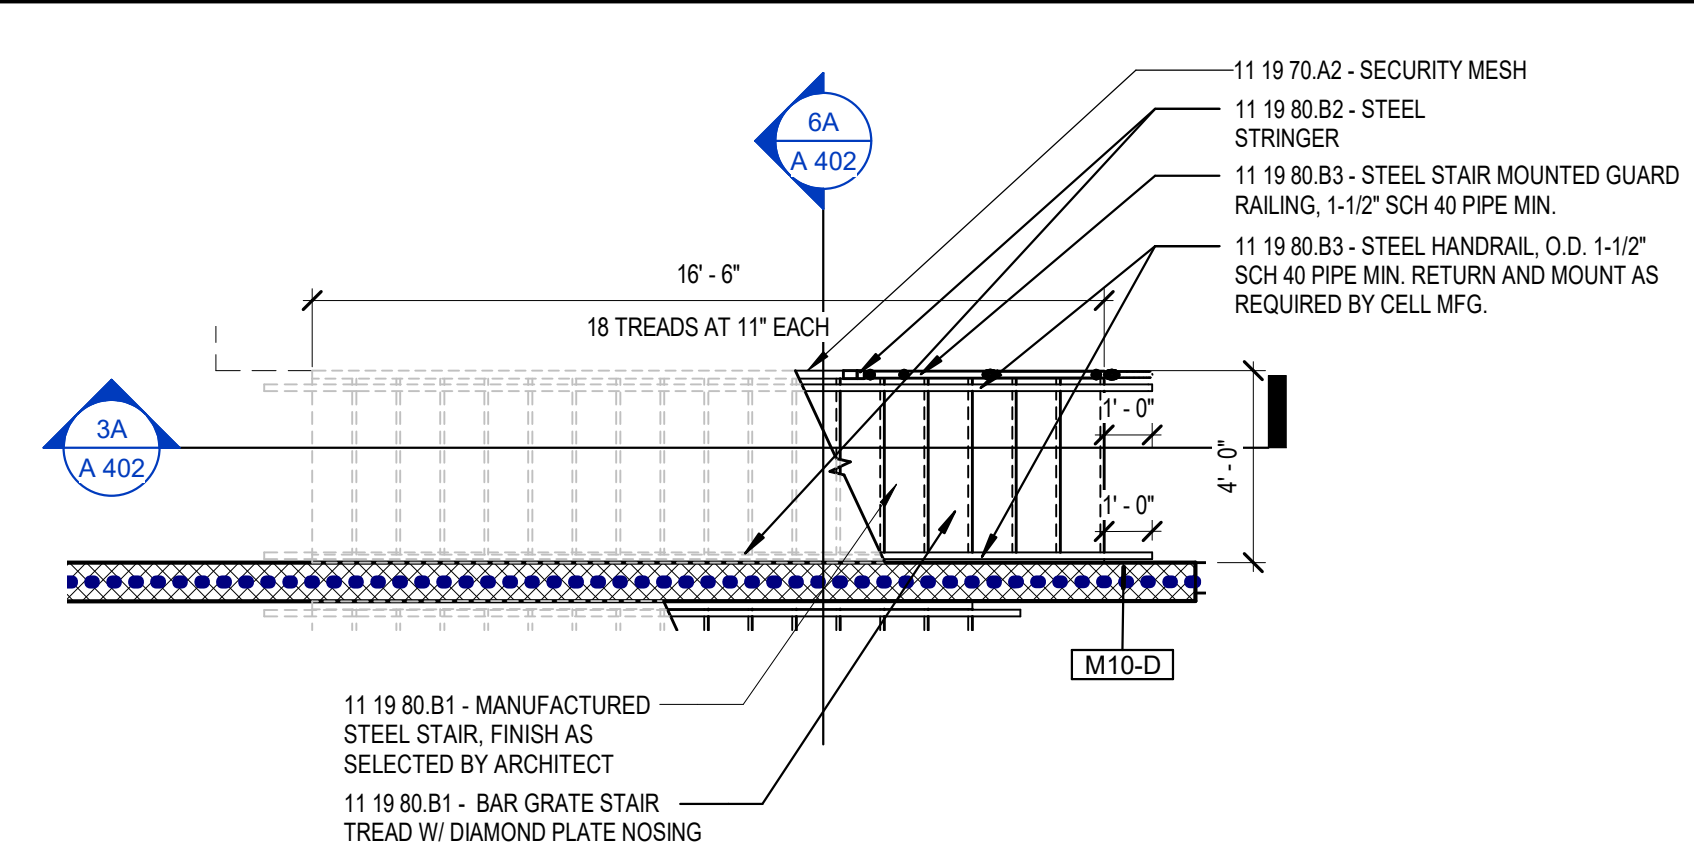


ENLARGED STAIR PLANS  
AND DETAILS

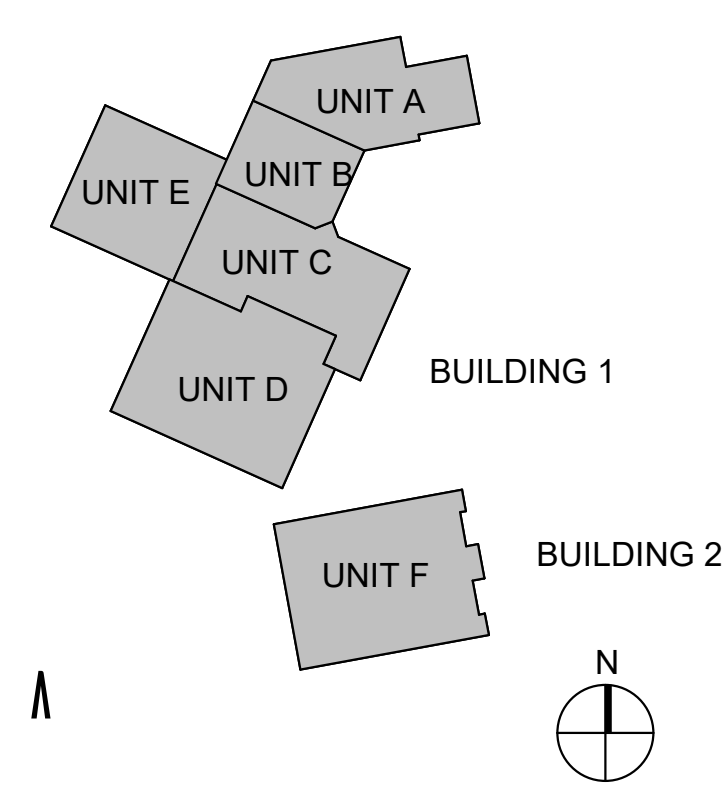
A 402

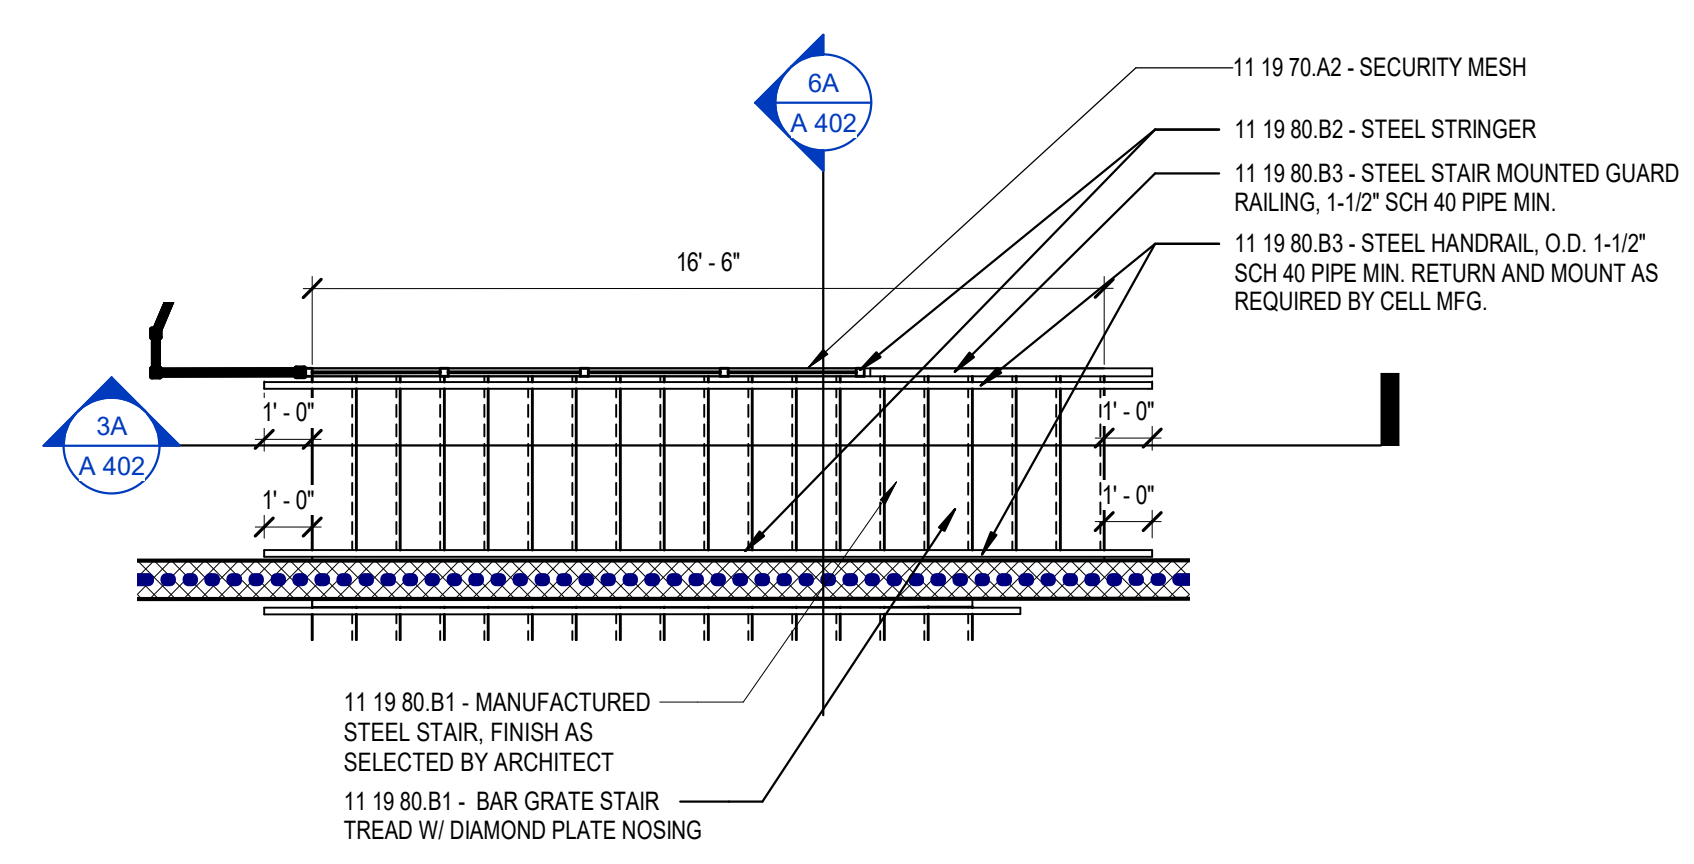


1B) TYP. STAIR AT DORM HOUSING SECOND FLOOR PLAN  
1/4" = 1'-0"



1A) TYPICAL STAIR AT DORM HOUSING FIRST FLOOR PLAN  
1/4" = 1'-0"

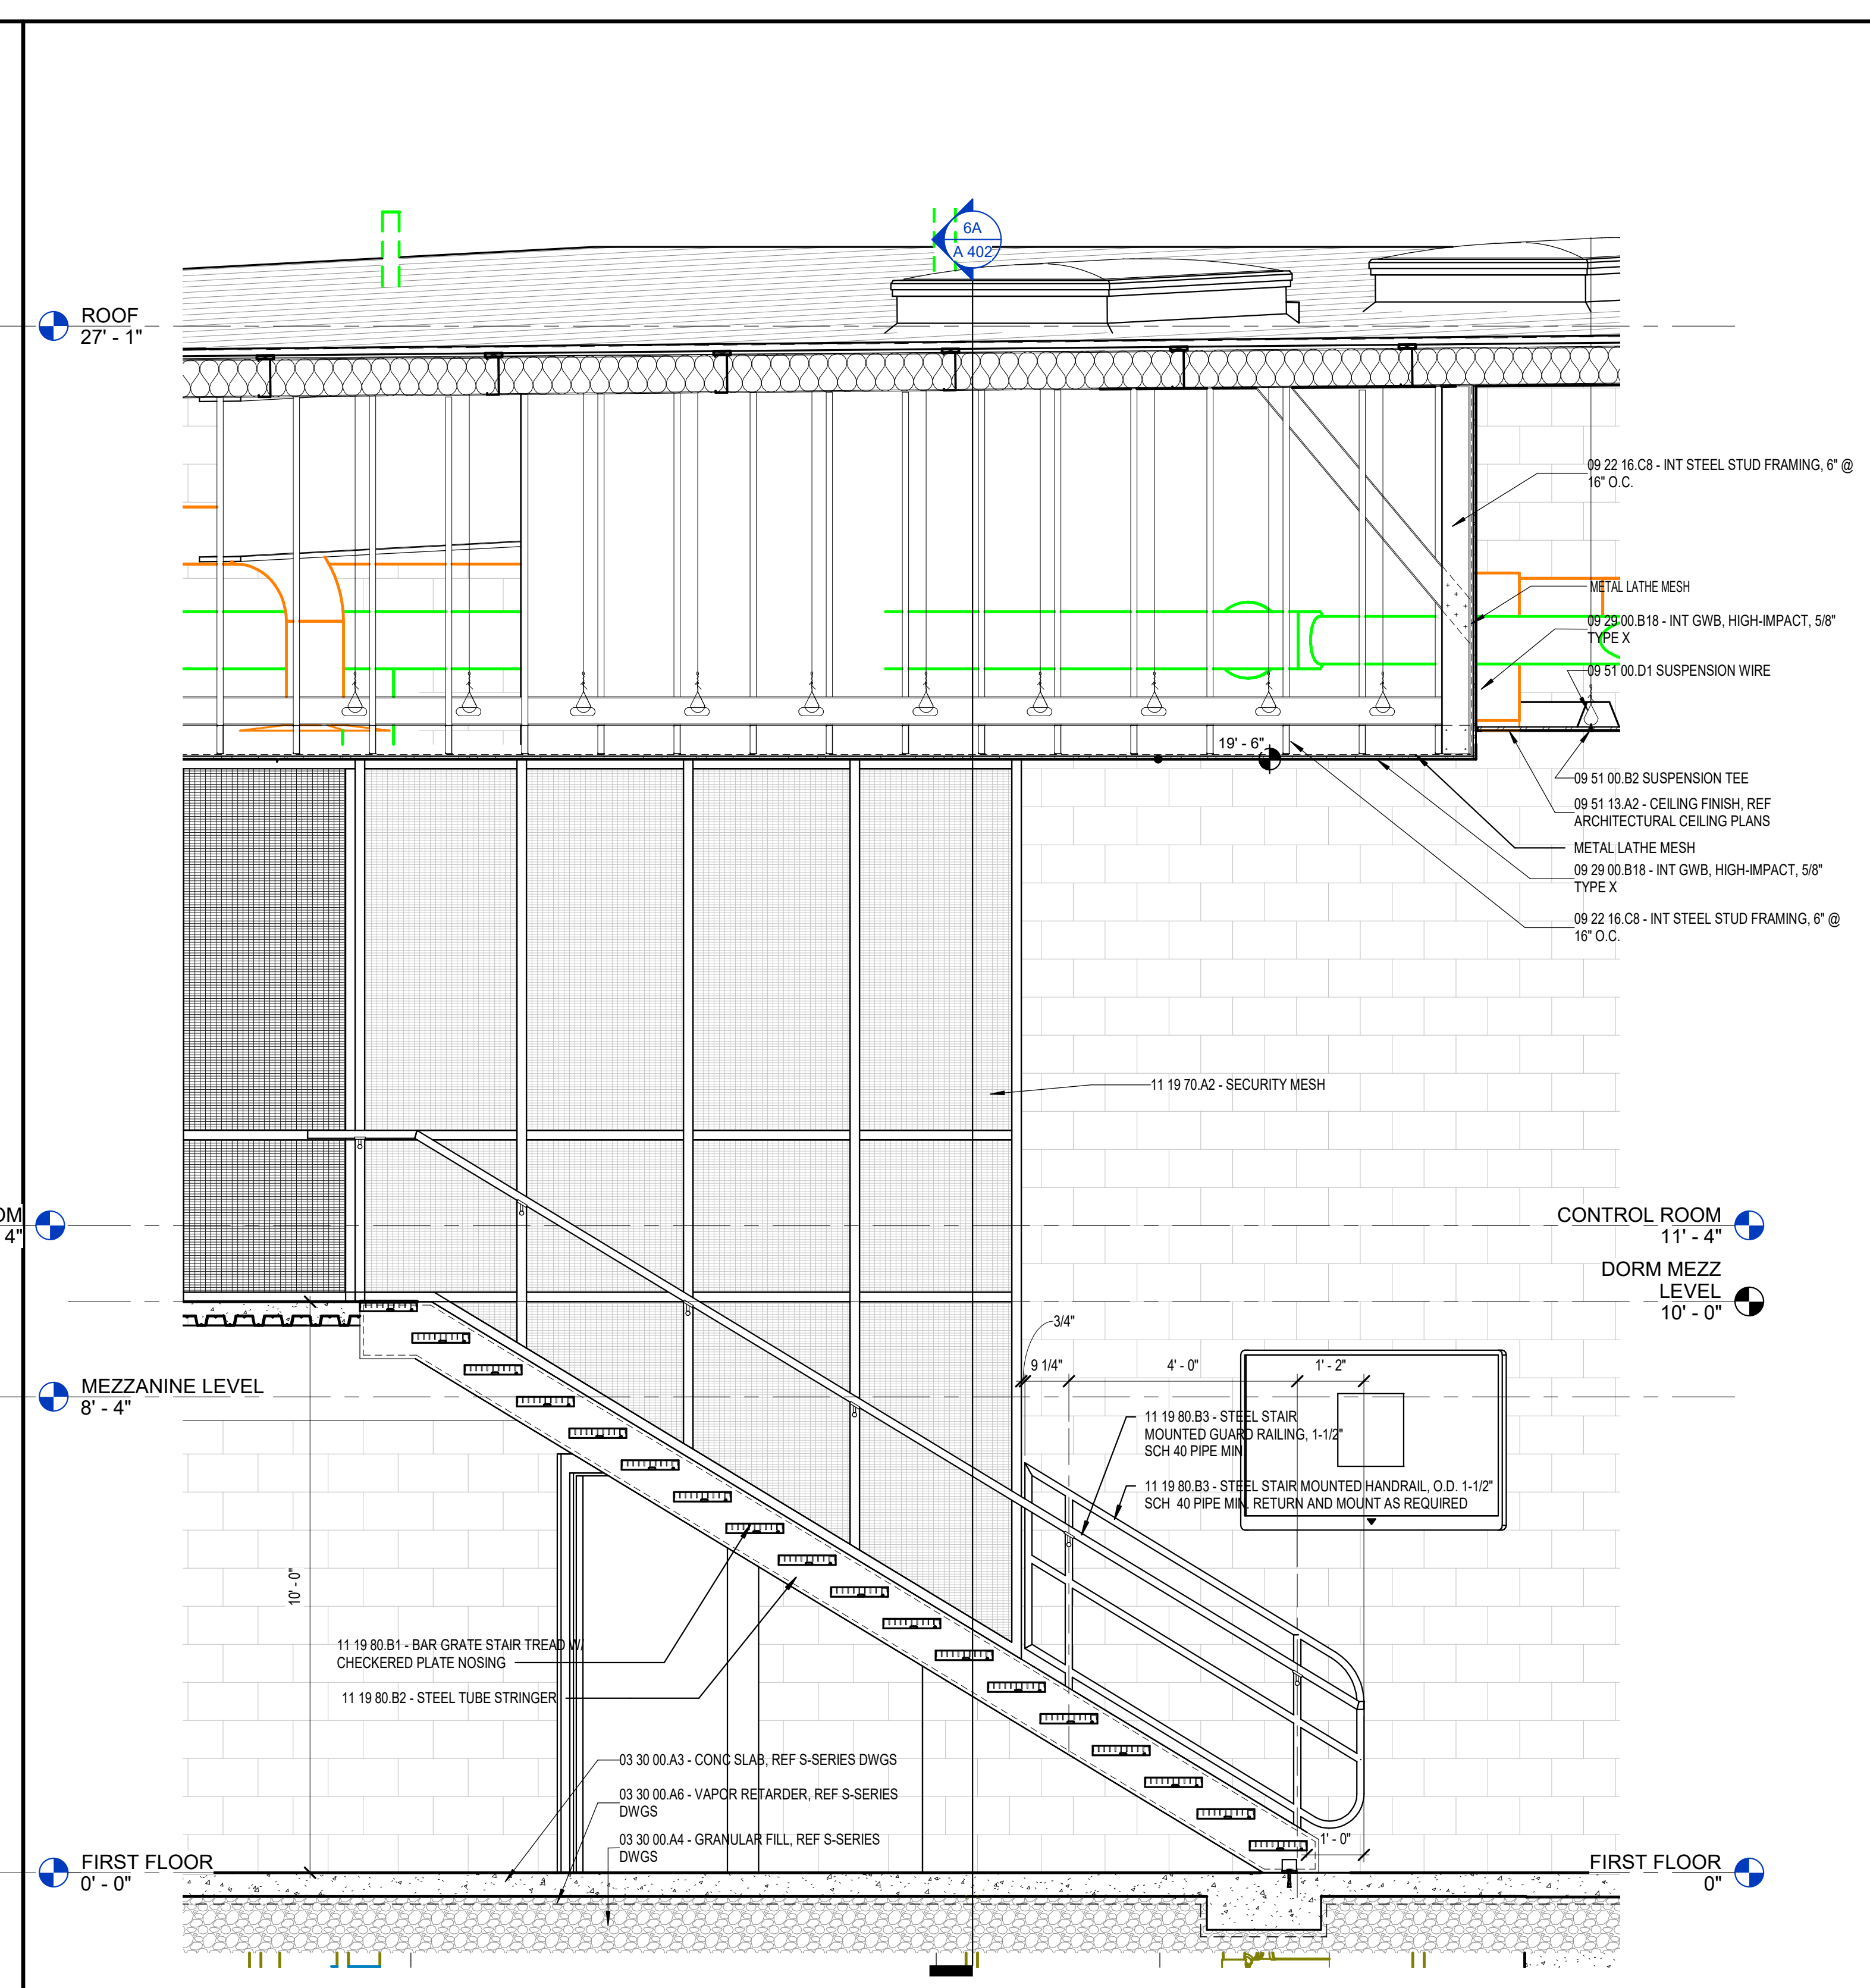

3A) TYPICAL STAIR AT DORM HOUSING SECTION 1  
1/2" = 1'-0"

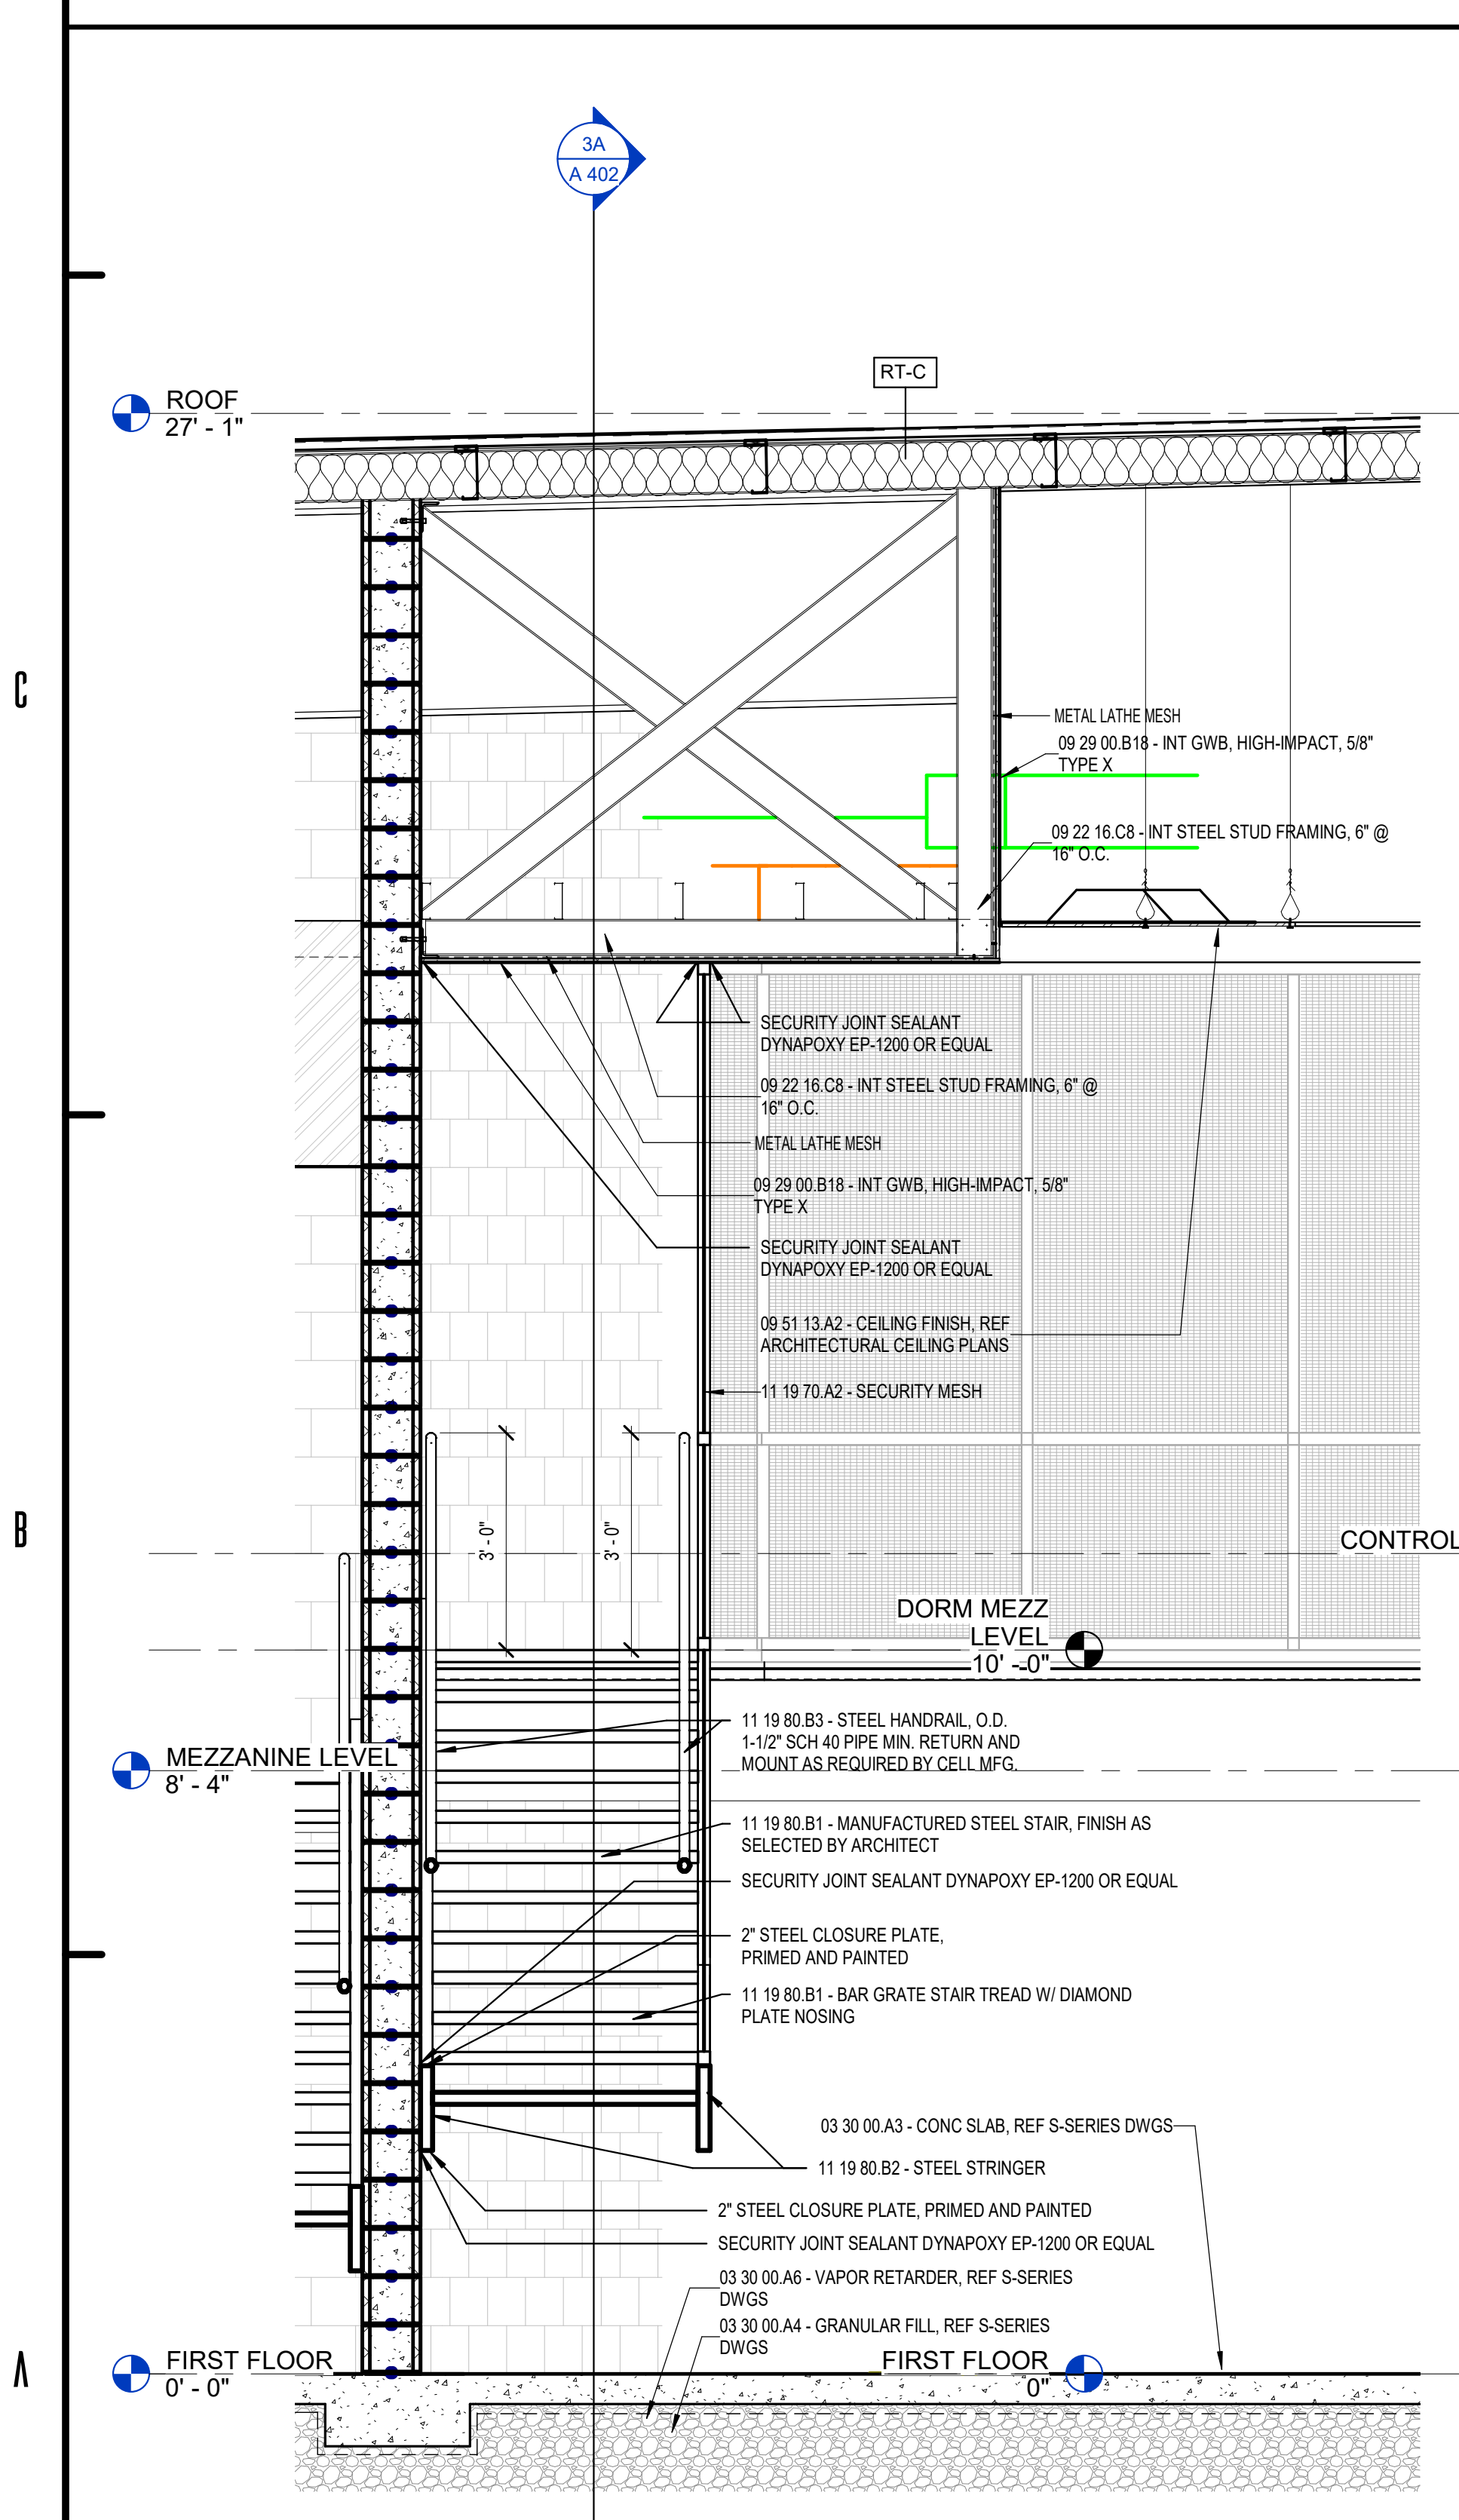


6A) TYPICAL STAIR AT DORM HOUSING SECTION 2  
1/2" = 1'-0"




#	Revision	Date
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Project #: 20-700-151-2  
Designed By: Designer  
Drawn By: Author  
Checked By: Checker  
Date: 01.28.2022

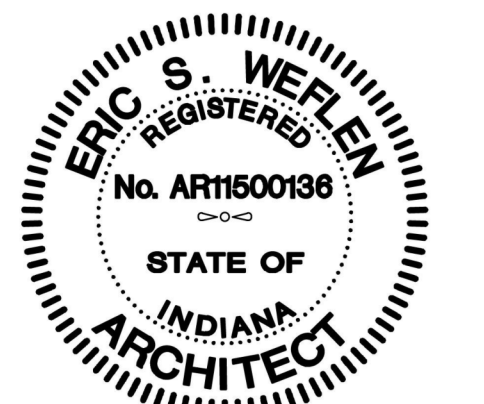


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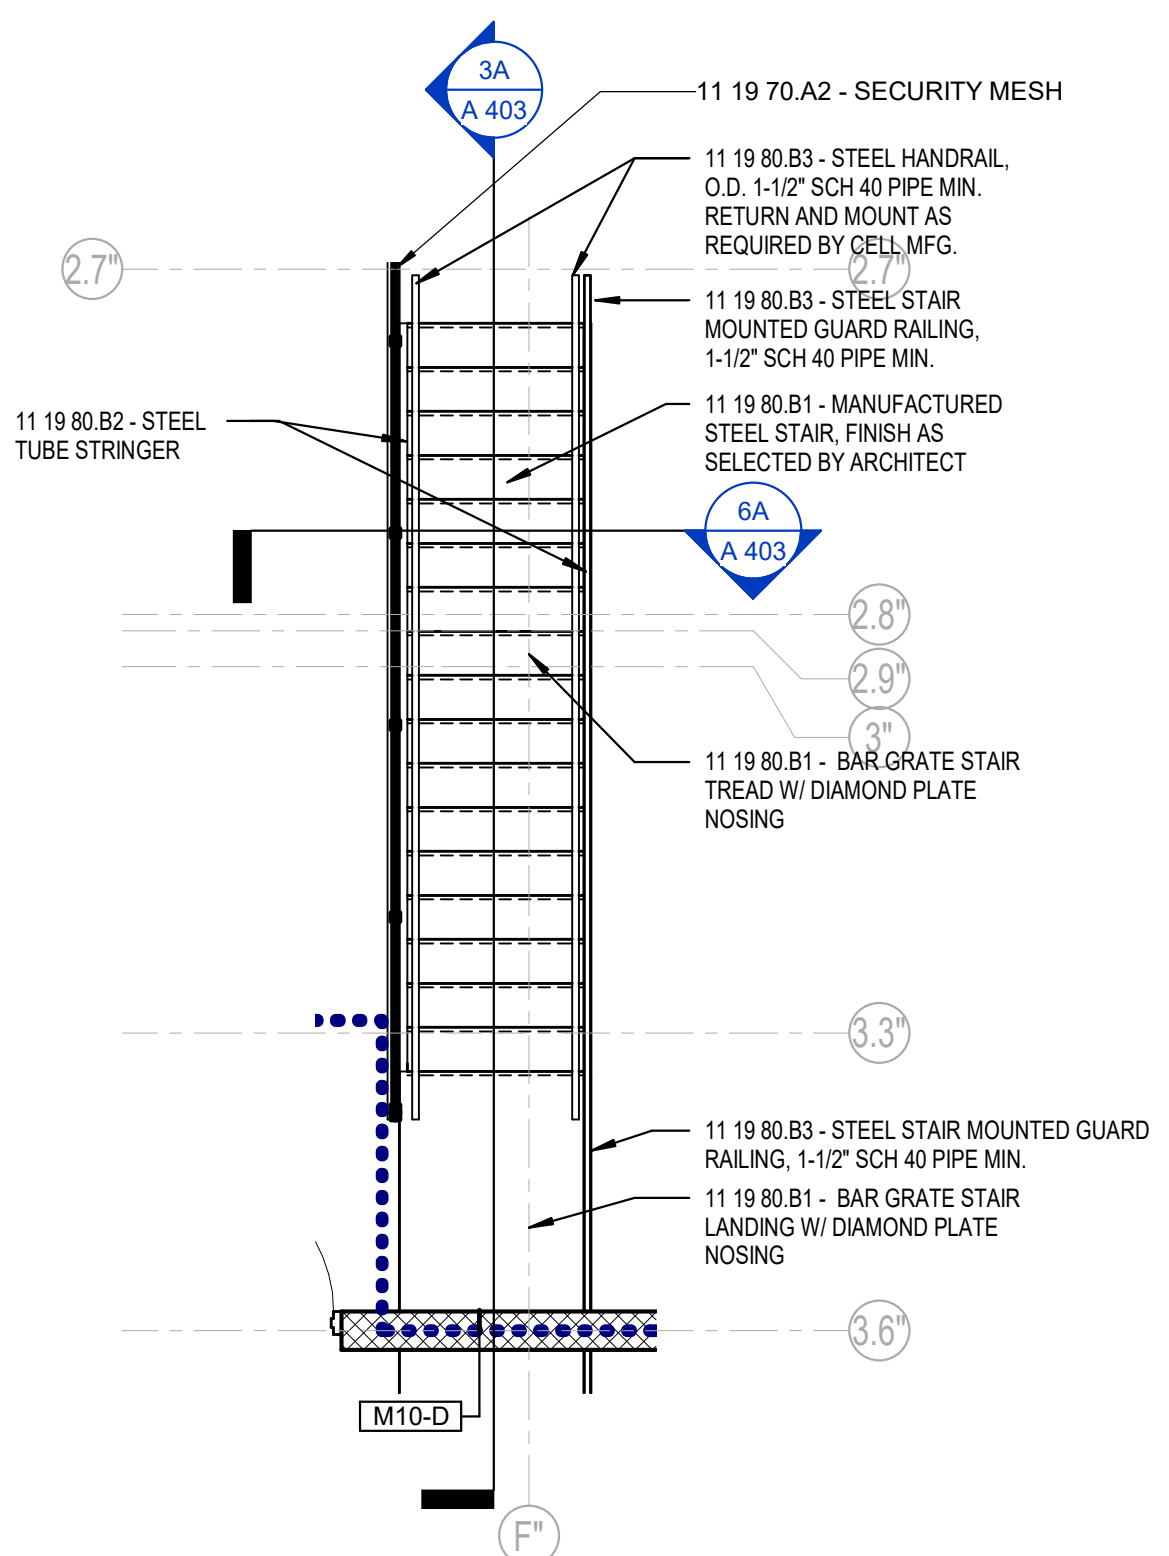


ENLARGED STAIR PLANS  
AND DETAILS

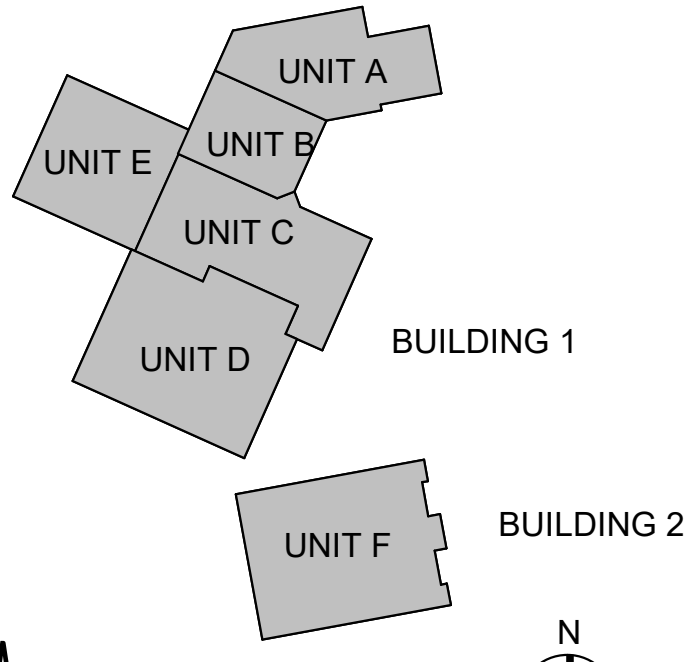
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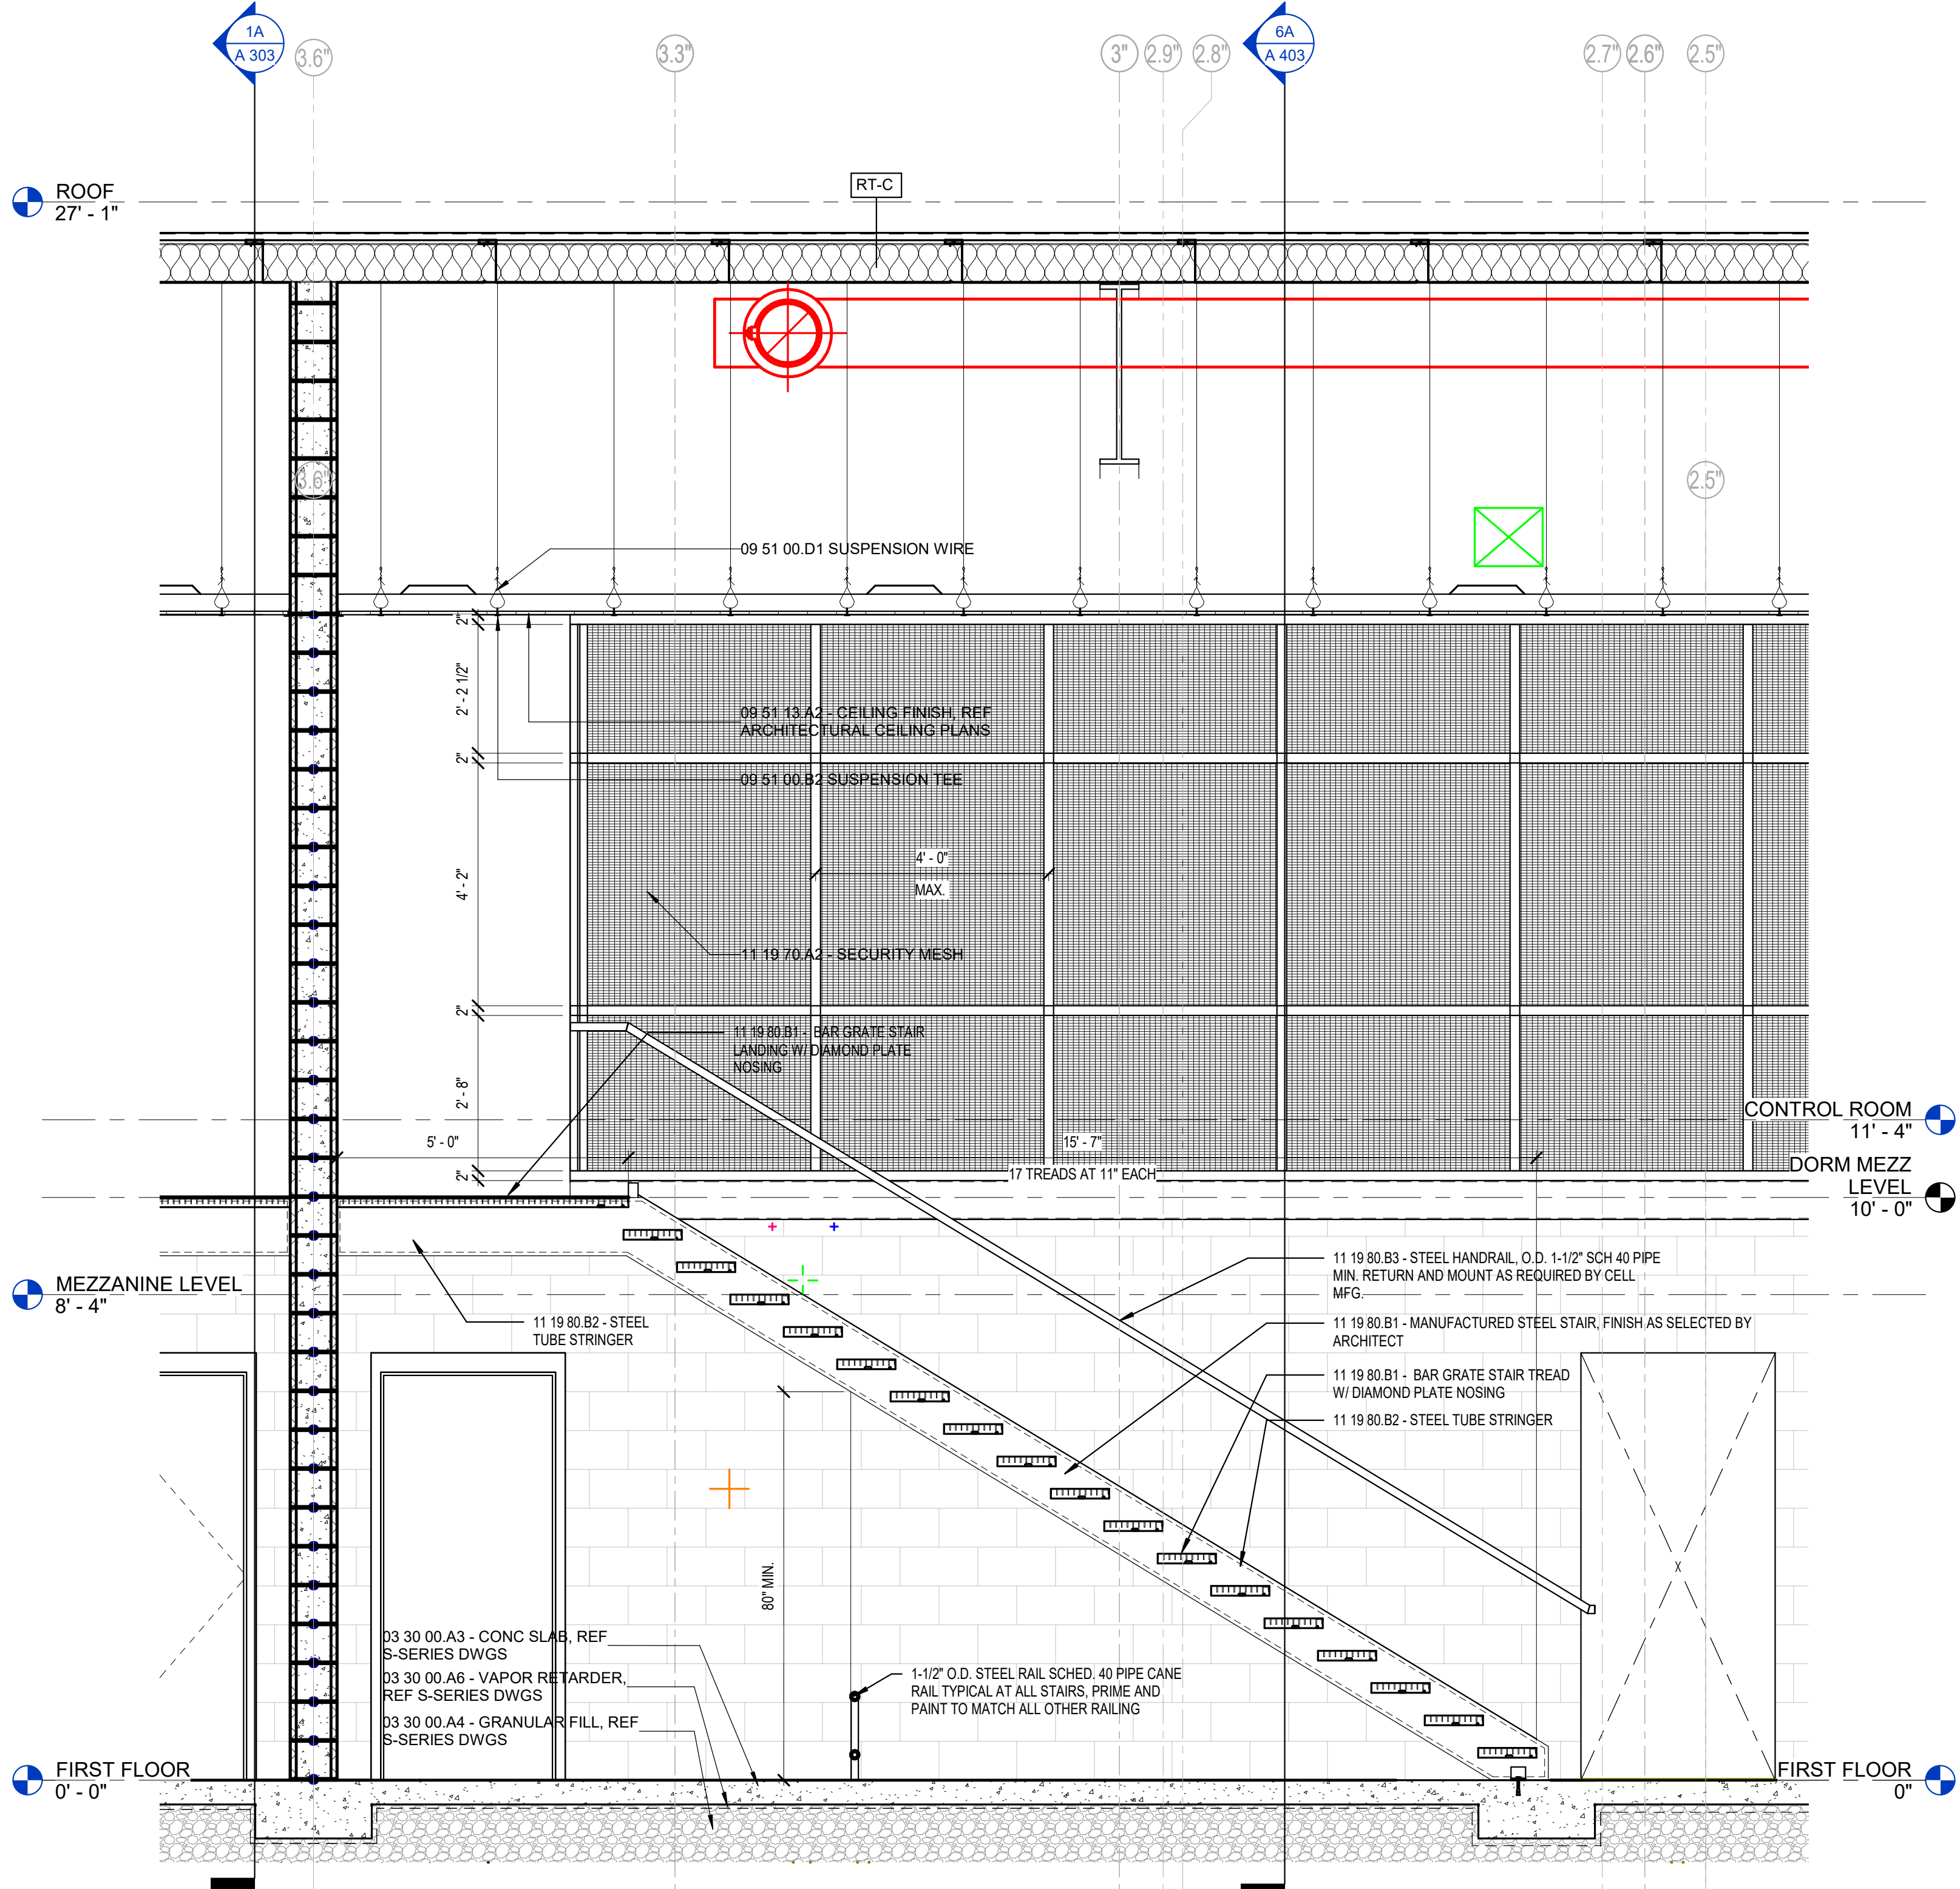
1E COMMUNITY CORRECTIONS STAIR AXON

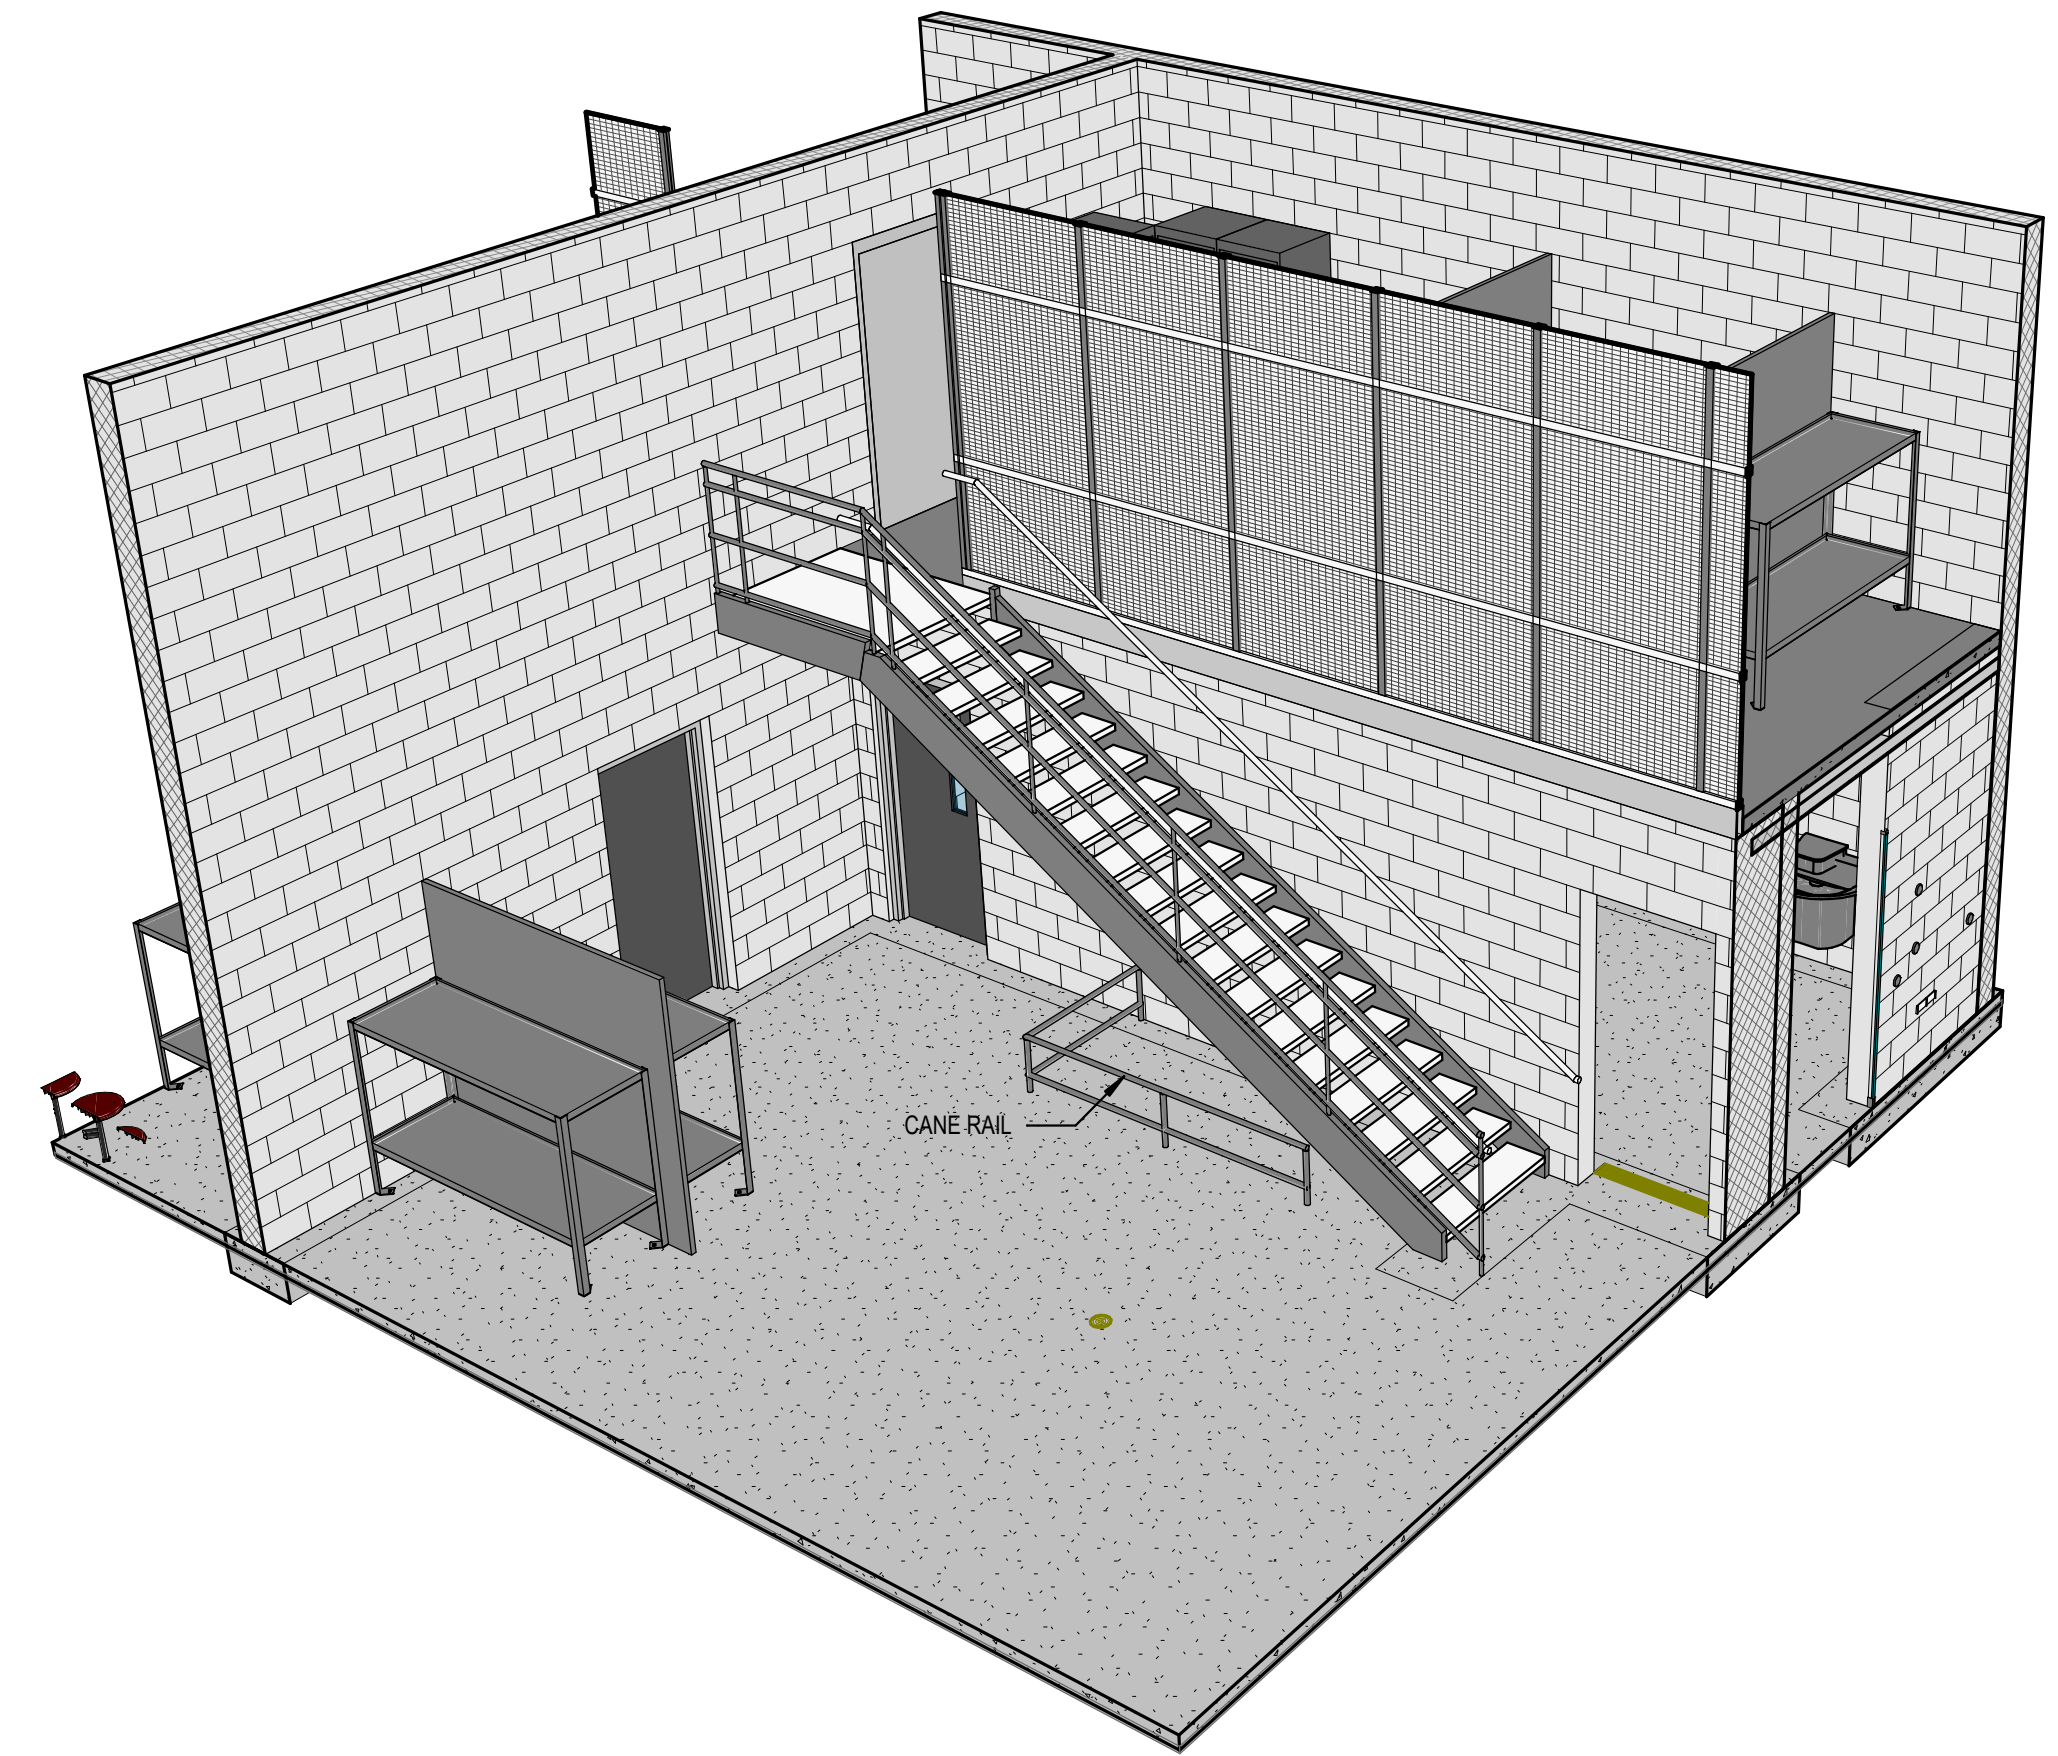


1B UNIT F - ENLARGED SECOND FLOOR PLAN STAIR DAYROOM 168  
1/4" = 1'-0"



1A UNIT F - ENLARGED PLAN STAIR DAYROOM 168  
1/4" = 1'-0"

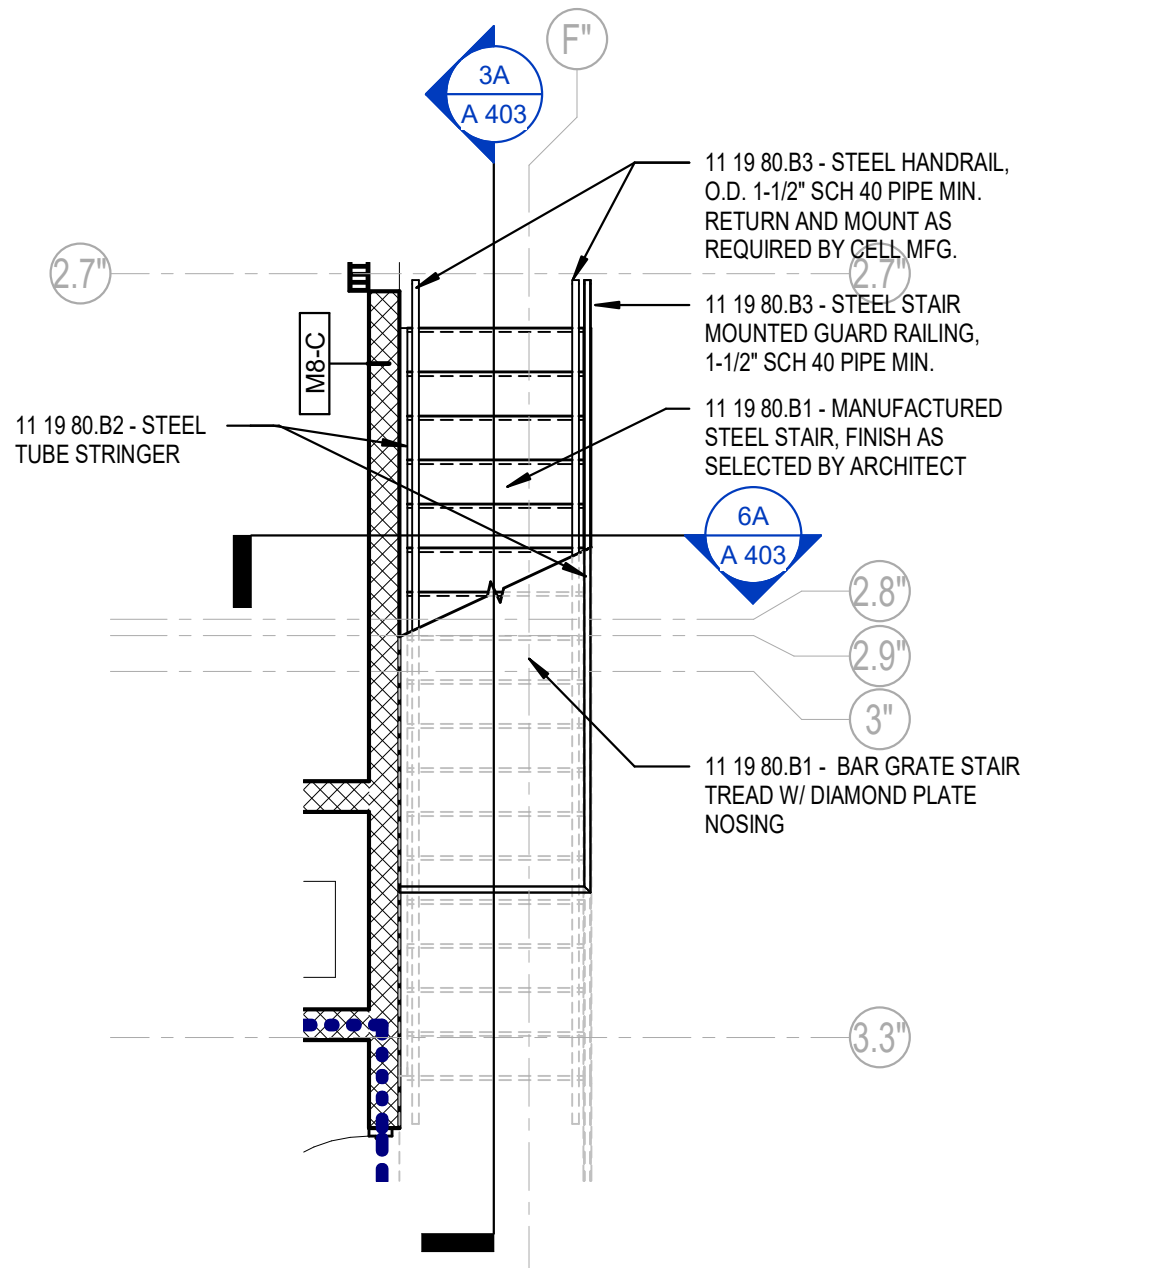

3A UNIT F - STAIR SECTION 1  
1/2" = 1'-0"

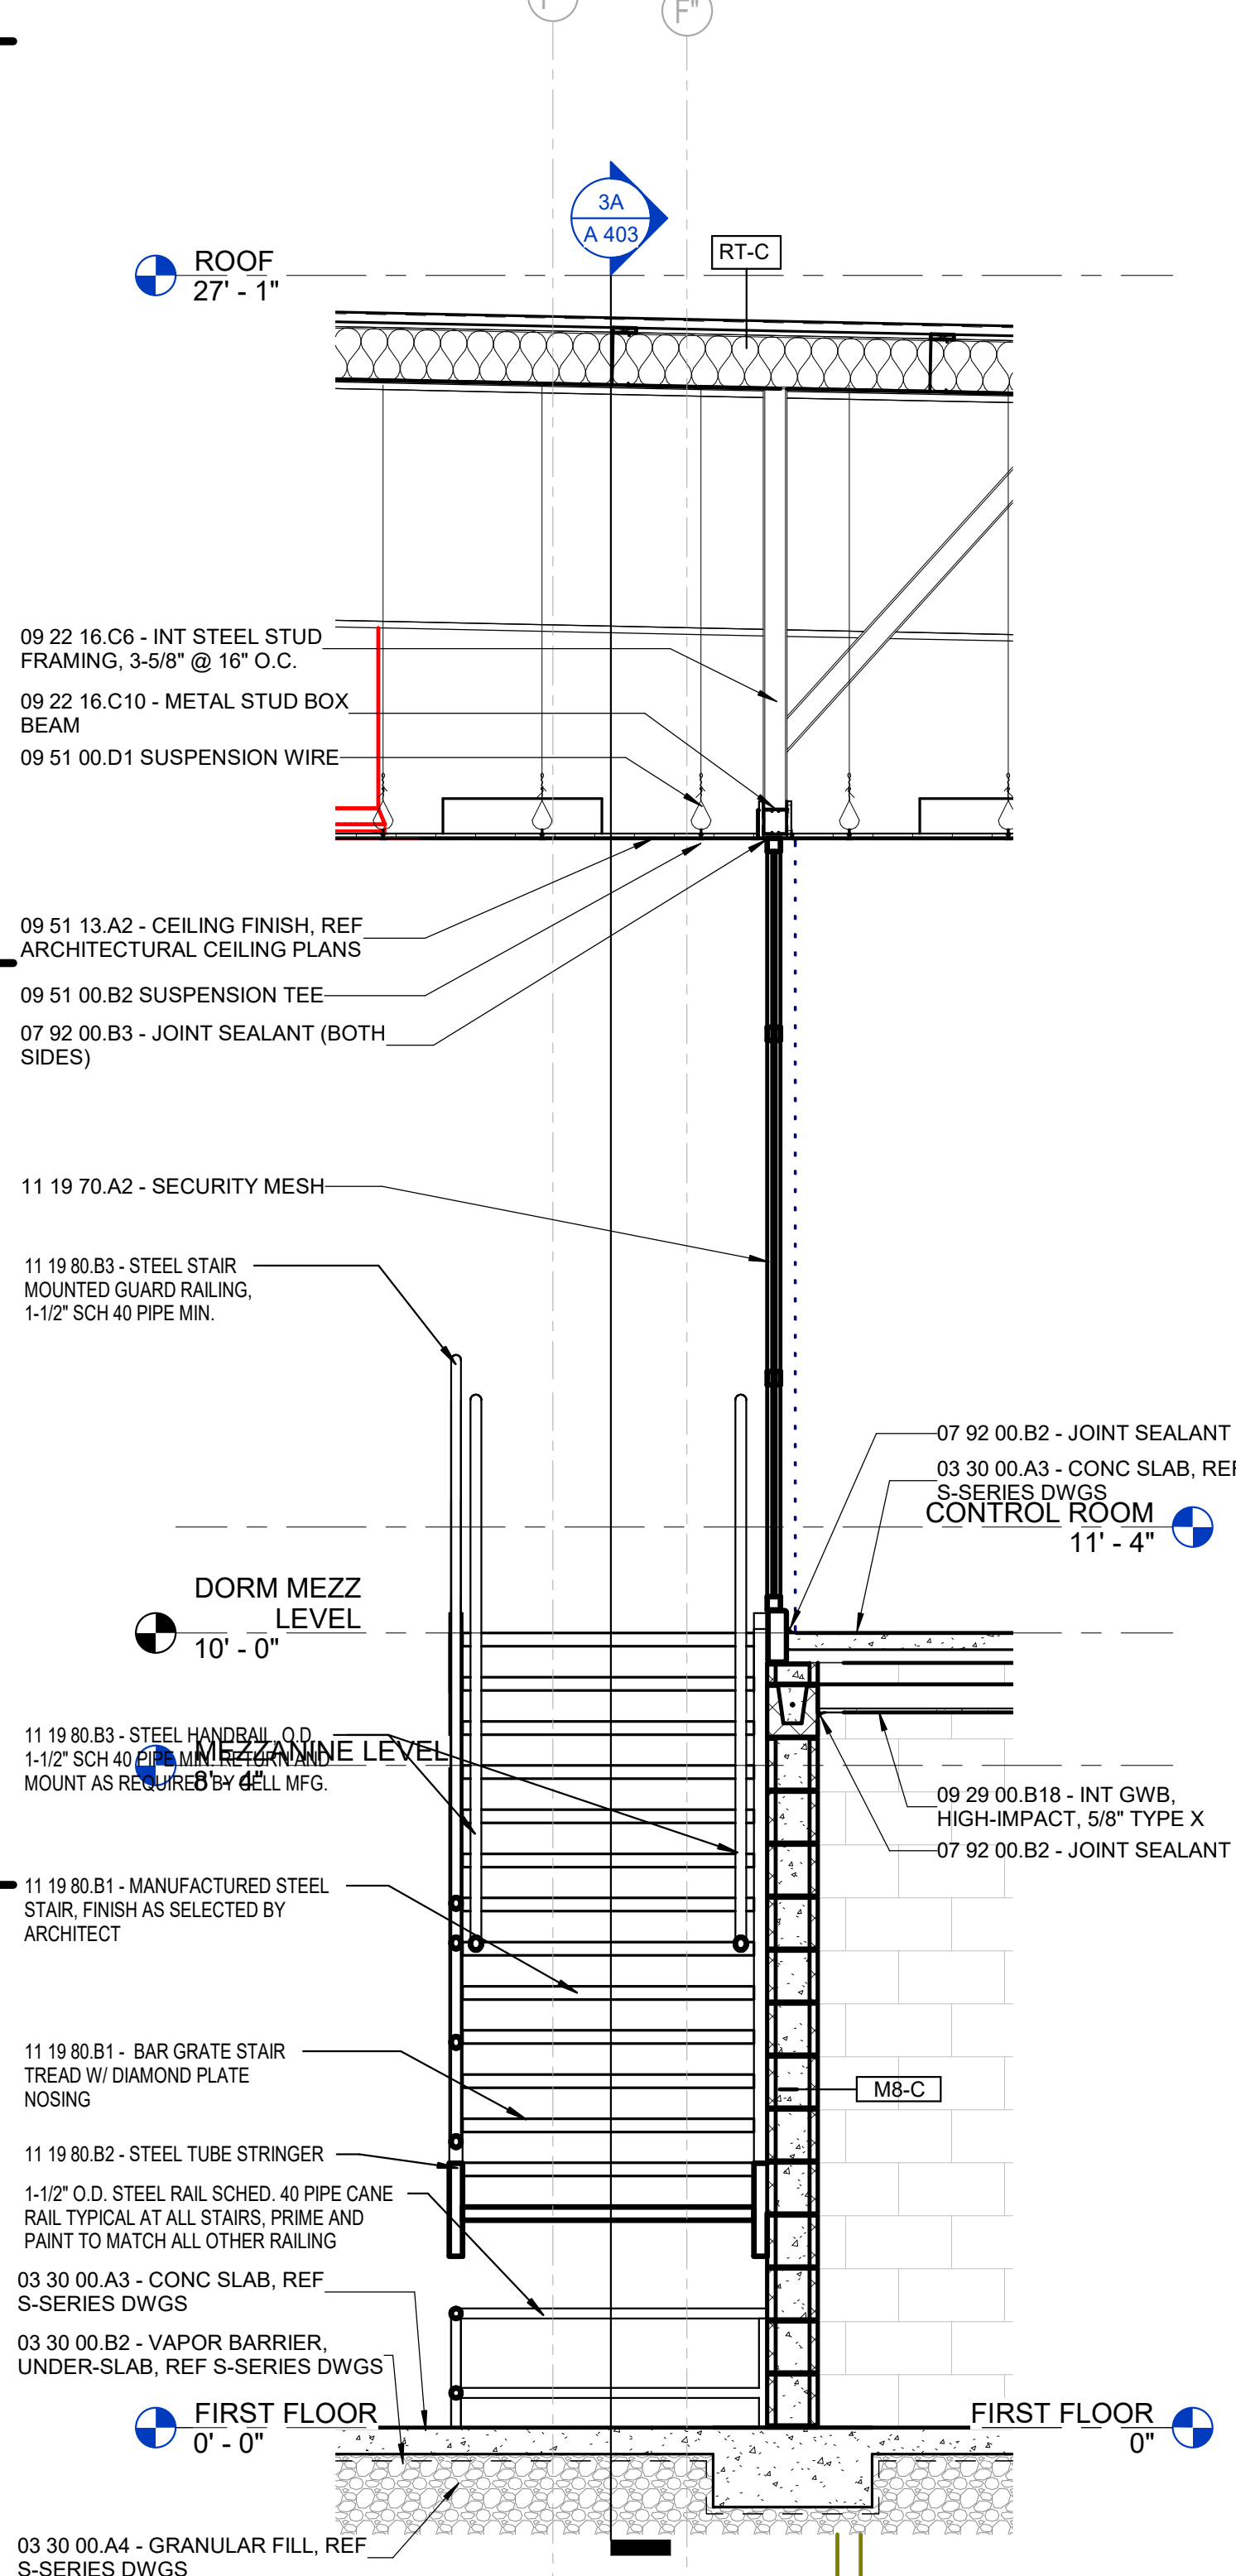

6A UNIT F - STAIR SECTION 2  
1/2" = 1'-0"




#	Revision	Date

Project #: 20-700-151-2  
Designed By: LD/SP  
Drawn By: CW  
Checked By: LD/IV  
Date: 01.28.2022












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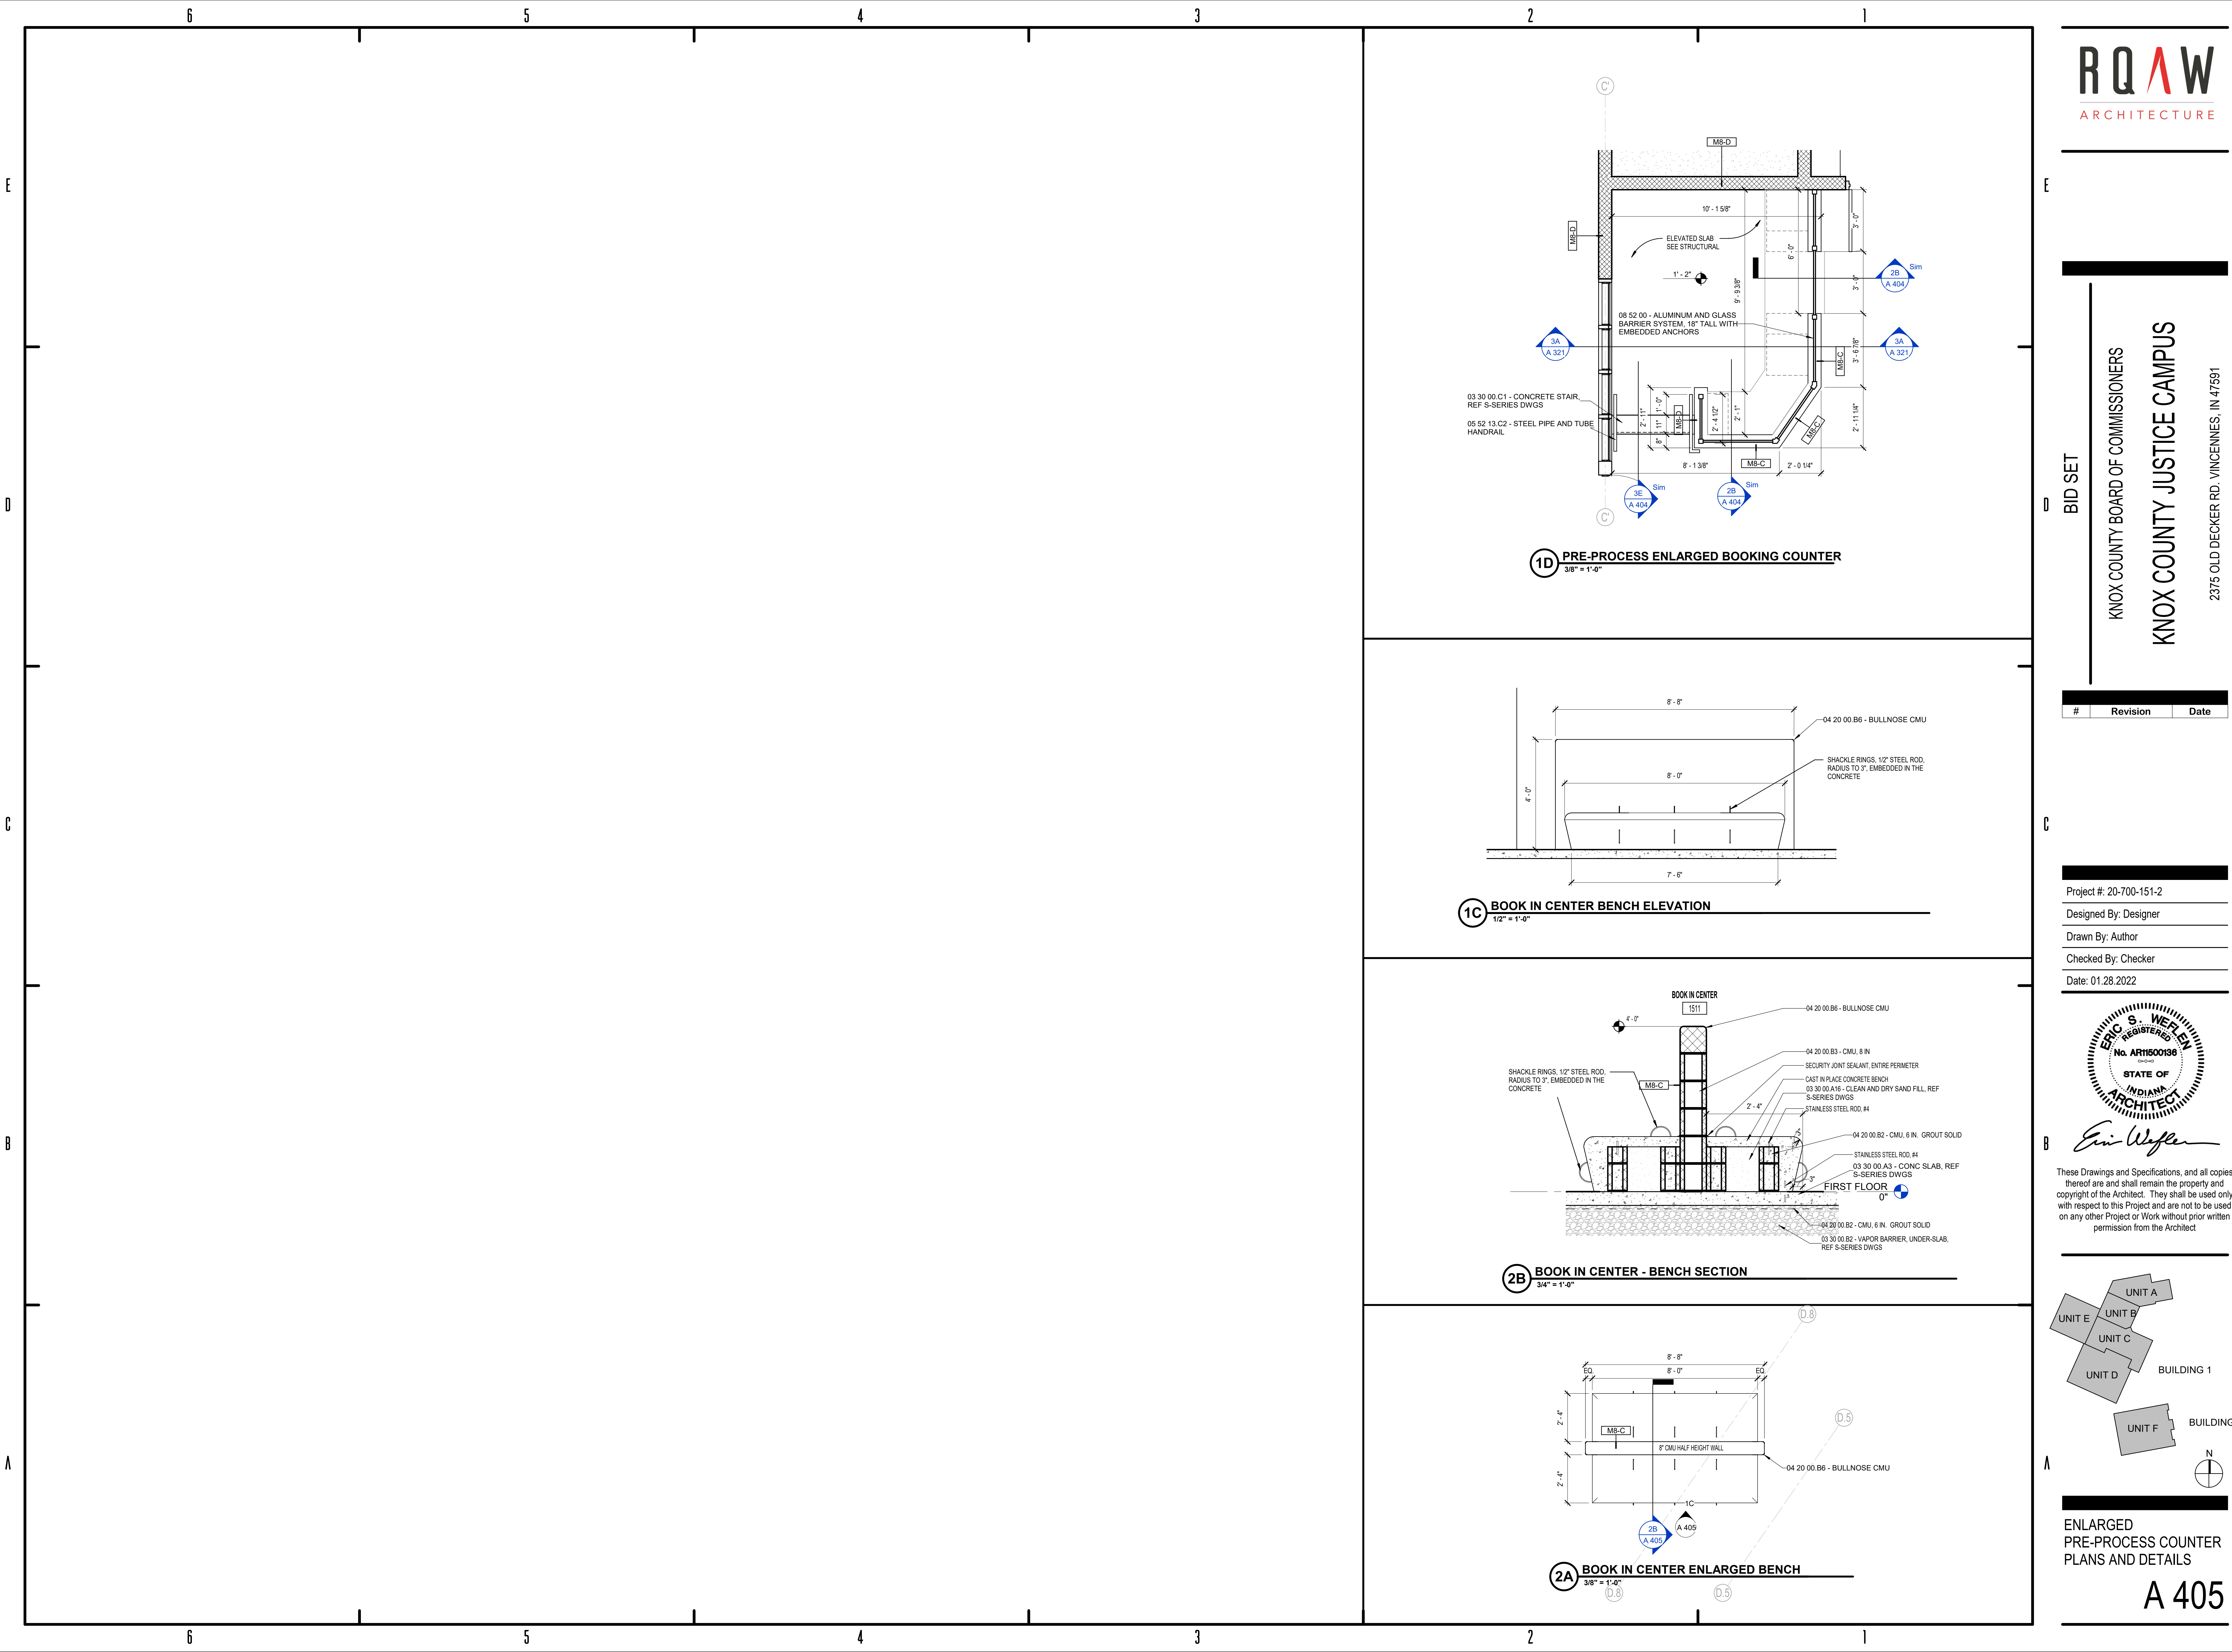


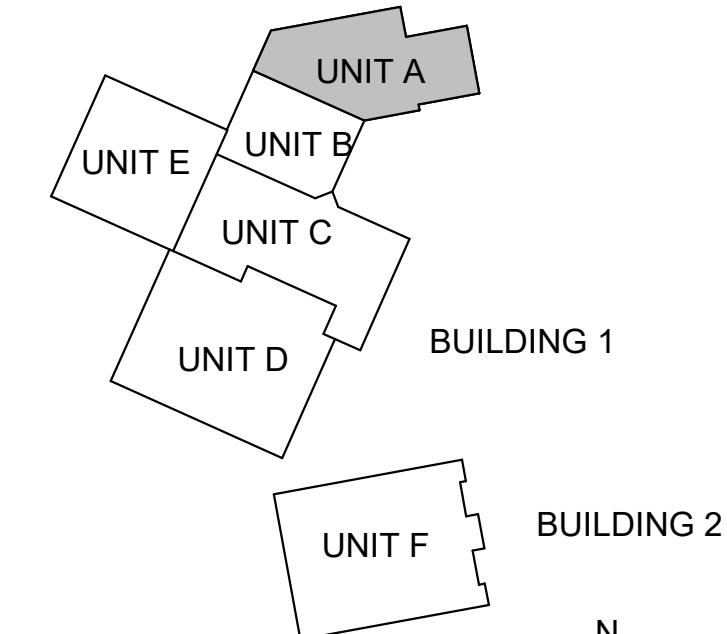ENLARGED BOOK IN COUNTER PLANS AND DETAILS

**A 404**




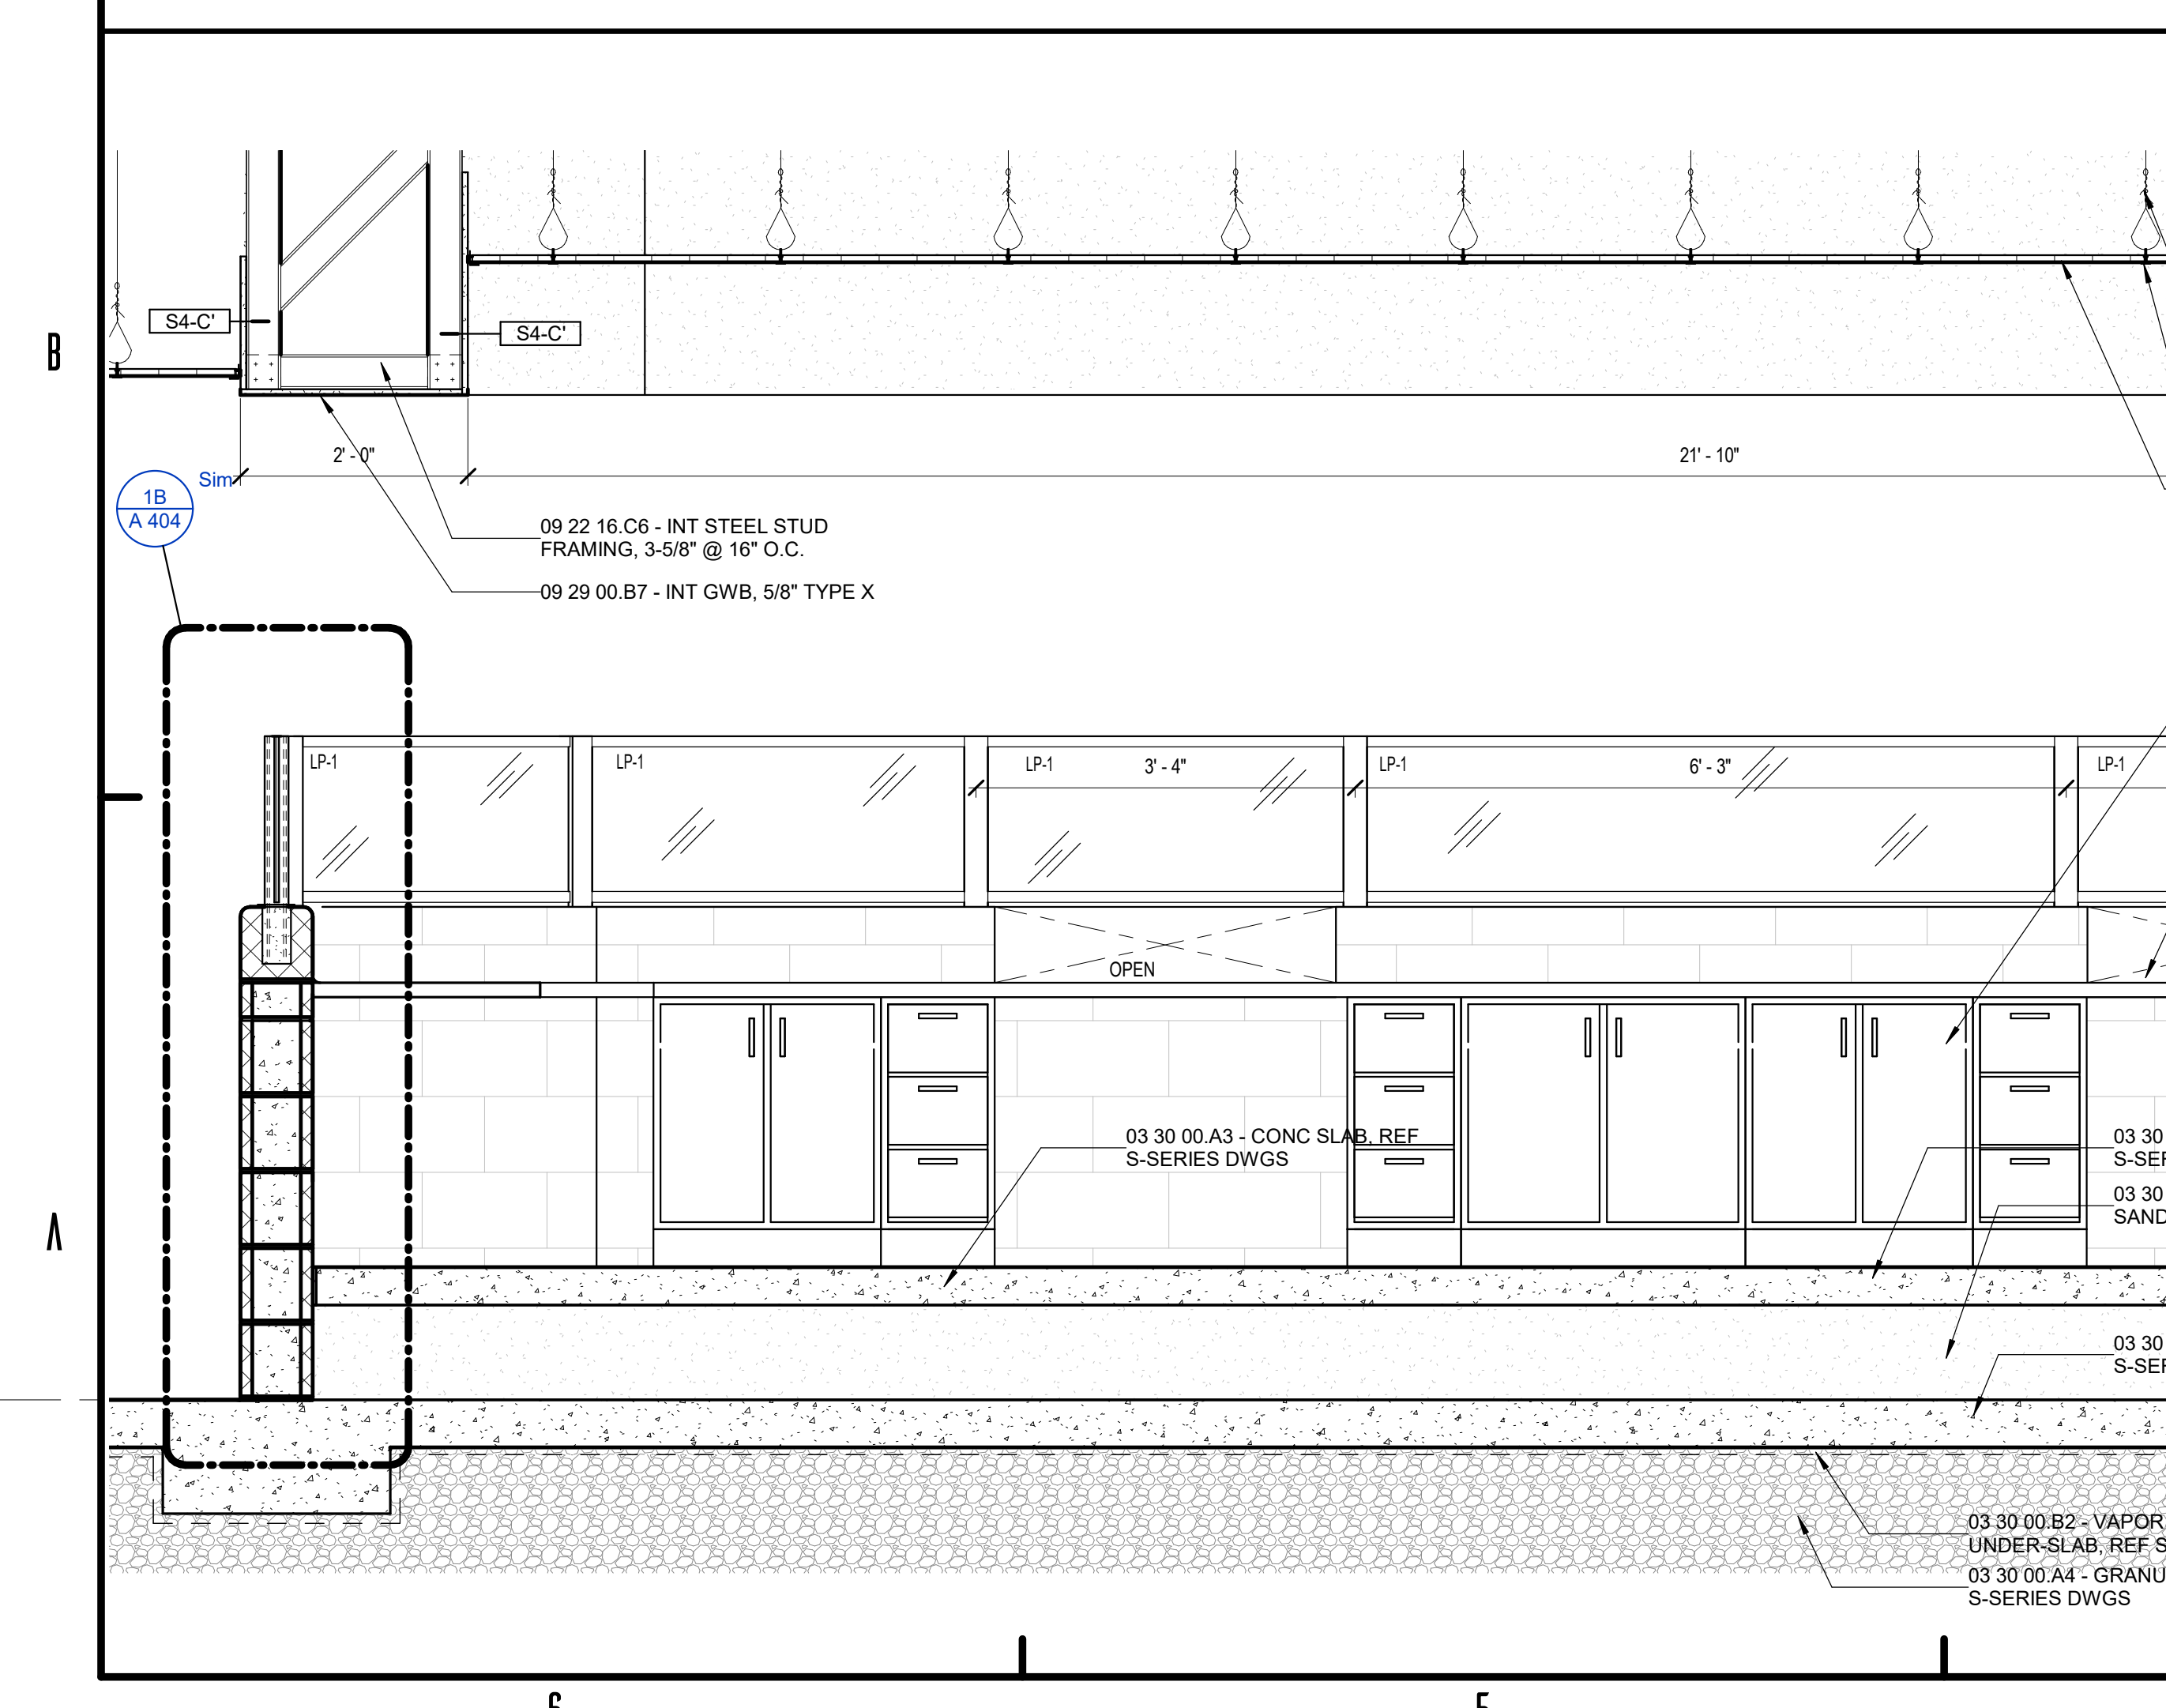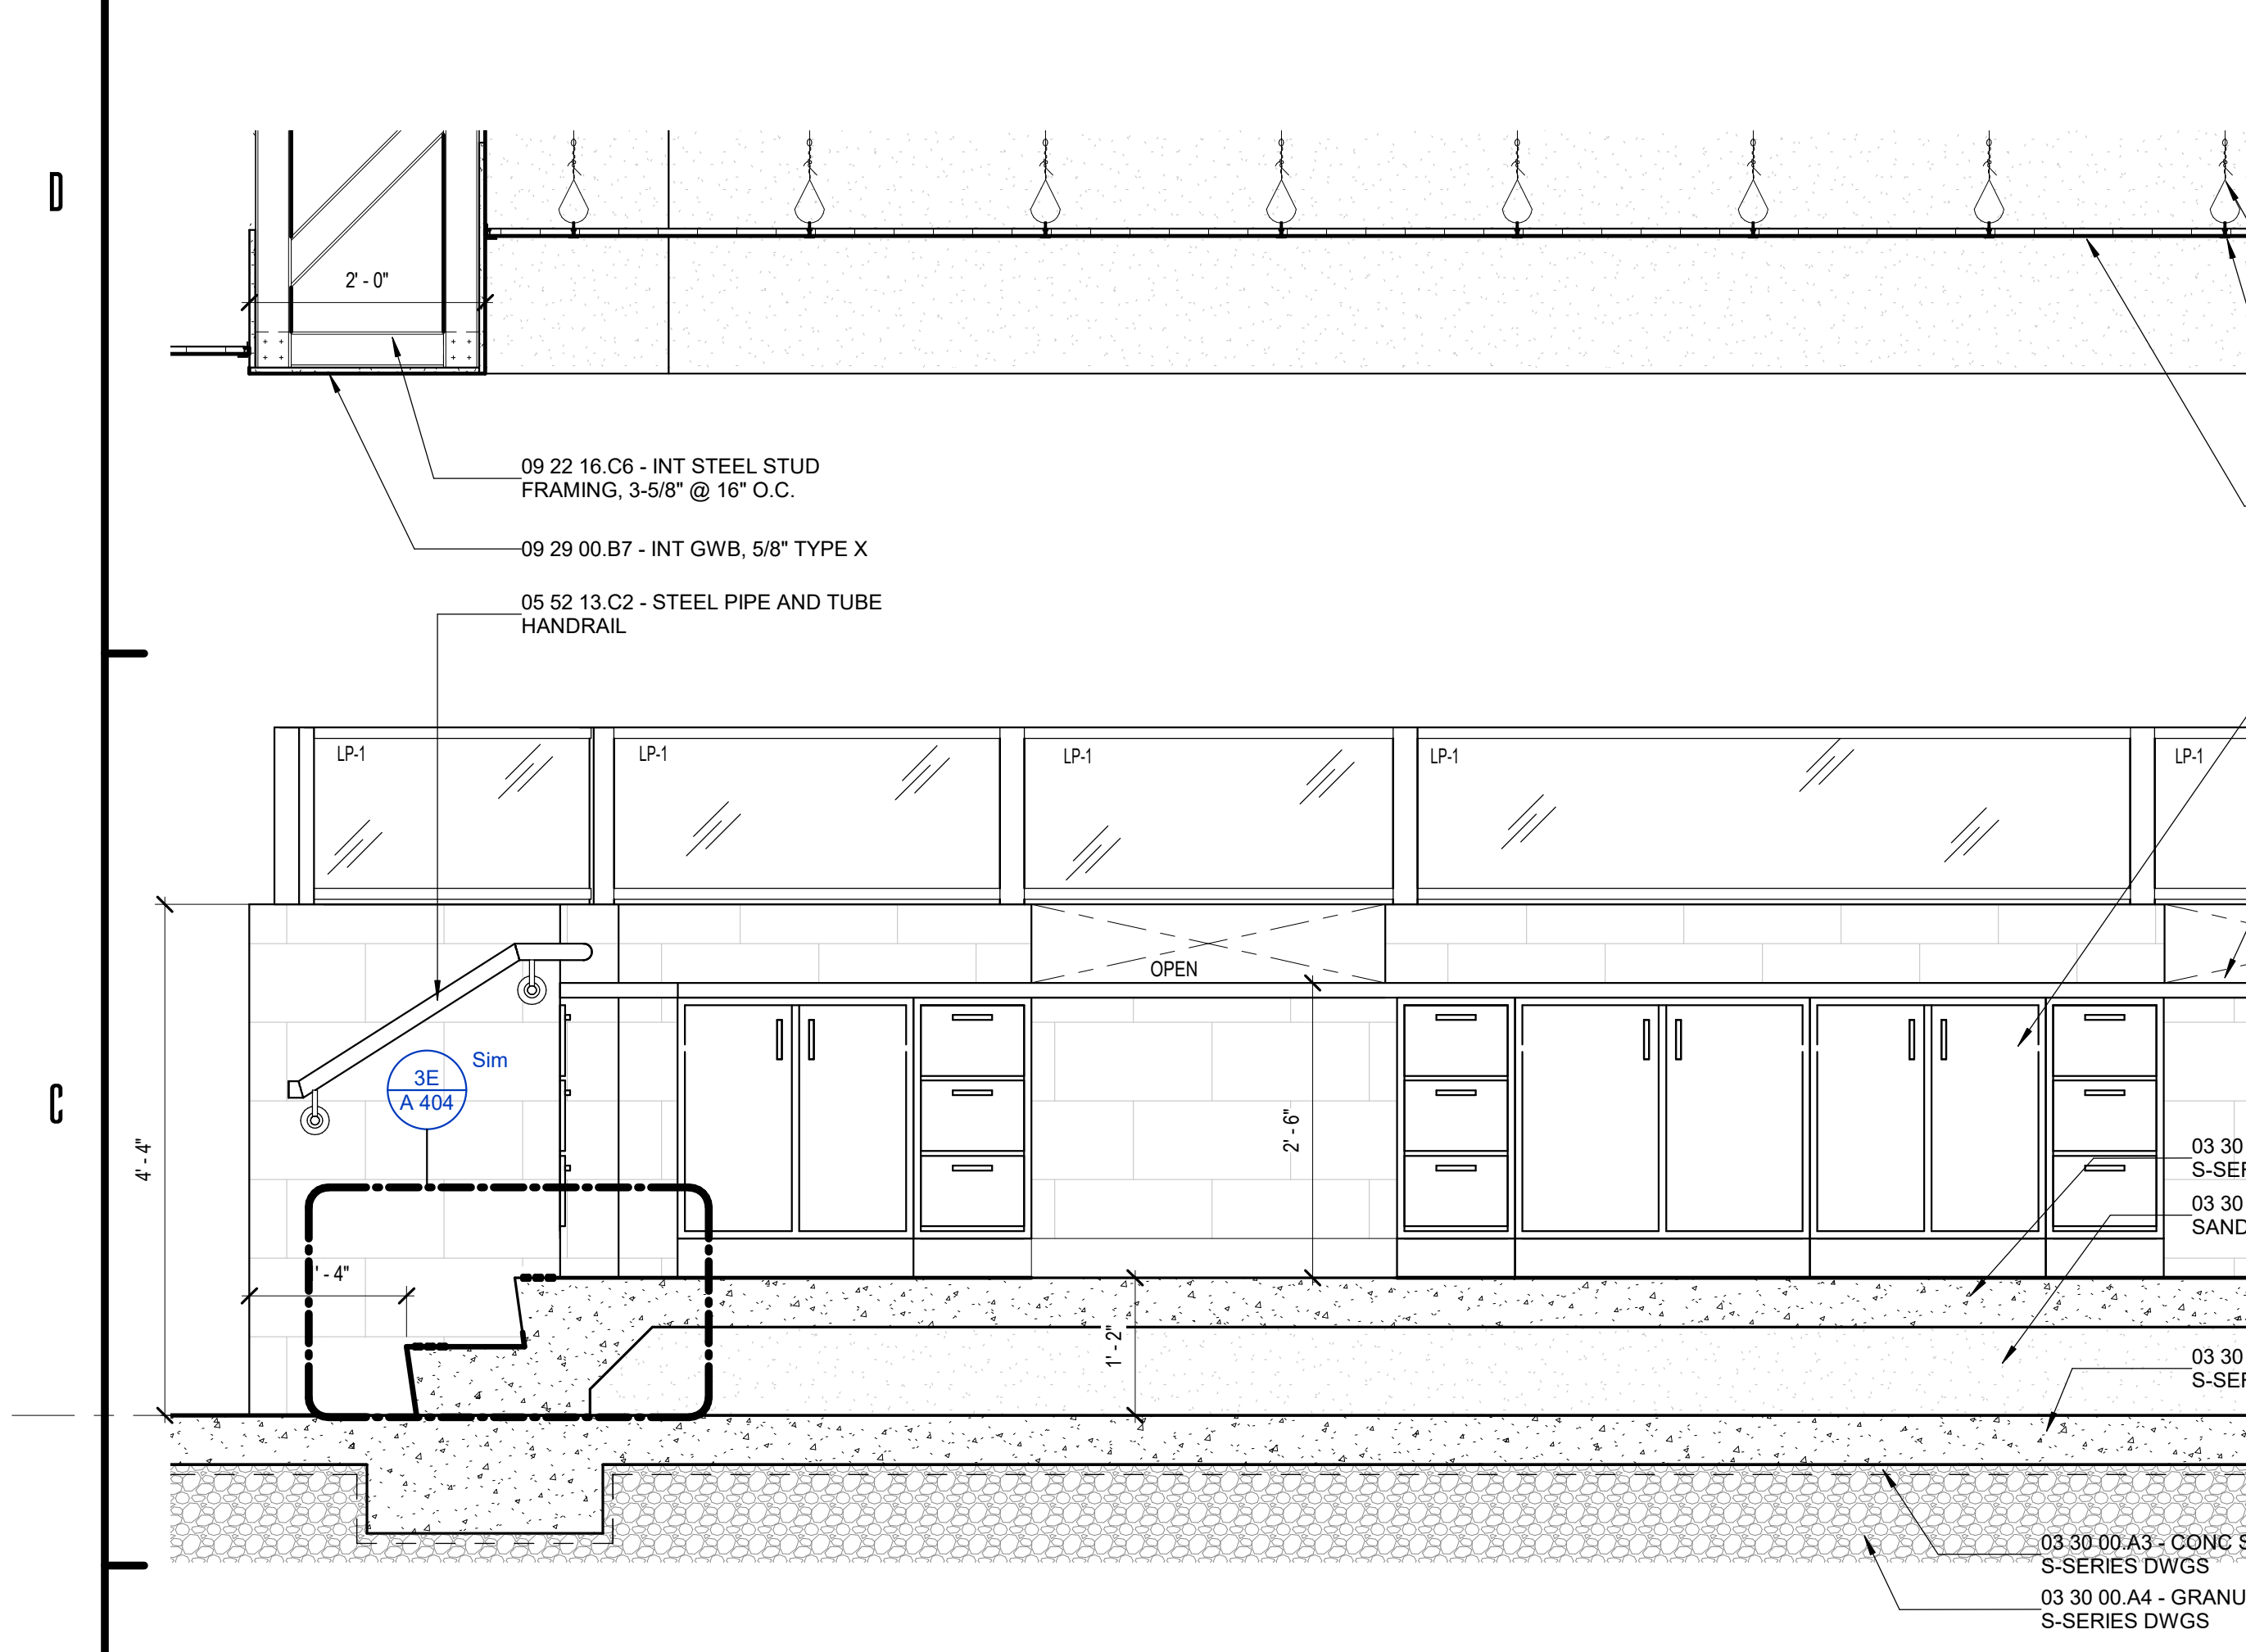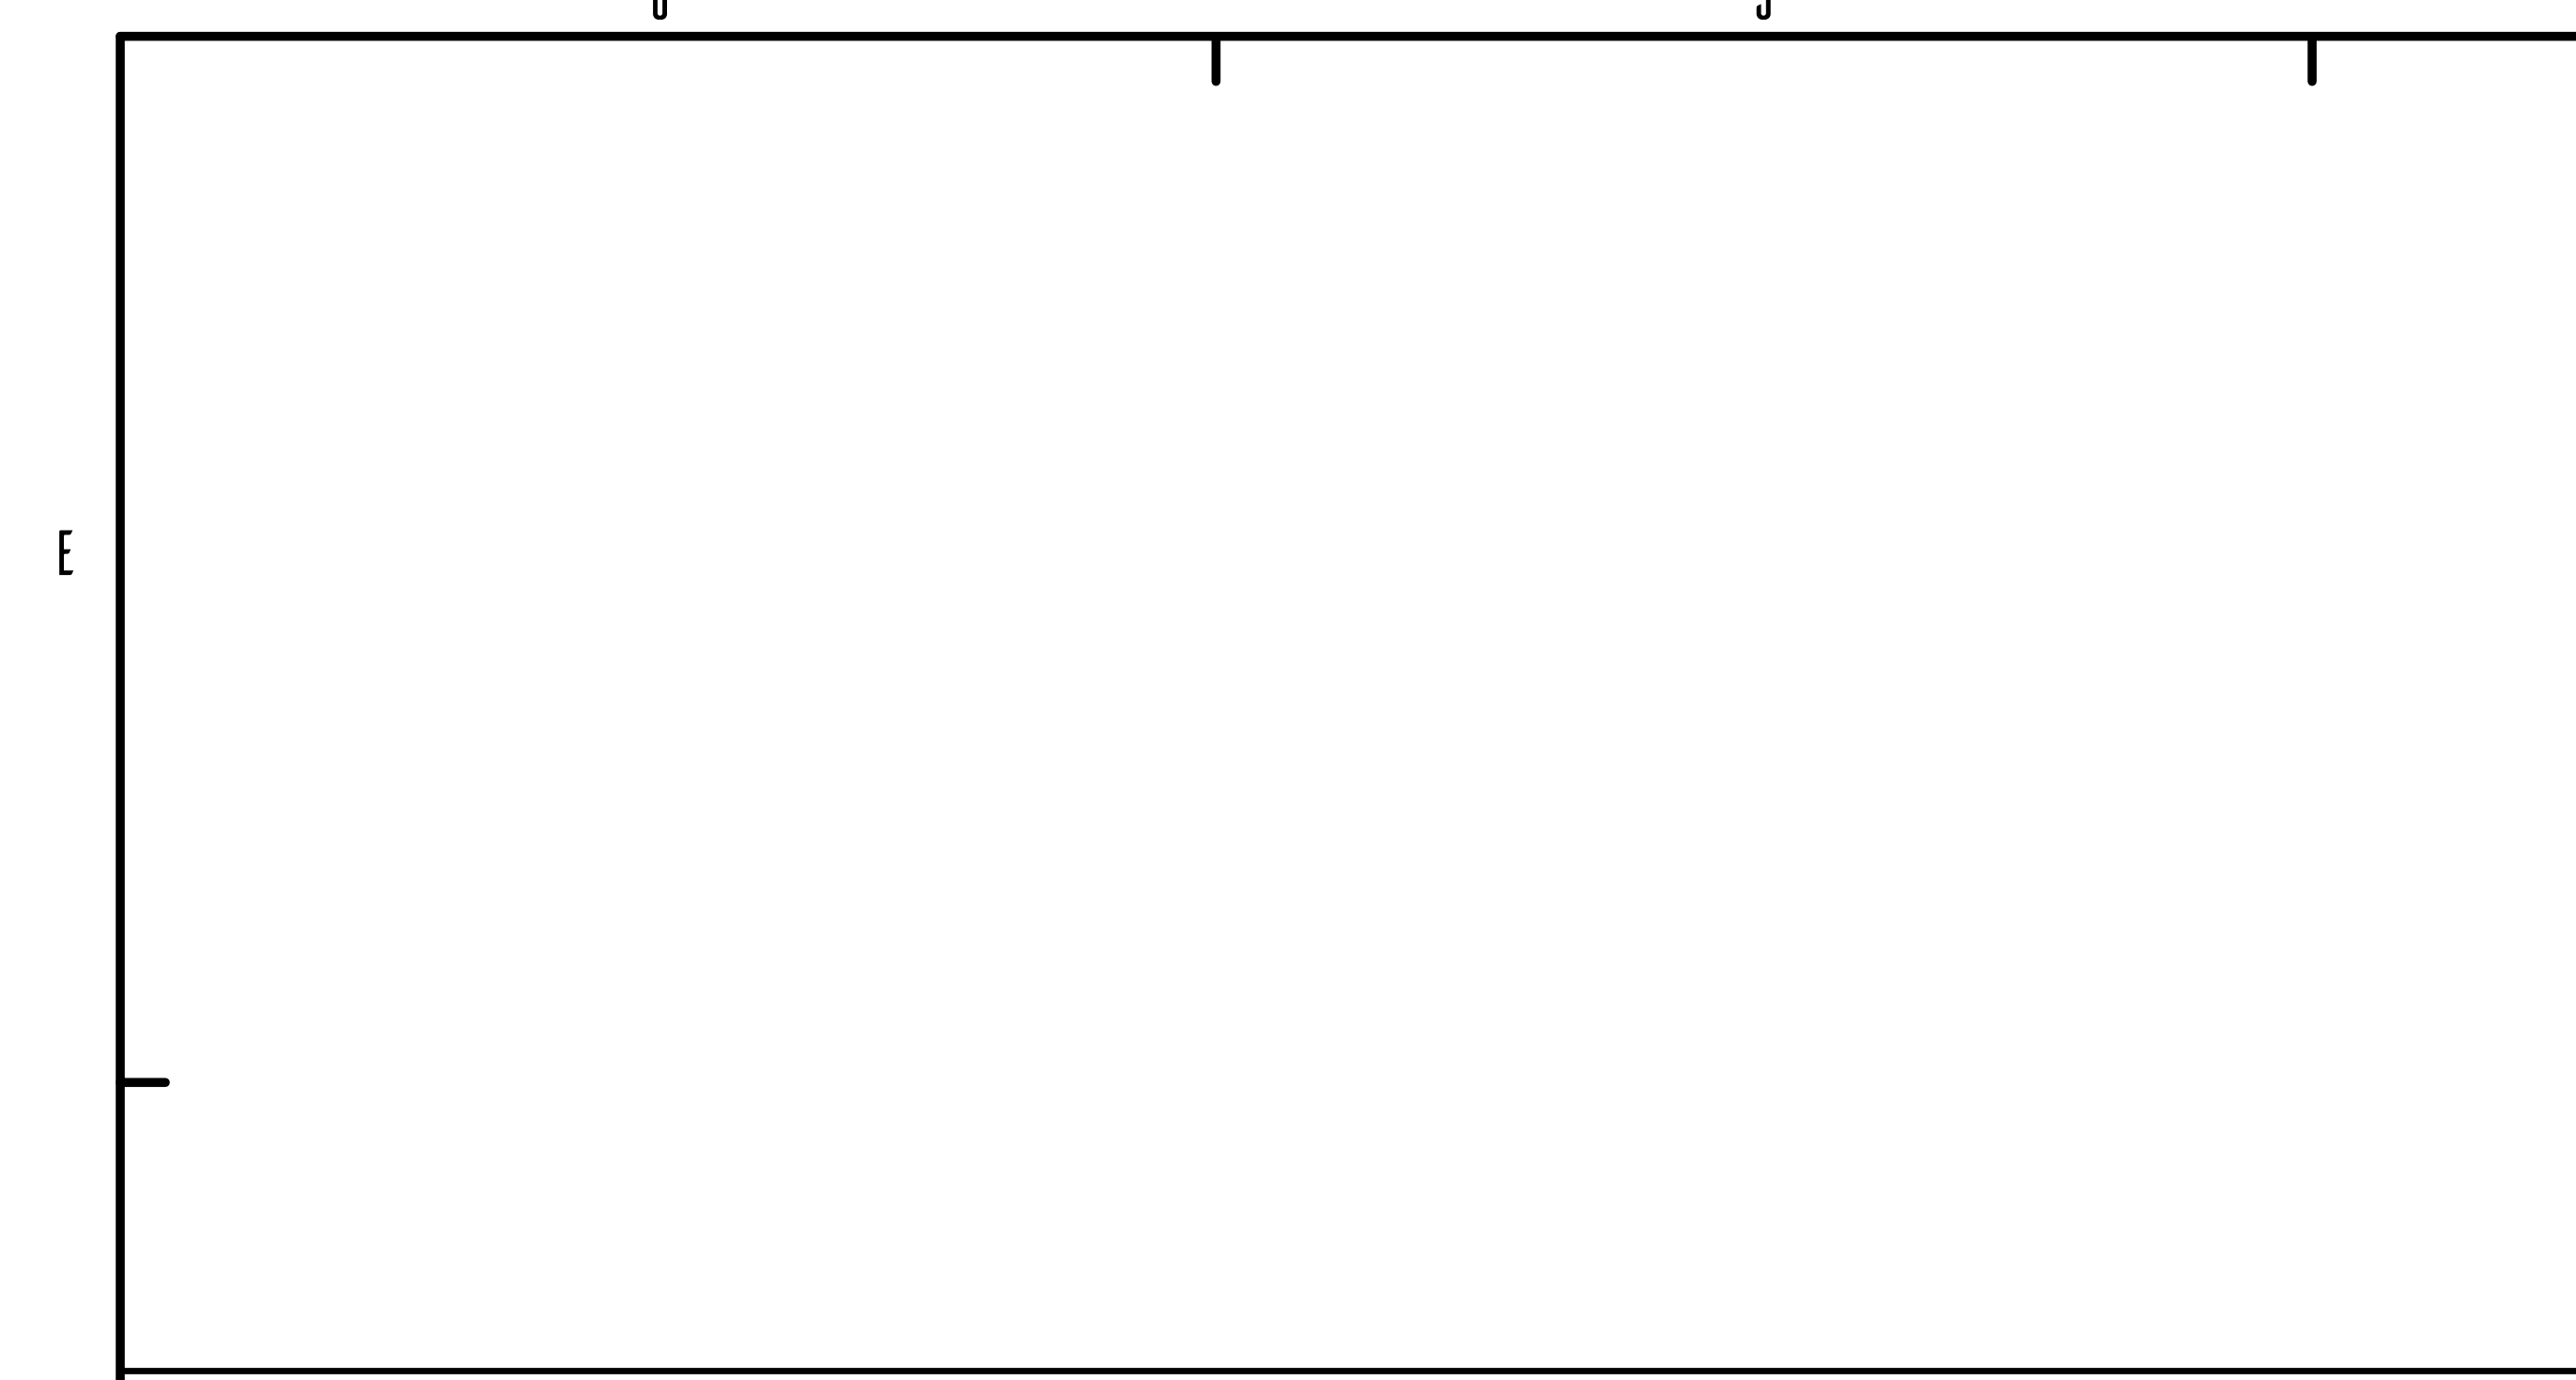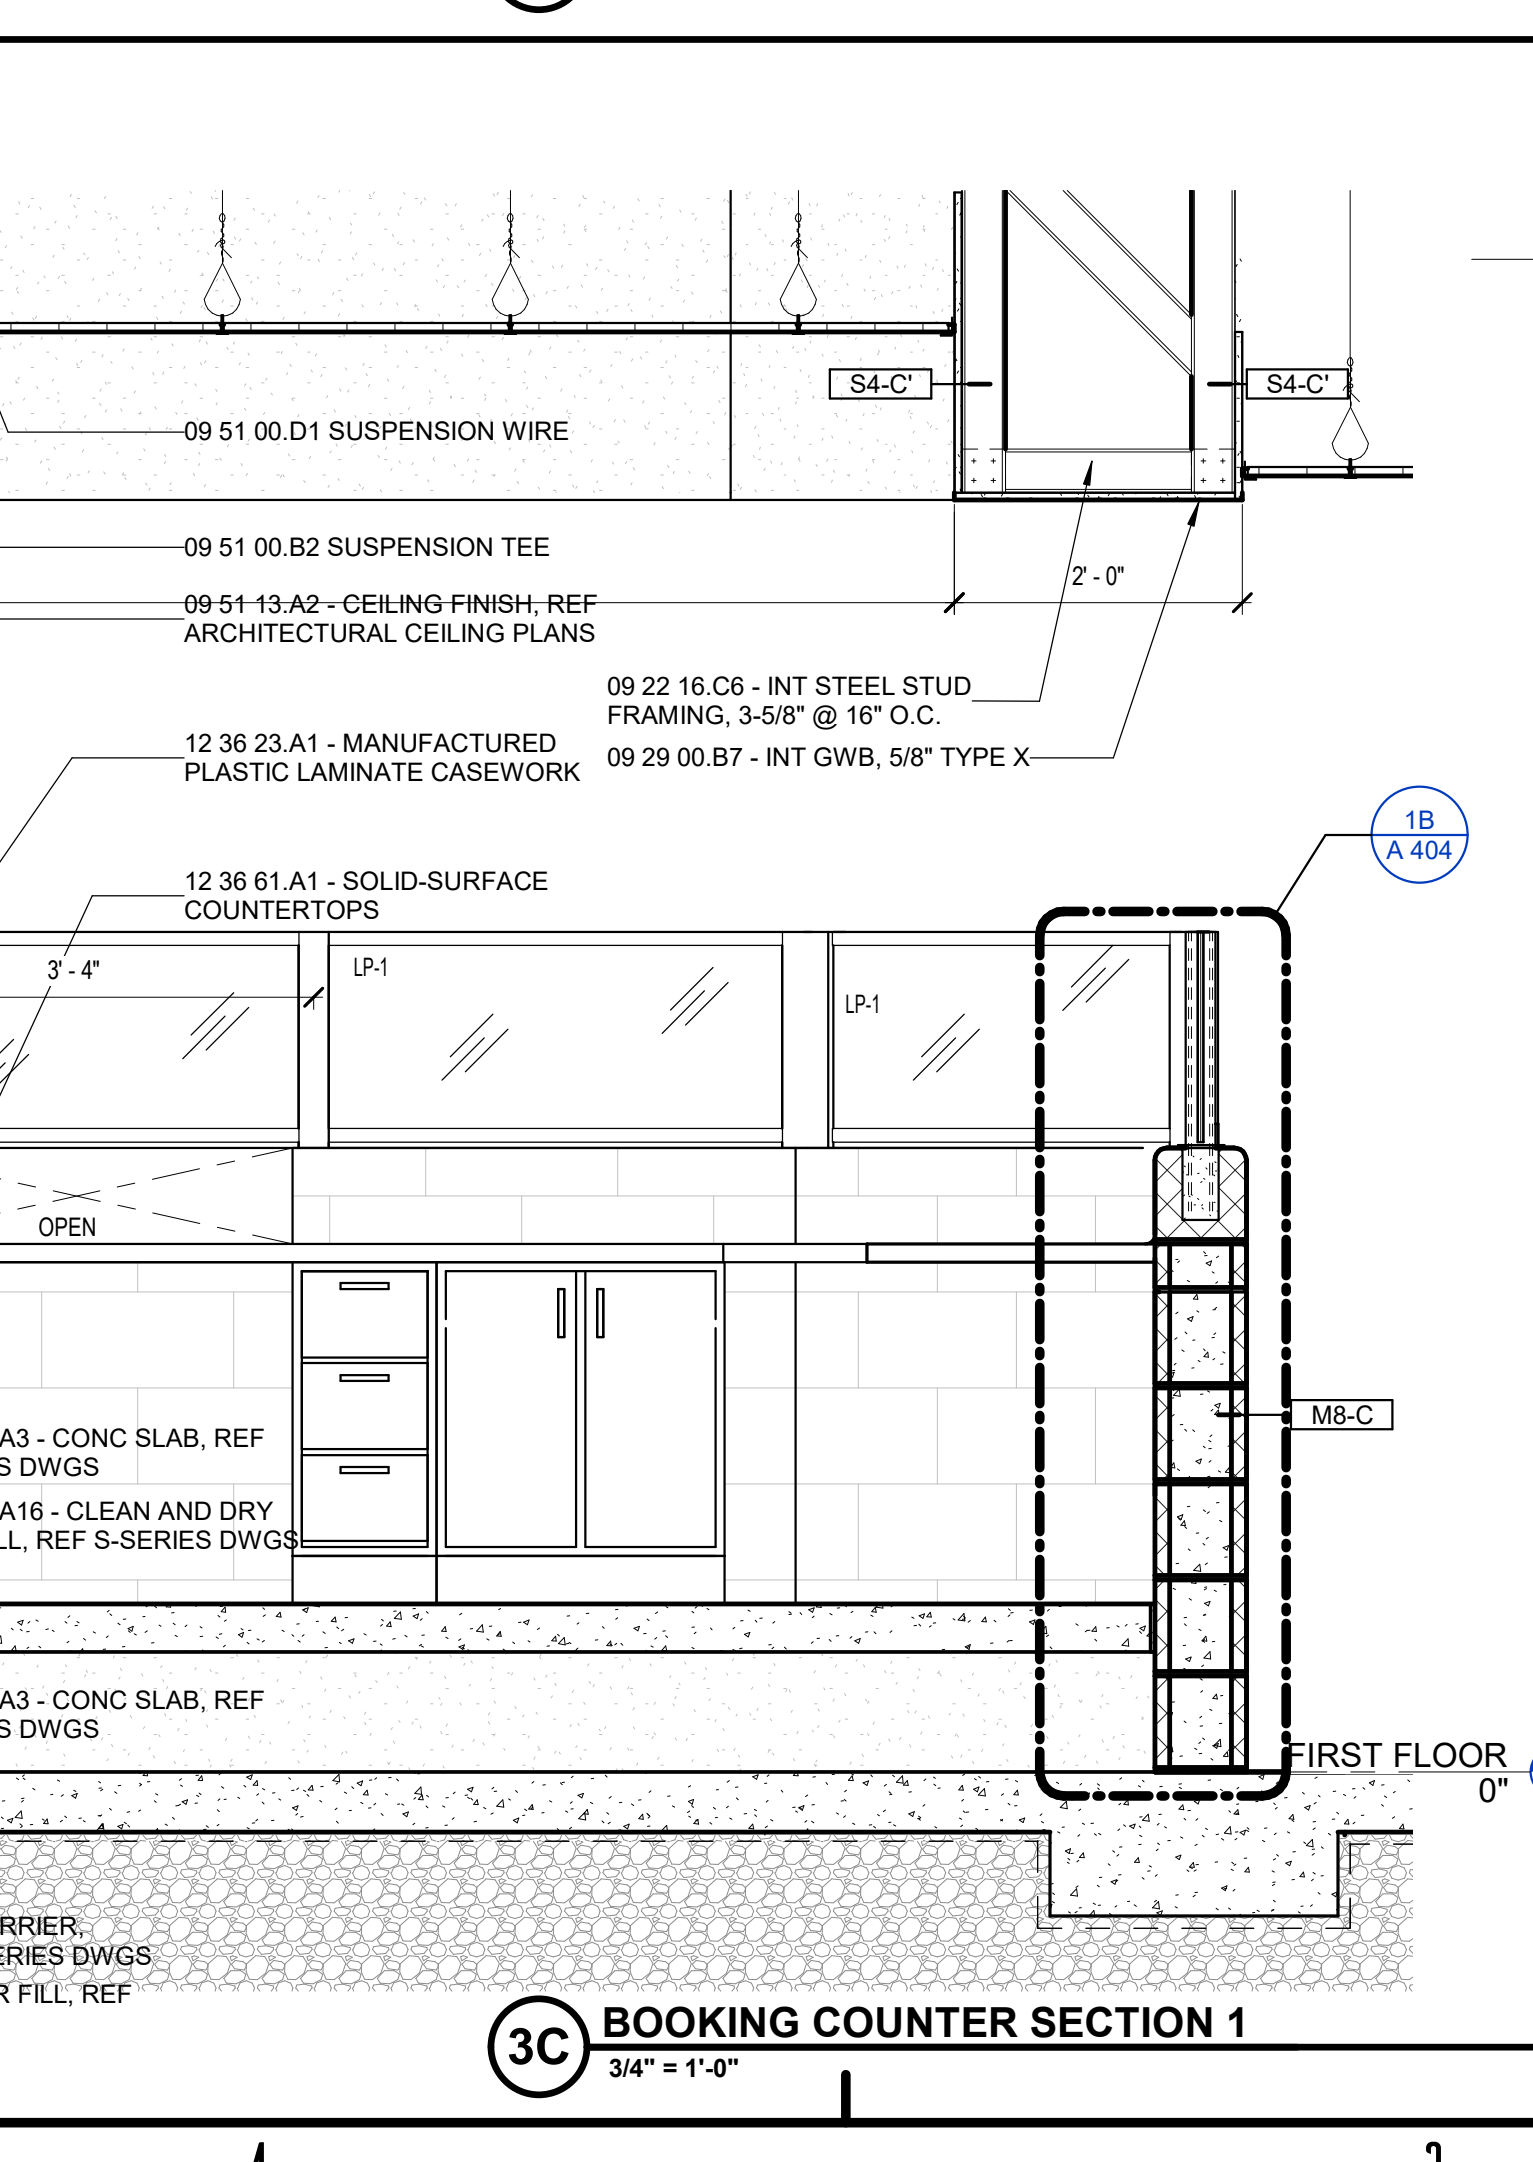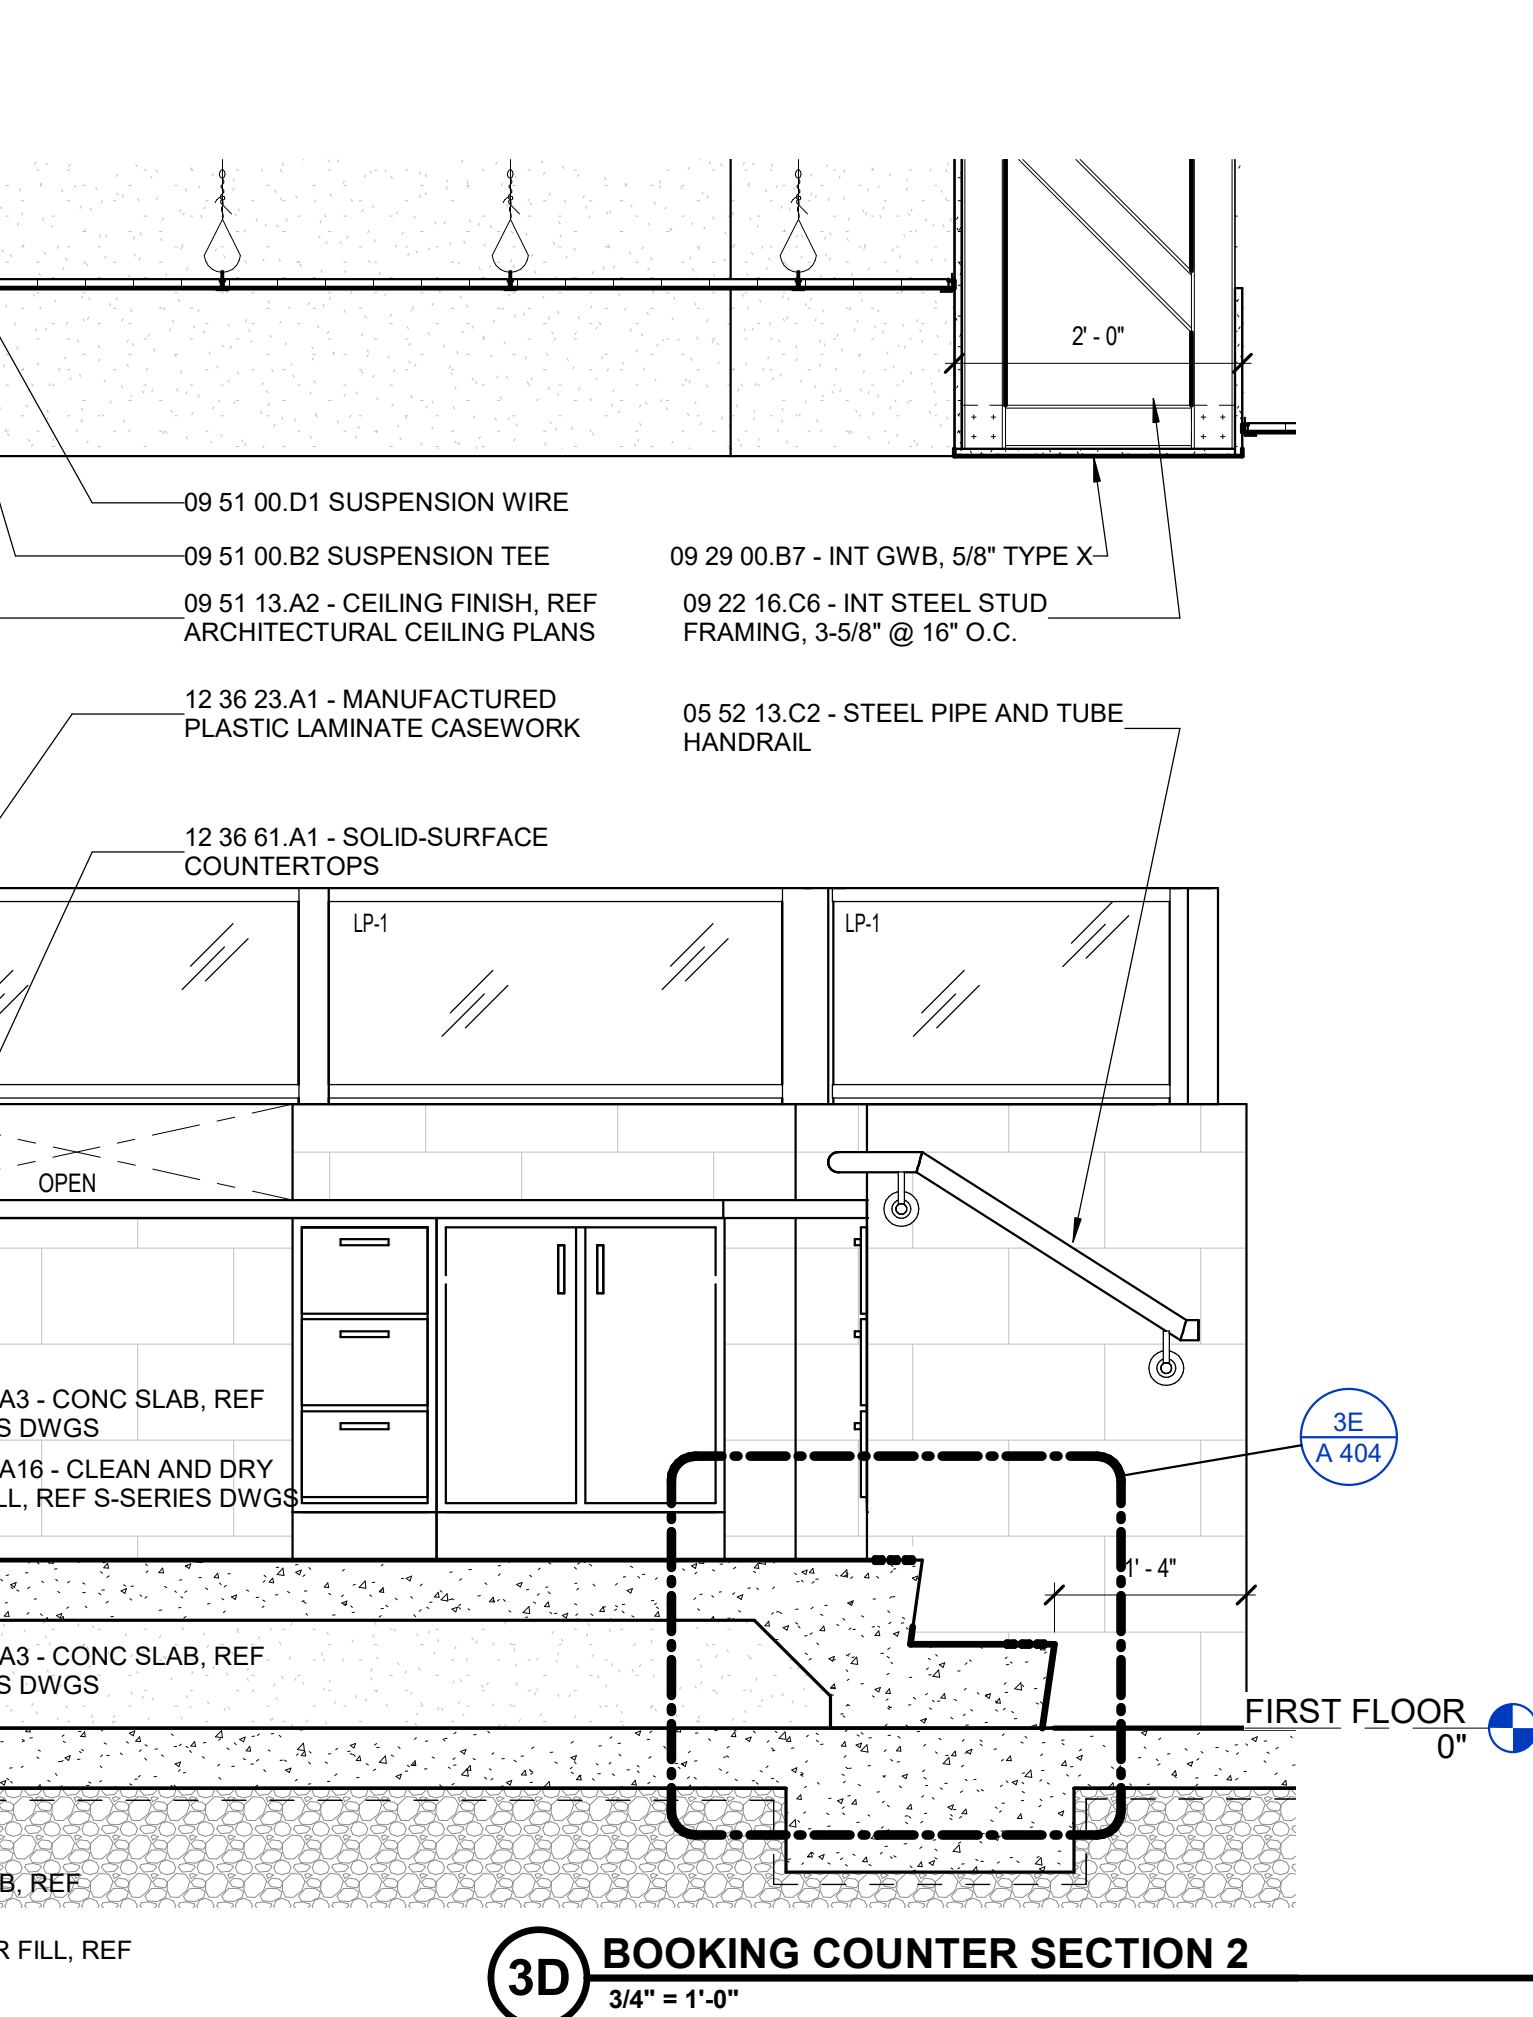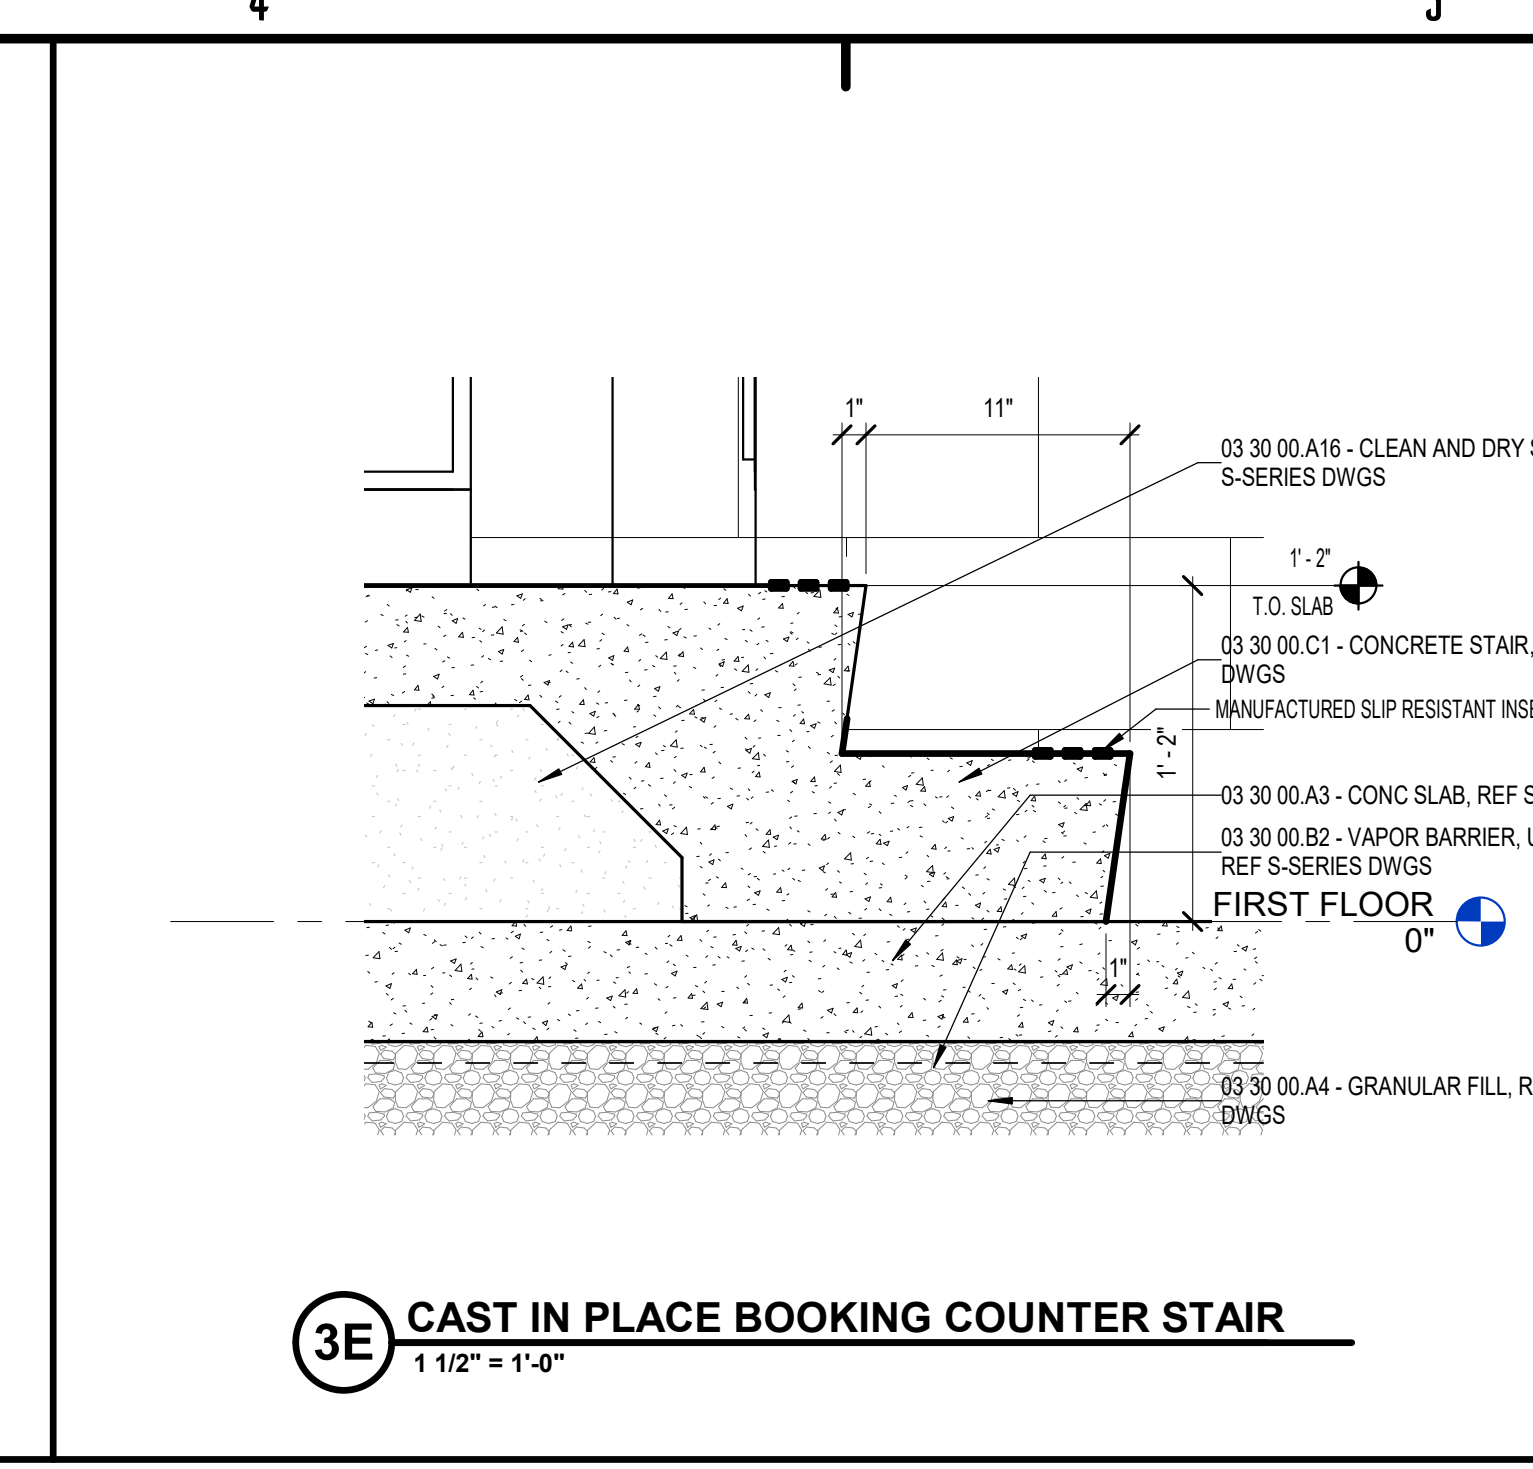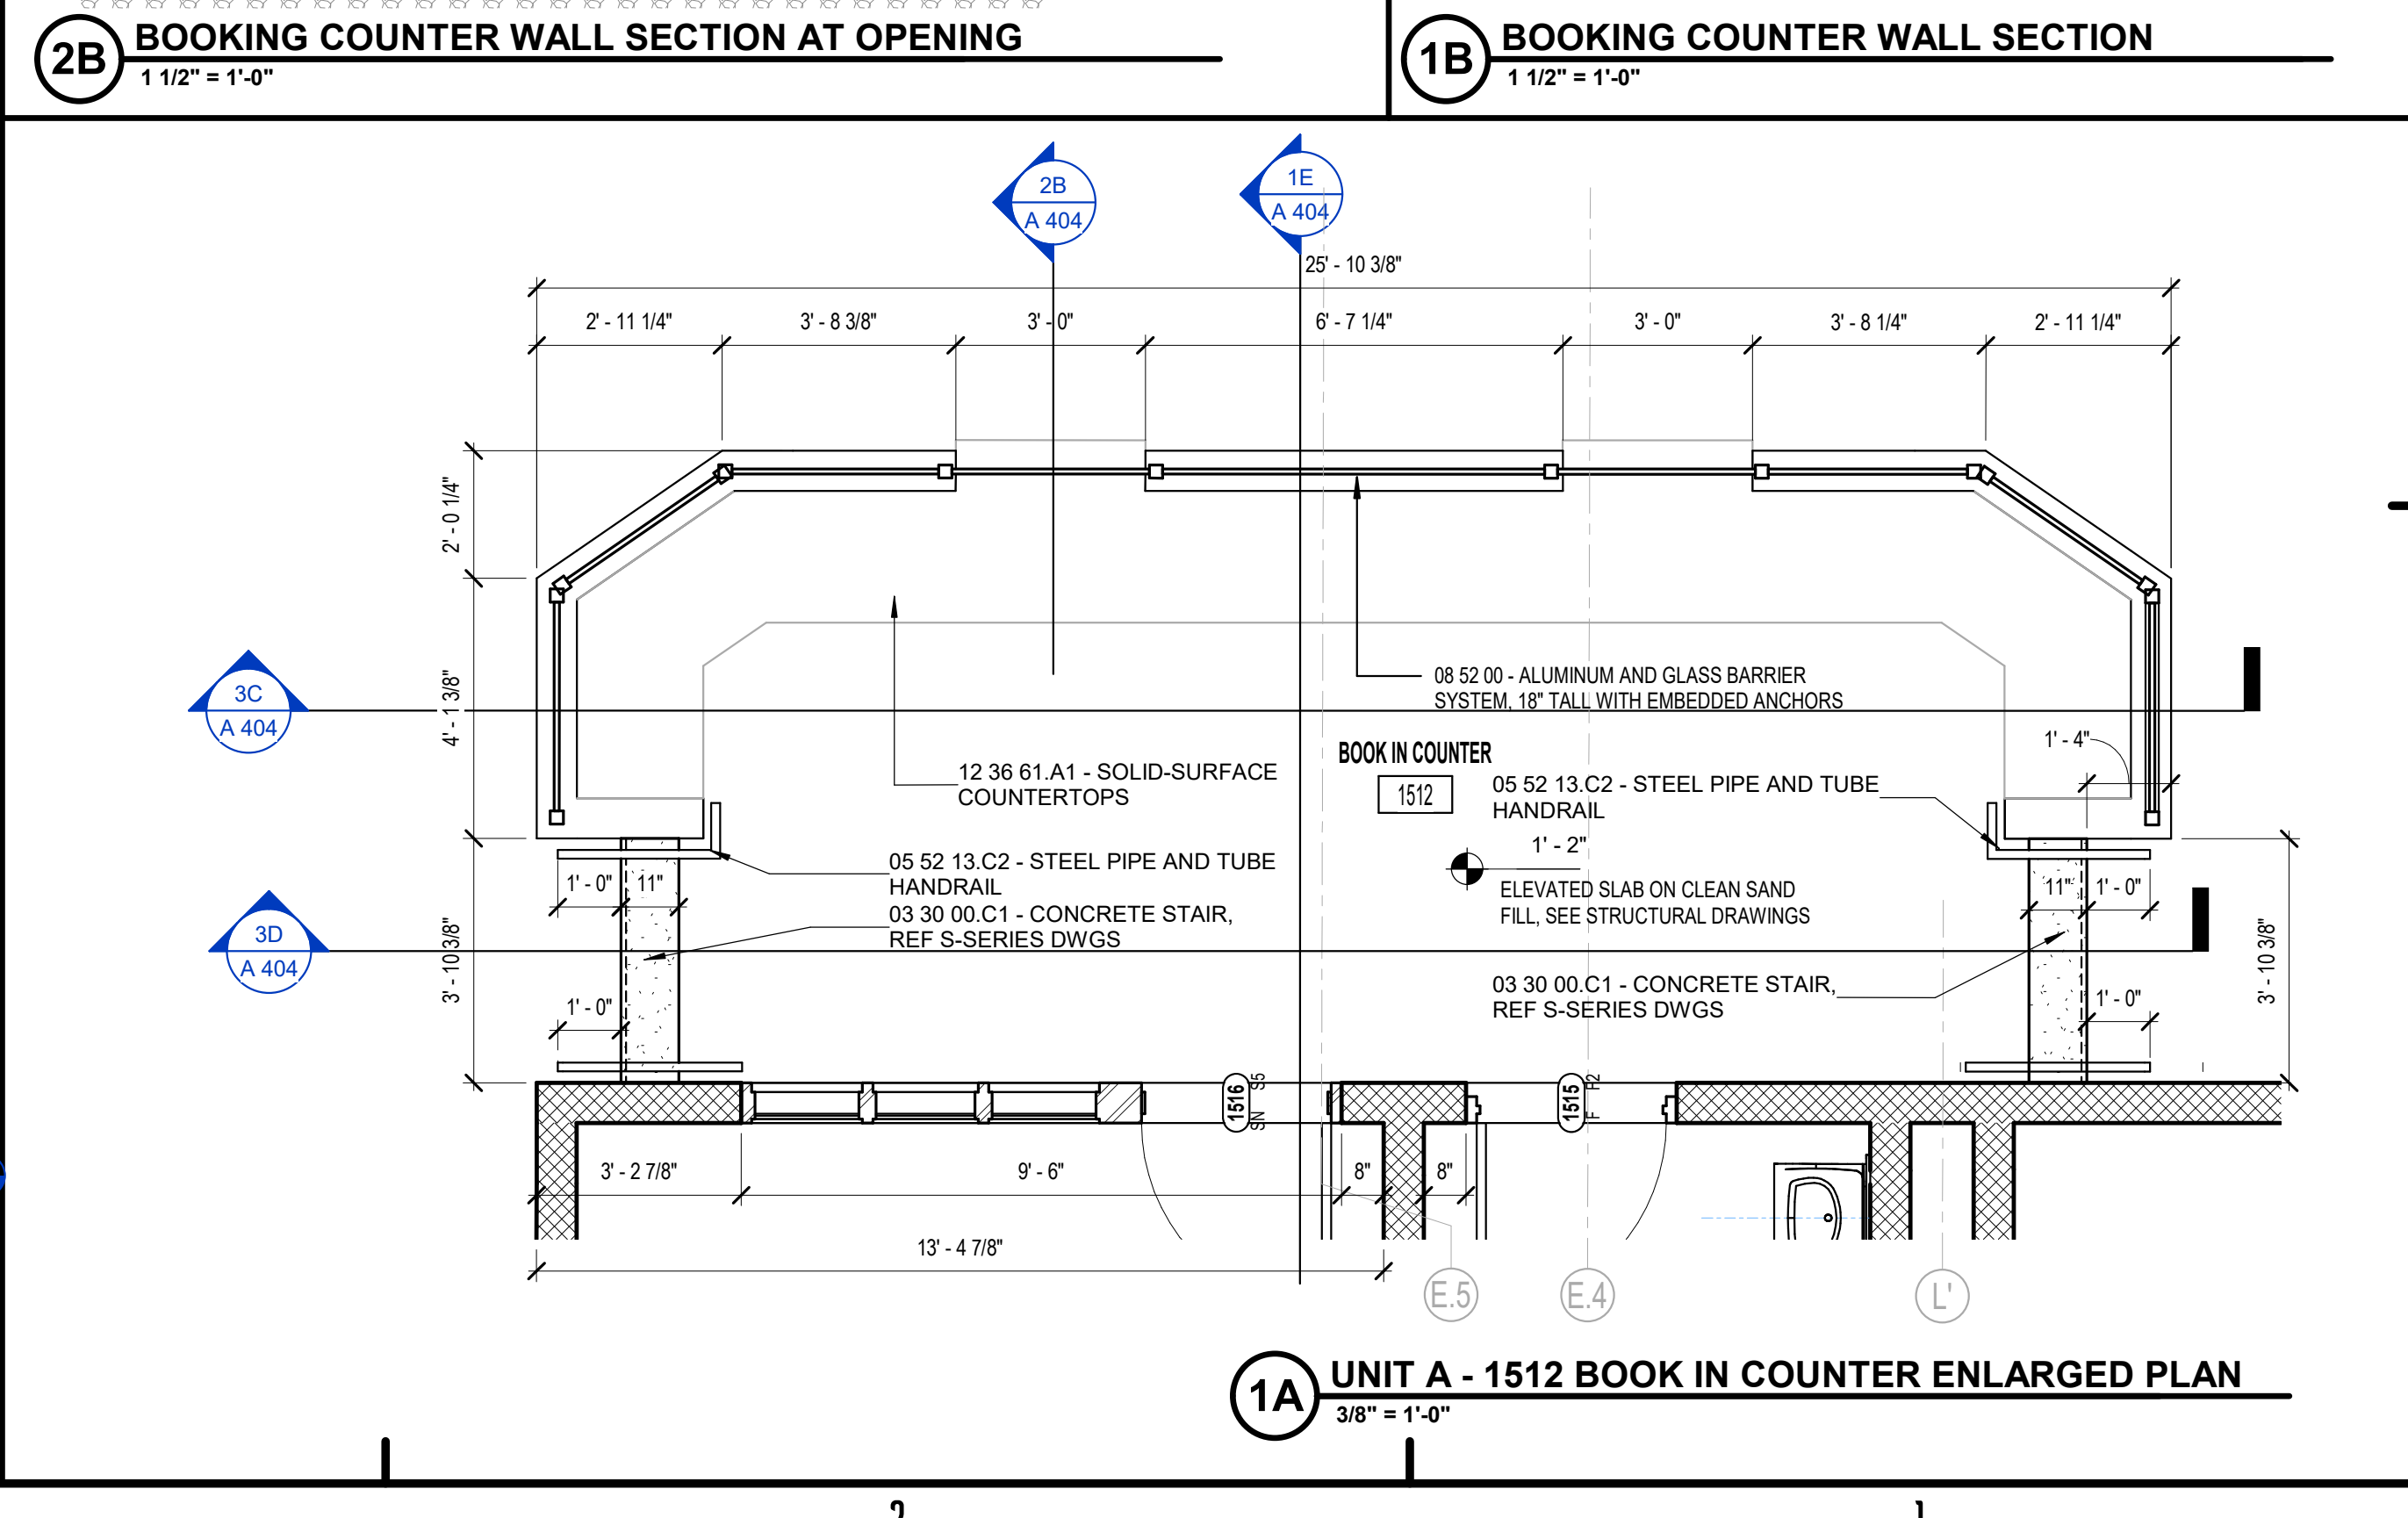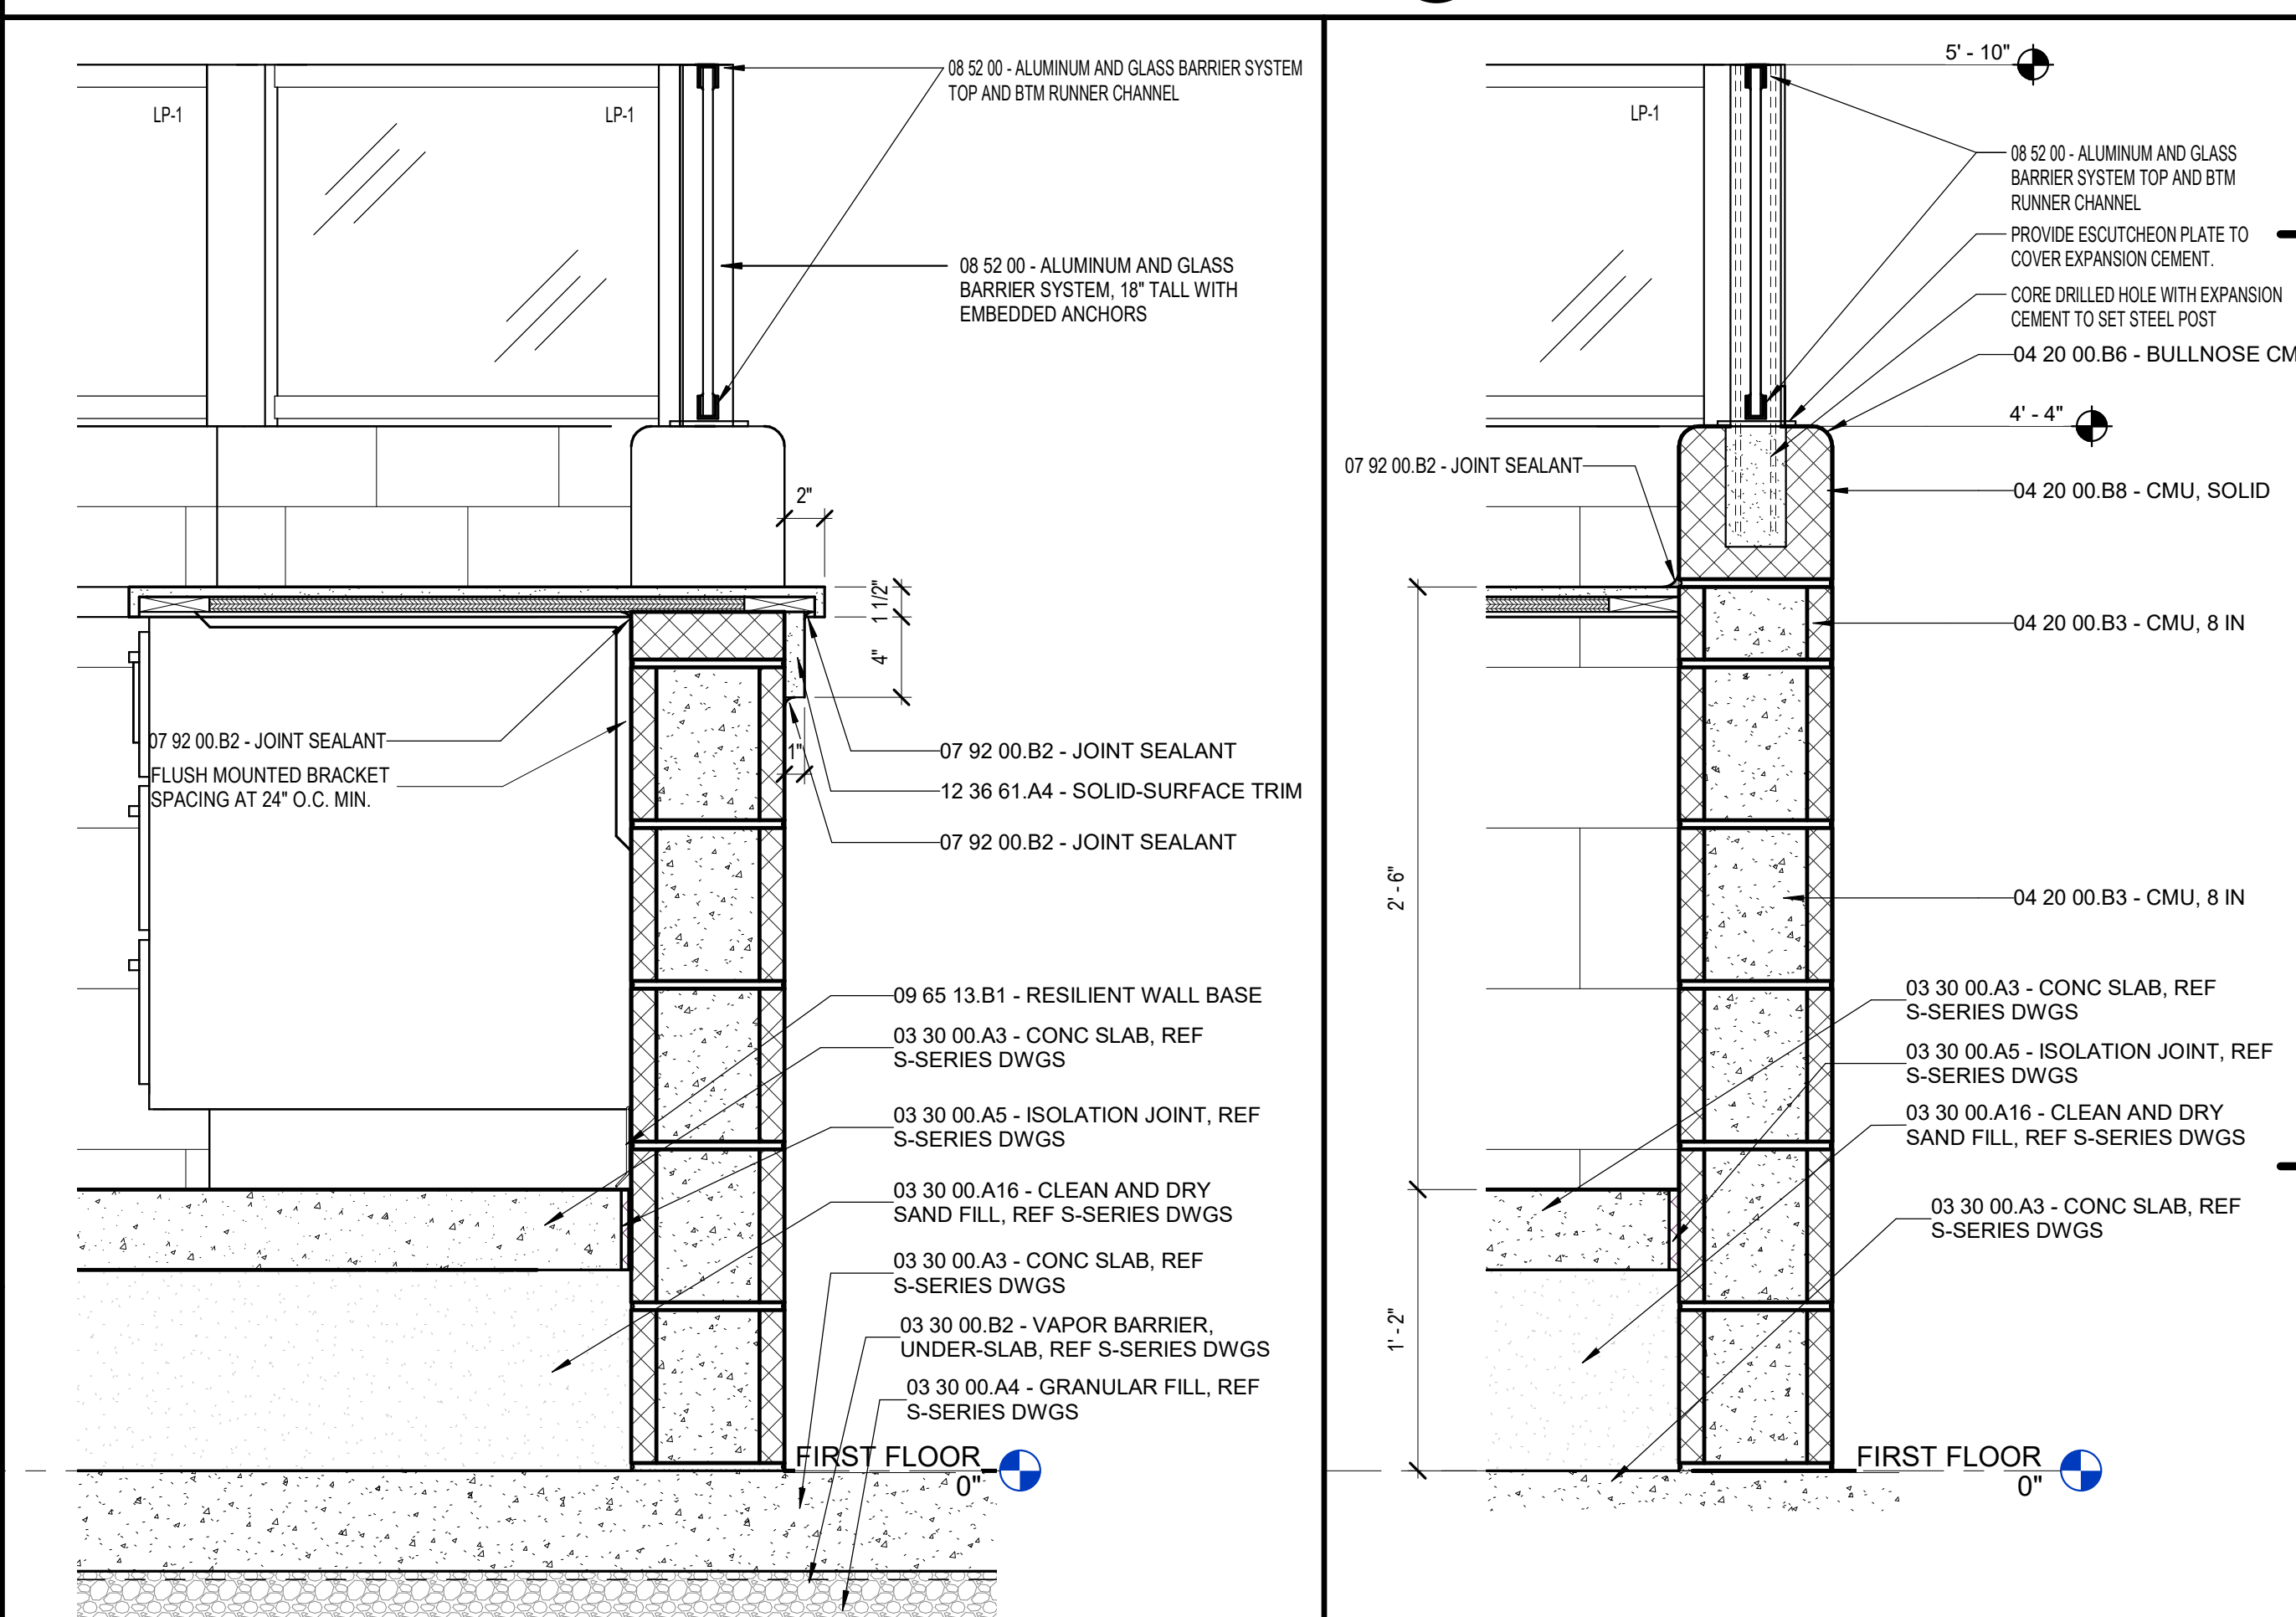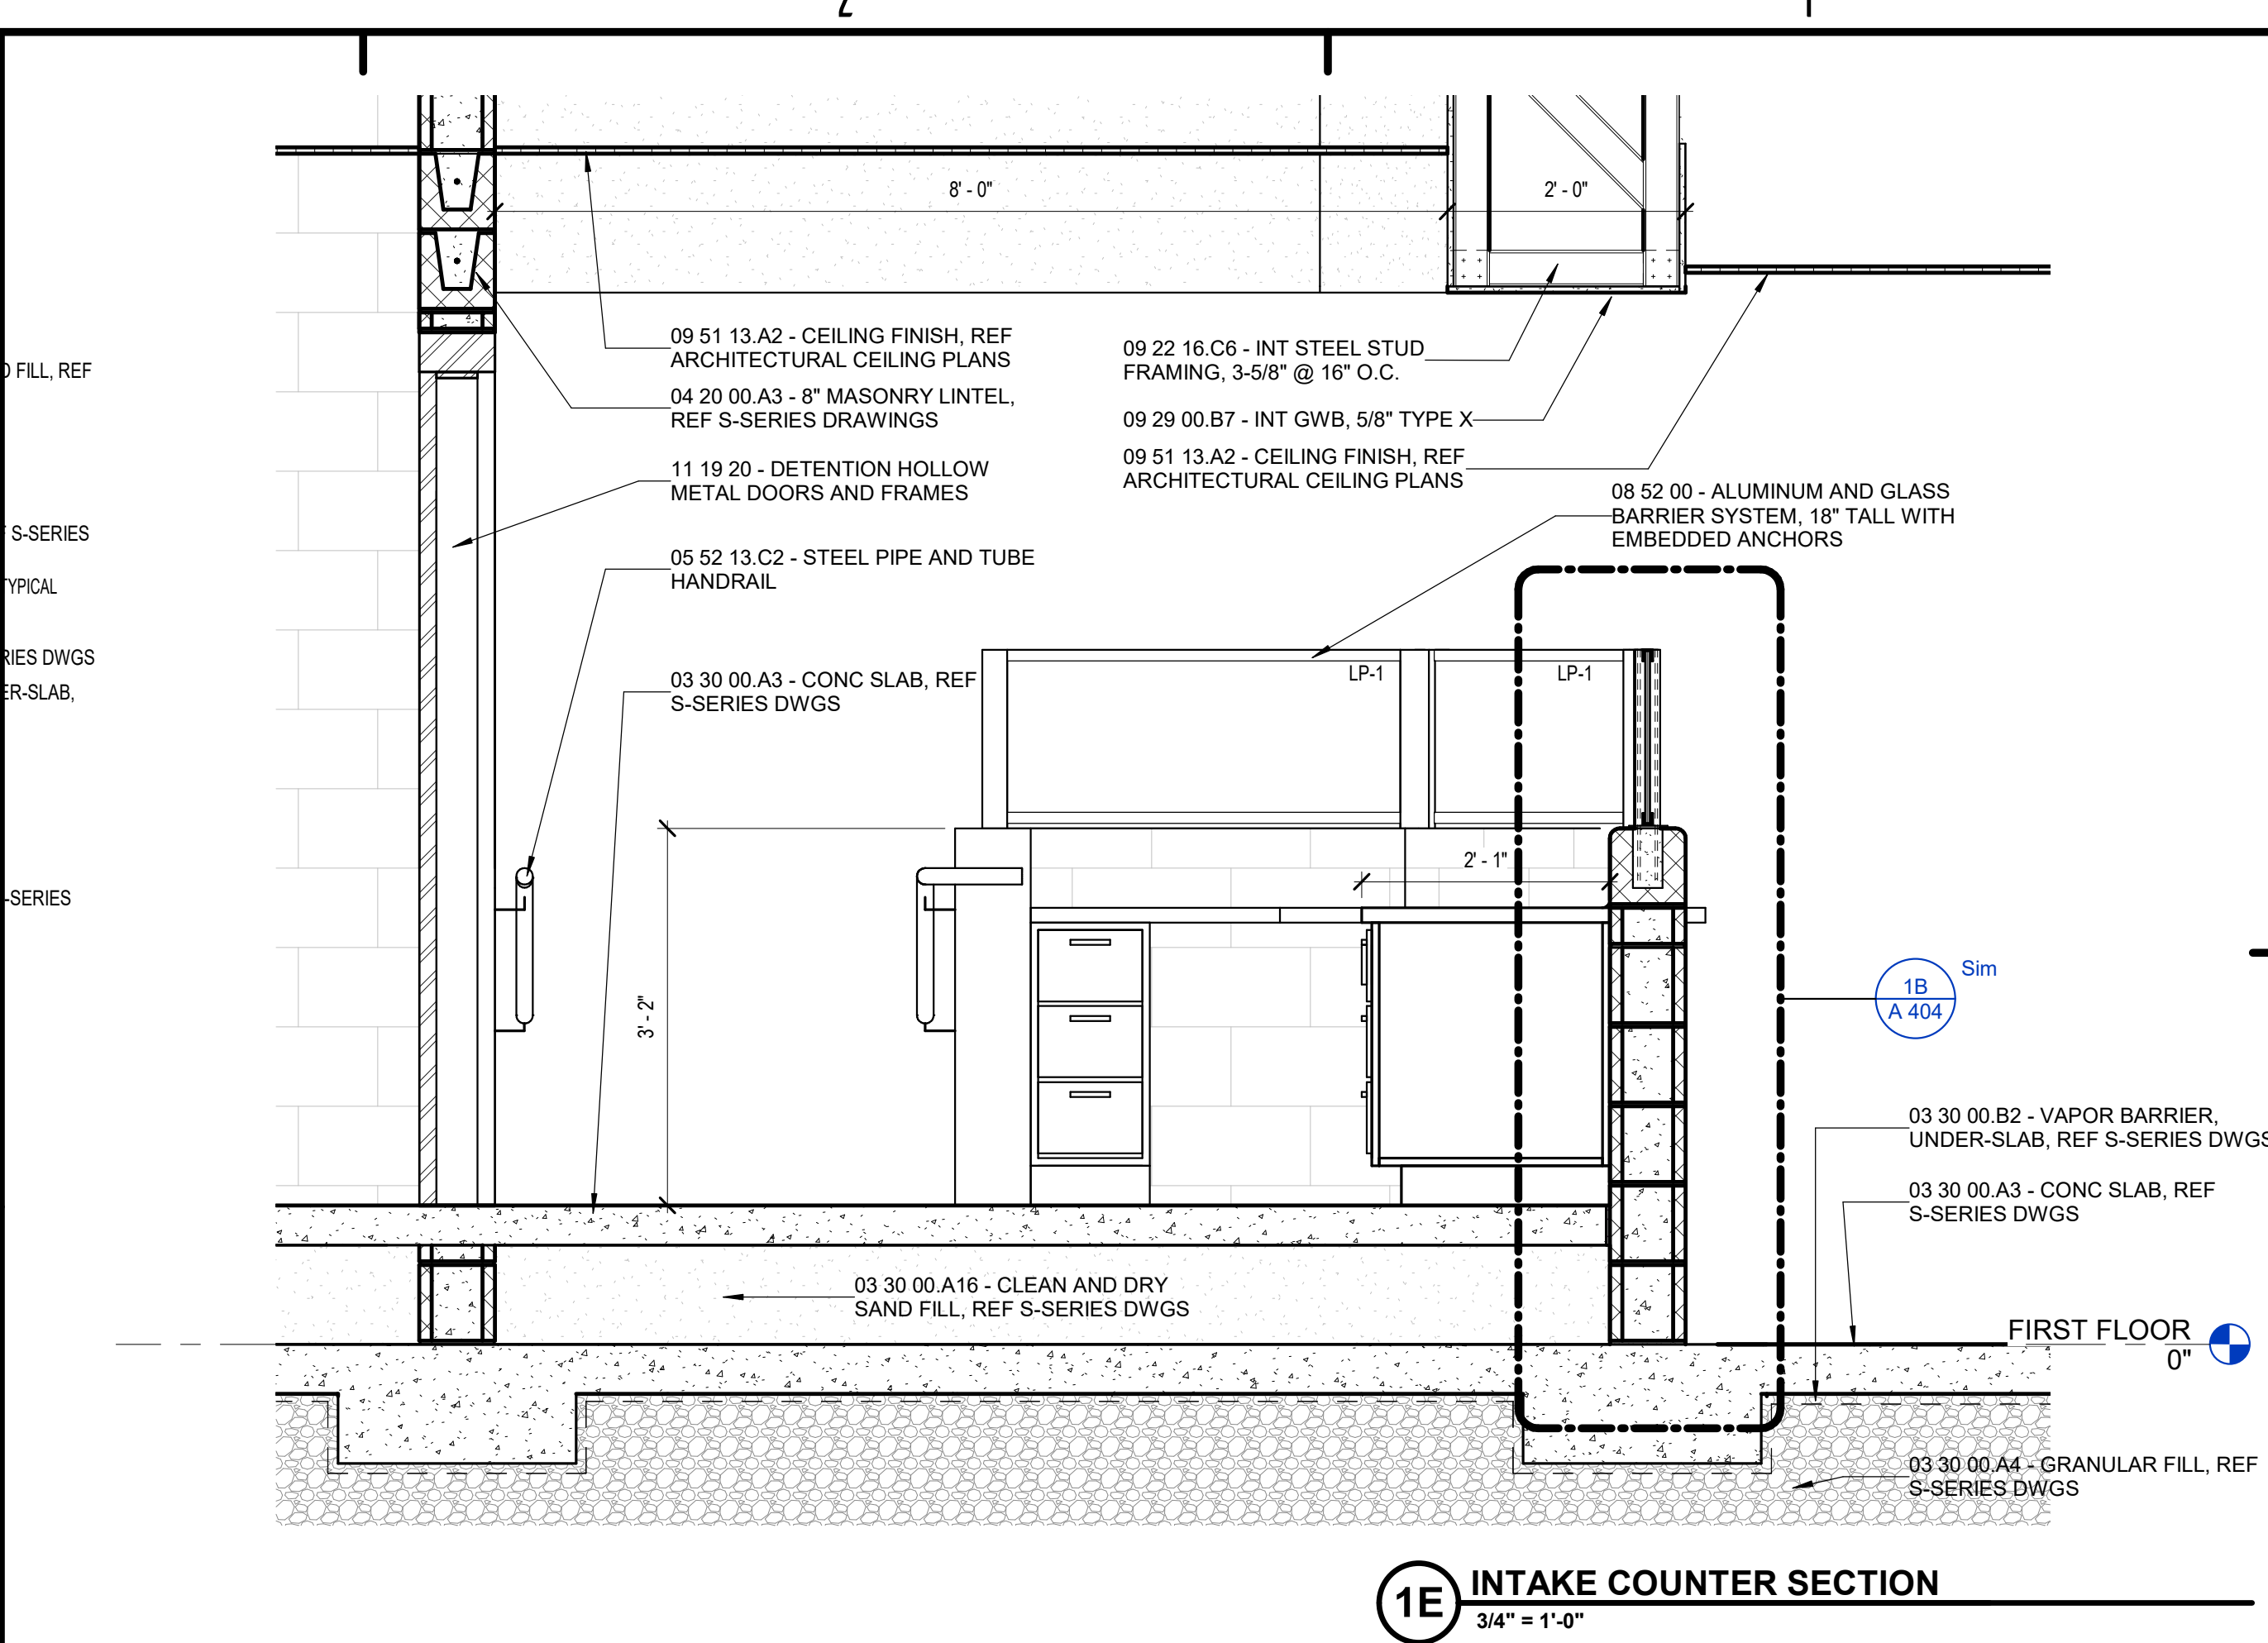




#	Revision	Date
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Project #: 20-700-151-2  
Designed By: Designer  
Drawn By: Author  
Checked By: Checker  
Date: 01.28.2022

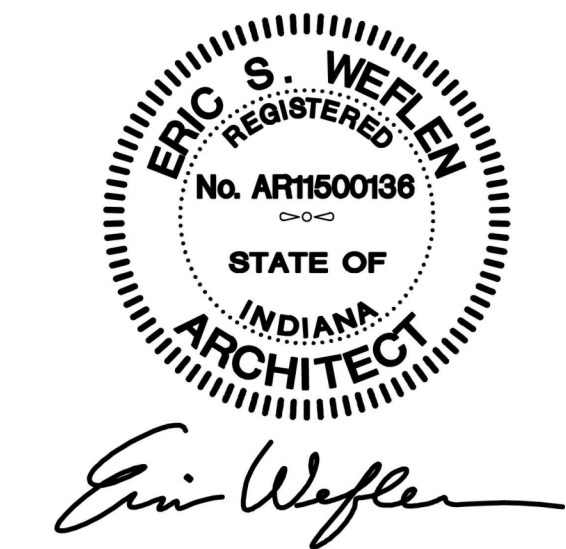


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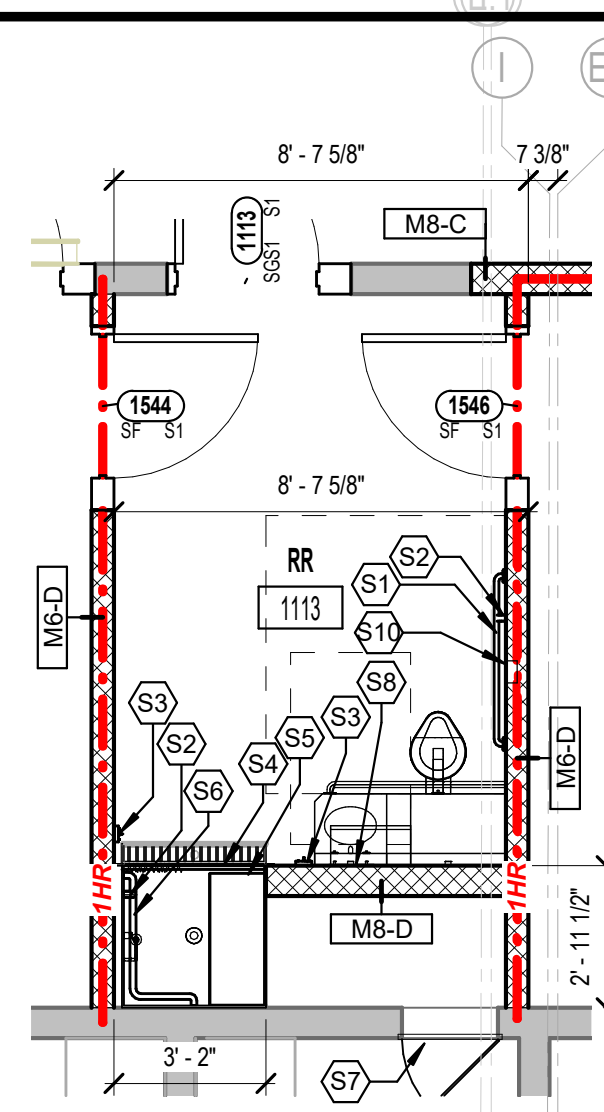


ENLARGED  
PRE-PROCESS COUNTER  
PLANS AND DETAILS

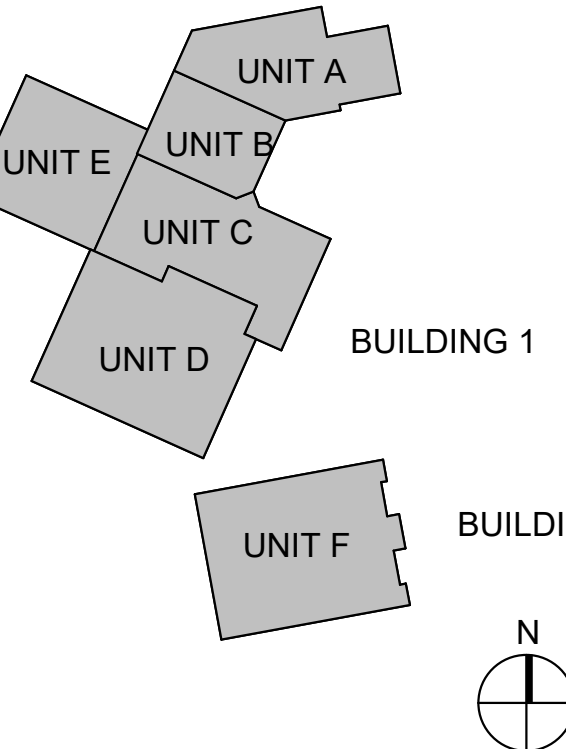

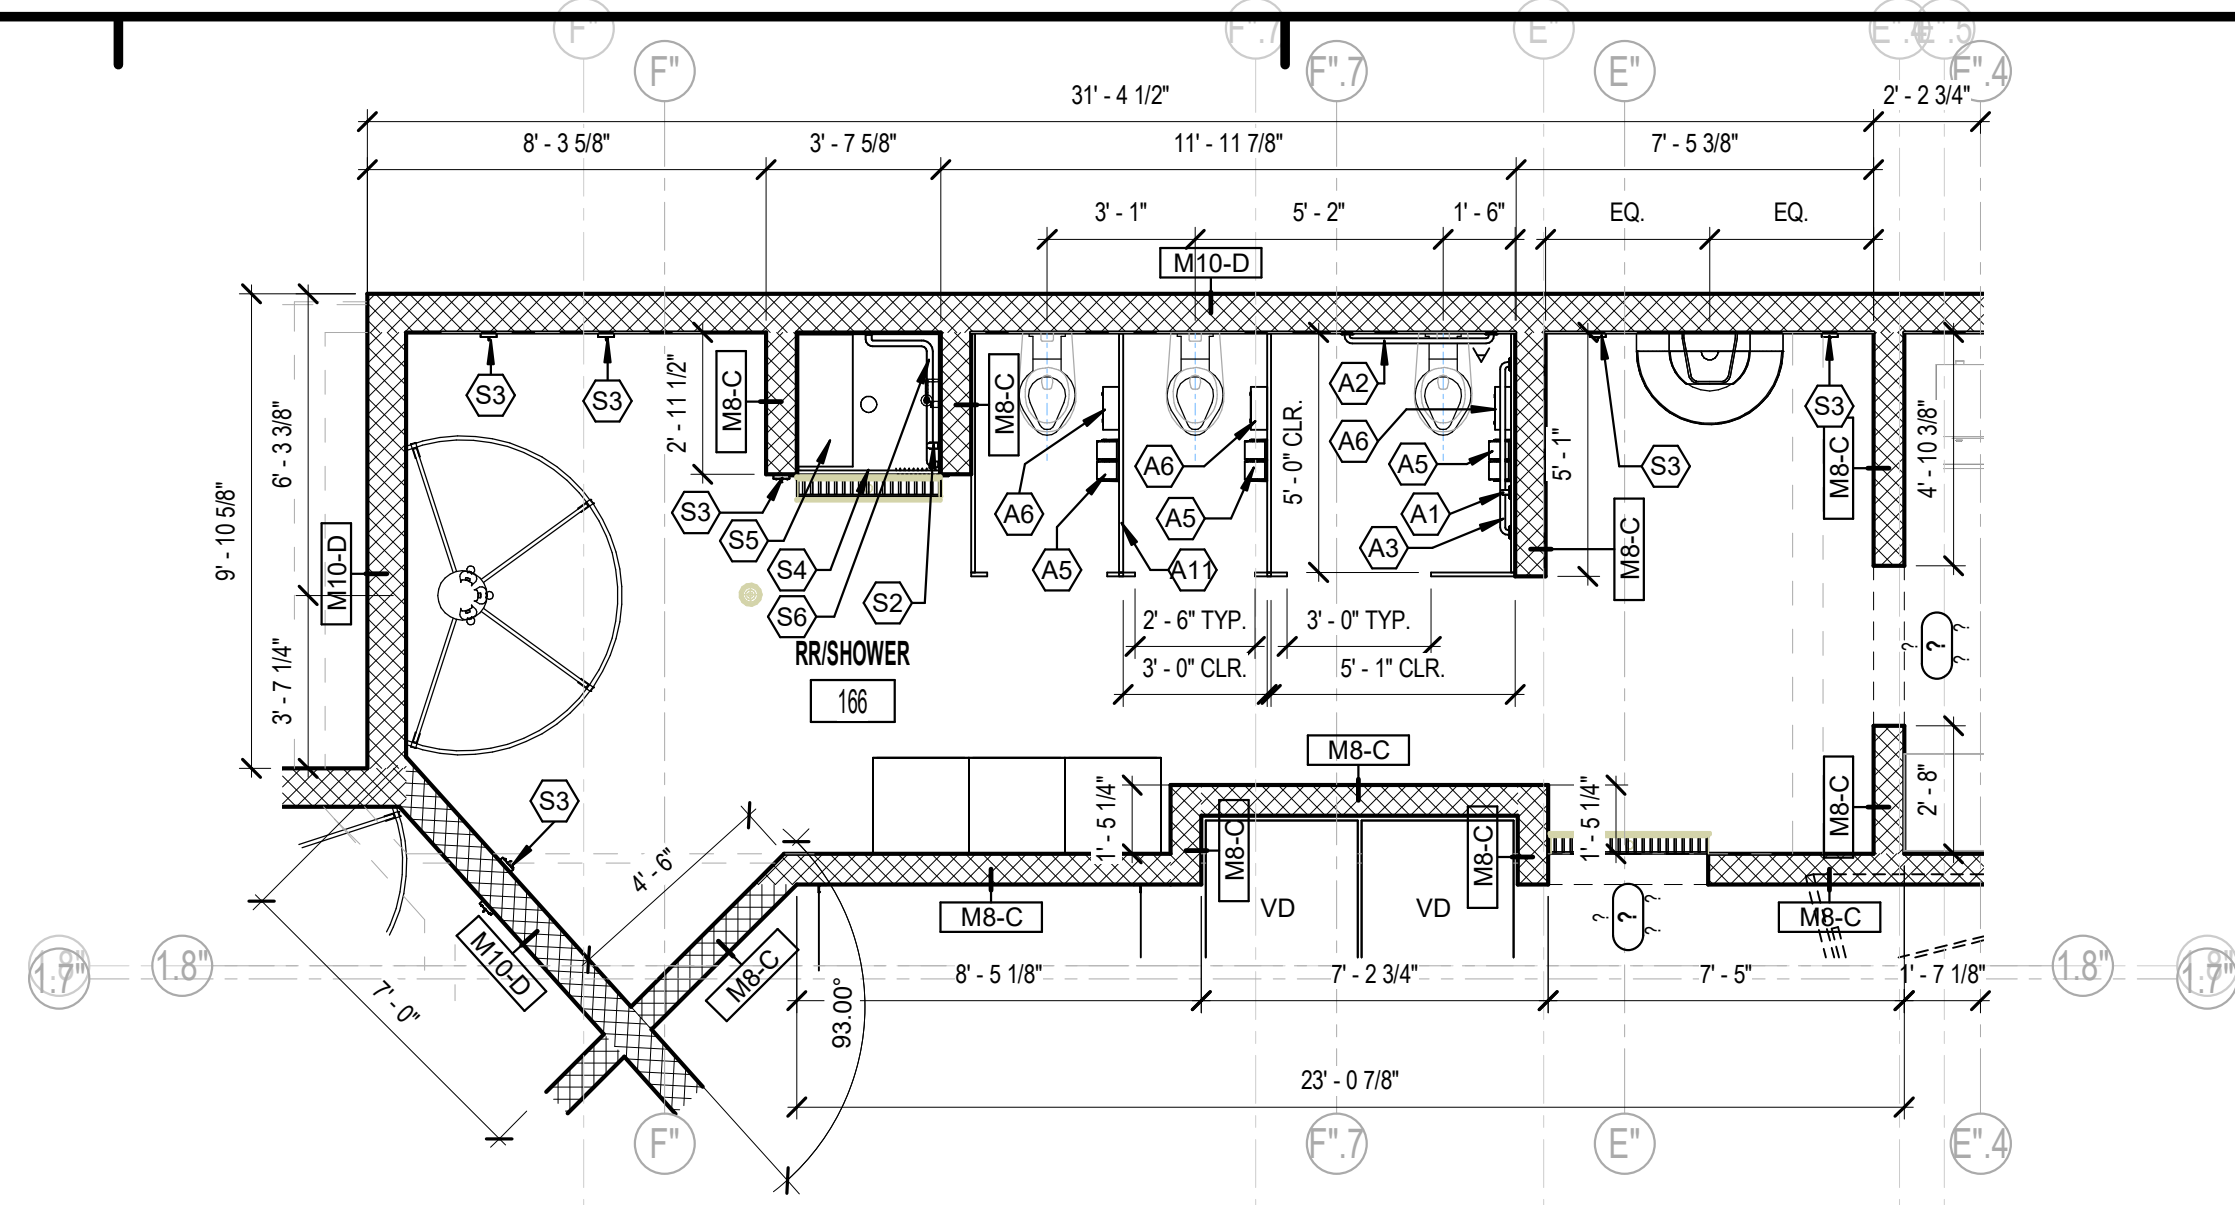


**5E UNIT F - ENLARGED PLAN RESTROOM/SHOWER 166**  
1/4" = 1'-0"




**3D UNIT B - ENLARGED PLAN RESTROOM 1113**  
1/4" = 1'-0"

Type Mark	Keynote	Description	Mounting	Furnished By	Installed By
A1	10 28 00	GRAB BAR - 18" VERTICAL	BOTTOM @ 40" AFF	CONTRACTOR	CONTRACTOR
A2	10 28 00	GRAB BAR - 36" HORIZONTAL	TOP @ 21" AFF	CONTRACTOR	CONTRACTOR
A3	10 28 00	GRAB BAR - 42" HORIZONTAL	TOP @ 21" AFF	CONTRACTOR	CONTRACTOR
A4	10 28 00	MIRROR - 24" X 36"	BOTTOM @ 4" ABOVE FIXTURE	CONTRACTOR	CONTRACTOR
A5	10 28 00	TOILET TISSUE DISPENSER - DOUBLE	BOTTOM @ 14" AFF	CONTRACTOR	CONTRACTOR
A6	10 28 00	SANITARY NAPKIN DISPOSAL - SURFACE	TOP @ 30" AFF	CONTRACTOR	CONTRACTOR
A7	10 28 00	SOAP DISPENSER	BOTTOM @ 4" ABOVE FIXTURE	CONTRACTOR	CONTRACTOR
A8	10 28 00	SANITARY NAPKIN DISPOSAL - SURFACE	TOP @ 30" AFF	CONTRACTOR	CONTRACTOR
A9	08 31 13	ACCESS DOOR - 16" X 16"	BOTTOM @ 40" AFF	CONTRACTOR	CONTRACTOR
A10	10 28 00	HAND DRYER - SLIM	BOTTOM @ 42" AFF	CONTRACTOR	CONTRACTOR
A11	10 21 13	TOILET PARTITION	BOTTOM @ 12" AFF	CONTRACTOR	CONTRACTOR
S1	11 19 10	SECURITY GRAB BAR - 42" HORIZONTAL, LIGATURE PROOF	TOP @ 21" AFF	CONTRACTOR	CONTRACTOR
S2	11 19 10	ADA SECURITY GRAB BAR - 18" VERTICAL, LIGATURE PROOF	BOTTOM @ 40" AFF	CONTRACTOR	CONTRACTOR
S3	11 19 10	SECURITY ROBE HOOKS WITH SUICIDE PREVENTION, LIGATURE PROOF	CENTER @ 44" AFF	CONTRACTOR	CONTRACTOR
S4	11 19 10	SECURITY SHOWER CURTAIN ROD	MOUNTED TO SOFFIT OF SHOWER UNIT	CONTRACTOR	CONTRACTOR
S5	11 19 10	ADA LOOSE FURNITURE SHOWER SEAT, BY OWNER	TOP @ 14" AFF	OWNER	OWNER
S6	11 19 10	ADA SECURITY SHOWER GRAB BAR - 40" HORIZONTAL	TOP @ 21" AFF	CONTRACTOR	CONTRACTOR
S7	11 19 10	SECURITY ACCESS DOOR - 24" X 32"	BOTTOM @ 40" AFF	CONTRACTOR	CONTRACTOR
S8	11 19 10	ADA DOUBLE SECURITY MIRROR, STAINLESS STEEL		CONTRACTOR	CONTRACTOR
S9	11 19 10	SECURITY MIRROR, STAINLESS STEEL		CONTRACTOR	CONTRACTOR
S10	11 19 10	SECURITY TYPE FULLY RECESSED TOILET PAPER HOLDER		CONTRACTOR	CONTRACTOR


NOTE: PROVIDE A 14" STAINLESS STEEL FINISH PANEL ABOVE ALL SECURITY SHOWERS, SPANNING VERTICALLY FROM SHOWER TO DECK/STRUCTURE ABOVE, AND HORIZONTALLY FROM STAINLESS STEEL PARTITION TO ADJACENT WALL. SEE TYPICAL DETAILS ON SIA-311. COORDINATE WITH MECHANICAL DRAWINGS FOR PERFORATION LOCATIONS.

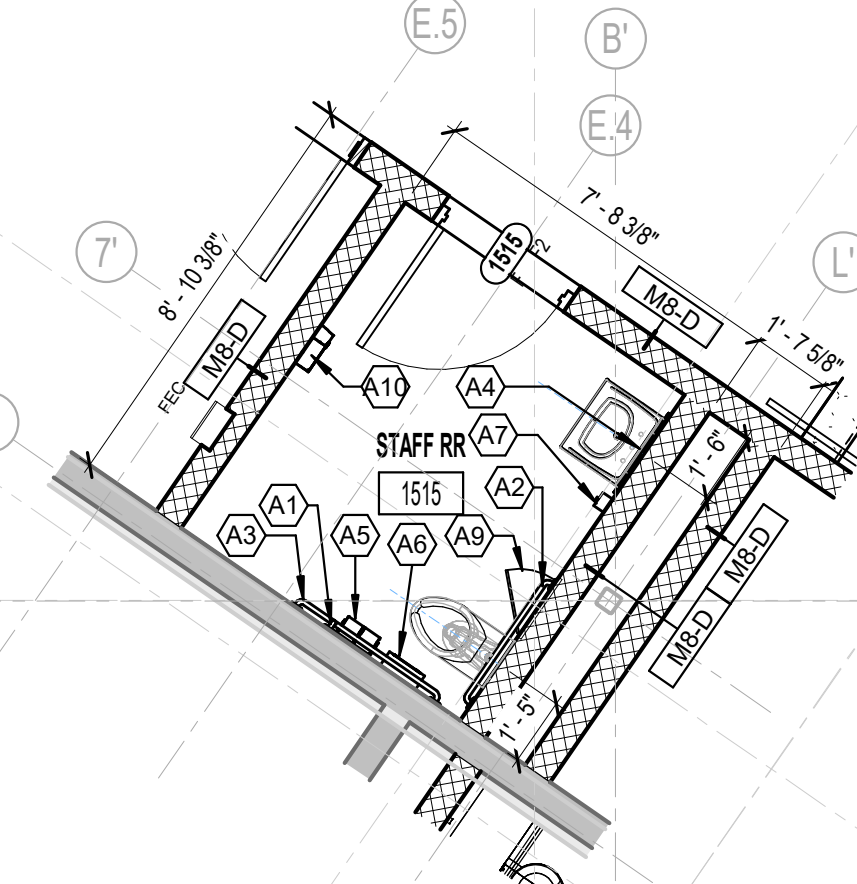


**2D UNIT A - ENLARGED PLAN STAFF RESTROOM 1515**  
1/4" = 1'-0"

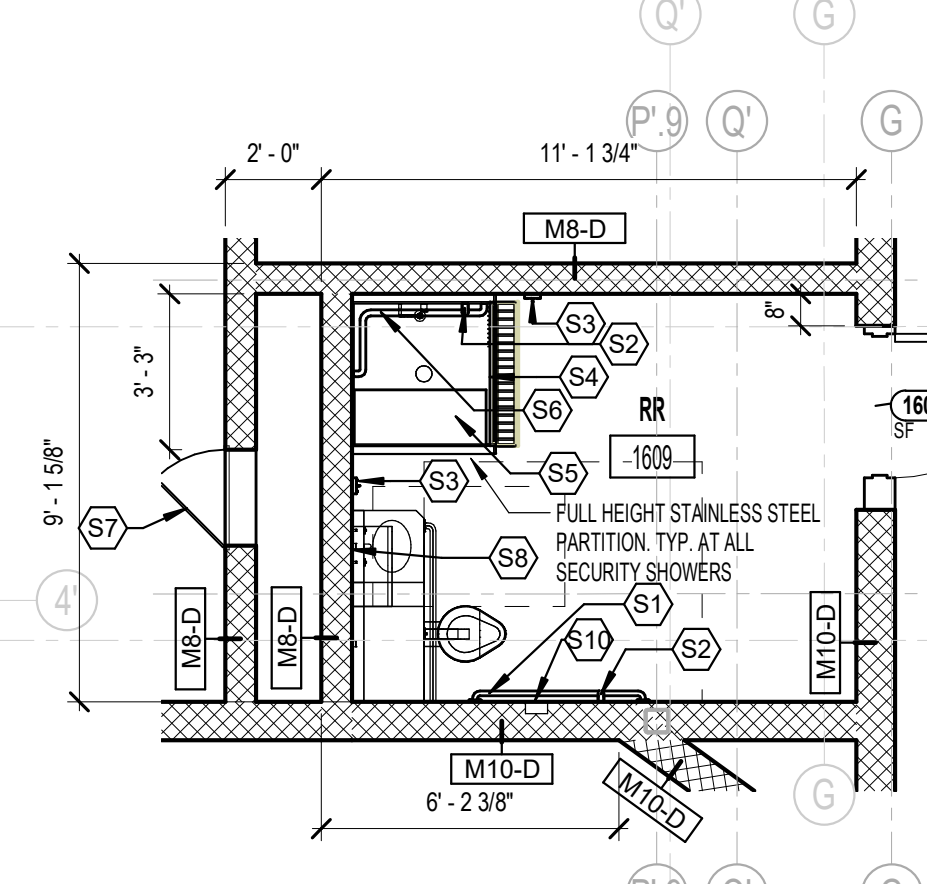


**1D UNIT D - ENLARGED PLAN RESTROOM 1609**  
1/4" = 1'-0"

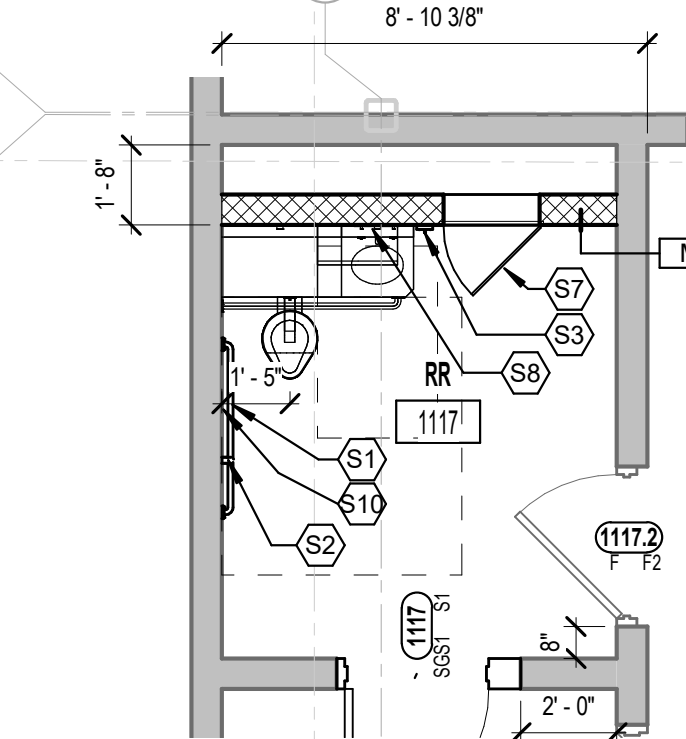


**2C UNIT B - ENLARGED PLAN RESTROOM 1117**  
1/4" = 1'-0"

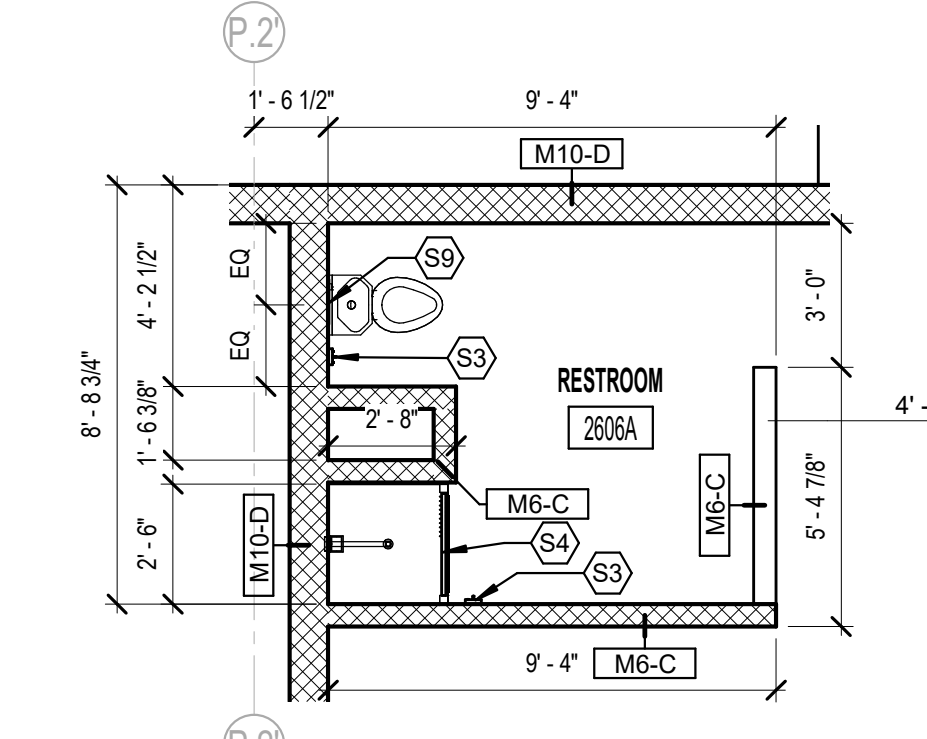


**1C UNIT D - ENLARGED PLAN RESTROOM 2606A**  
1/4" = 1'-0"

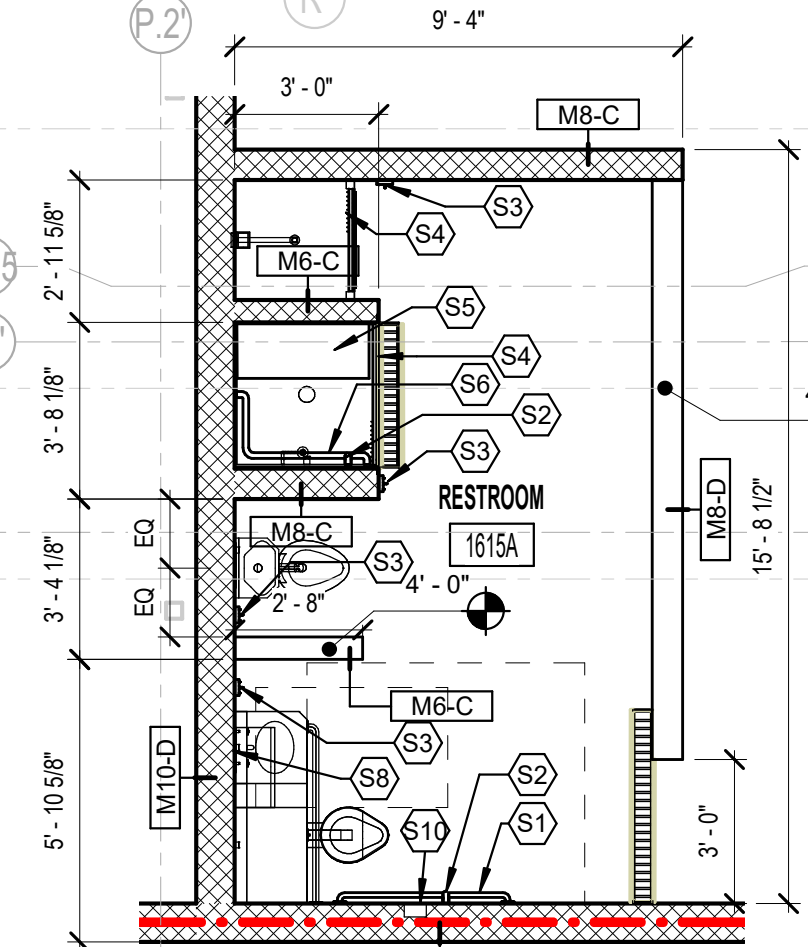


**2B UNIT D - ENLARGED PLAN RESTROOM 1615A**  
1/4" = 1'-0"

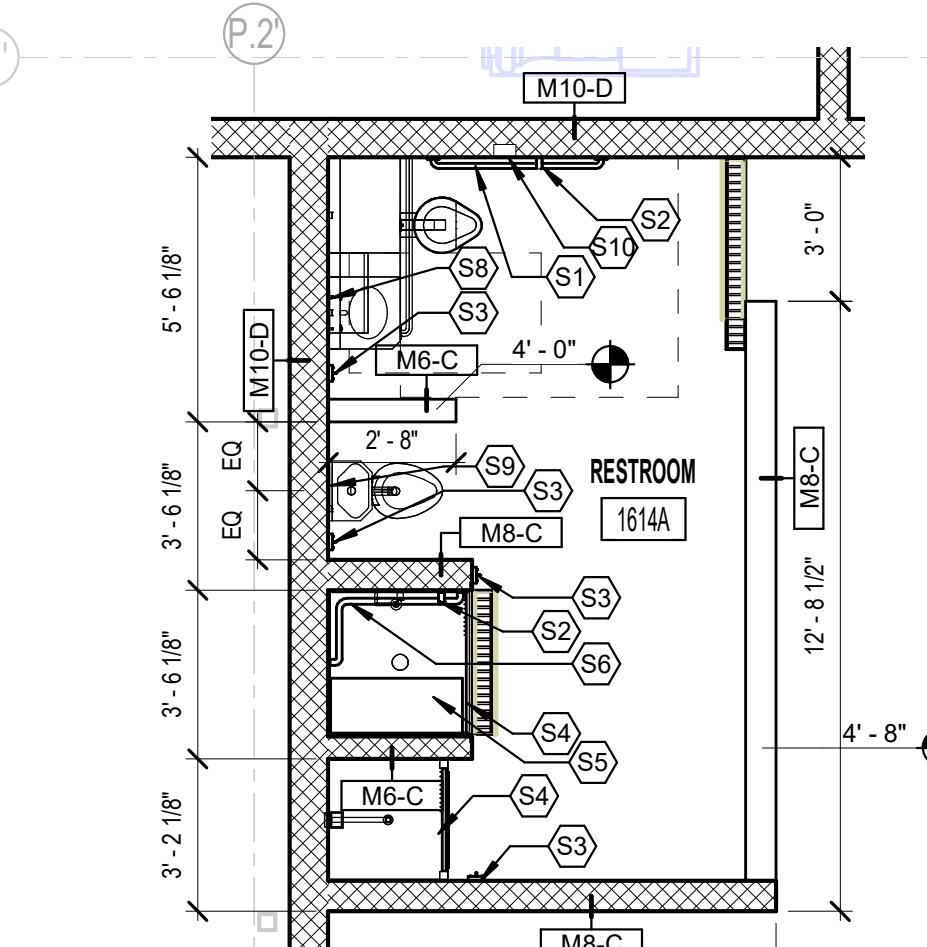


**1B UNIT D - ENLARGED PLAN RESTROOM 1314A**  
1/4" = 1'-0"

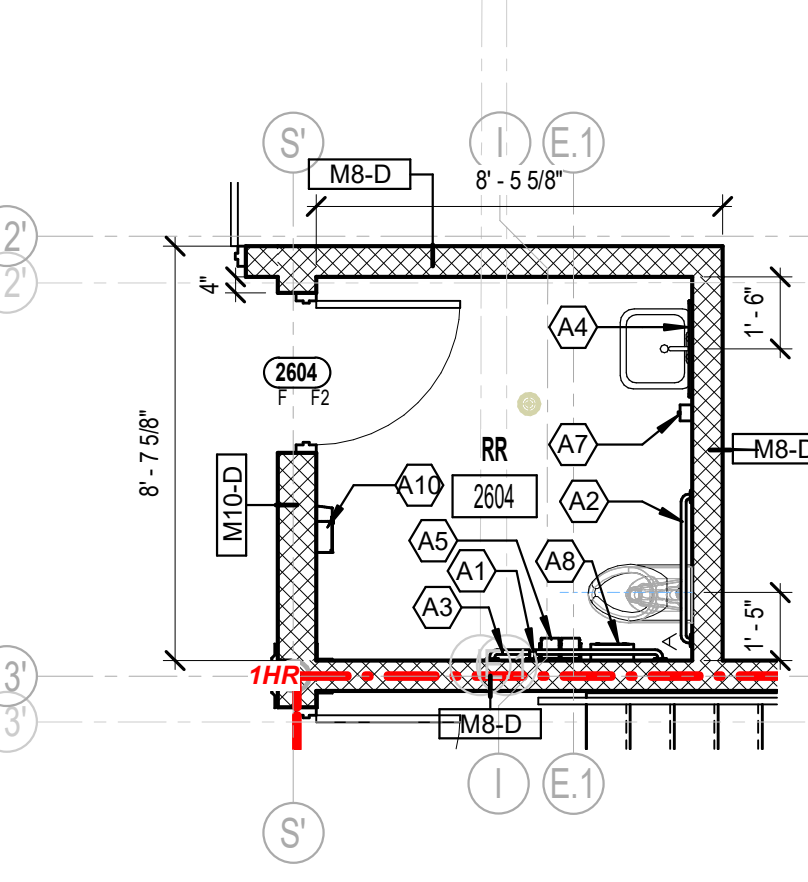


**2A UNIT D - ENLARGED PLAN RESTROOM 2604**  
1/4" = 1'-0"

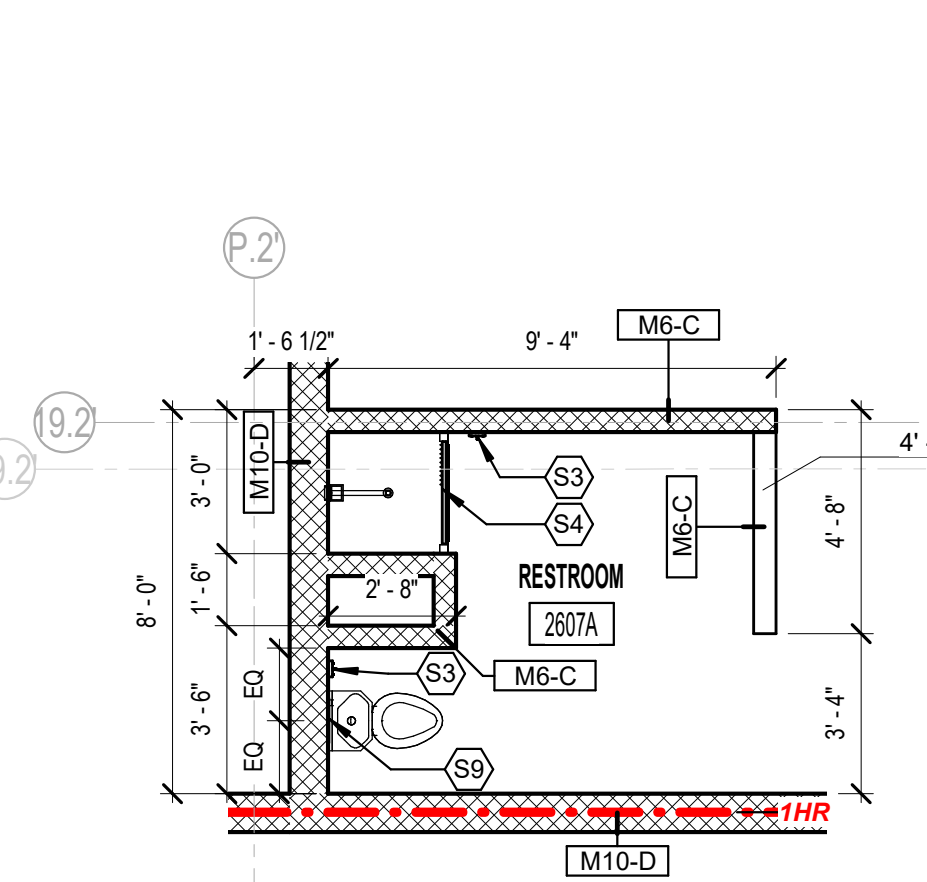


**1A UNIT D - ENLARGED PLAN RESTROOM 2607A**  
1/4" = 1'-0"

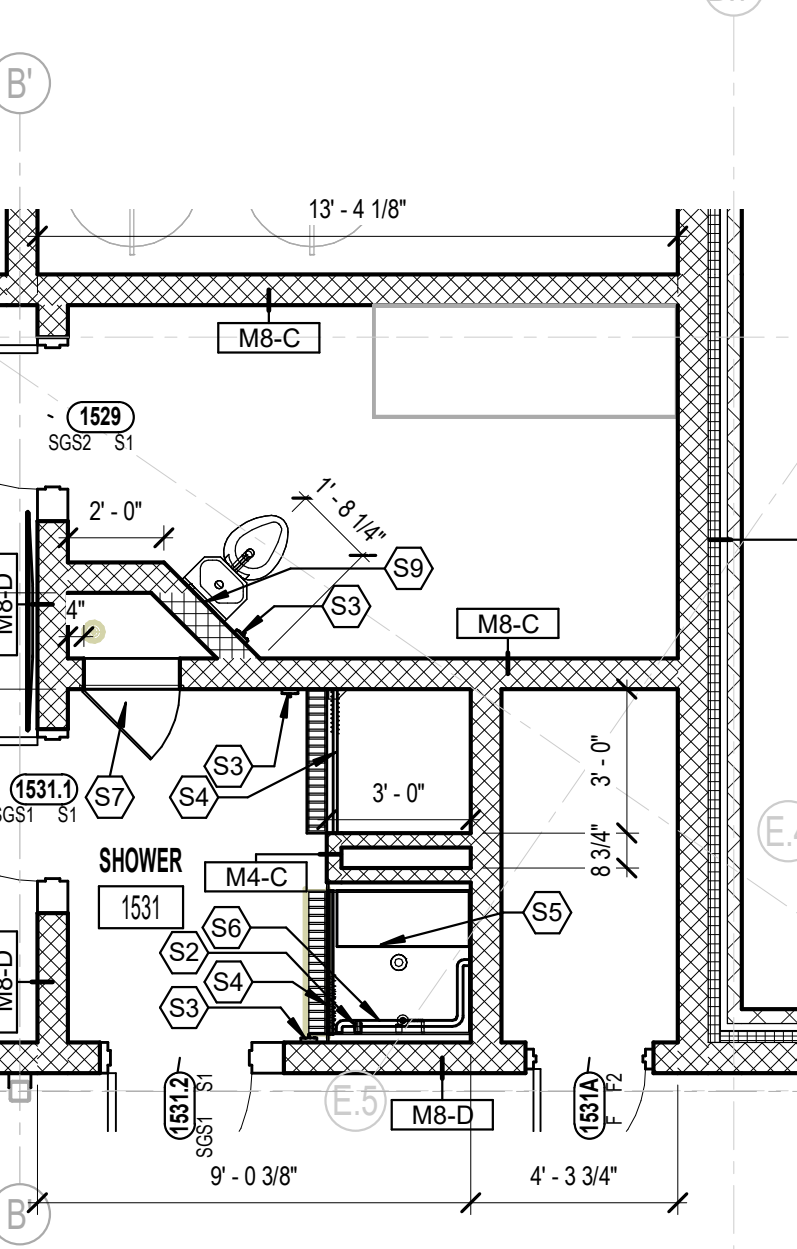


**3C UNIT A - ENLARGED PLAN SHOWER 1531**  
1/4" = 1'-0"

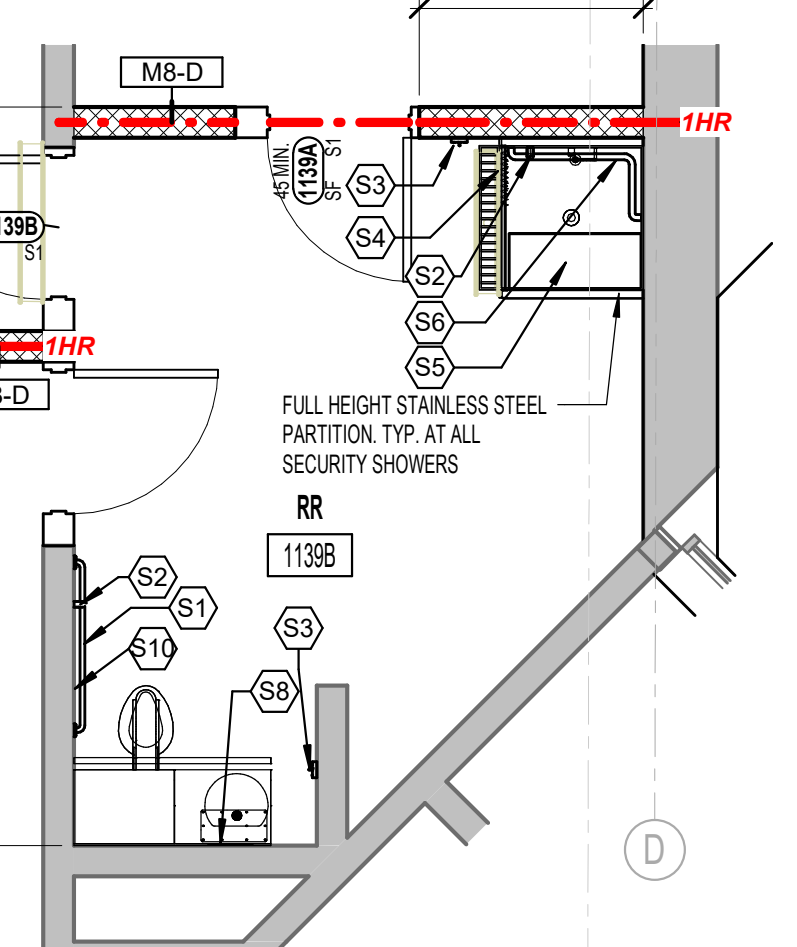


**3B UNIT B - ENLARGED PLAN RESTROOM 1139B**  
1/4" = 1'-0"

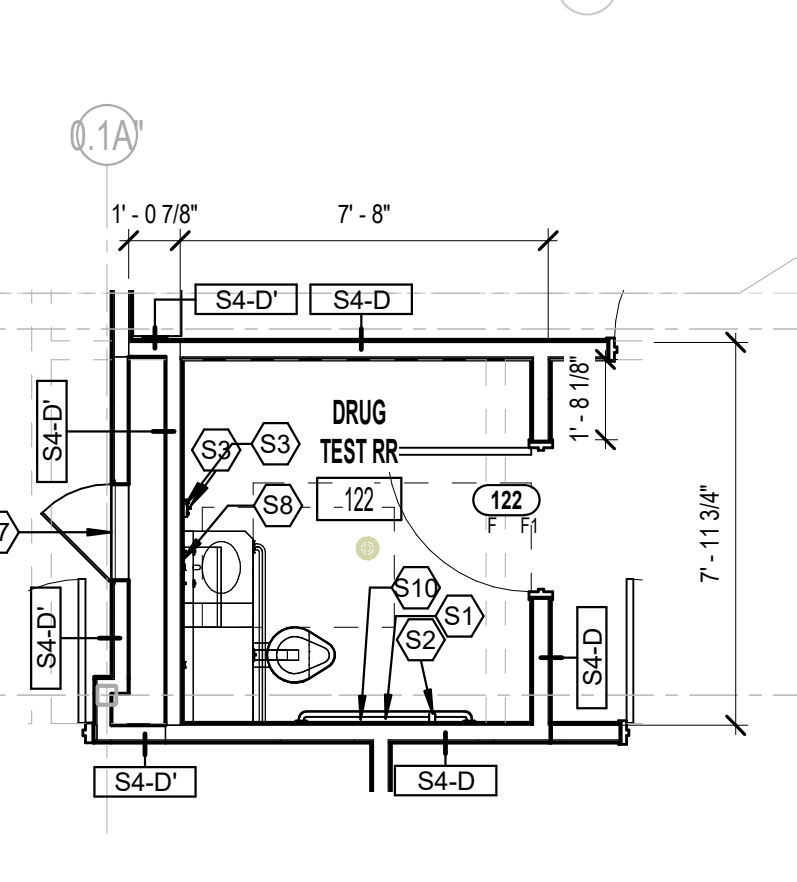


**3A UNIT F - ENLARGED PLAN DRUG TEST RESTROOM 122**  
1/4" = 1'-0"

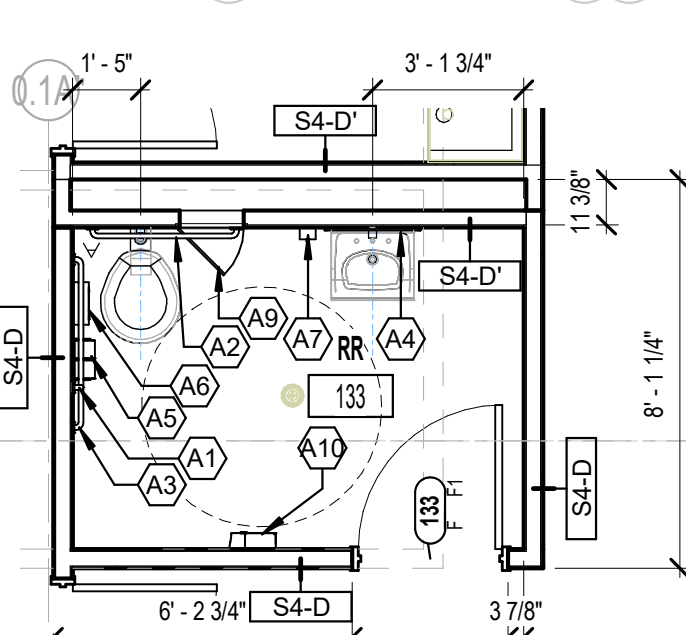


**4D UNIT F - ENLARGED PLAN RESTROOM 133**  
1/4" = 1'-0"

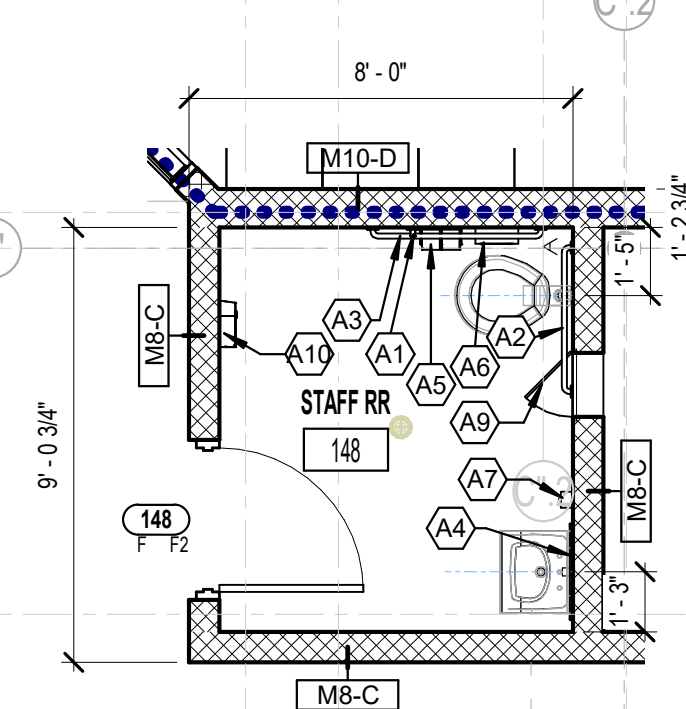


**4C UNIT F - ENLARGED PLAN STAFF RESTROOM 148**  
1/4" = 1'-0"

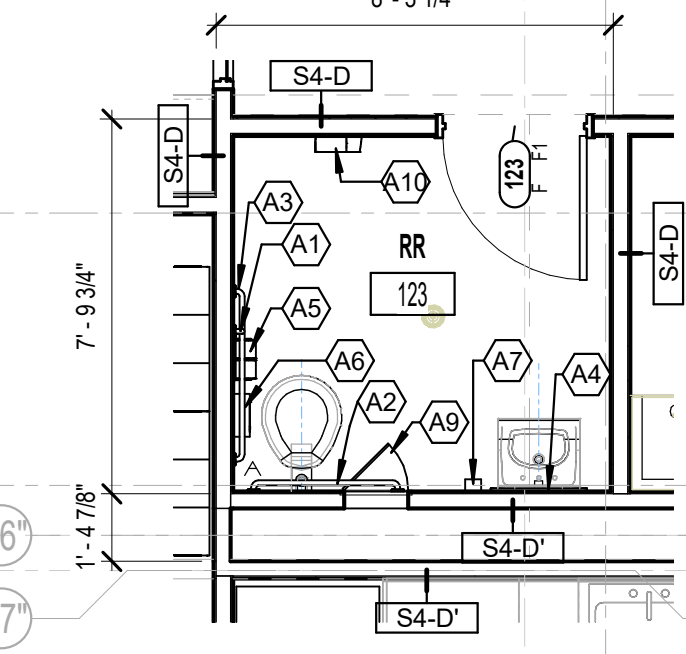


**4B UNIT F - ENLARGED PLAN RESTROOM 123**  
1/4" = 1'-0"

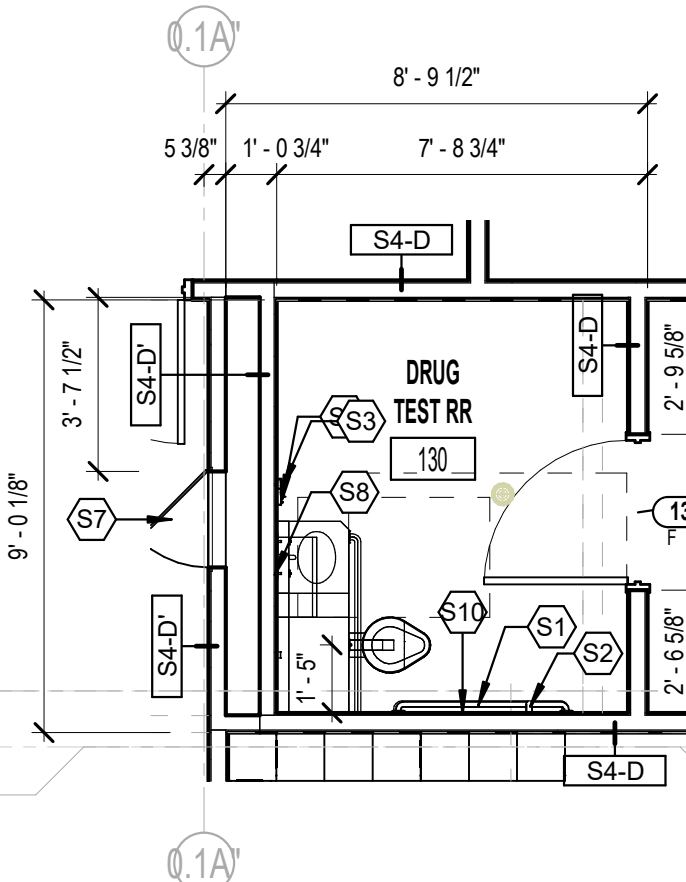


**4A UNIT F - ENLARGED PLAN DRUG TEST RESTROOM 130**  
1/4" = 1'-0"

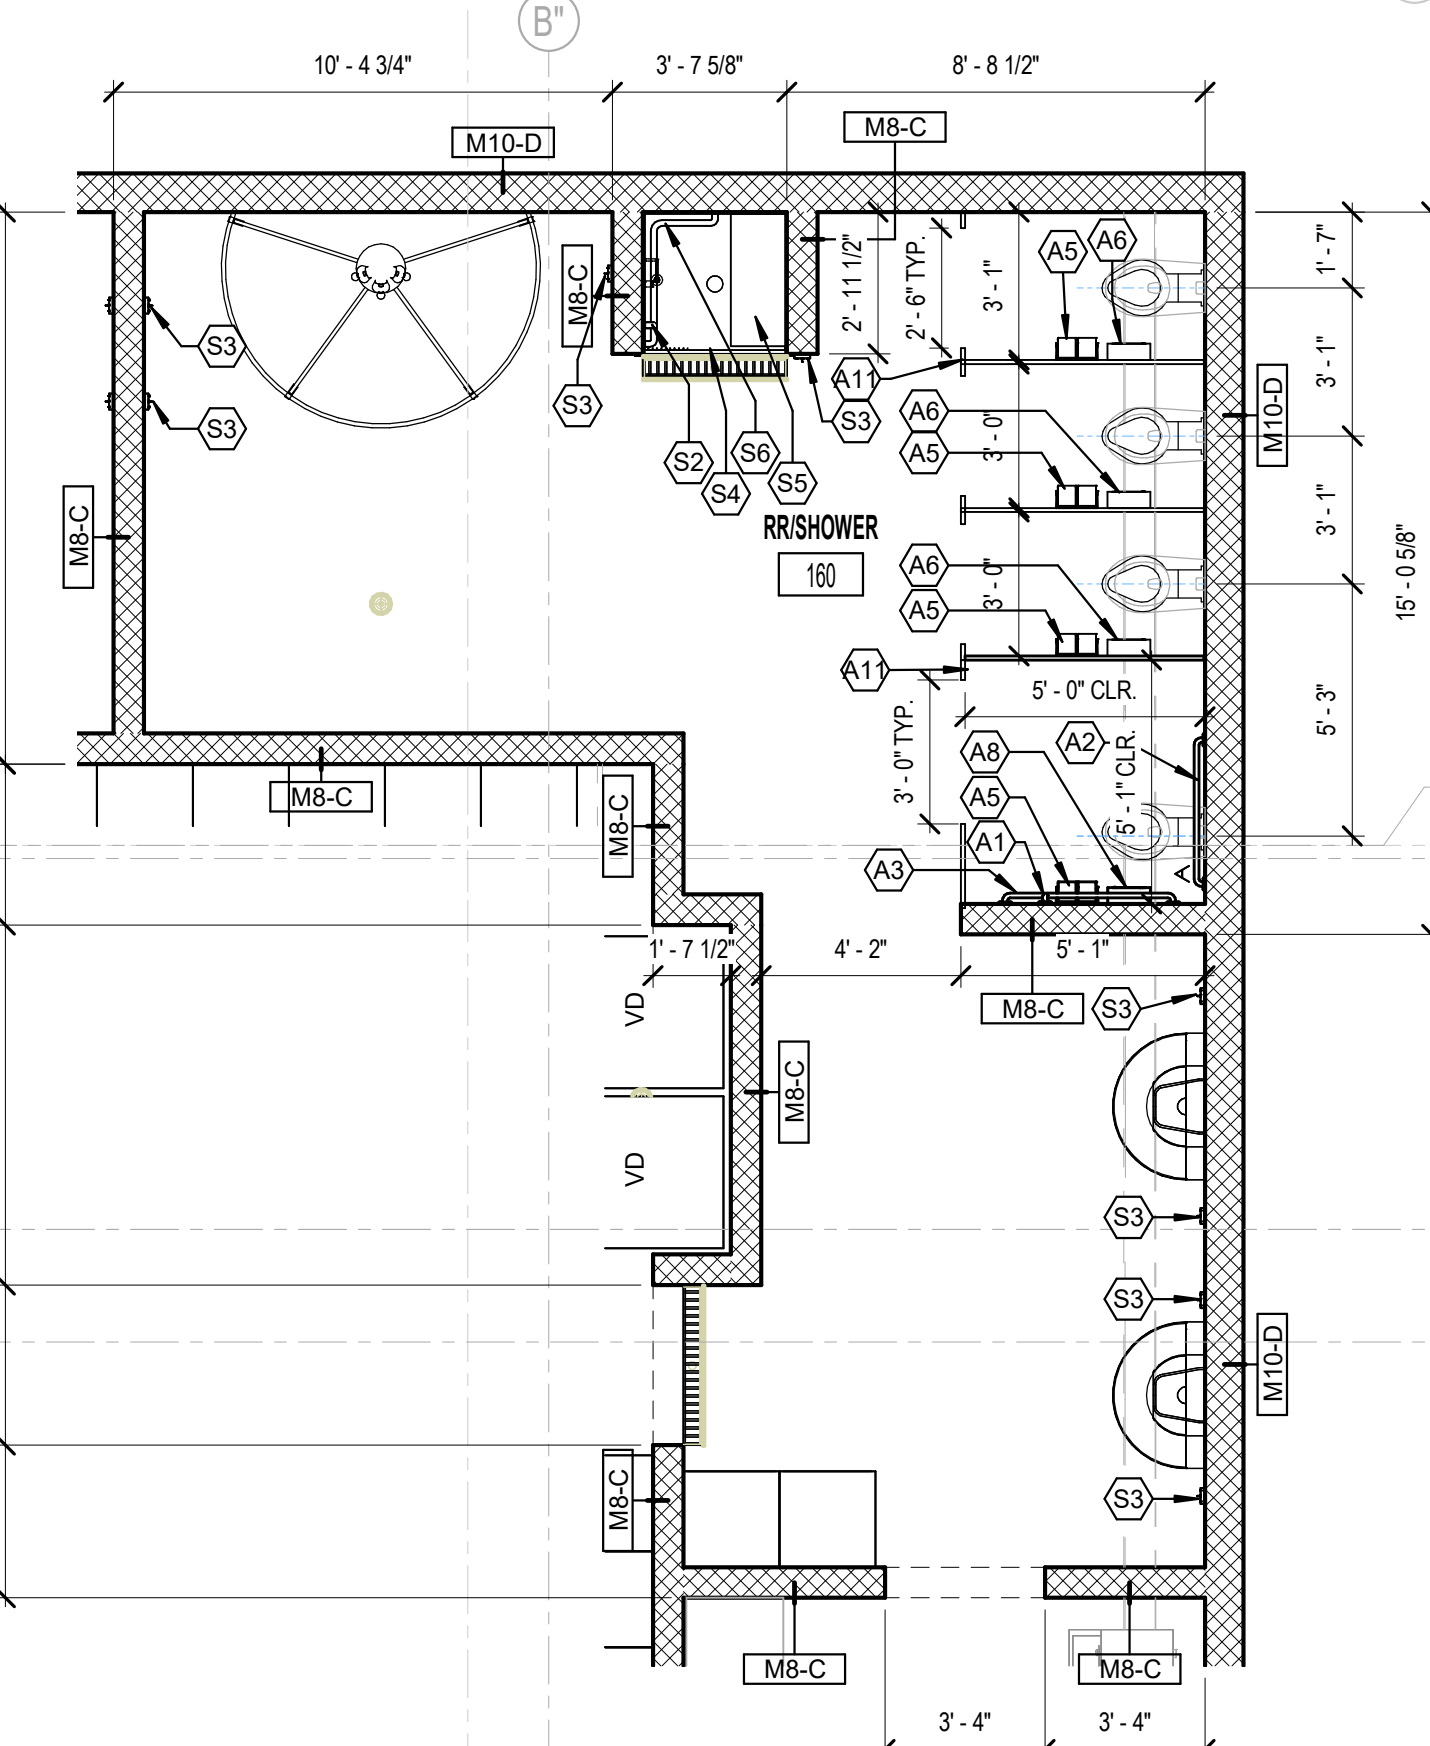

**6C UNIT F - ENLARGED PLAN RESTROOM/SHOWER 160**  
1/4" = 1'-0"

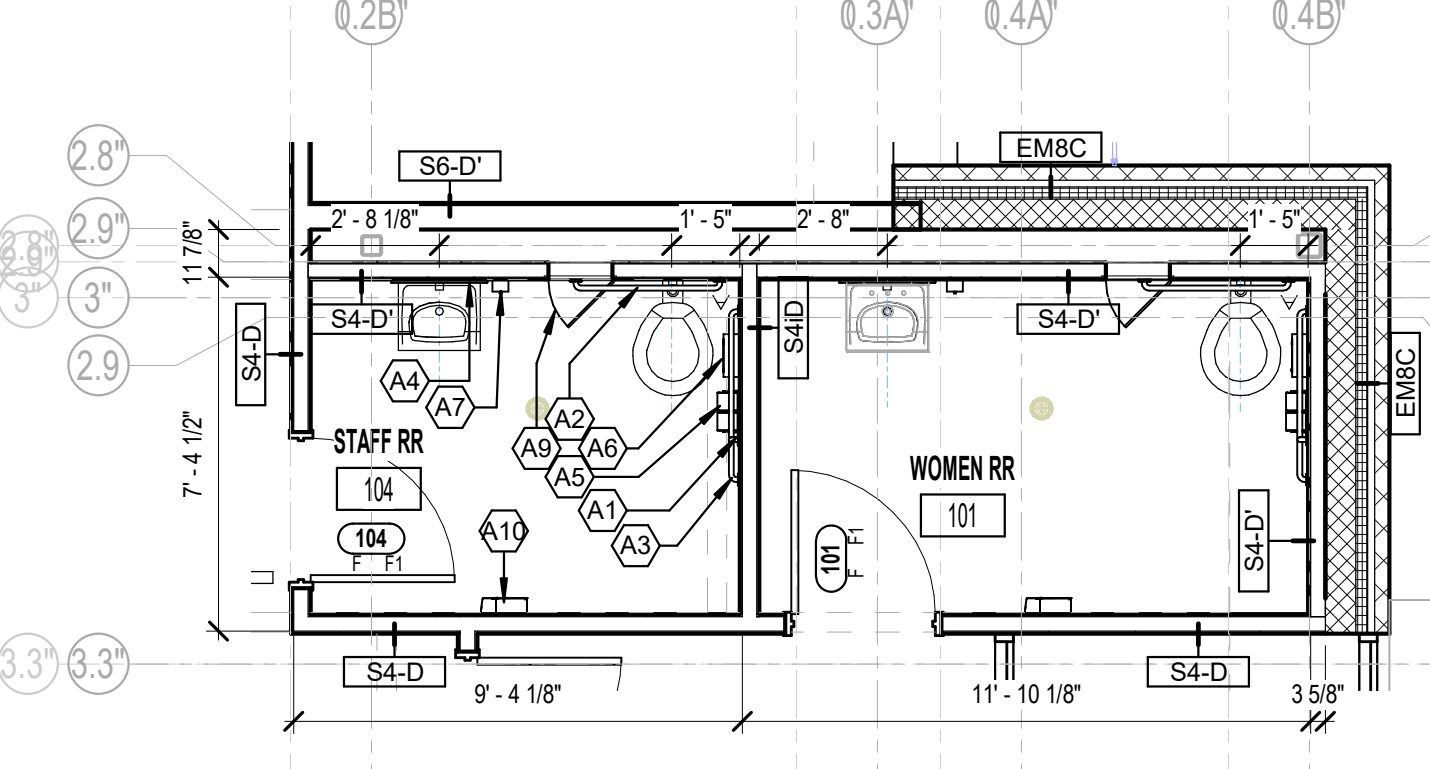

**6B UNIT F - ENLARGED PLAN WOMEN RESTROOM 101 & STAFF RESTROOM 104**  
1/4" = 1'-0"

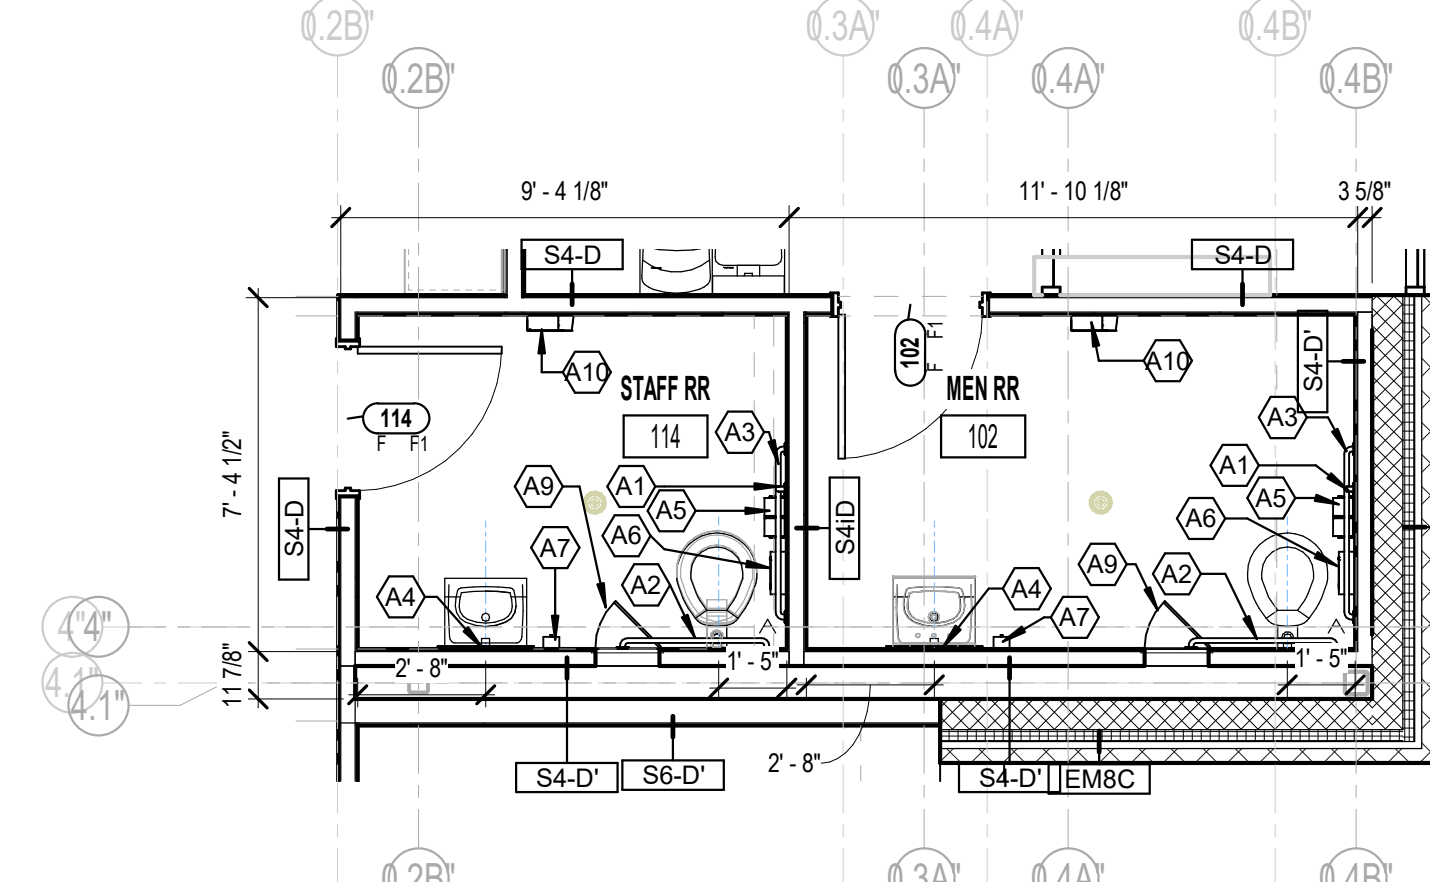

**6A UNIT F - ENLARGED MEN RESTROOM 102 & STAFF RESTROOM 114**  
1/4" = 1'-0"

#	Revision	Date
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Project #: 20-700-151-2

Designed By: LD/SP


Drawn By: CW

Checked By: LD/IV

Date: 01.28.2022




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ENLARGED BATHROOM PLANS

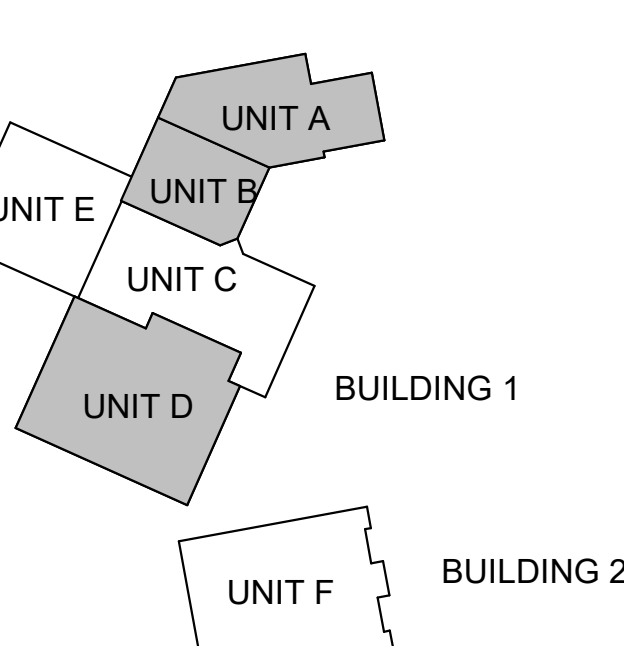



RQAW

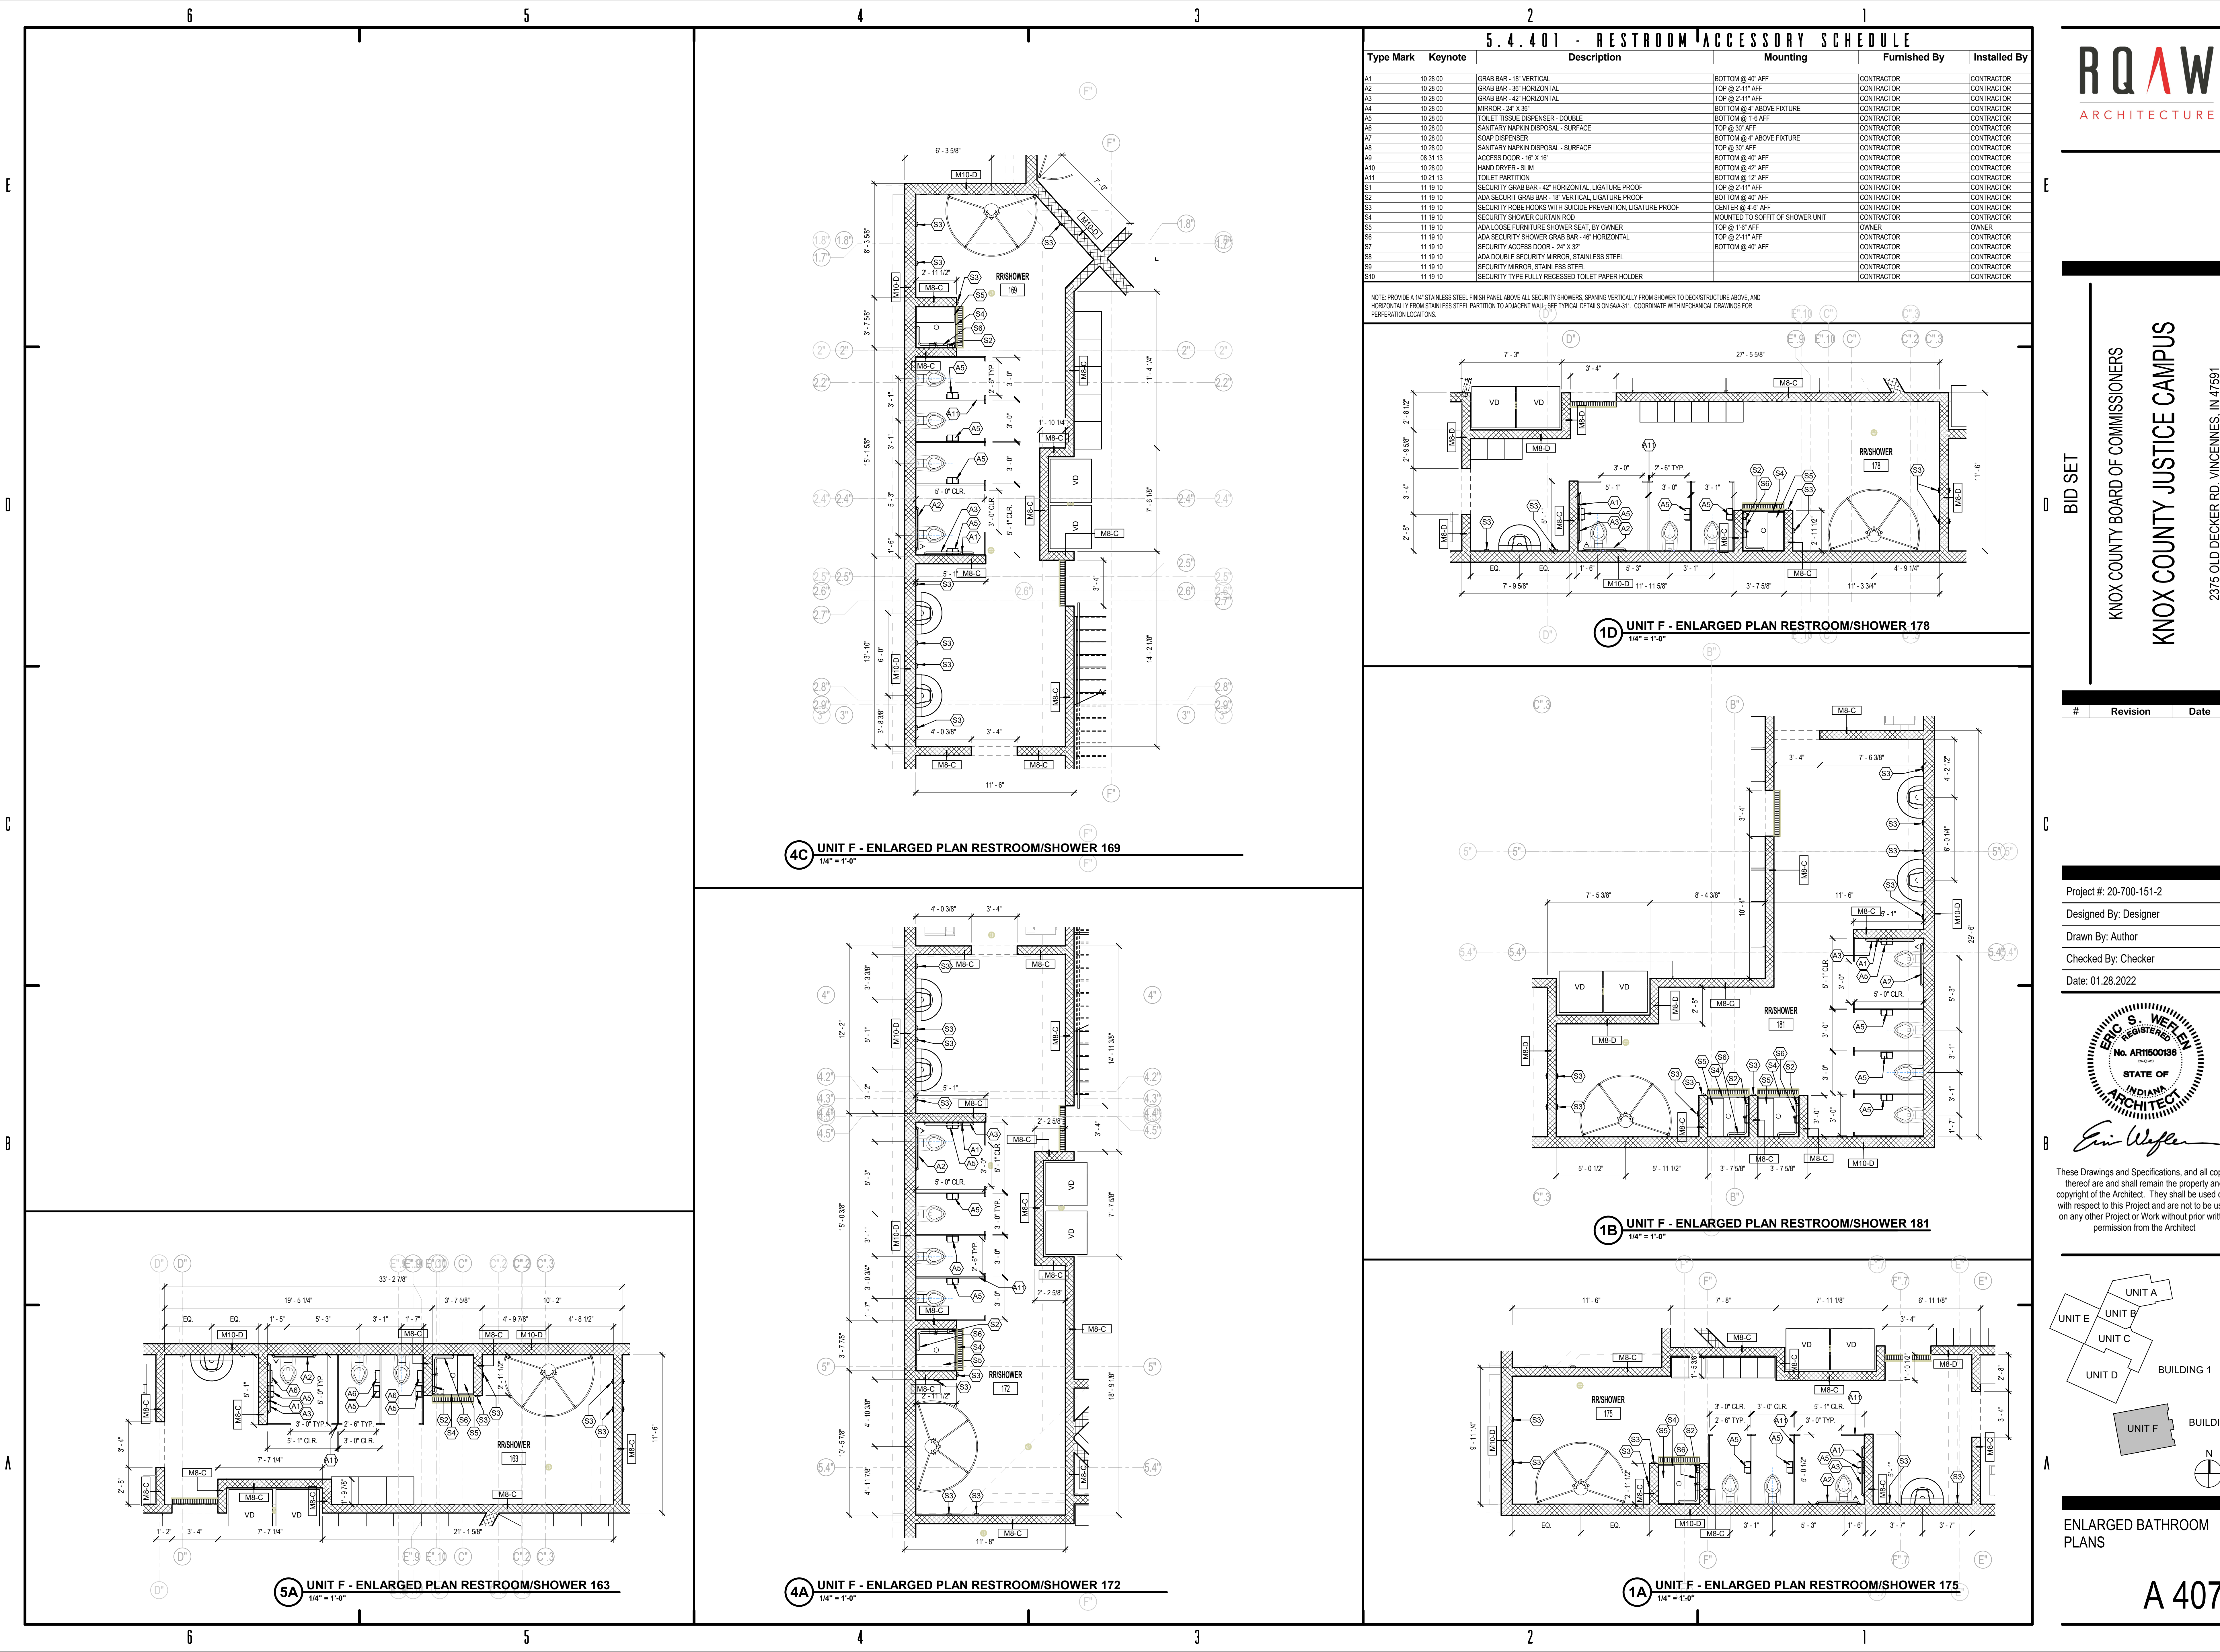ARCHITECTURE

BID SET

KNOX COUNTY BOARD OF COMMISSIONERS

KNOX COUNTY JUSTICE CAMPUS

2375 OLD DECKER RD. VINCENNES, IN 47591

#	Revision	Date
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Project #:

20-700-151-2

Designed By:

Designer

Drawn By:

Author

Checked By:

Checker

Date:

01.28.2022

ERIC S. WELLEN

REGISTERED

No. AR1500196

STATE OF INDIANA

ARCHITECT

Eric Wellen

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UNIT A

UNIT B

UNIT C

UNIT D

UNIT E

UNIT F


BUILDING 1

BUILDING 2


ENLARGED BATHROOM PLANS

A 407



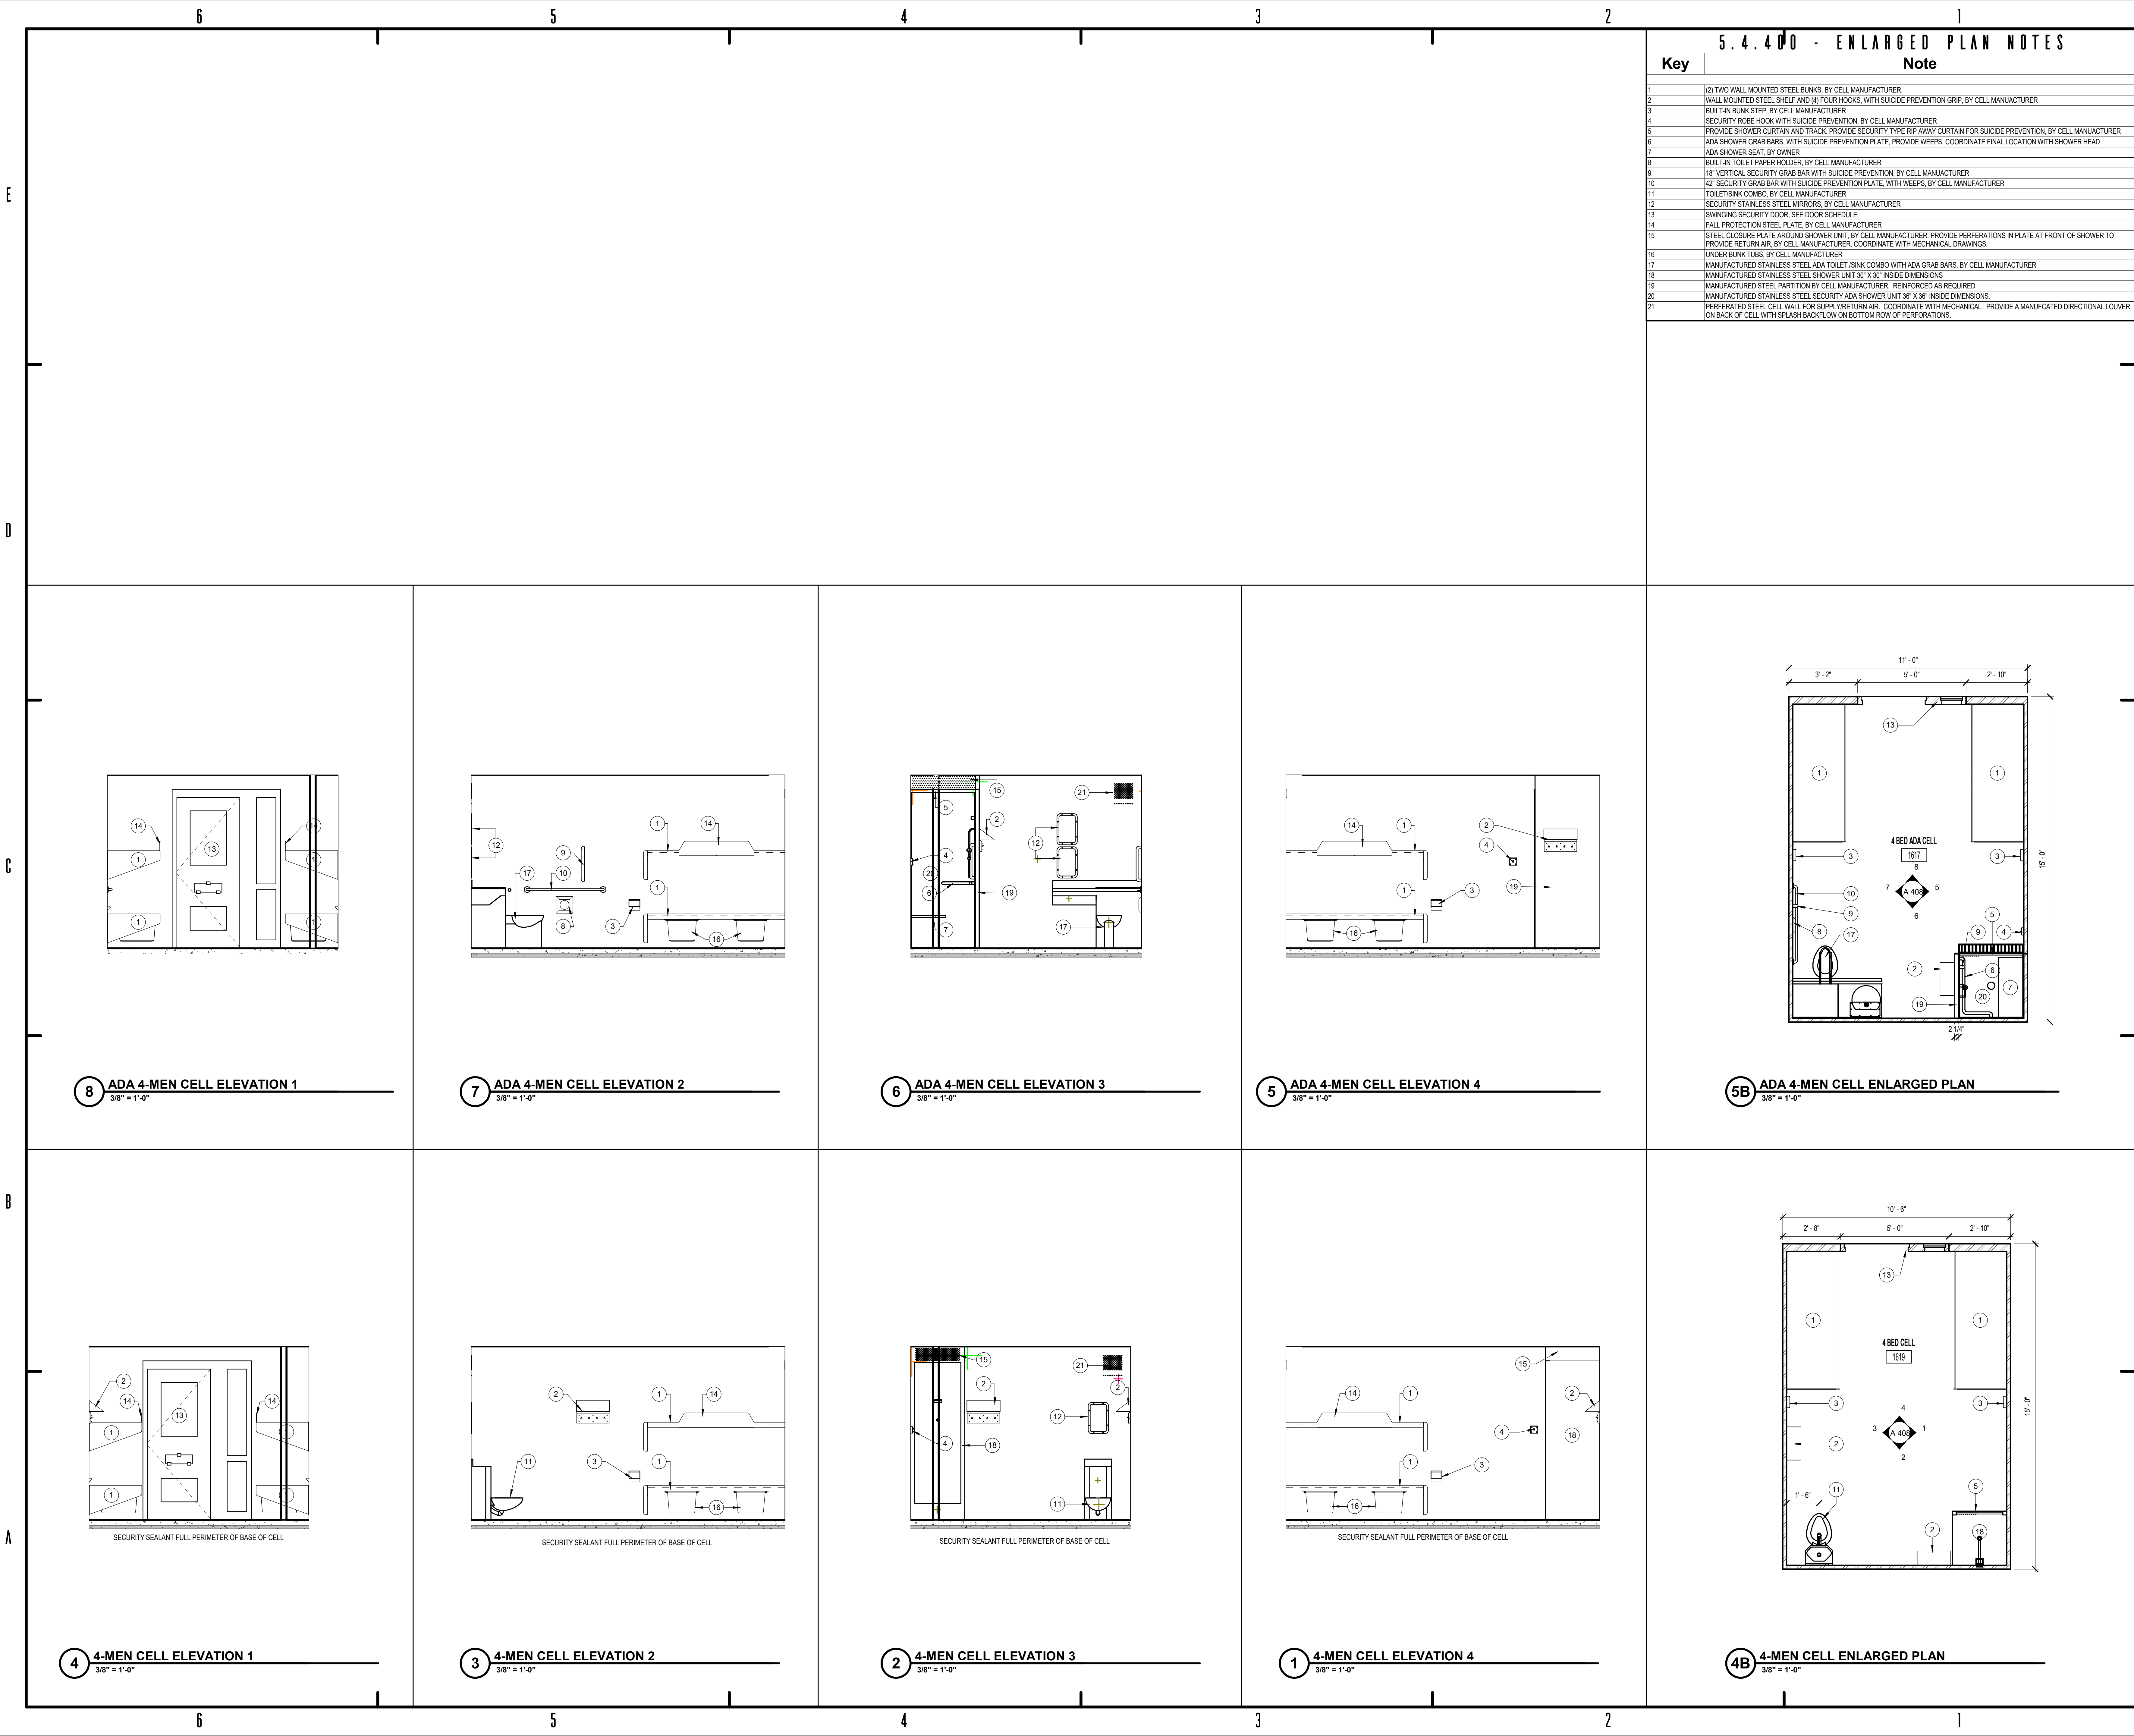

5.4.400 - ENLARGED PLAN NOTES	
Key	Note
1	(2) TWO WALL MOUNTED STEEL BUNKS, BY CELL MANUFACTURER.
2	WALL MOUNTED STEEL SHELF AND (4) FOUR HOOKS, WITH SUICIDE PREVENTION GRIP, BY CELL MANUFACTURER
3	BUILT-IN BUNK STEP, BY CELL MANUFACTURER
4	SECURITY ROBE HOOK WITH SUICIDE PREVENTION, BY CELL MANUFACTURER
5	PROVIDE SHOWER CURTAIN AND TRACK, PROVIDE SECURITY TYPE RP AWAY CURTAIN FOR SUICIDE PREVENTION, BY CELL MANUFACTURER
6	ADA SHOWER GRAB BARS, WITH SUICIDE PREVENTION PLATE, PROVIDE WEEPS, COORDINATE FINAL LOCATION WITH SHOWER HEAD
7	ADA SHOWER SEAT, BY OWNER
8	BUILT-IN TOILET PAPER HOLDER, BY CELL MANUFACTURER
9	18" VERTICAL SECURITY GRAB BAR WITH SUICIDE PREVENTION, BY CELL MANUFACTURER
10	42" SECURITY GRAB BAR WITH SUICIDE PREVENTION PLATE, WITH WEEPS, BY CELL MANUFACTURER
11	TOILET/SINK COMBO, BY CELL MANUFACTURER
12	SECURITY STAINLESS STEEL MIRRORS, BY CELL MANUFACTURER
13	SWINGING SECURITY DOOR, SEE DOOR SCHEDULE
14	FALL PROTECTION STEEL PLATE, BY CELL MANUFACTURER
15	STEEL CLOSURE PLATE AROUND SHOWER UNIT, BY CELL MANUFACTURER, PROVIDE PERFORATIONS IN PLATE AT FRONT OF SHOWER TO PROVIDE RETURN AIR, BY CELL MANUFACTURER, COORDINATE WITH MECHANICAL DRAWINGS.
16	UNDER BUNK TUBS, BY CELL MANUFACTURER
17	MANUFACTURED STAINLESS STEEL ADA TOILET /SINK COMBO WITH ADA GRAB BARS, BY CELL MANUFACTURER
18	MANUFACTURED STAINLESS STEEL SHOWER UNIT, 36" X 36" INSIDE DIMENSIONS
19	MANUFACTURED STEEL PARTITION BY CELL MANUFACTURER, REINFORCED AS REQUIRED
20	MANUFACTURED STAINLESS STEEL SECURITY ADA SHOWER UNIT 36" X 36" INSIDE DIMENSIONS.
21	PERFORATED STEEL CELL WALL FOR SUPPLY/RETURN AIR. COORDINATE WITH MECHANICAL. PROVIDE A MANUFACTURED DIRECTIONAL LOUVER ON BACK OF CELL WITH SPLASH BACKFLOW ON BOTTOM ROW OF PERFORATIONS.



BID SET

KNOX COUNTY BOARD OF COMMISSIONERS

KNOX COUNTY JUSTICE CAMPUS

2375 OLD DECKER RD. VINCENNES, IN 47591

#	Revision	Date
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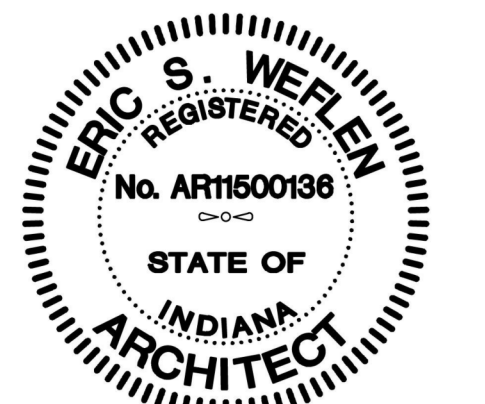
Project #: 20-700-151-2

Designed By: Designer

Drawn By: Author


Checked By: Checker

Date: 01.28.2022



Eric Weylan

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UNIT A

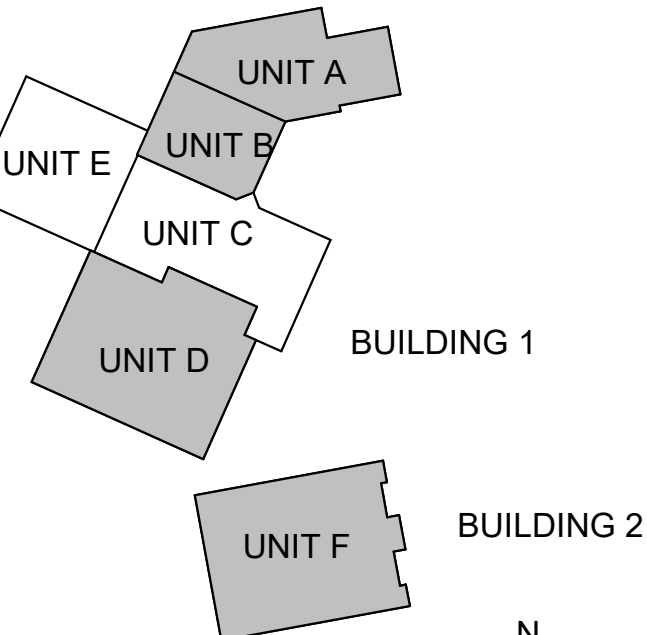UNIT B

UNIT C

UNIT D

UNIT E

UNIT F

BUILDING 1

BUILDING 2

N


ENLARGED CELL PLANS & DETAILS

A 408




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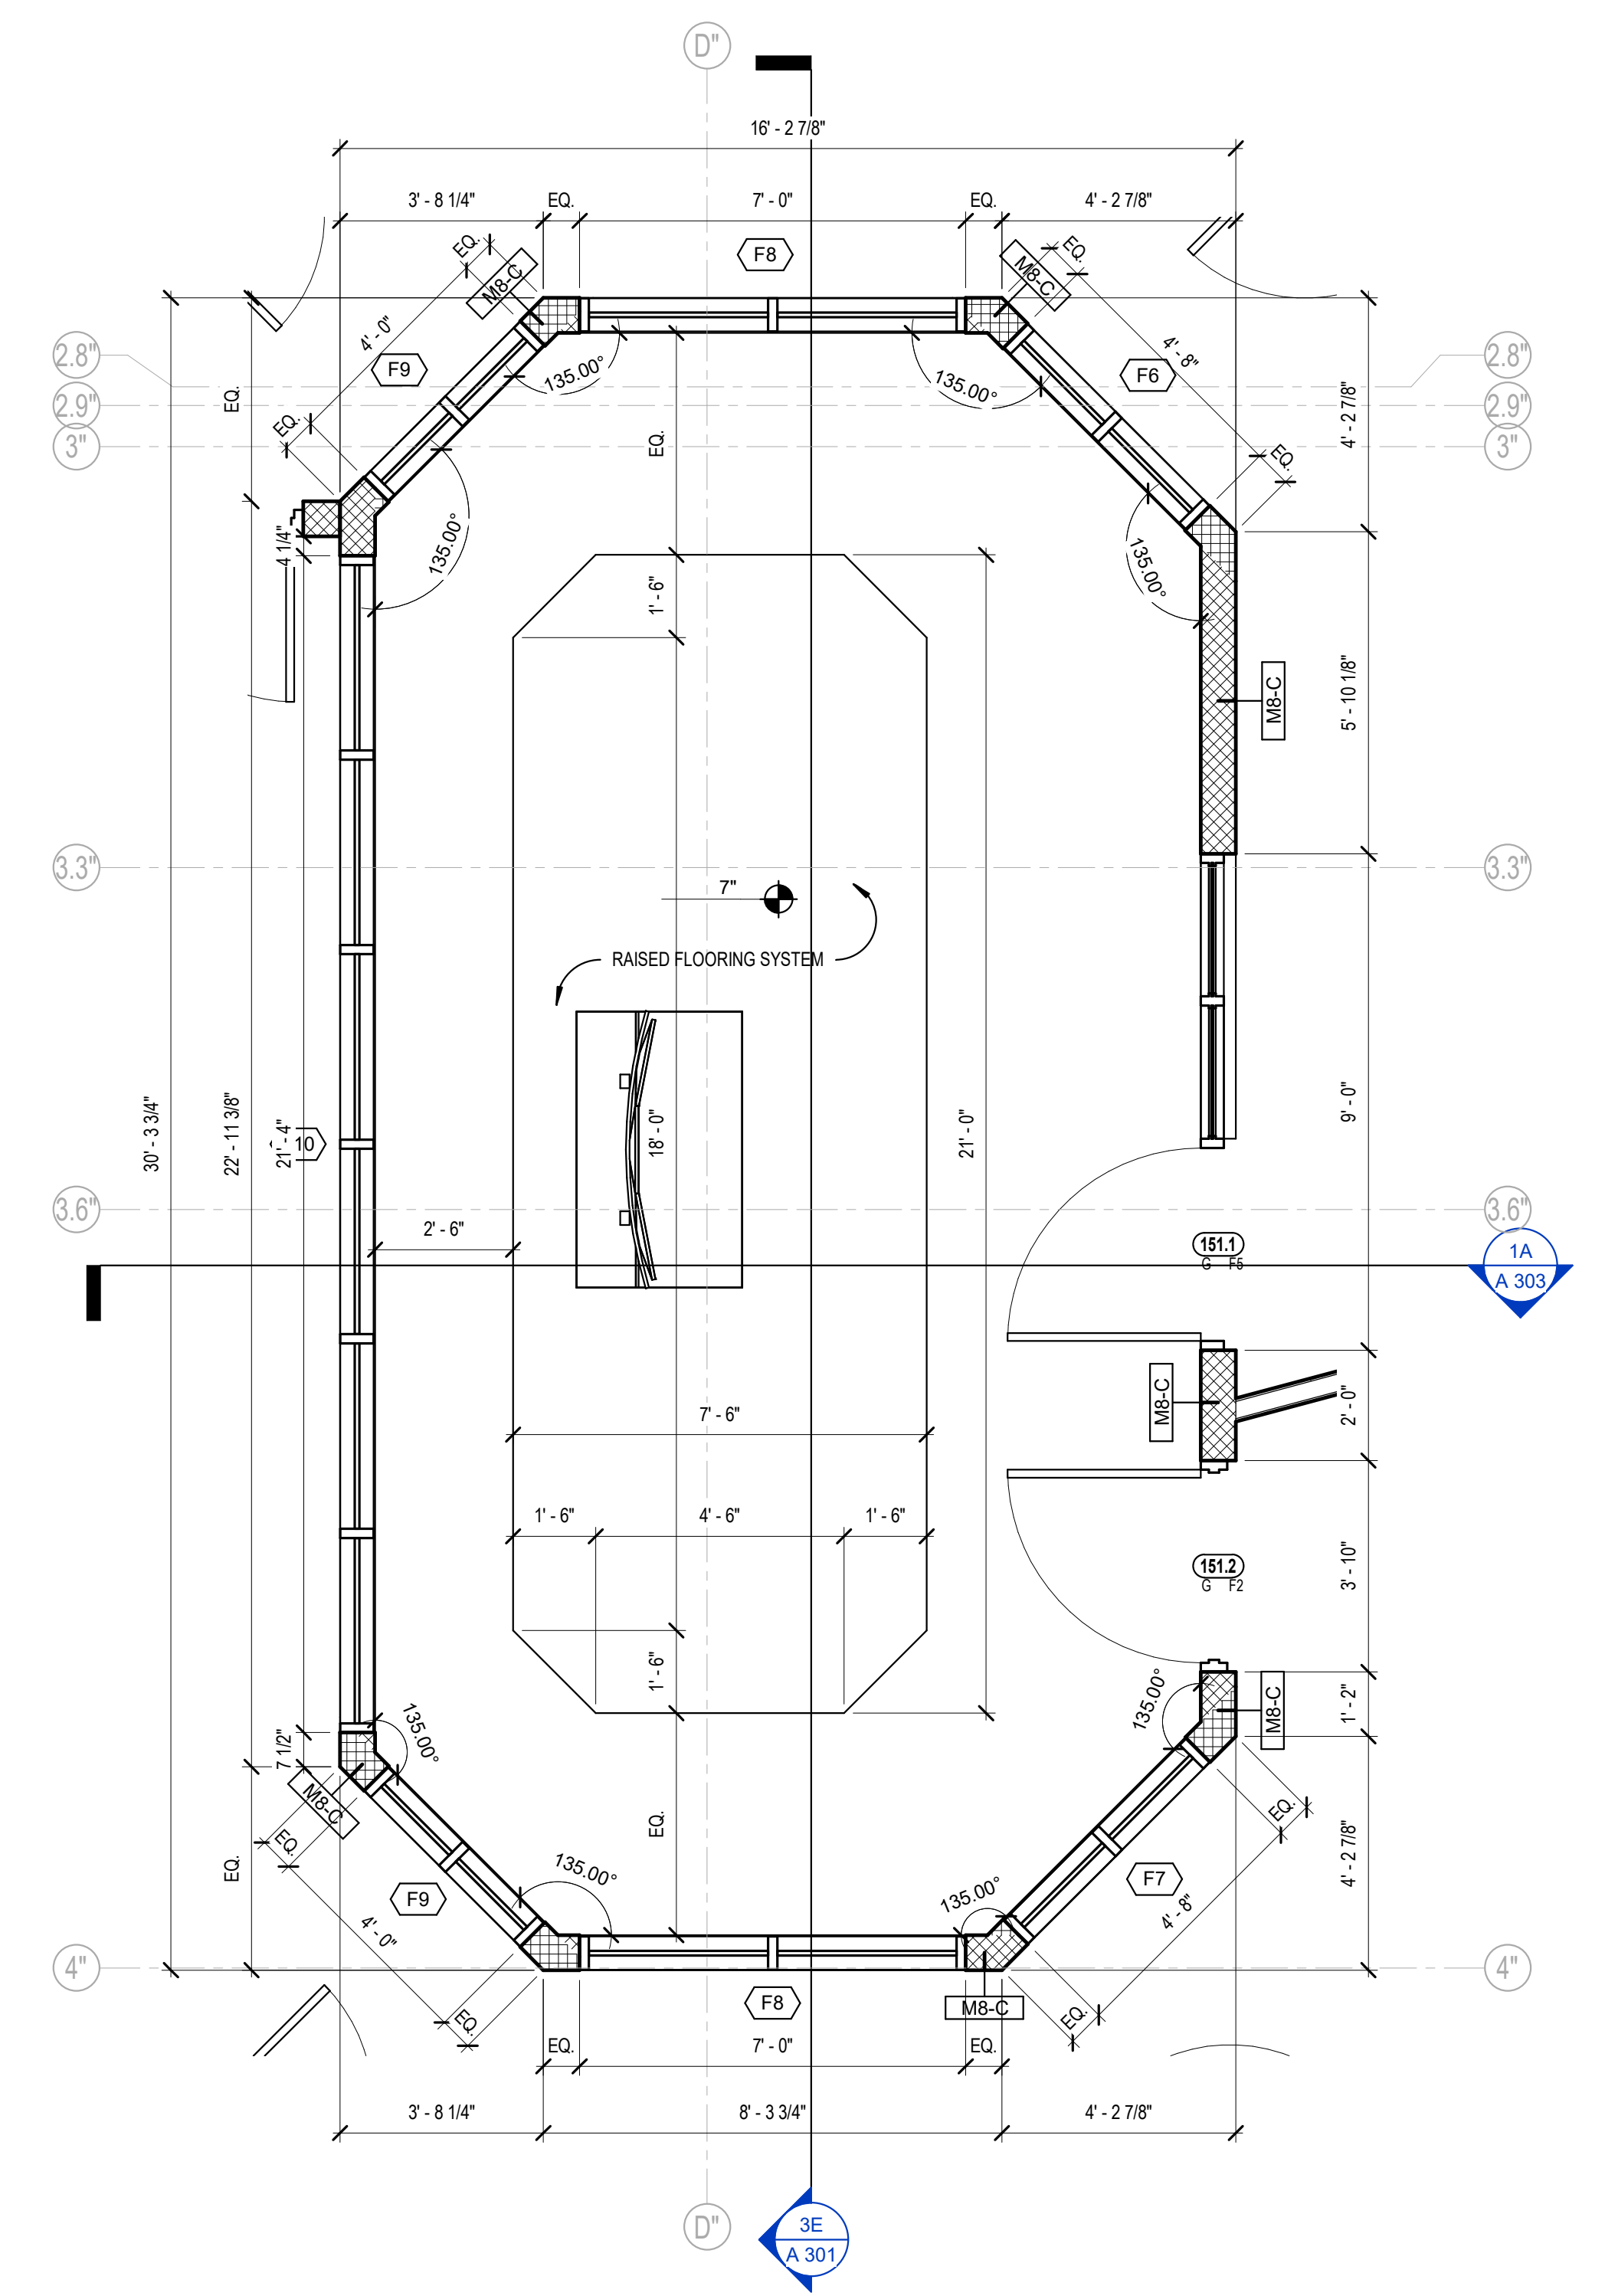
Project #: 20-700-151-2  
Designed By: Designer  
Drawn By: Author  
Checked By: Checker  
Date: 01.28.2022

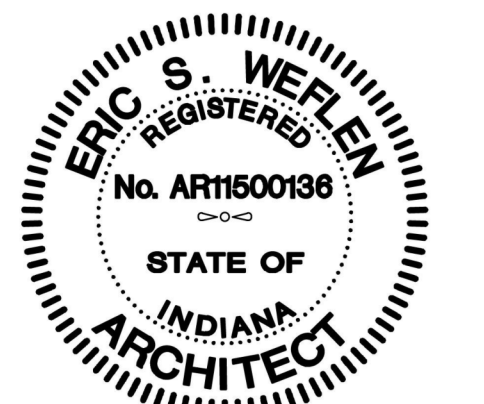


Eric Wepler  
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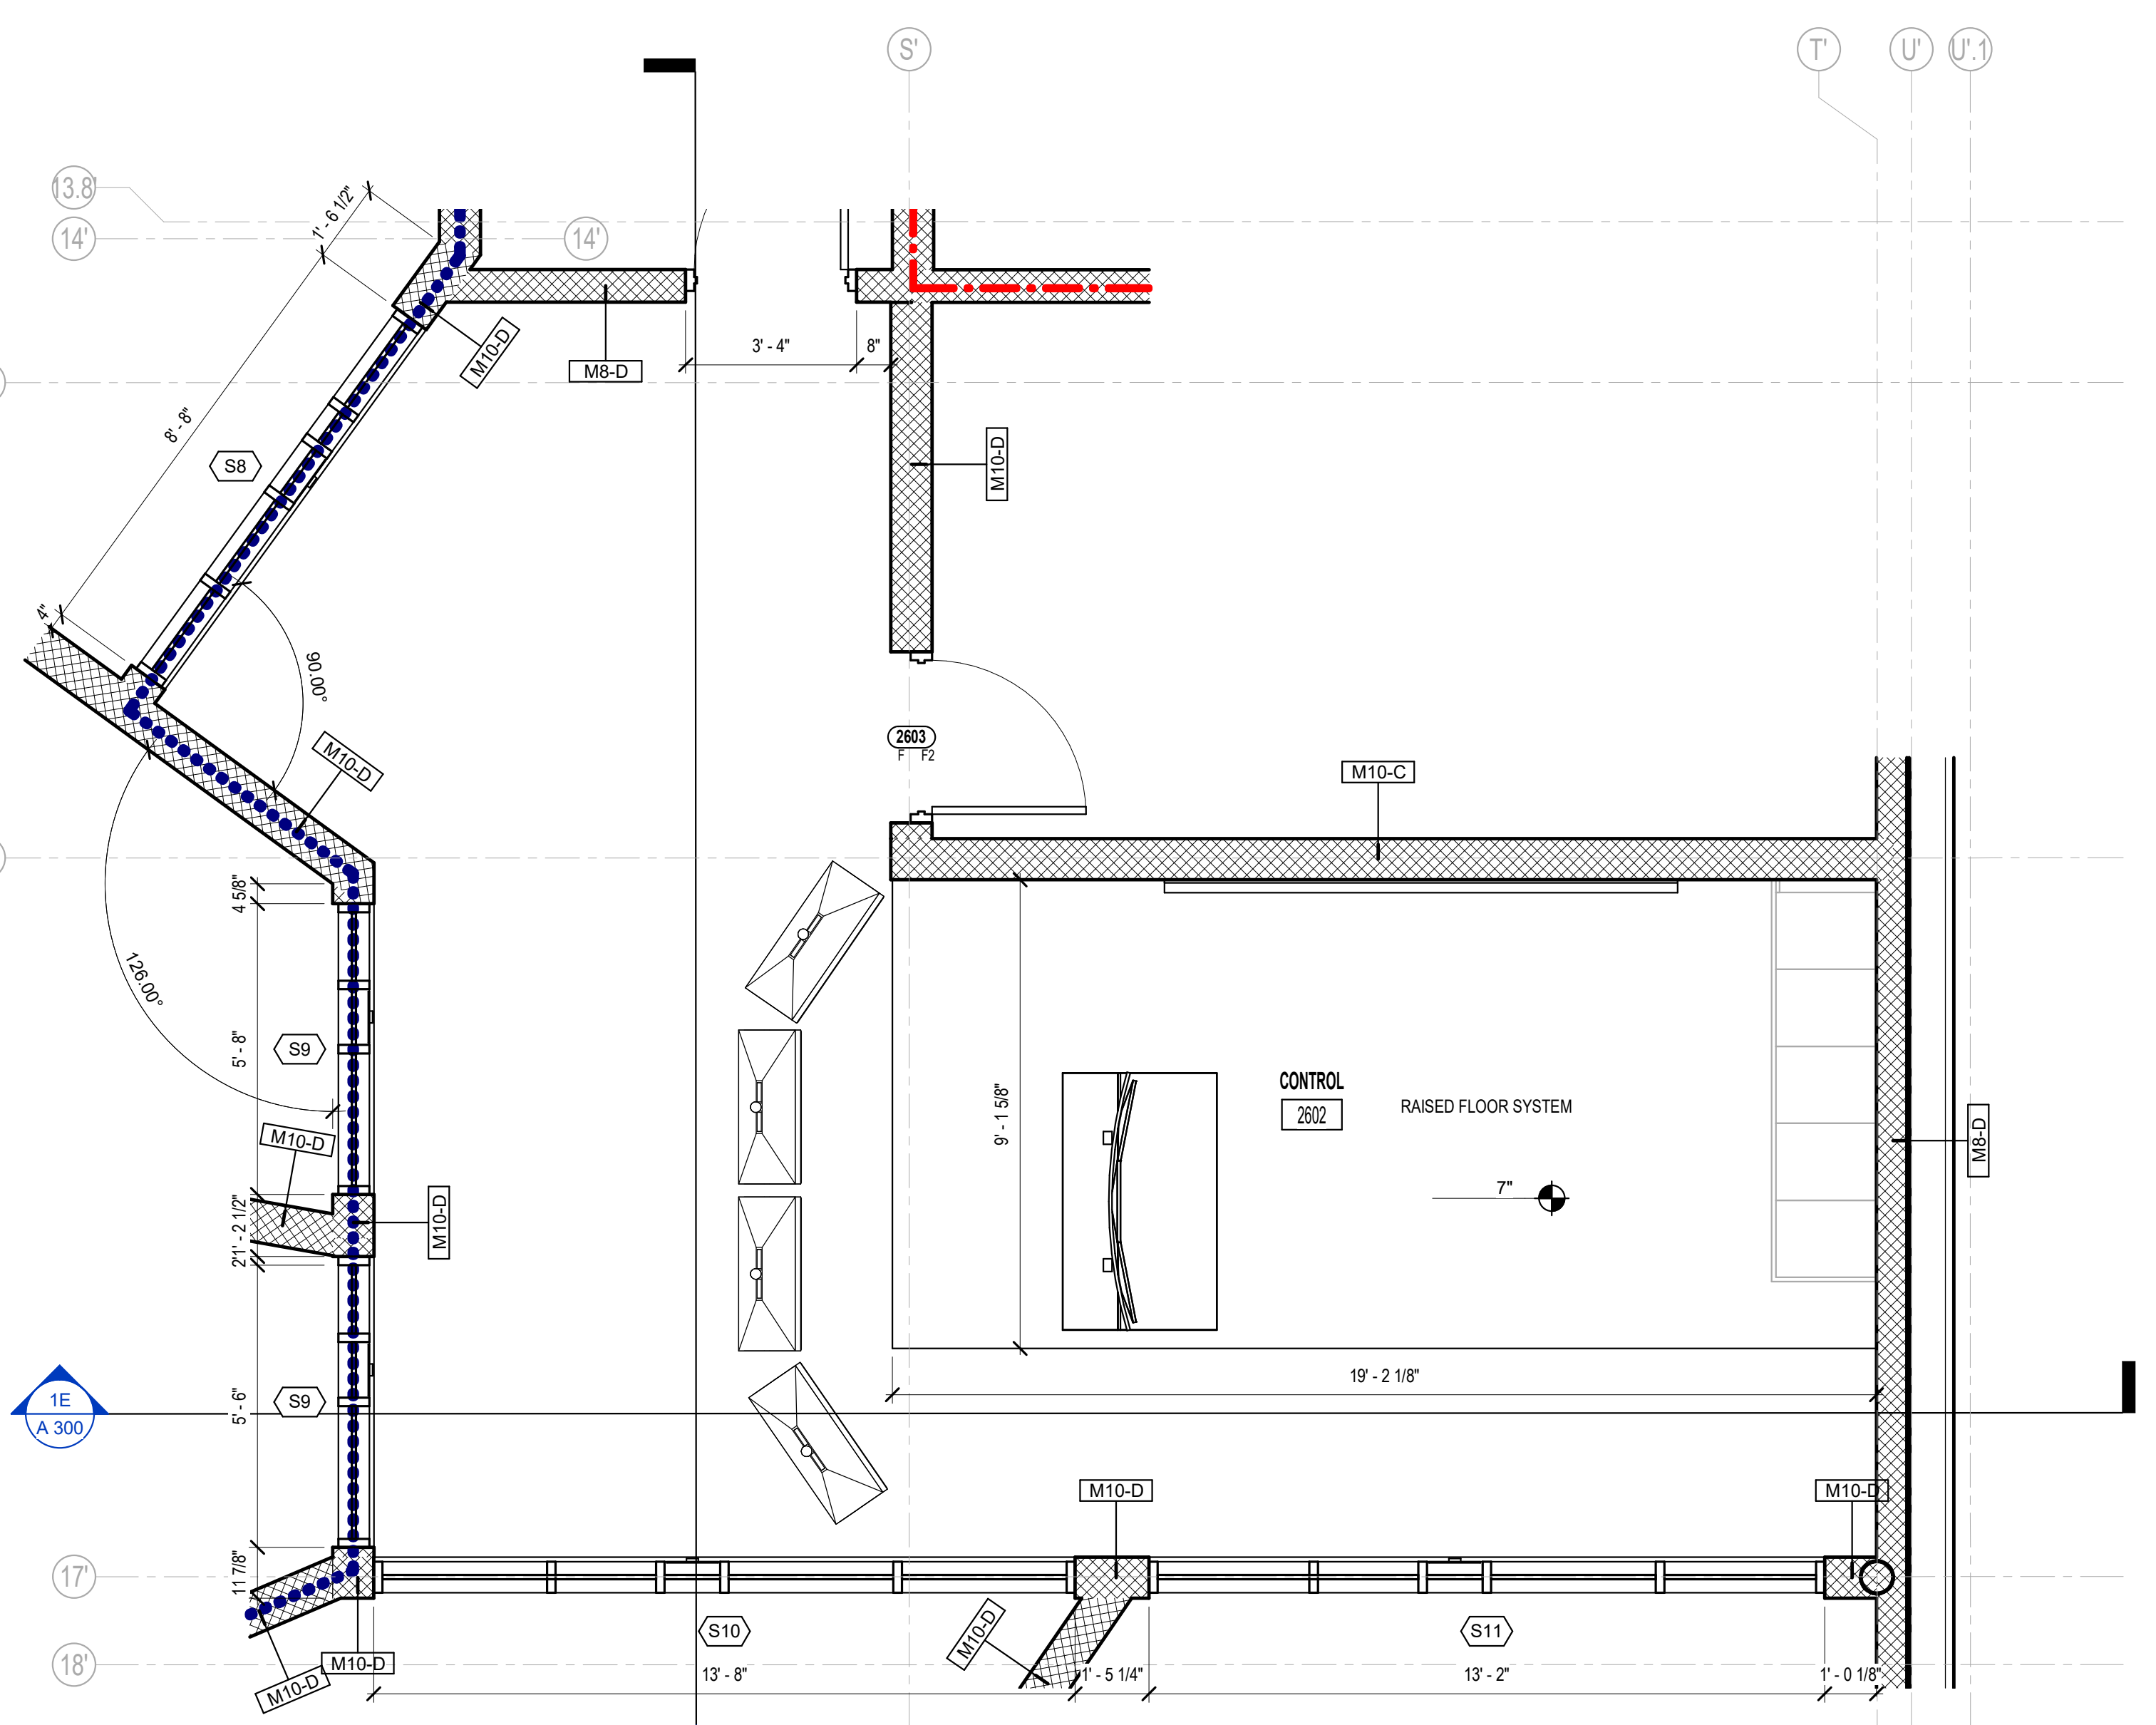
ENLARGED CONTROL ROOM PLANS AND DETAILS

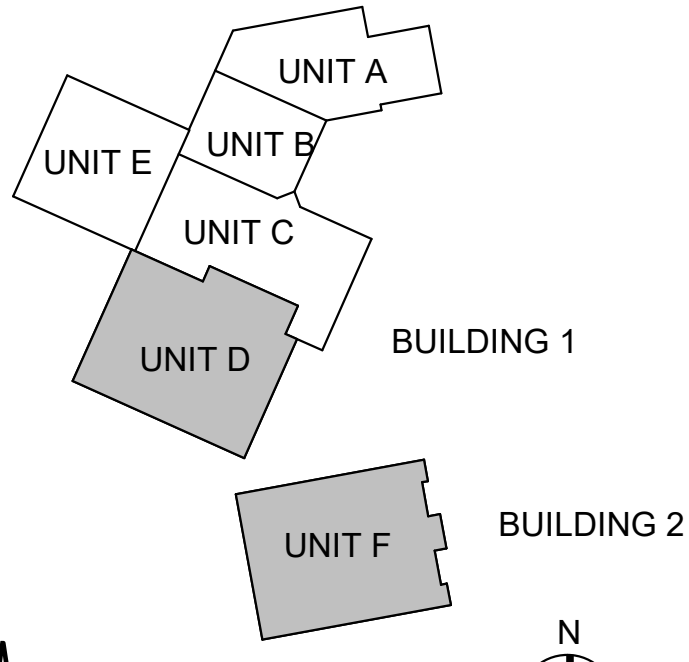

1C UNIT F - 151 CONTROL ROOM  
3/8" = 1'-0"



1A UNIT D - 2602 CONTROL ROOM - ALTERNATE  
3/8" = 1'-0"

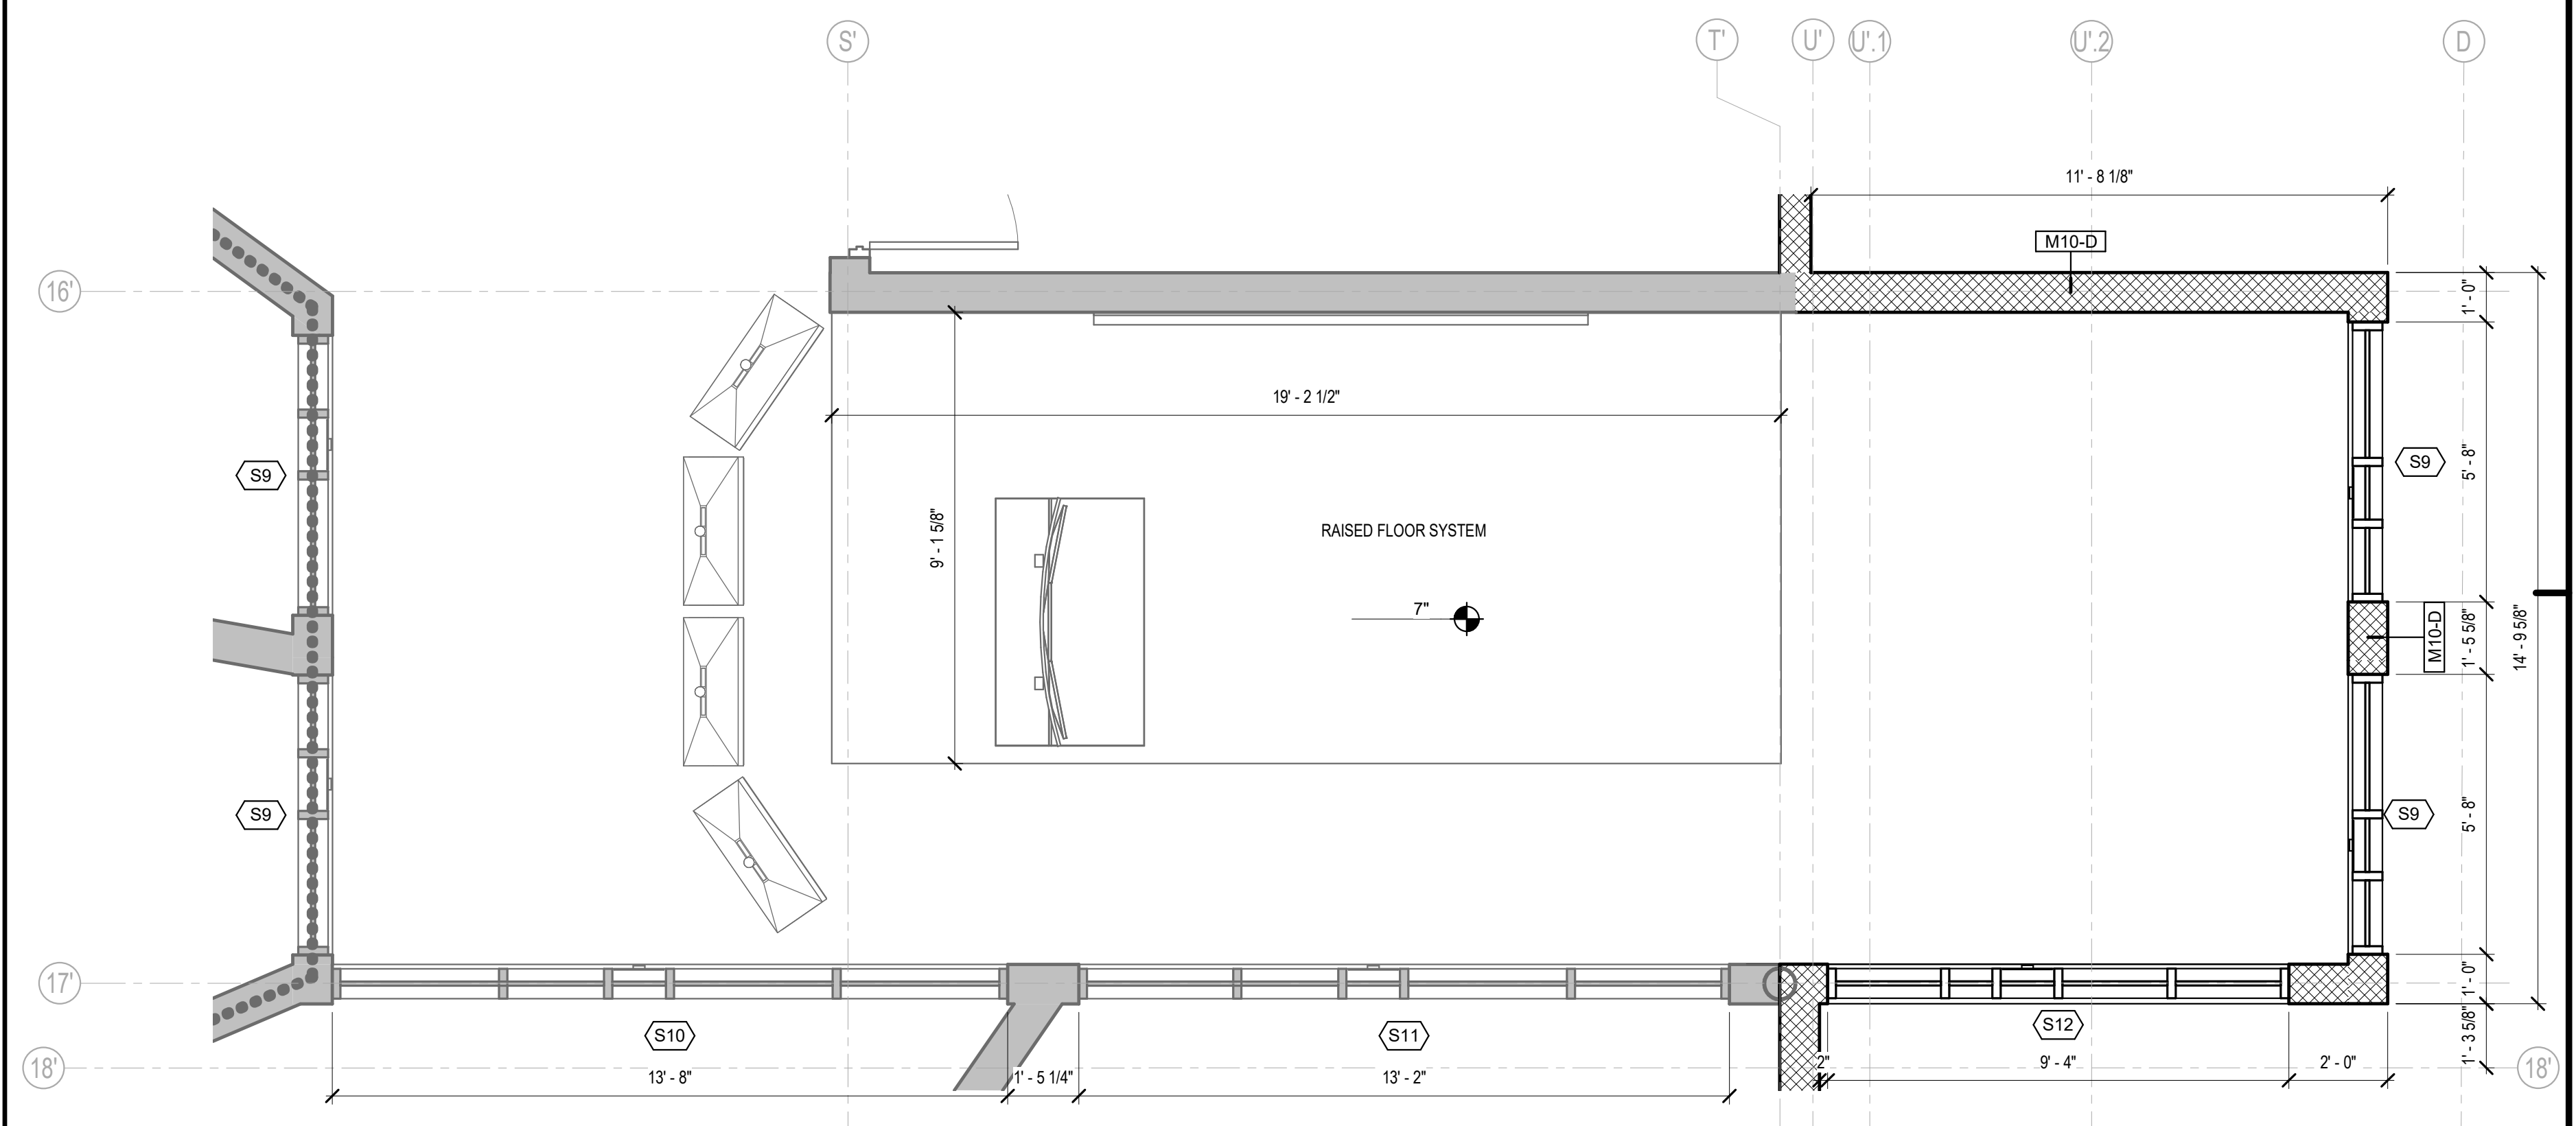


4A UNIT D - 2602 CONTROL ROOM  
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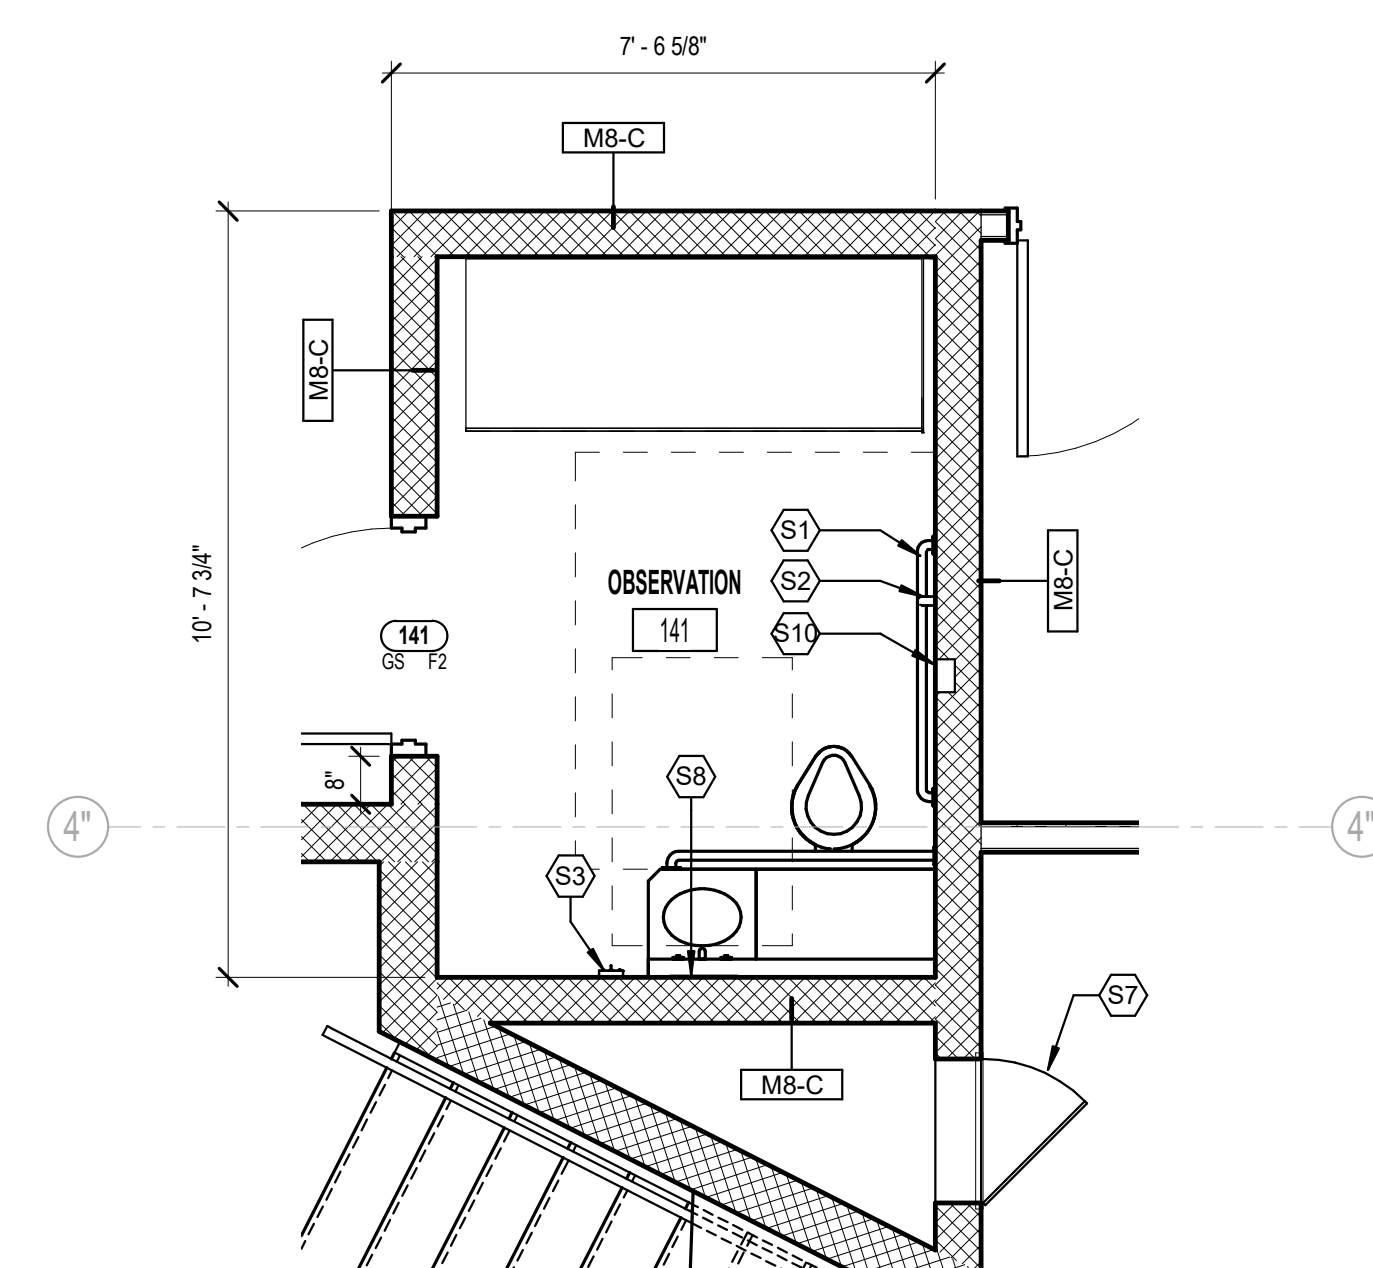


5.4.401 - RESTROOM ACCESSORY SCHEDULE					
Type Mark	Keynote	Description	Mounting	Furnished By	Installed By
A1	10 28 00	GRAB BAR - 18" VERTICAL	BOTTOM @ 40" AFF	CONTRACTOR	CONTRACTOR
A2	10 28 00	GRAB BAR - 36" HORIZONTAL	TOP @ 2-11" AFF	CONTRACTOR	CONTRACTOR
A3	10 28 00	GRAB BAR - 42" HORIZONTAL	TOP @ 2-11" AFF	CONTRACTOR	CONTRACTOR
A4	10 28 00	MIRROR - 24" X 36"	BOTTOM @ 4" ABOVE FIXTURE	CONTRACTOR	CONTRACTOR
A5	10 28 00	TOILET TISSUE DISPENSER - DOUBLE	BOTTOM @ 1-6 AFF	CONTRACTOR	CONTRACTOR
A6	10 28 00	SANITARY NAPKIN DISPOSAL - SURFACE	TOP @ 30" AFF	CONTRACTOR	CONTRACTOR
A7	10 28 00	SOAP DISPENSER	BOTTOM @ 4" ABOVE FIXTURE	CONTRACTOR	CONTRACTOR
A8	10 28 00	SANITARY NAPKIN DISPOSAL - SURFACE	TOP @ 30" AFF	CONTRACTOR	CONTRACTOR
A9	08 31 13	ACCESS DOOR - 16" X 16"	BOTTOM @ 40" AFF	CONTRACTOR	CONTRACTOR
A10	10 28 00	HAND DRYER - SLIM	BOTTOM @ 42" AFF	CONTRACTOR	CONTRACTOR
A11	10 21 13	TOILET PARTITION	BOTTOM @ 12" AFF	CONTRACTOR	CONTRACTOR
S1	11 19 10	SECURITY GRAB BAR - 42" HORIZONTAL, LIGATURE PROOF	TOP @ 2-11" AFF	CONTRACTOR	CONTRACTOR
S2	11 19 10	ADA SECURIT GRAB BAR - 18" VERTICAL, LIGATURE PROOF	BOTTOM @ 40" AFF	CONTRACTOR	CONTRACTOR
S3	11 19 10	SECURITY ROBE HOOKS WITH SUICIDE PREVENTION, LIGATURE PROOF	CENTER @ 4-6" AFF	CONTRACTOR	CONTRACTOR
S4	11 19 10	SECURITY SHOWER CURTAIN ROD	MOUNTED TO SOFFIT OF SHOWER UNIT	CONTRACTOR	CONTRACTOR
S5	11 19 10	ADA LOOSE FURNITURE SHOWER SEAT, BY OWNER	TOP @ 1-6" AFF	OWNER	OWNER
S6	11 19 10	ADA SECURITY SHOWER GRAB BAR - 46" HORIZONTAL	TOP @ 2-11" AFF	CONTRACTOR	CONTRACTOR
S7	11 19 10	SECURITY ACCESS DOOR - 24" X 32"	TOP @ 2-11" AFF	CONTRACTOR	CONTRACTOR
S8	11 19 10	ADA DOUBLE SECURITY MIRROR, STAINLESS STEEL	BOTTOM @ 40" AFF	CONTRACTOR	CONTRACTOR
S9	11 19 10	SECURITY MIRROR, STAINLESS STEEL		CONTRACTOR	CONTRACTOR
S10	11 19 10	SECURITY TYPE FULLY RECESSED TOILET PAPER HOLDER		CONTRACTOR	CONTRACTOR


NOTE: PROVIDE A 1/4" STAINLESS STEEL FINISH PANEL ABOVE ALL SECURITY SHOWERS, SPANNING VERTICALLY FROM SHOWER TO DECK/STRUCTURE ABOVE, AND HORIZONTALLY FROM STAINLESS STEEL PARTITION TO ADJACENT WALL. SEE TYPICAL DETAILS ON 5AIA-311. COORDINATE WITH MECHANICAL DRAWINGS FOR PERFORATION LOCATIONS.

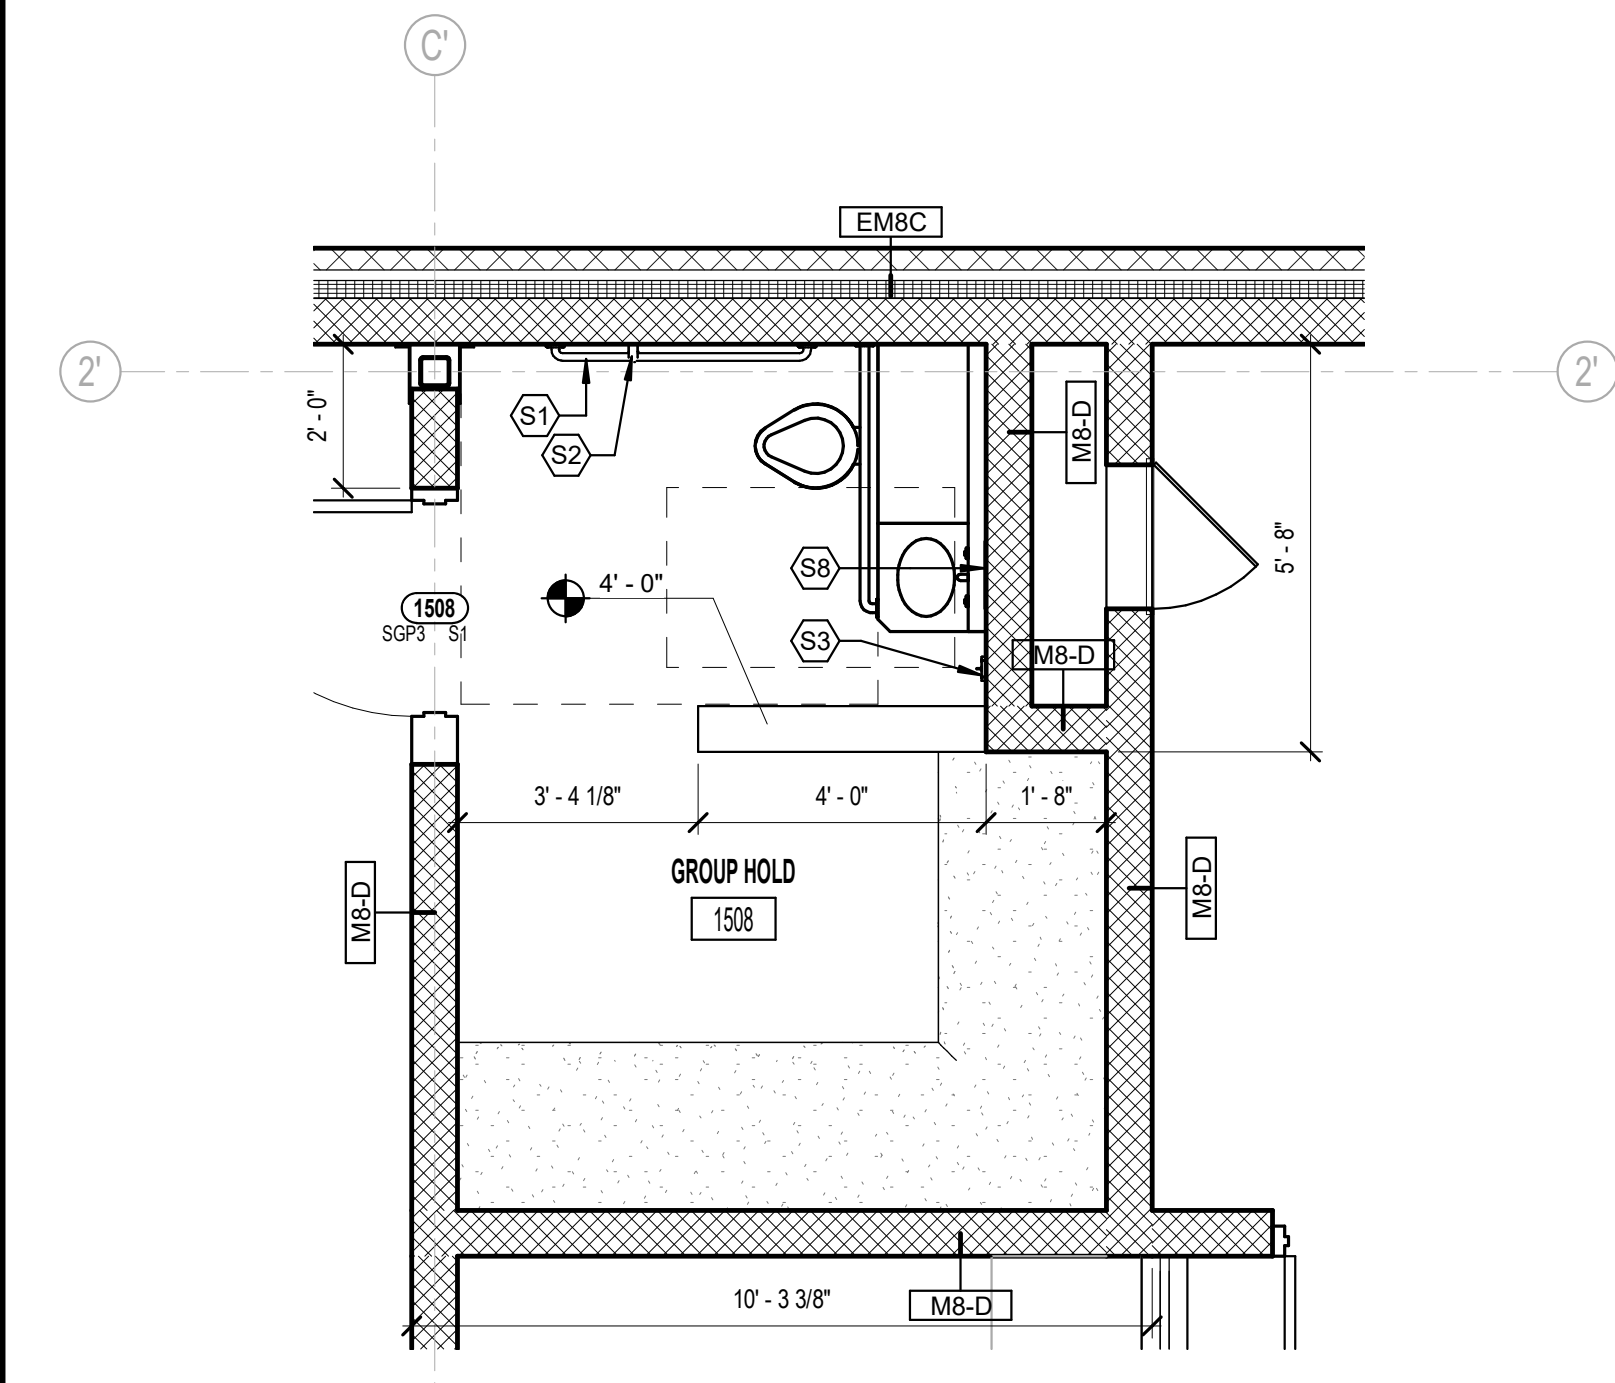


3C UNIT A - 1508 GROUP HOLDING CELL ENLARGED PLAN  
3/8" = 1'-0"




2C UNIT F - 141 OBSERVATION CELL ENLARGED PLAN  
3/8" = 1'-0"

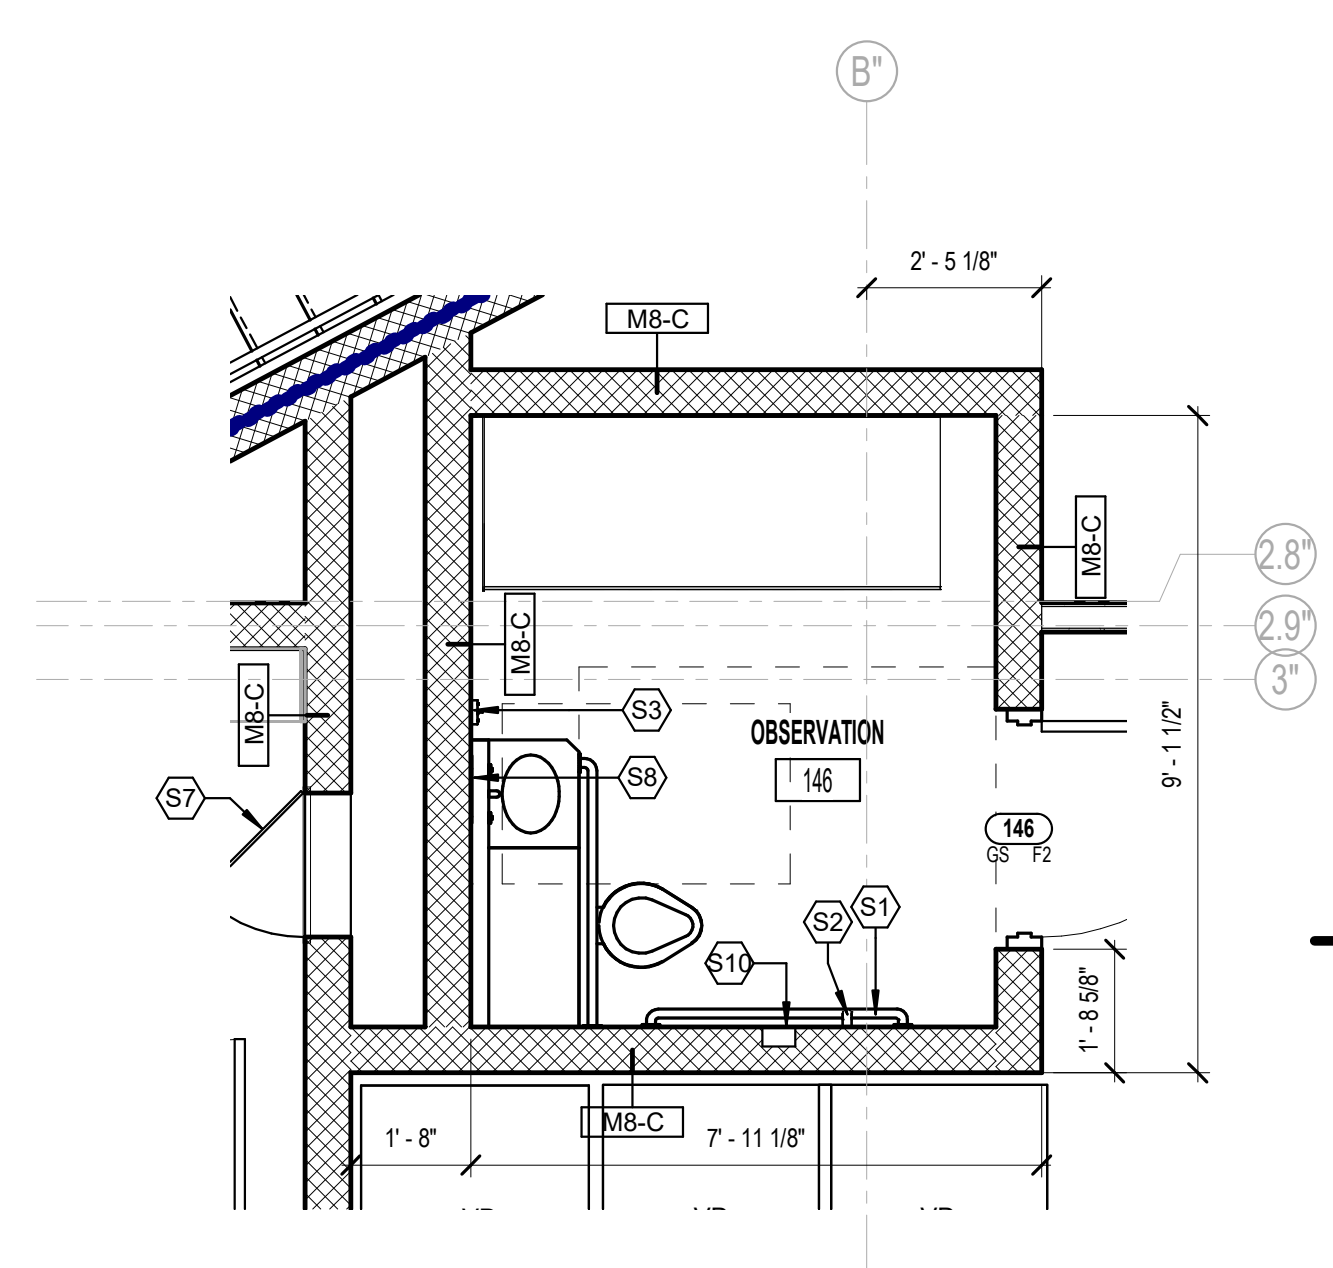

1C UNIT F - 146 OBSERVATION CELL ENLARGED PLAN  
3/8" = 1'-0"

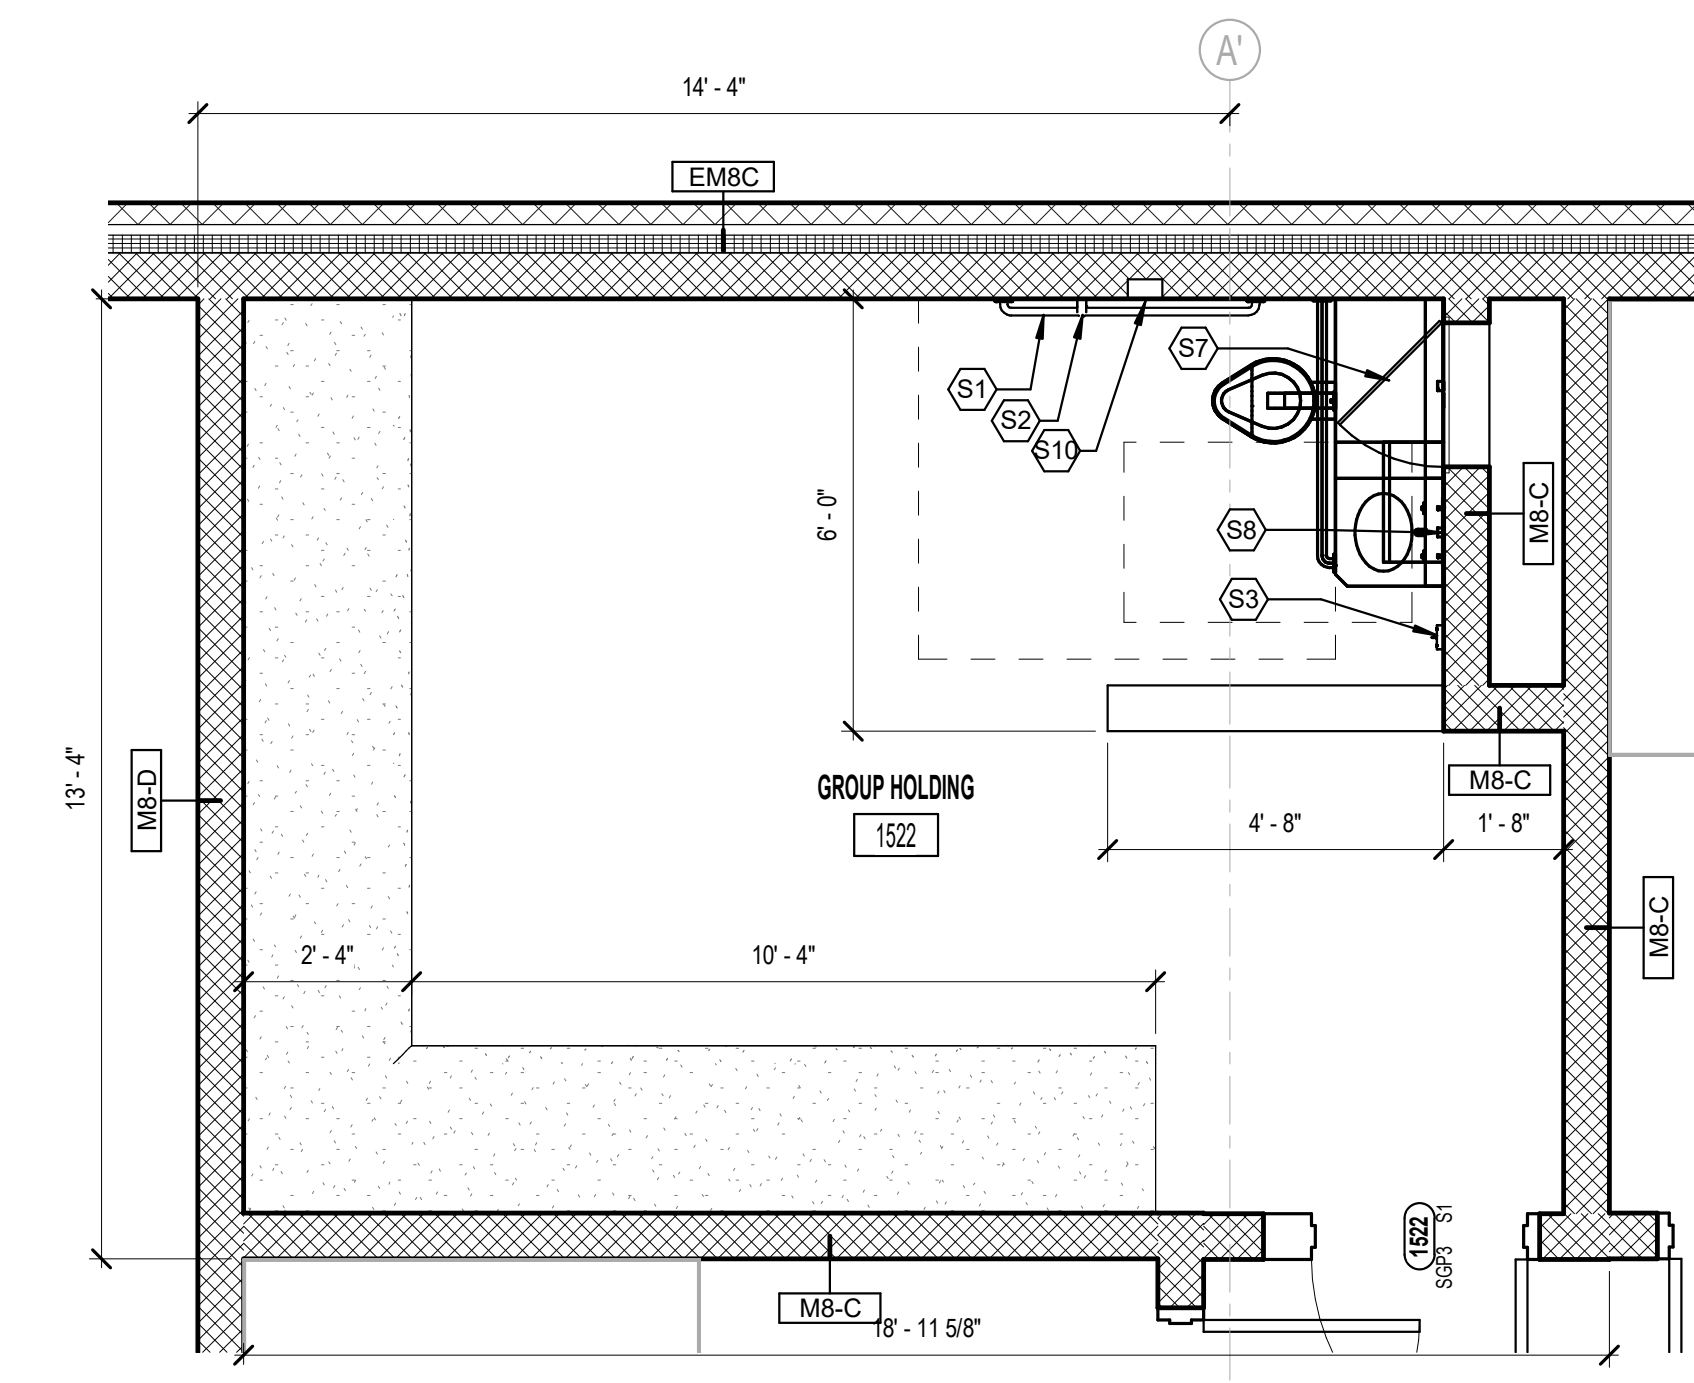

2 UNIT A - 1522 GROUP HOLDING CELL ENLARGED PLAN  
3/8" = 1'-0"

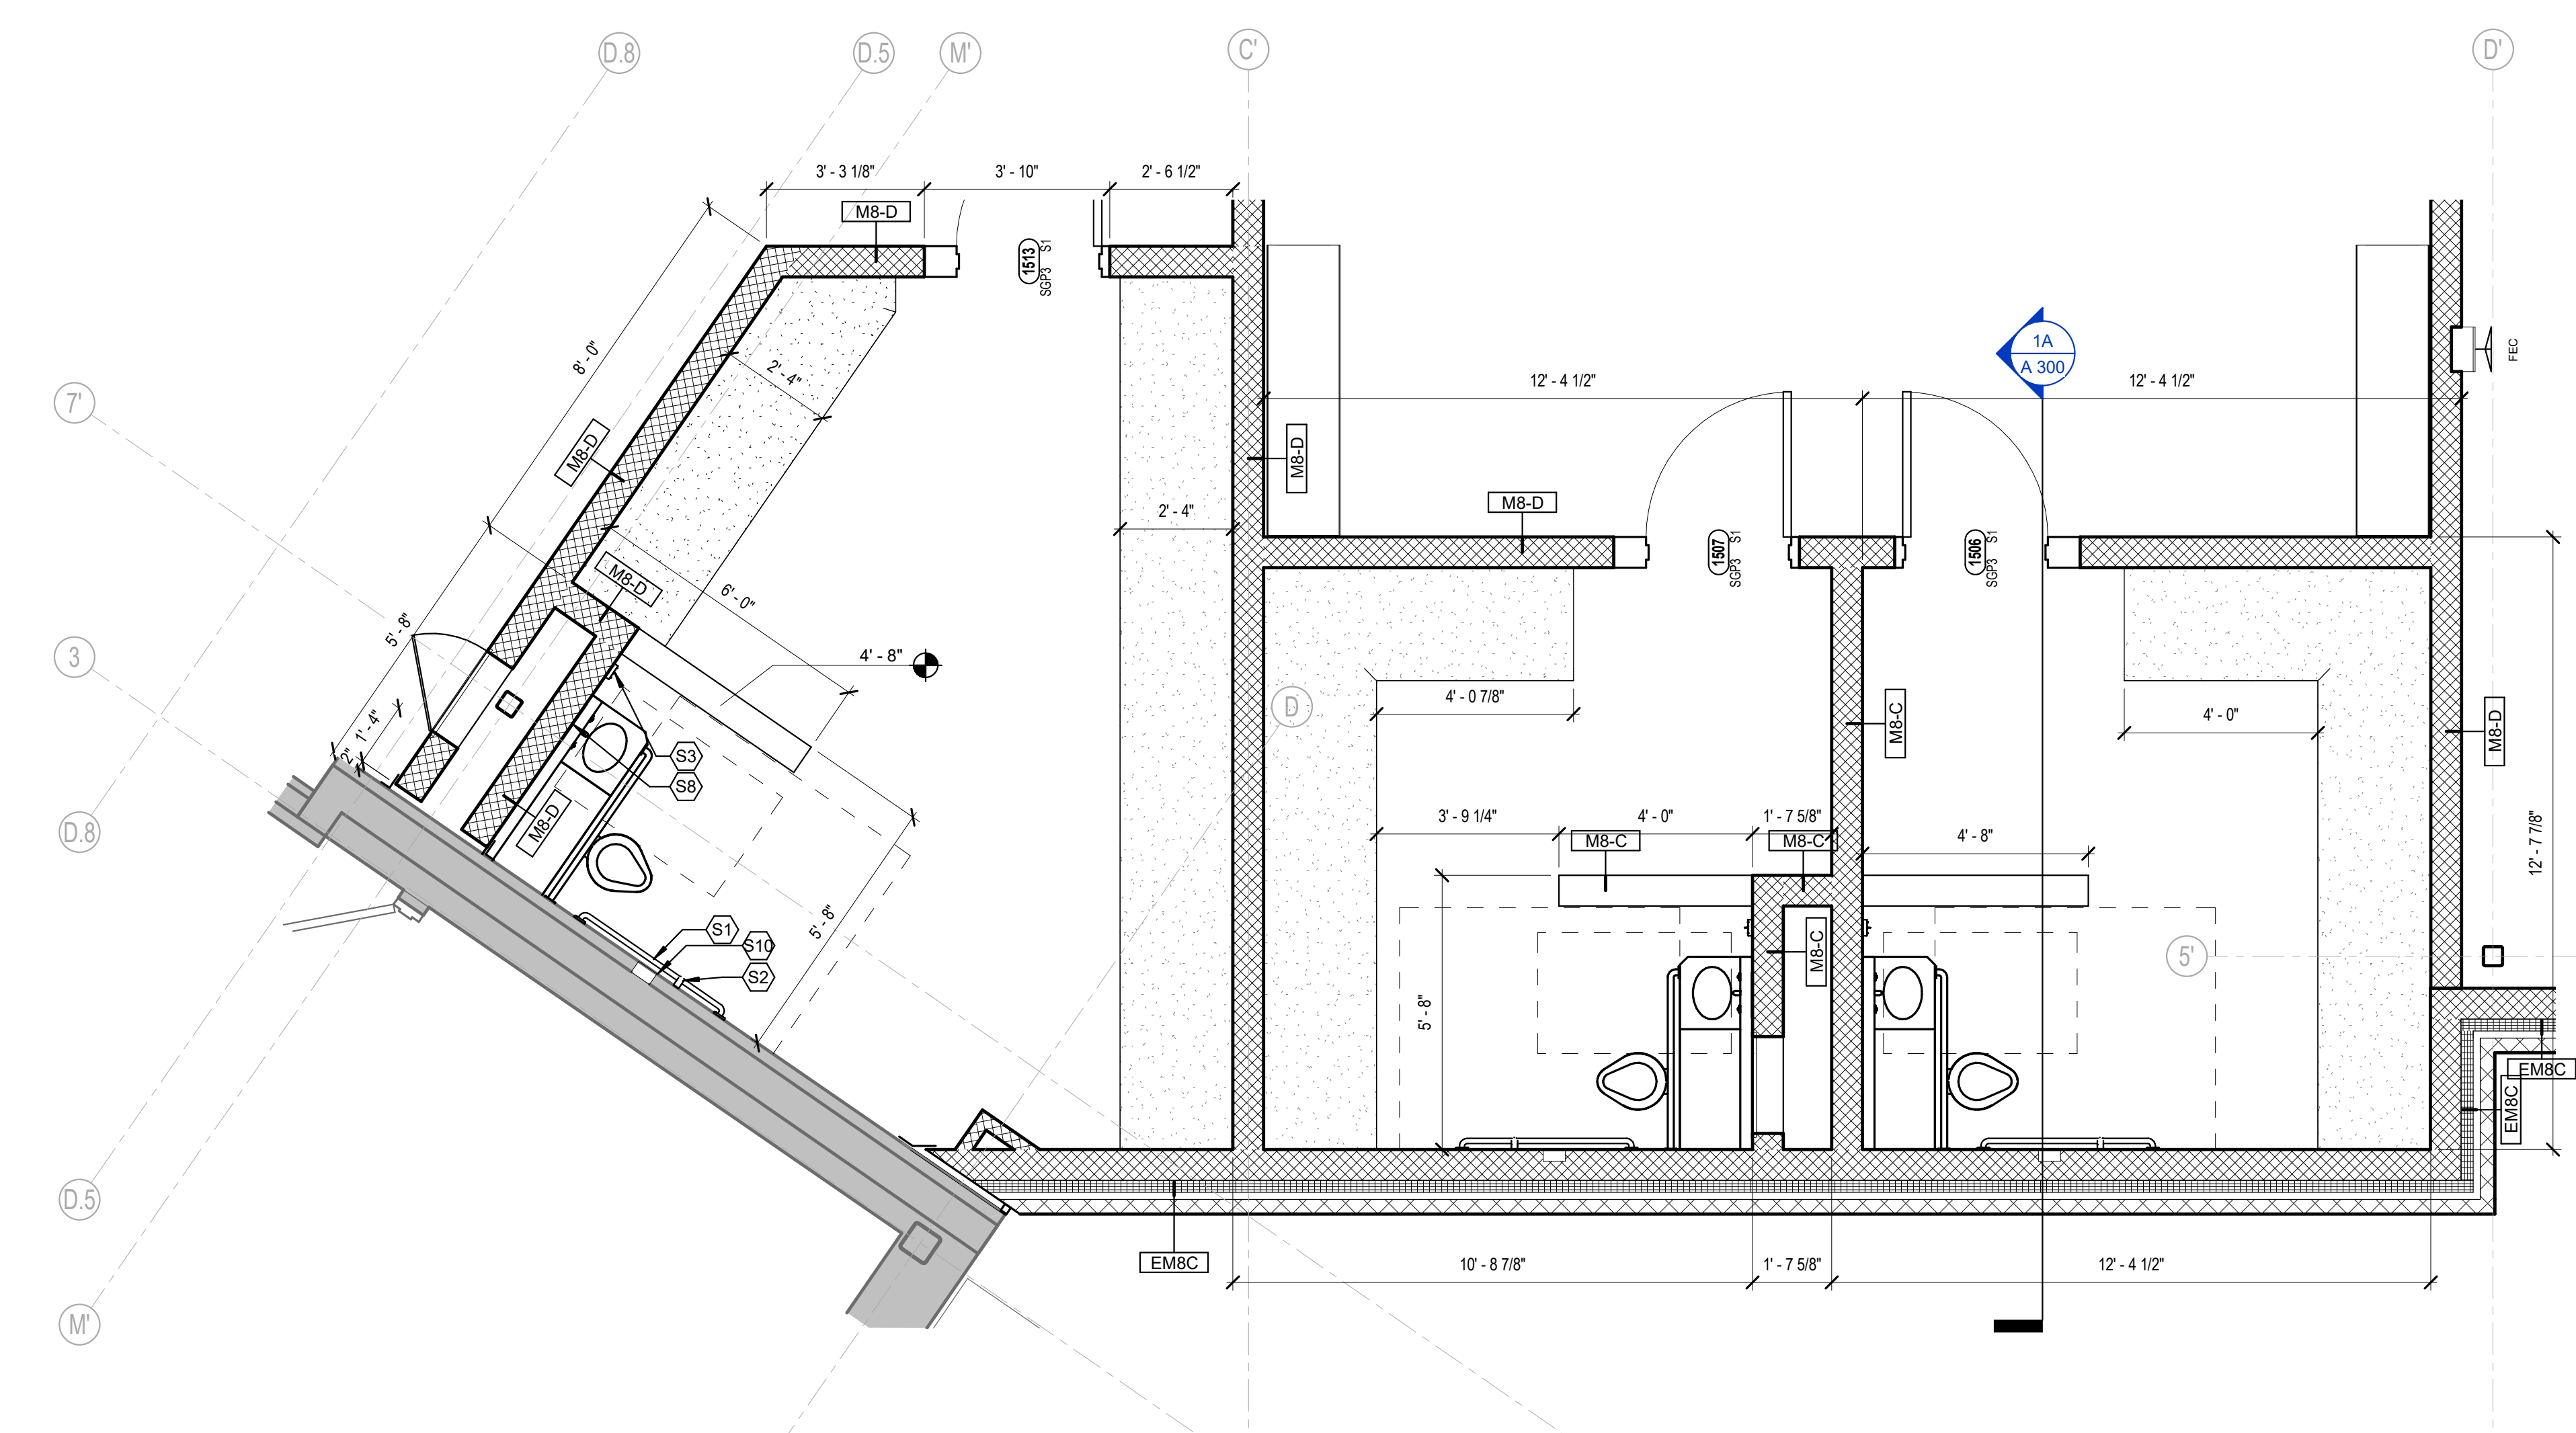

1A HOLDING - ENLARGED PLANS  
3/8" = 1'-0"





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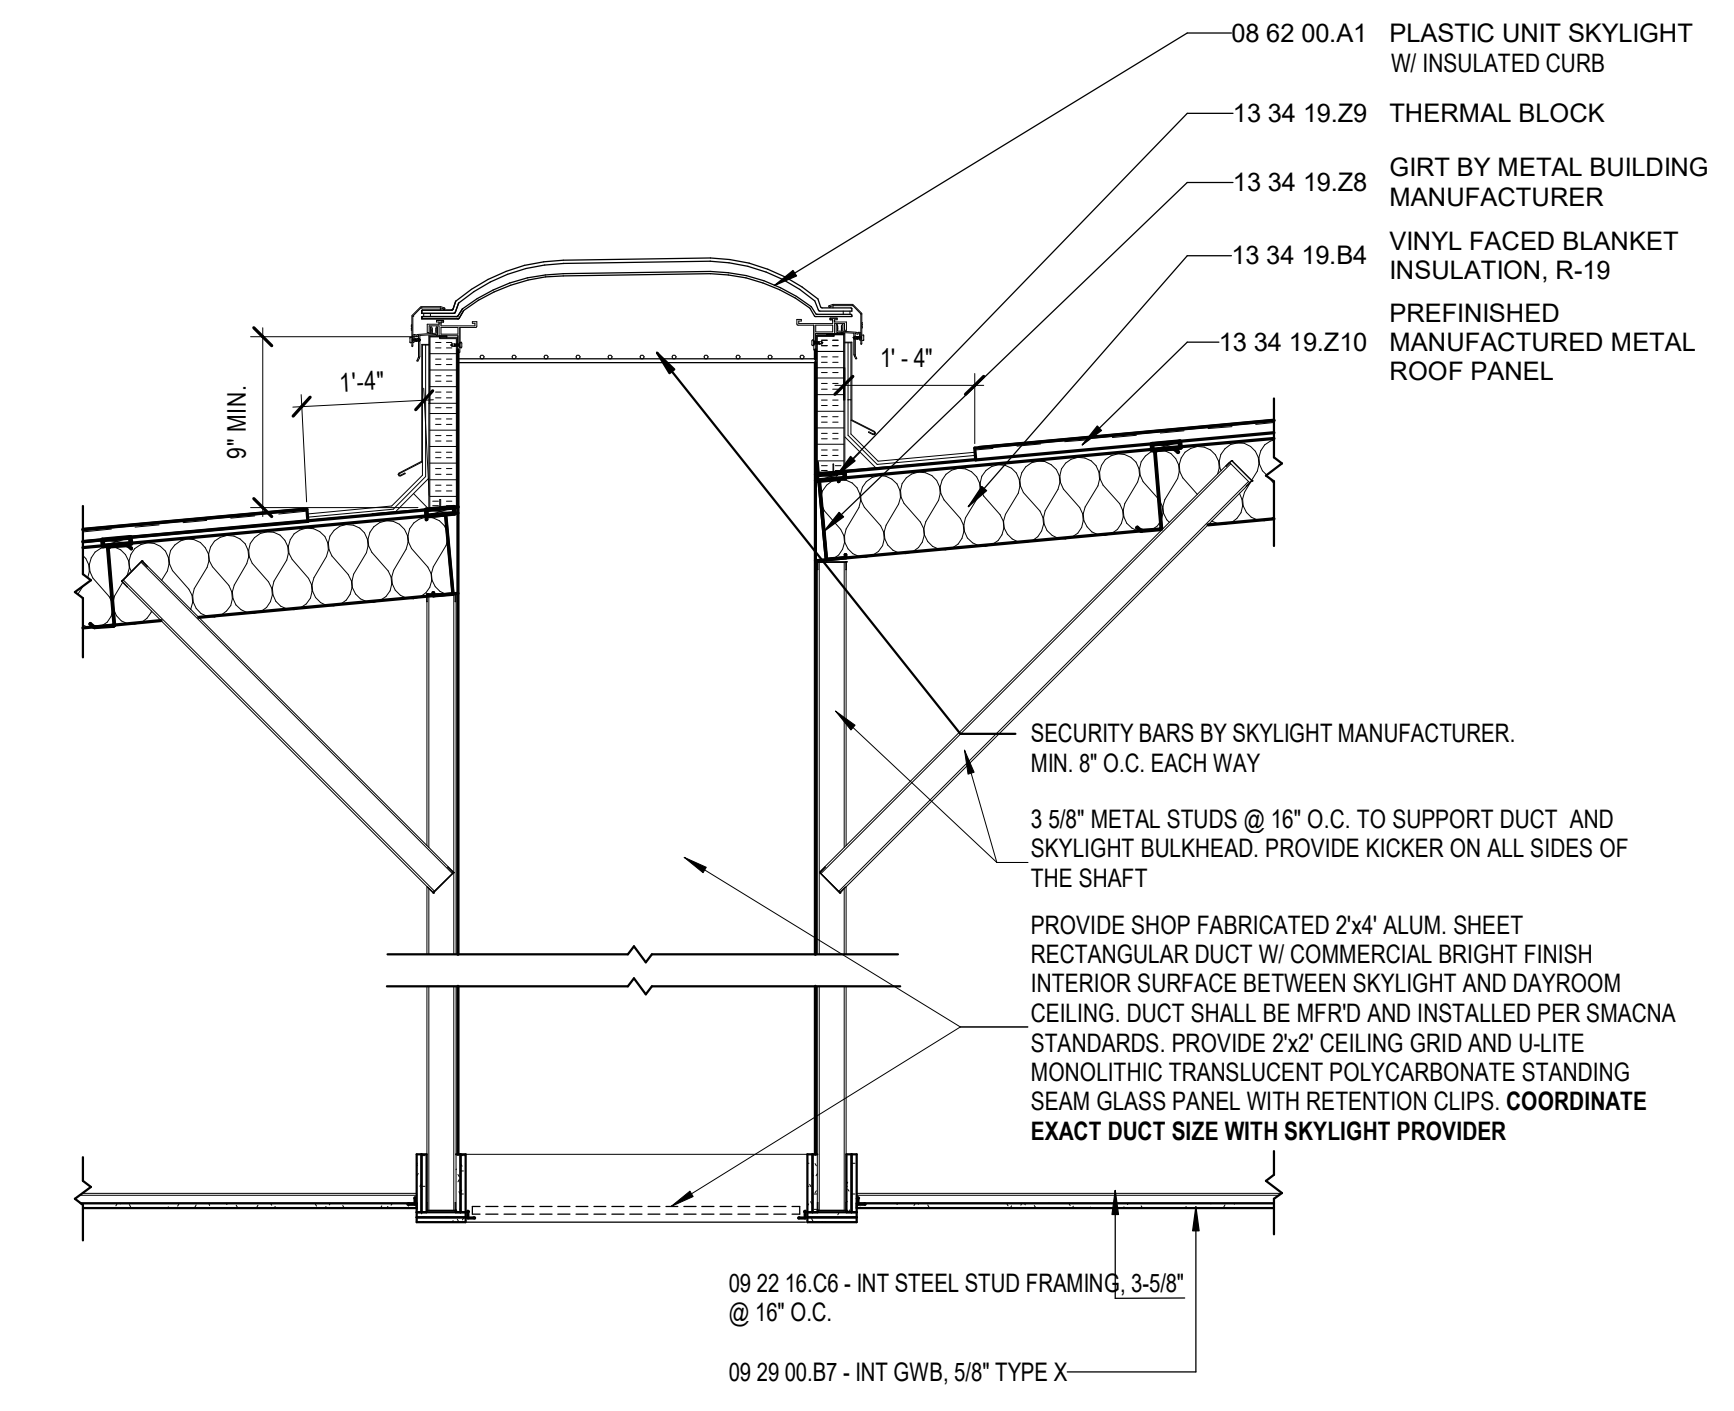
Project #: 20-700-151-2  
Designed By: LD/SP  
Drawn By: CP  
Checked By: LD/EV  
Date: 01.28.2022




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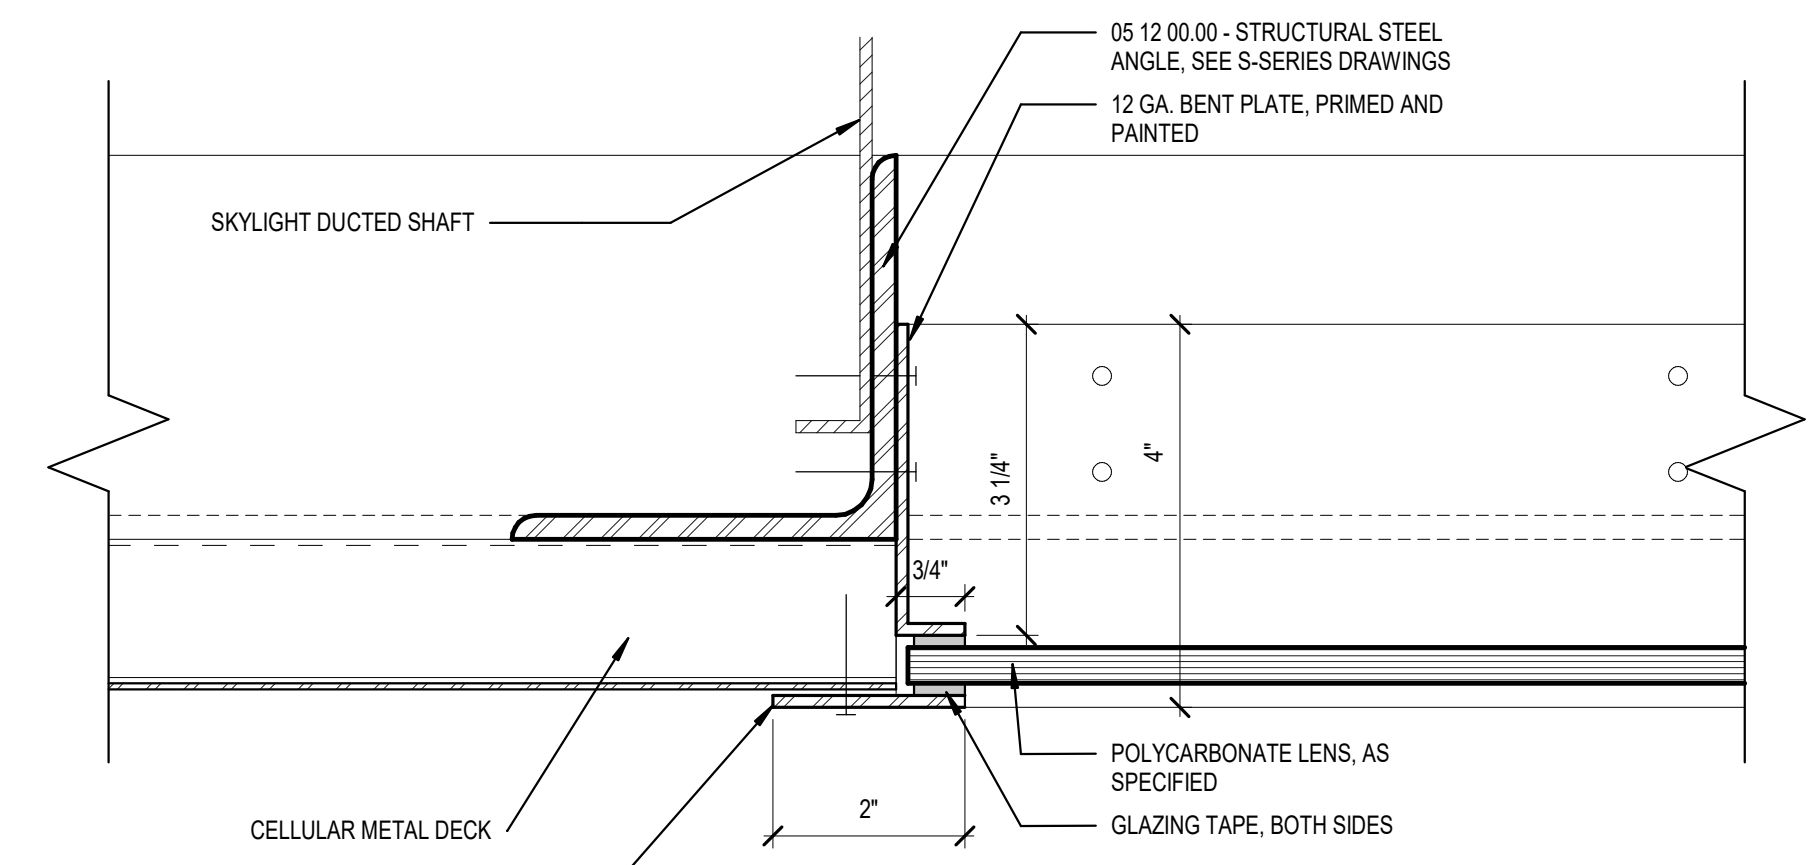
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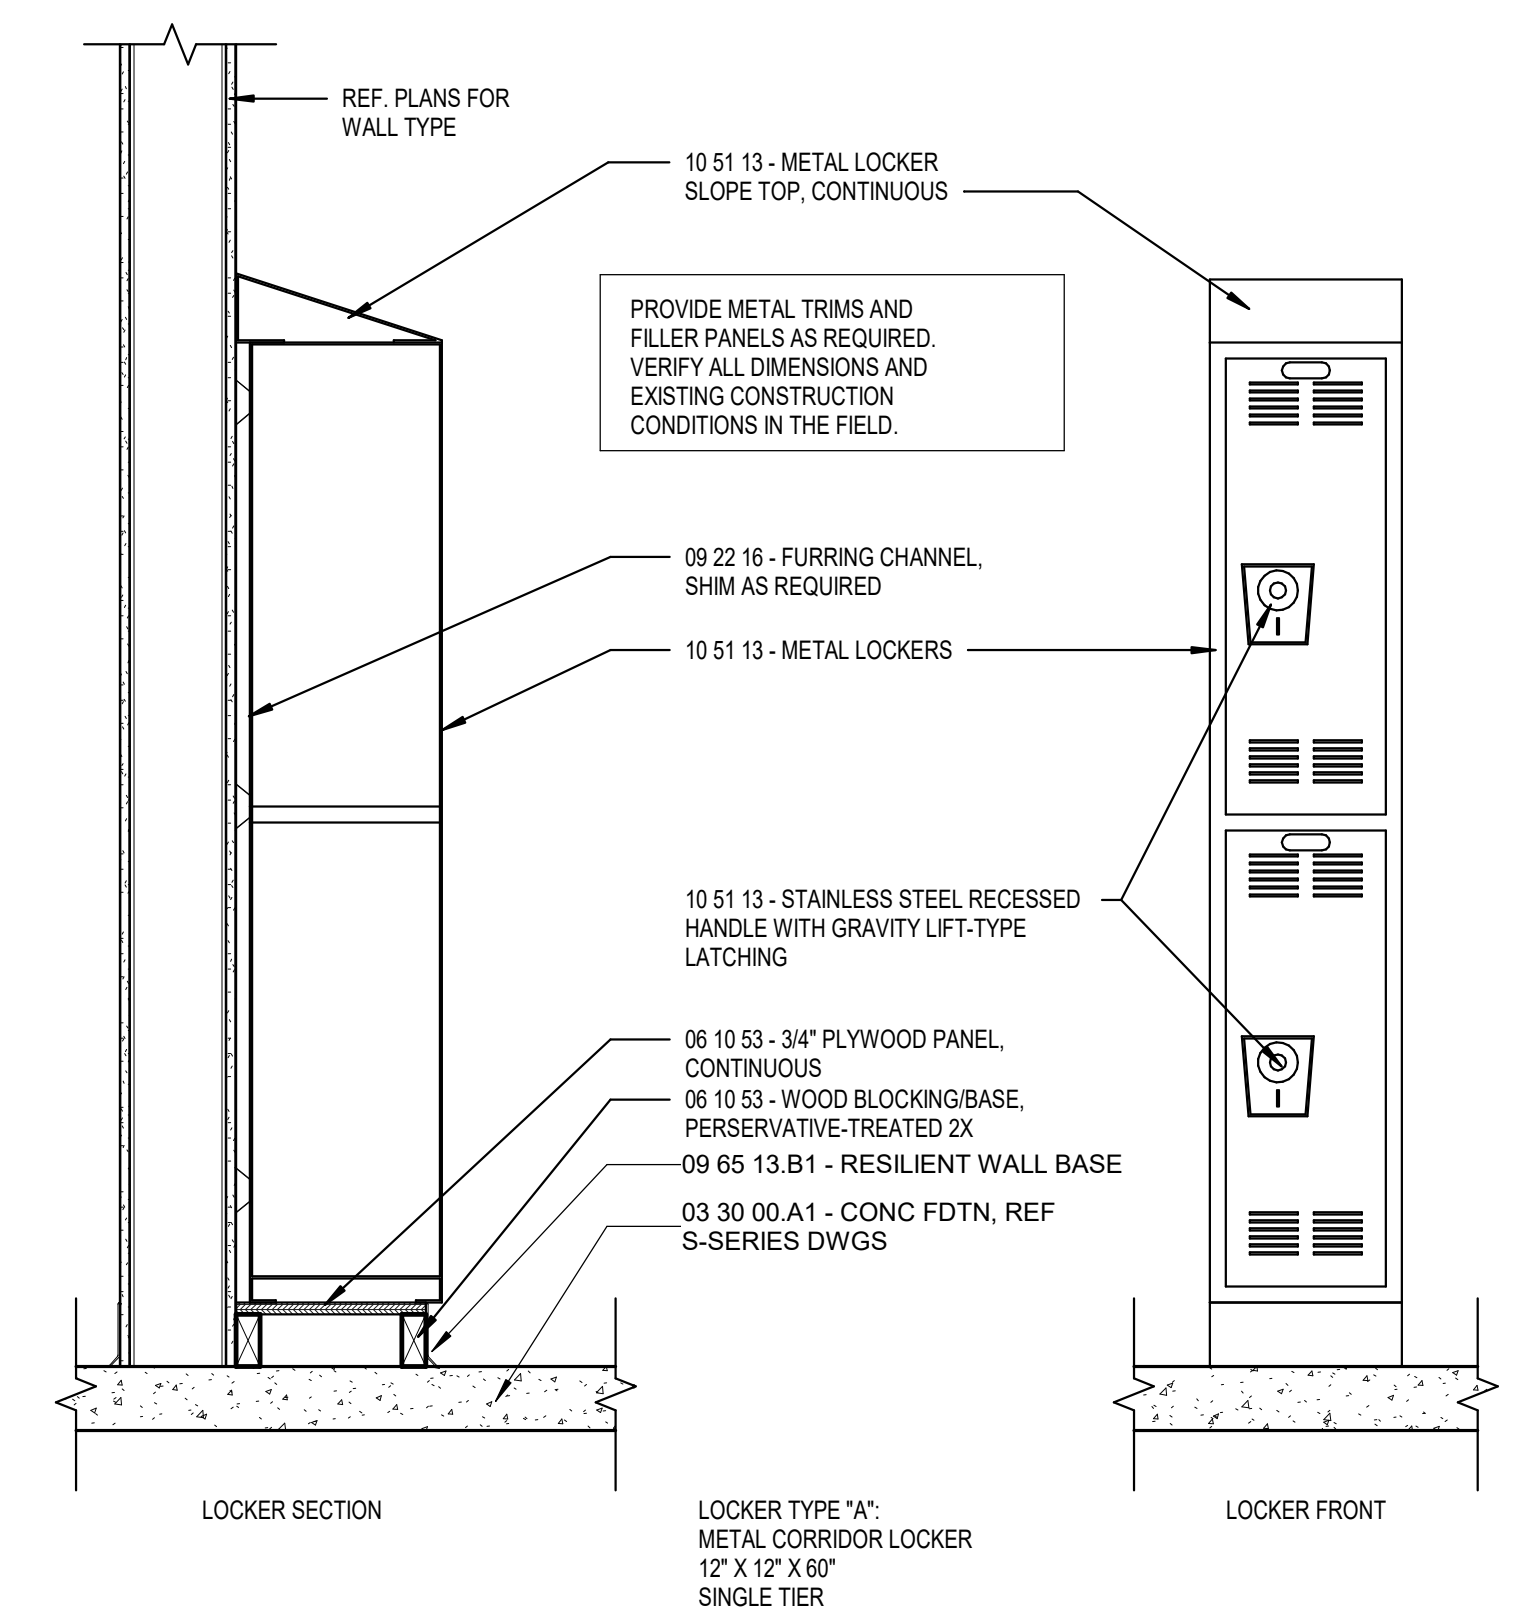
**3D SKYLIGHT AT EXISTING ROOF SECTION**  
1/2" = 1'-0"

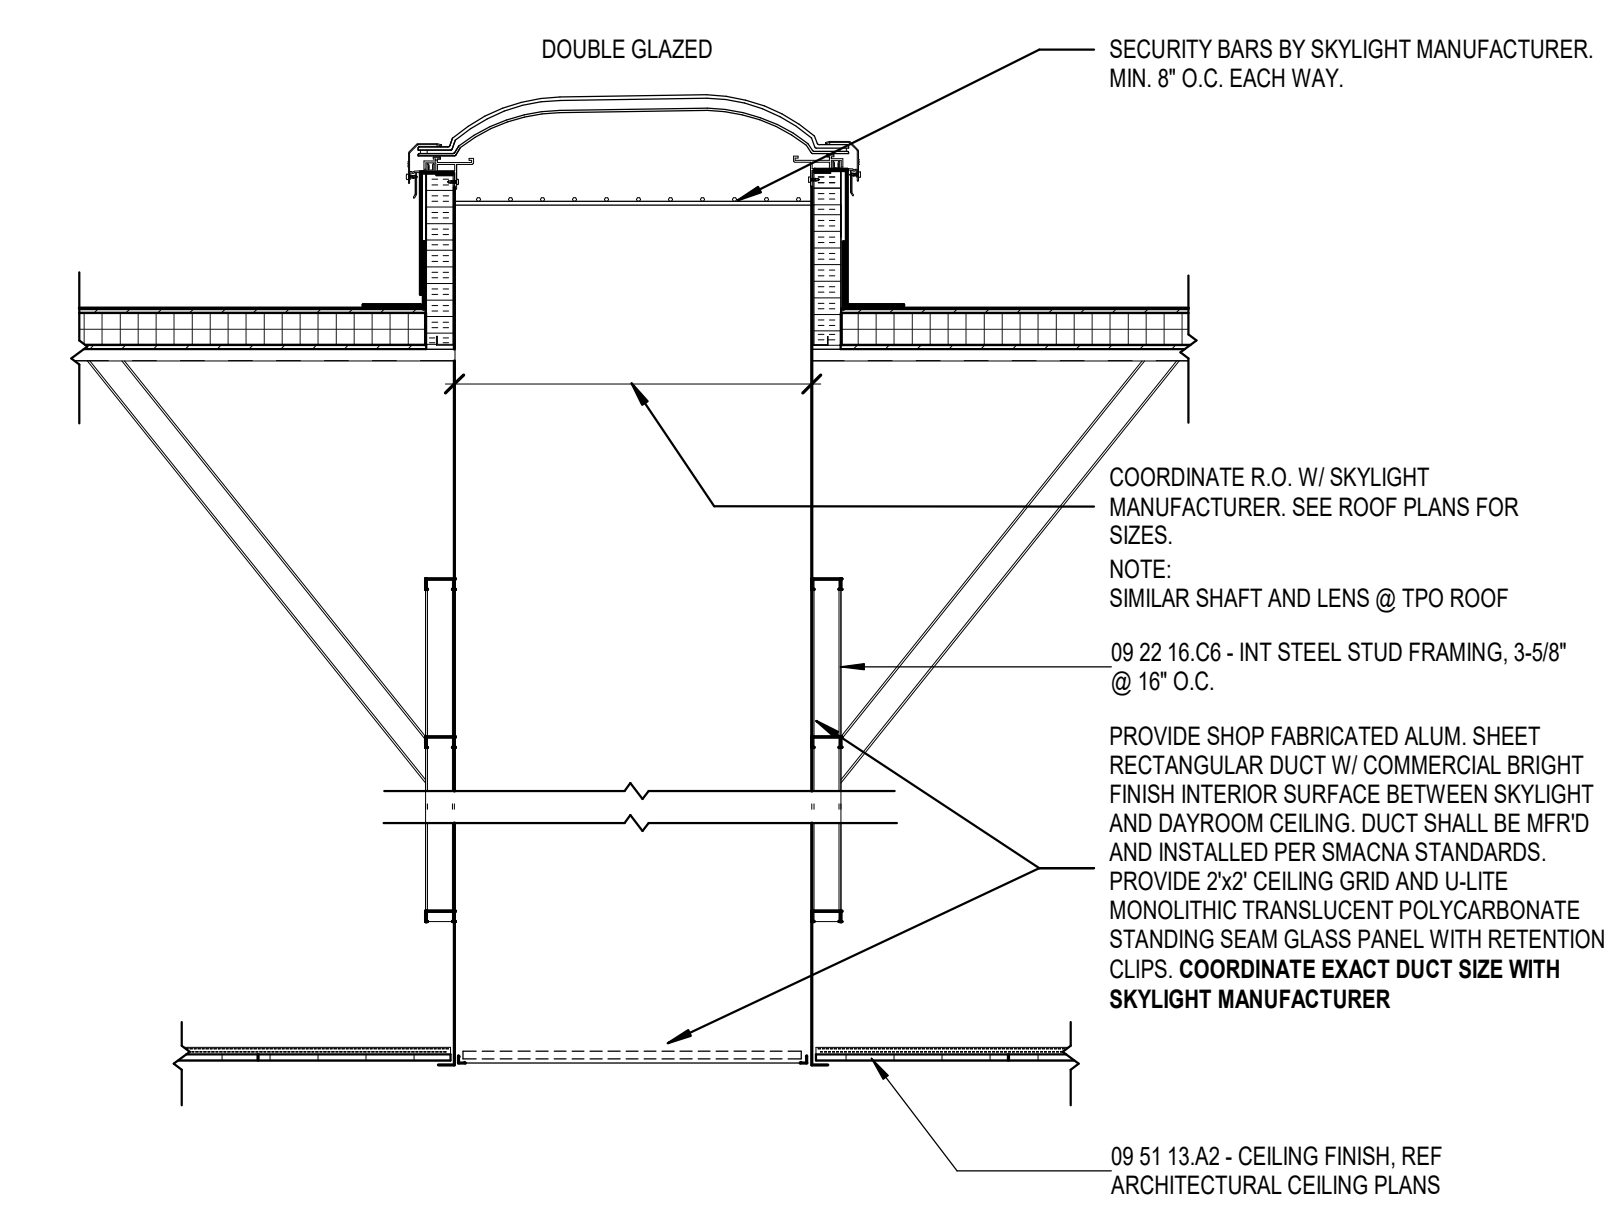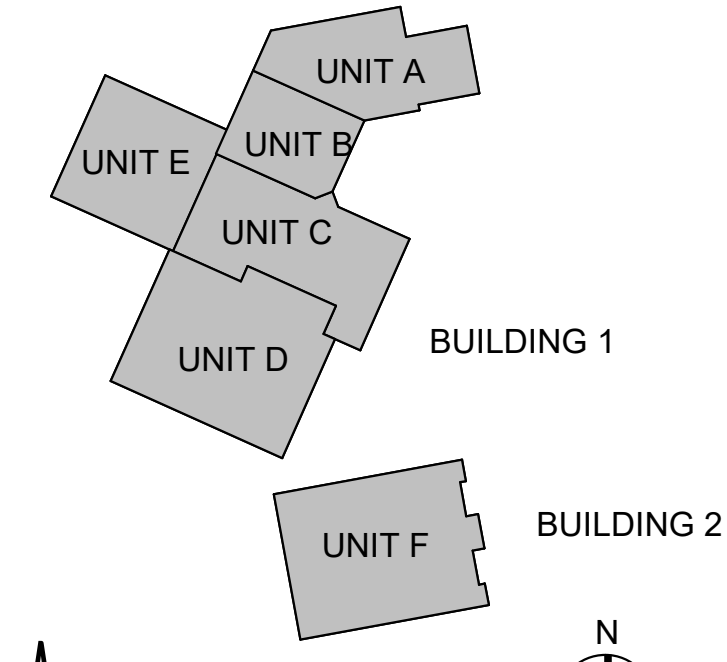


**1C CONCRETE BENCH DETAIL**  
1 1/2" = 1'-0"




**3C SKYLIGHT @ SECURITY CELLULAR DECK CEILING**  
6" = 1'-0"

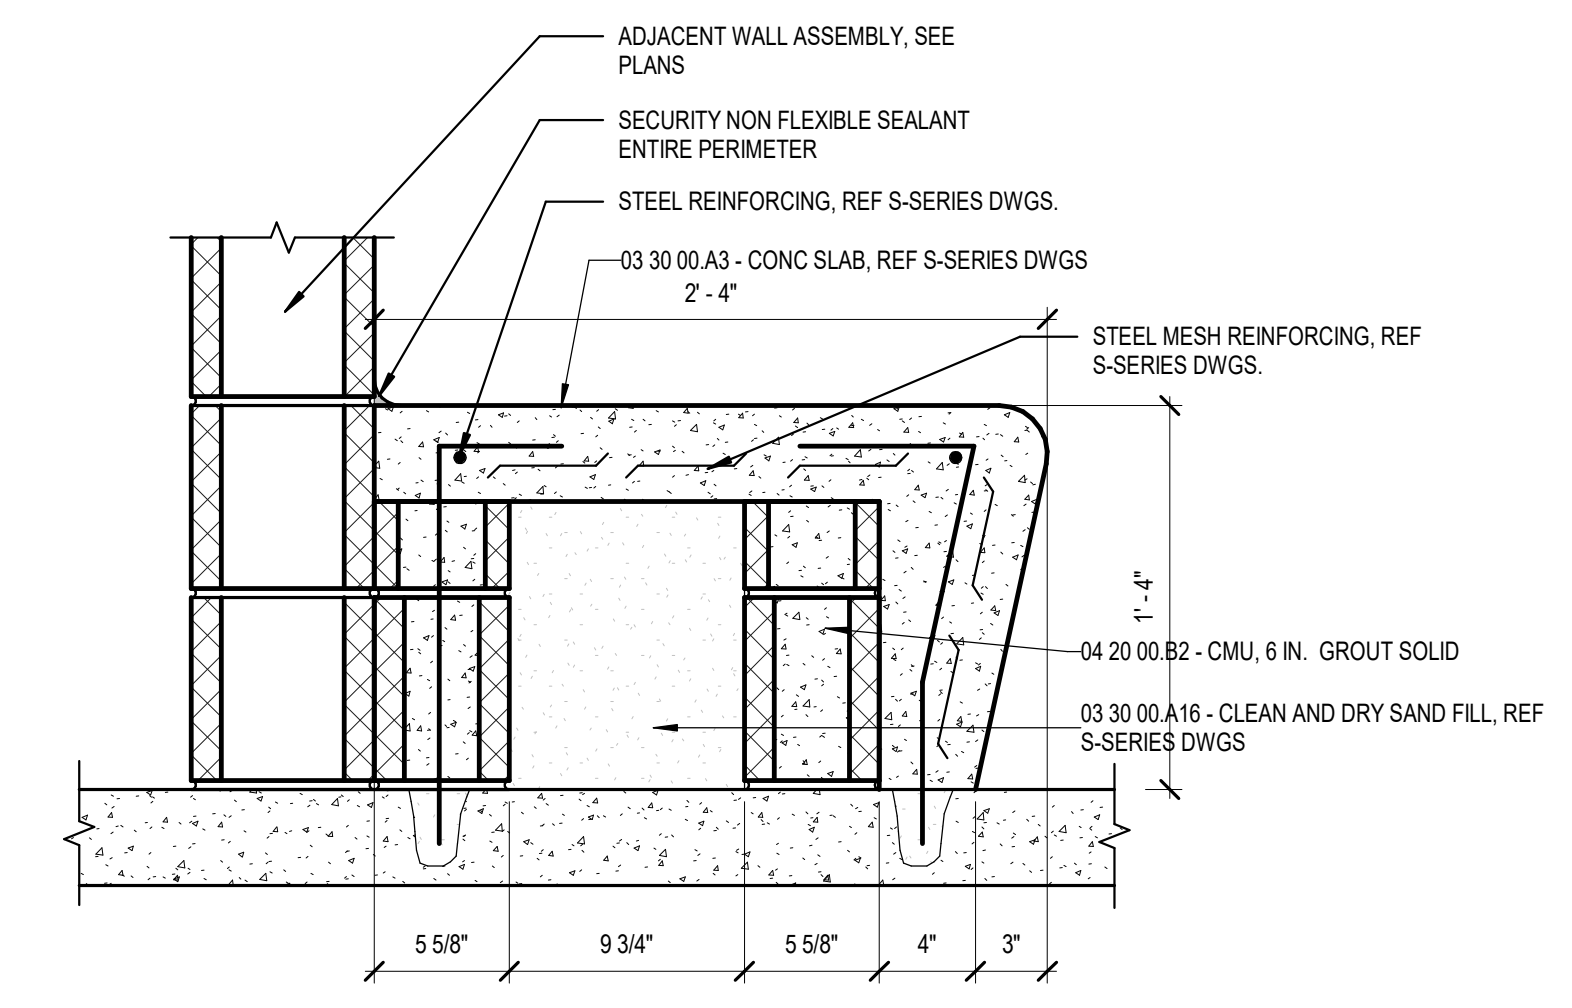


**1A LOCKER TYPE "A"**  
1" = 1'-0"

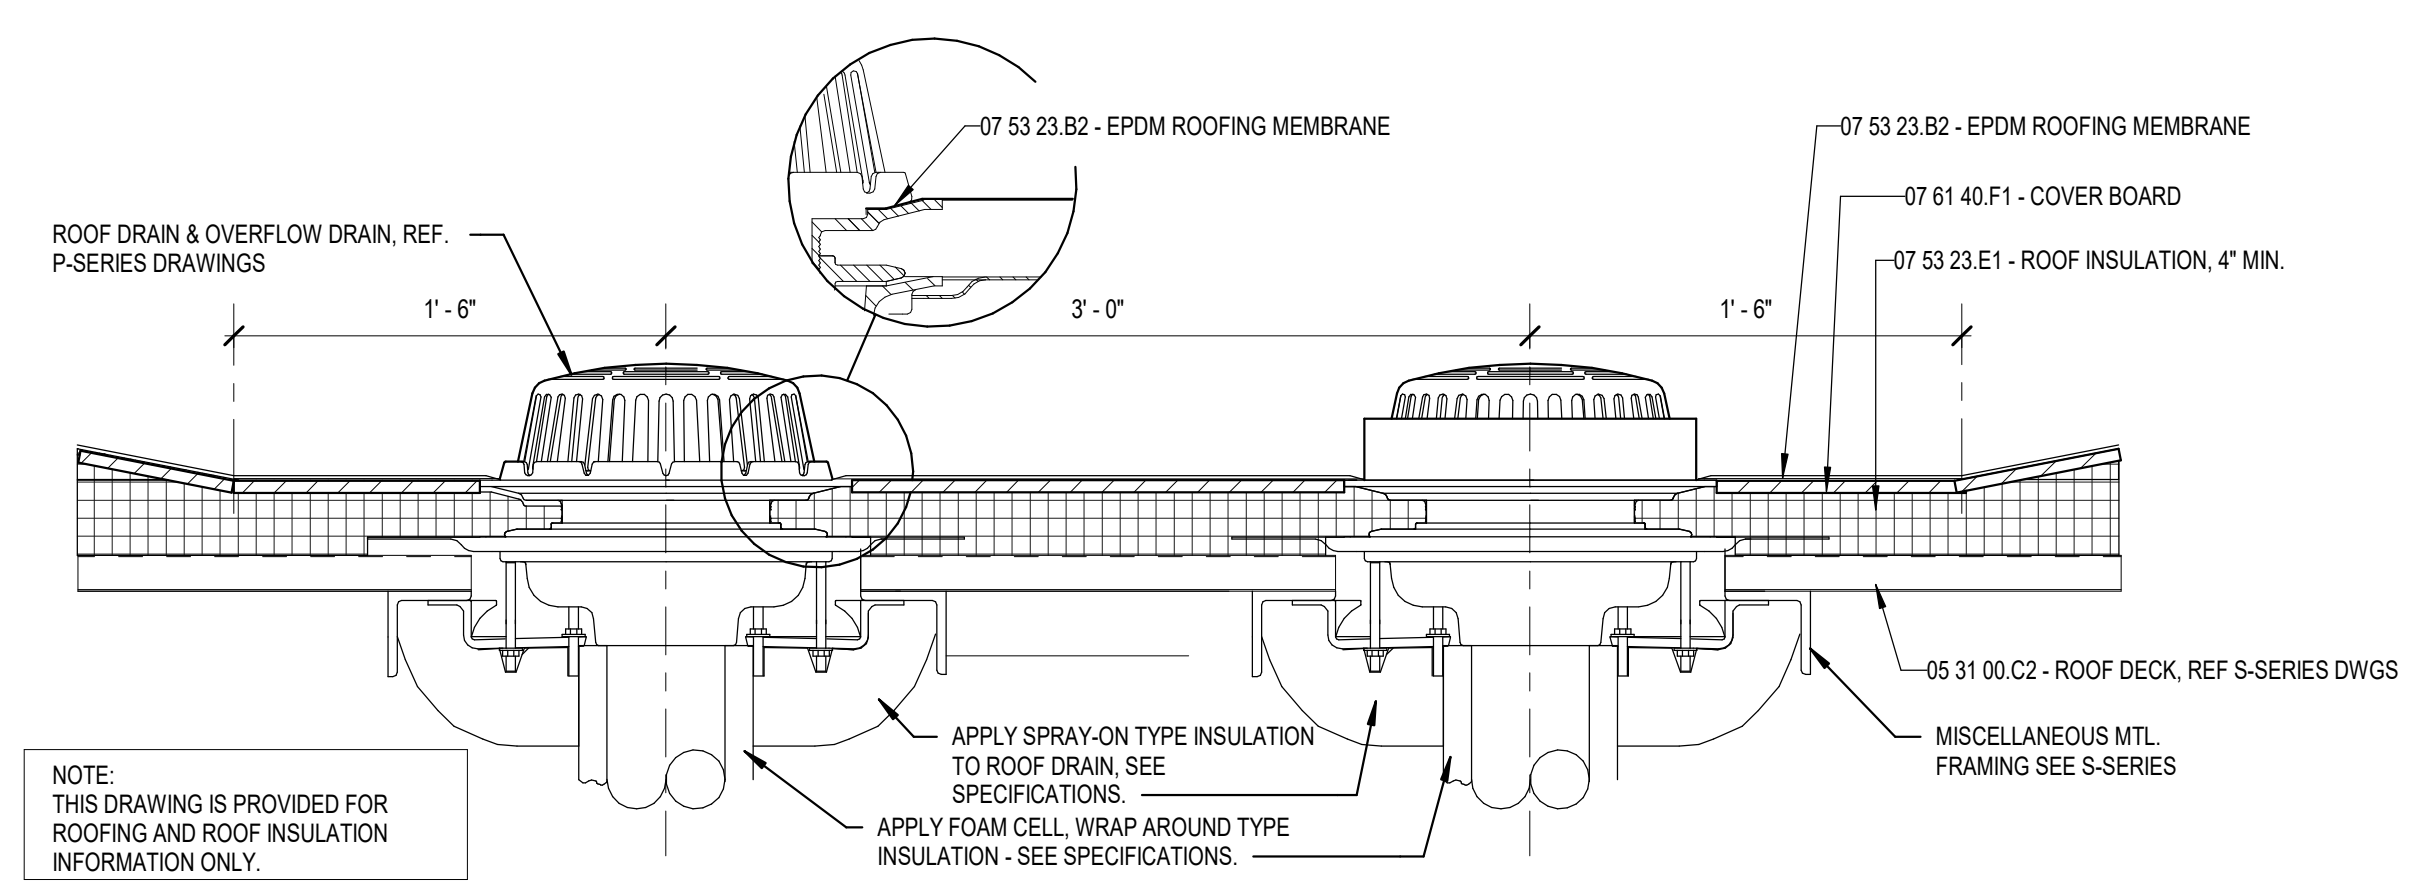

**3A ROOF DRAIN DETAIL**  
1 1/2" = 1'-0"

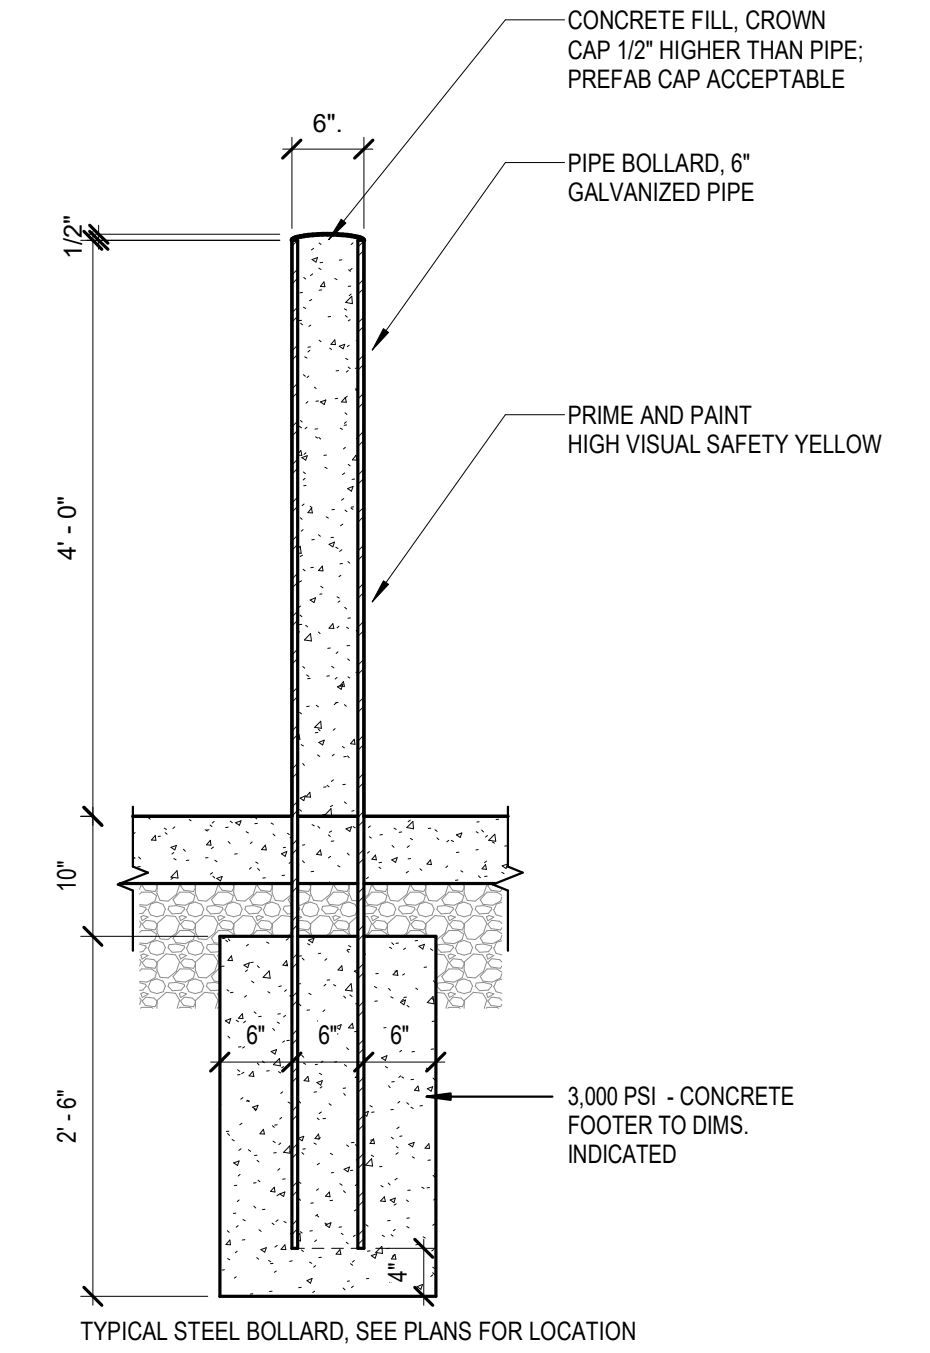

**5D BOLLARD TYPE - A DETAIL**  
3/4" = 1'-0"

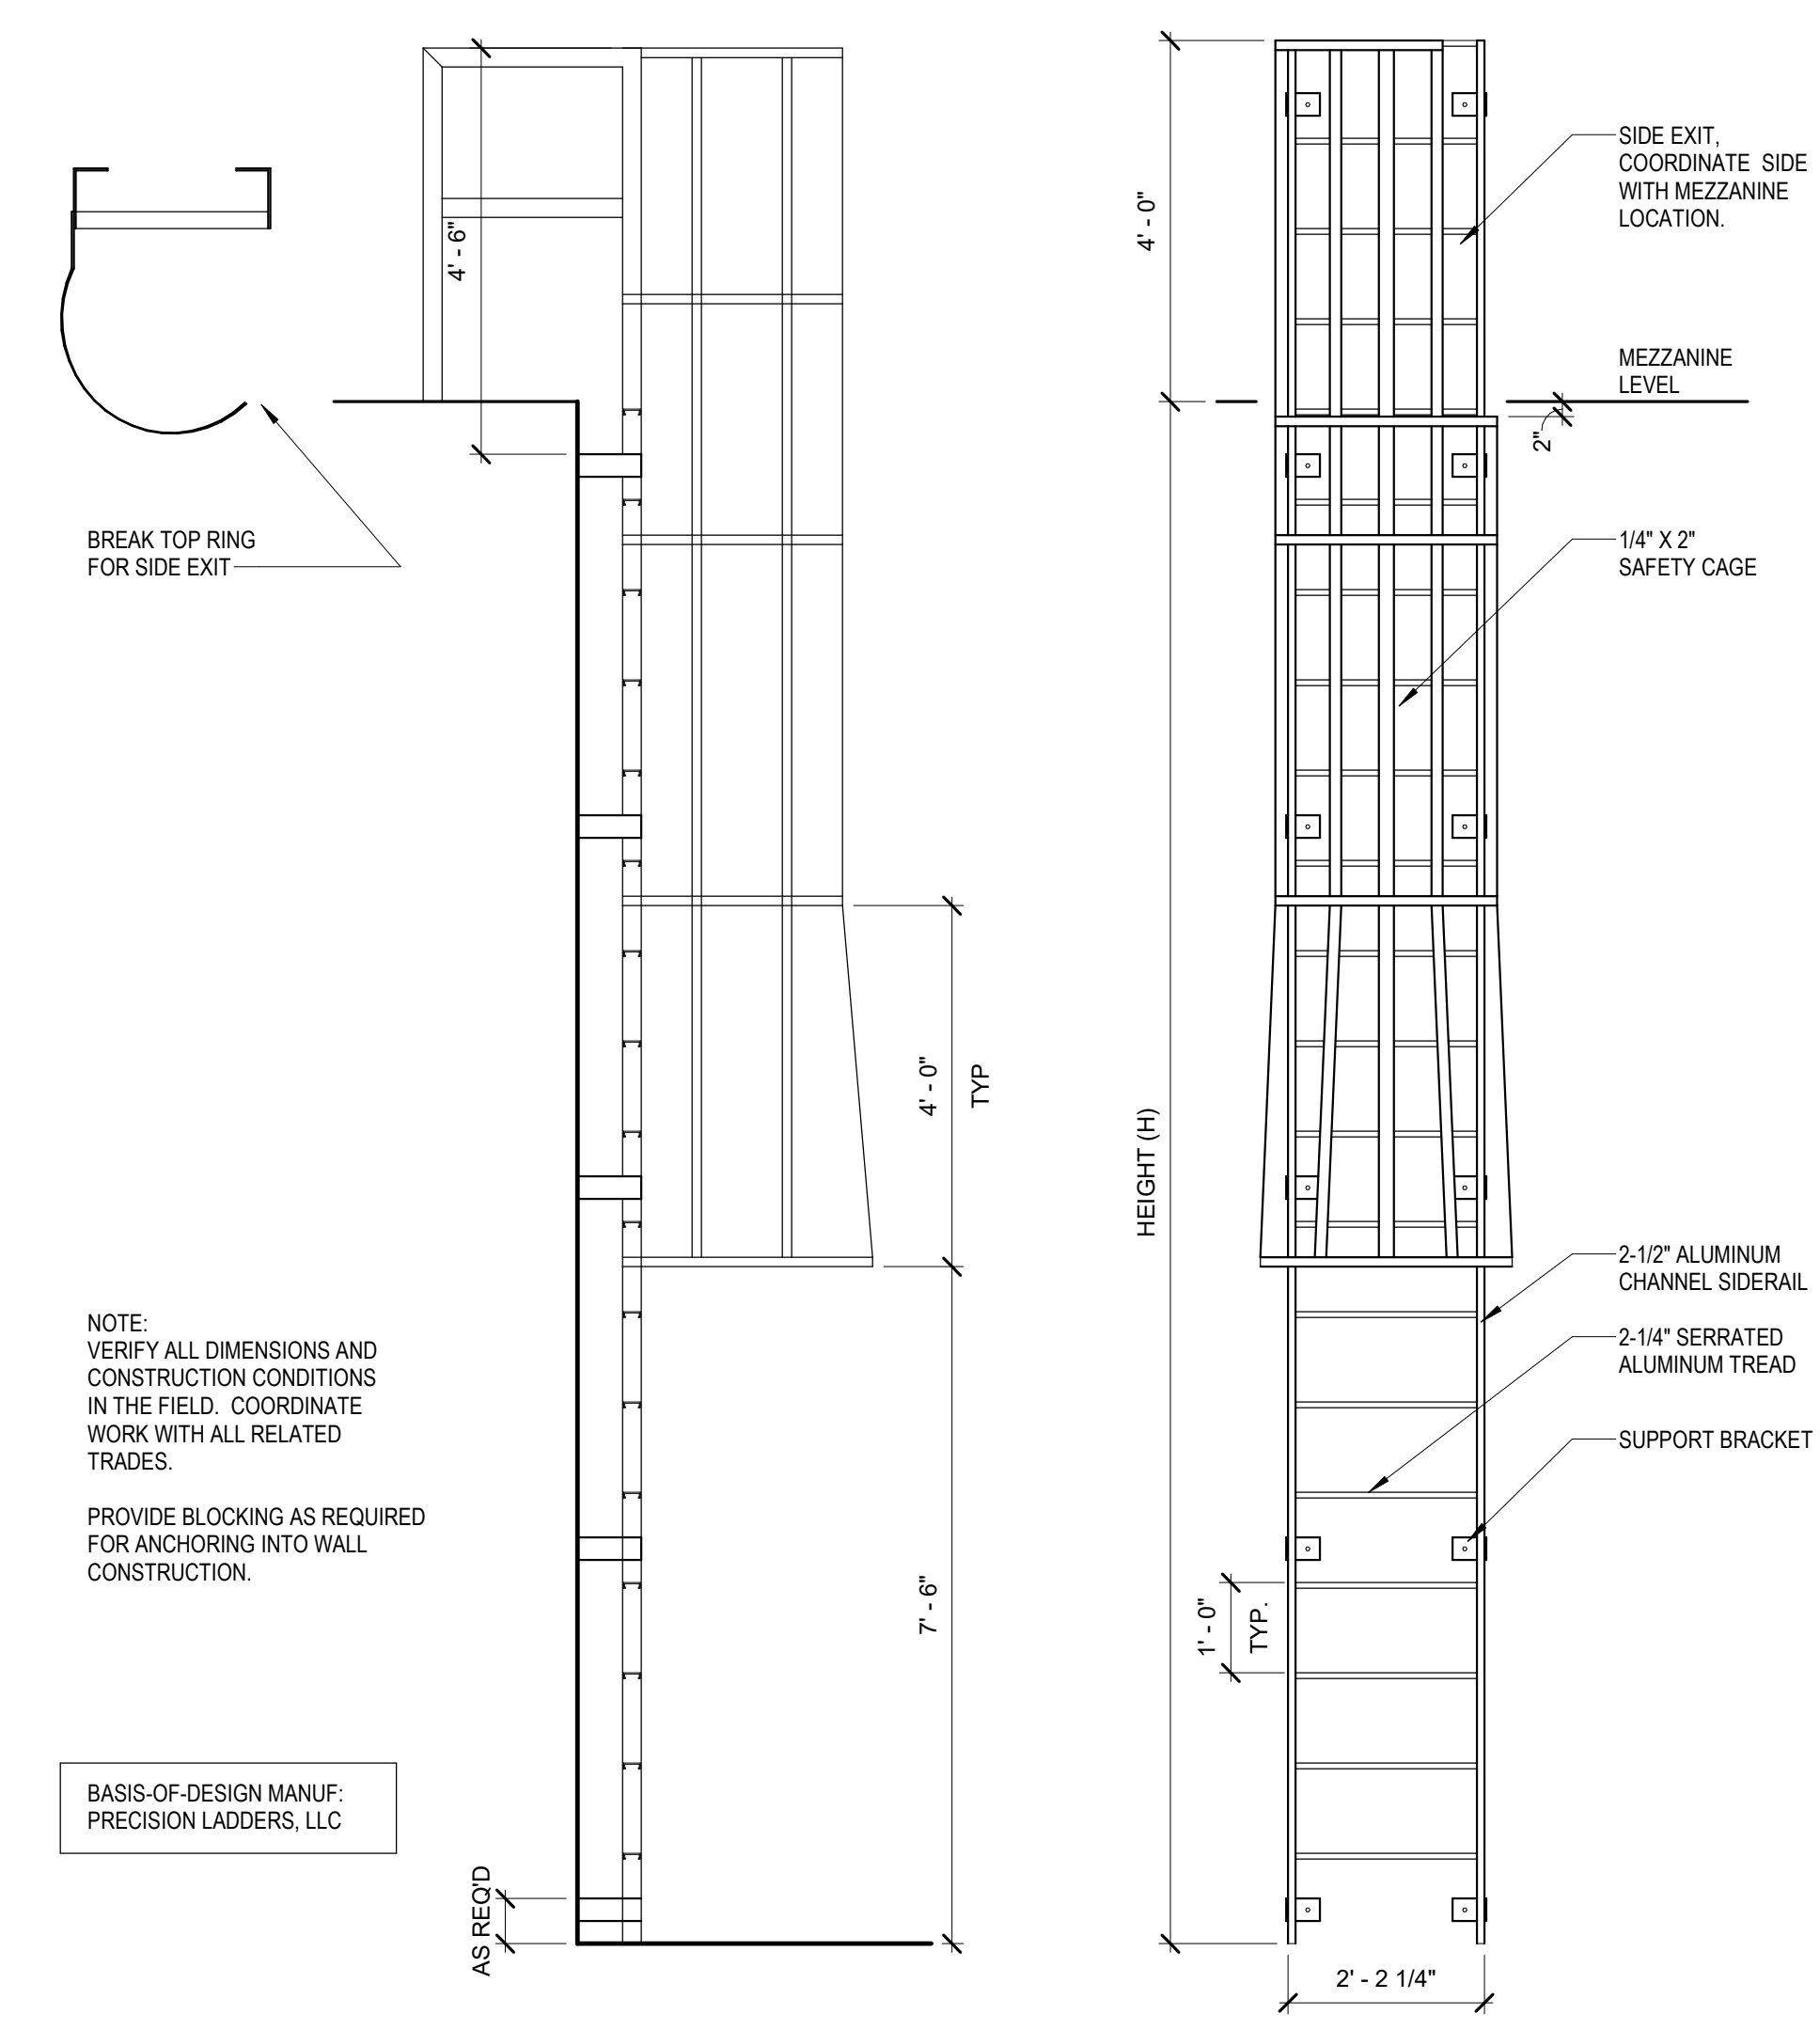


**5A ALUM FIXED LADDER W/CAGE & OVERSHOOT**  
1/2" = 1'-0"




#	Revision	Date
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Project #: 20-700-151-2  
Designed By: LD/SP  
Drawn By: CW  
Checked By: LD/IV  
Date: 01.28.2022

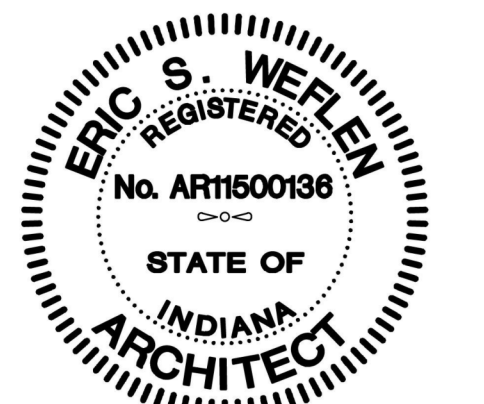













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PLAN DETAILS

**A 510**












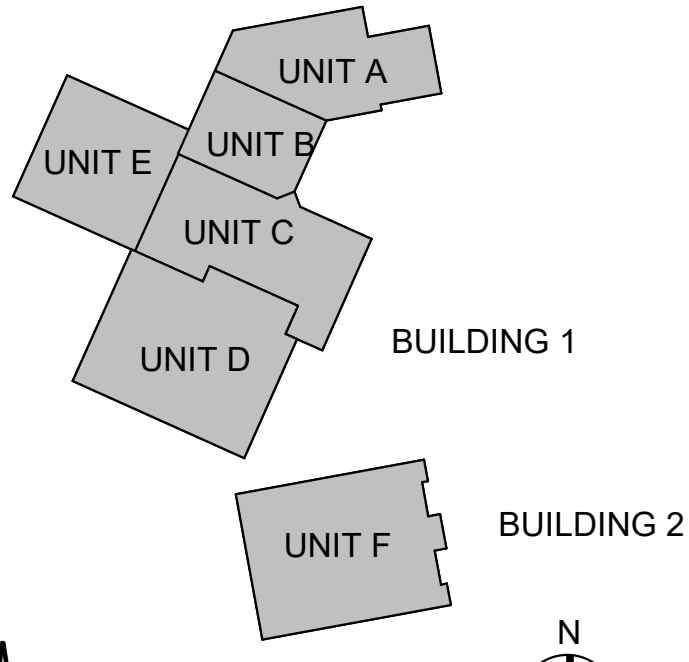


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Project #: 20-700-151-2  
Designed By: Designer  
Drawn By: Author  
Checked By: Checker  
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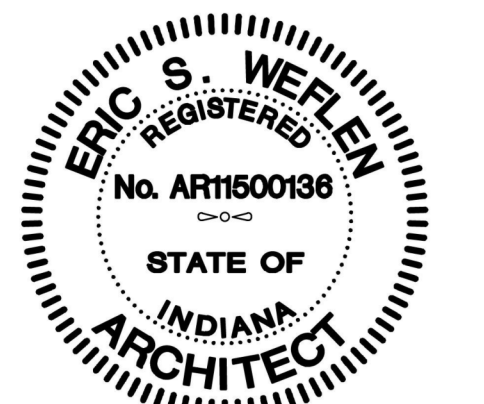


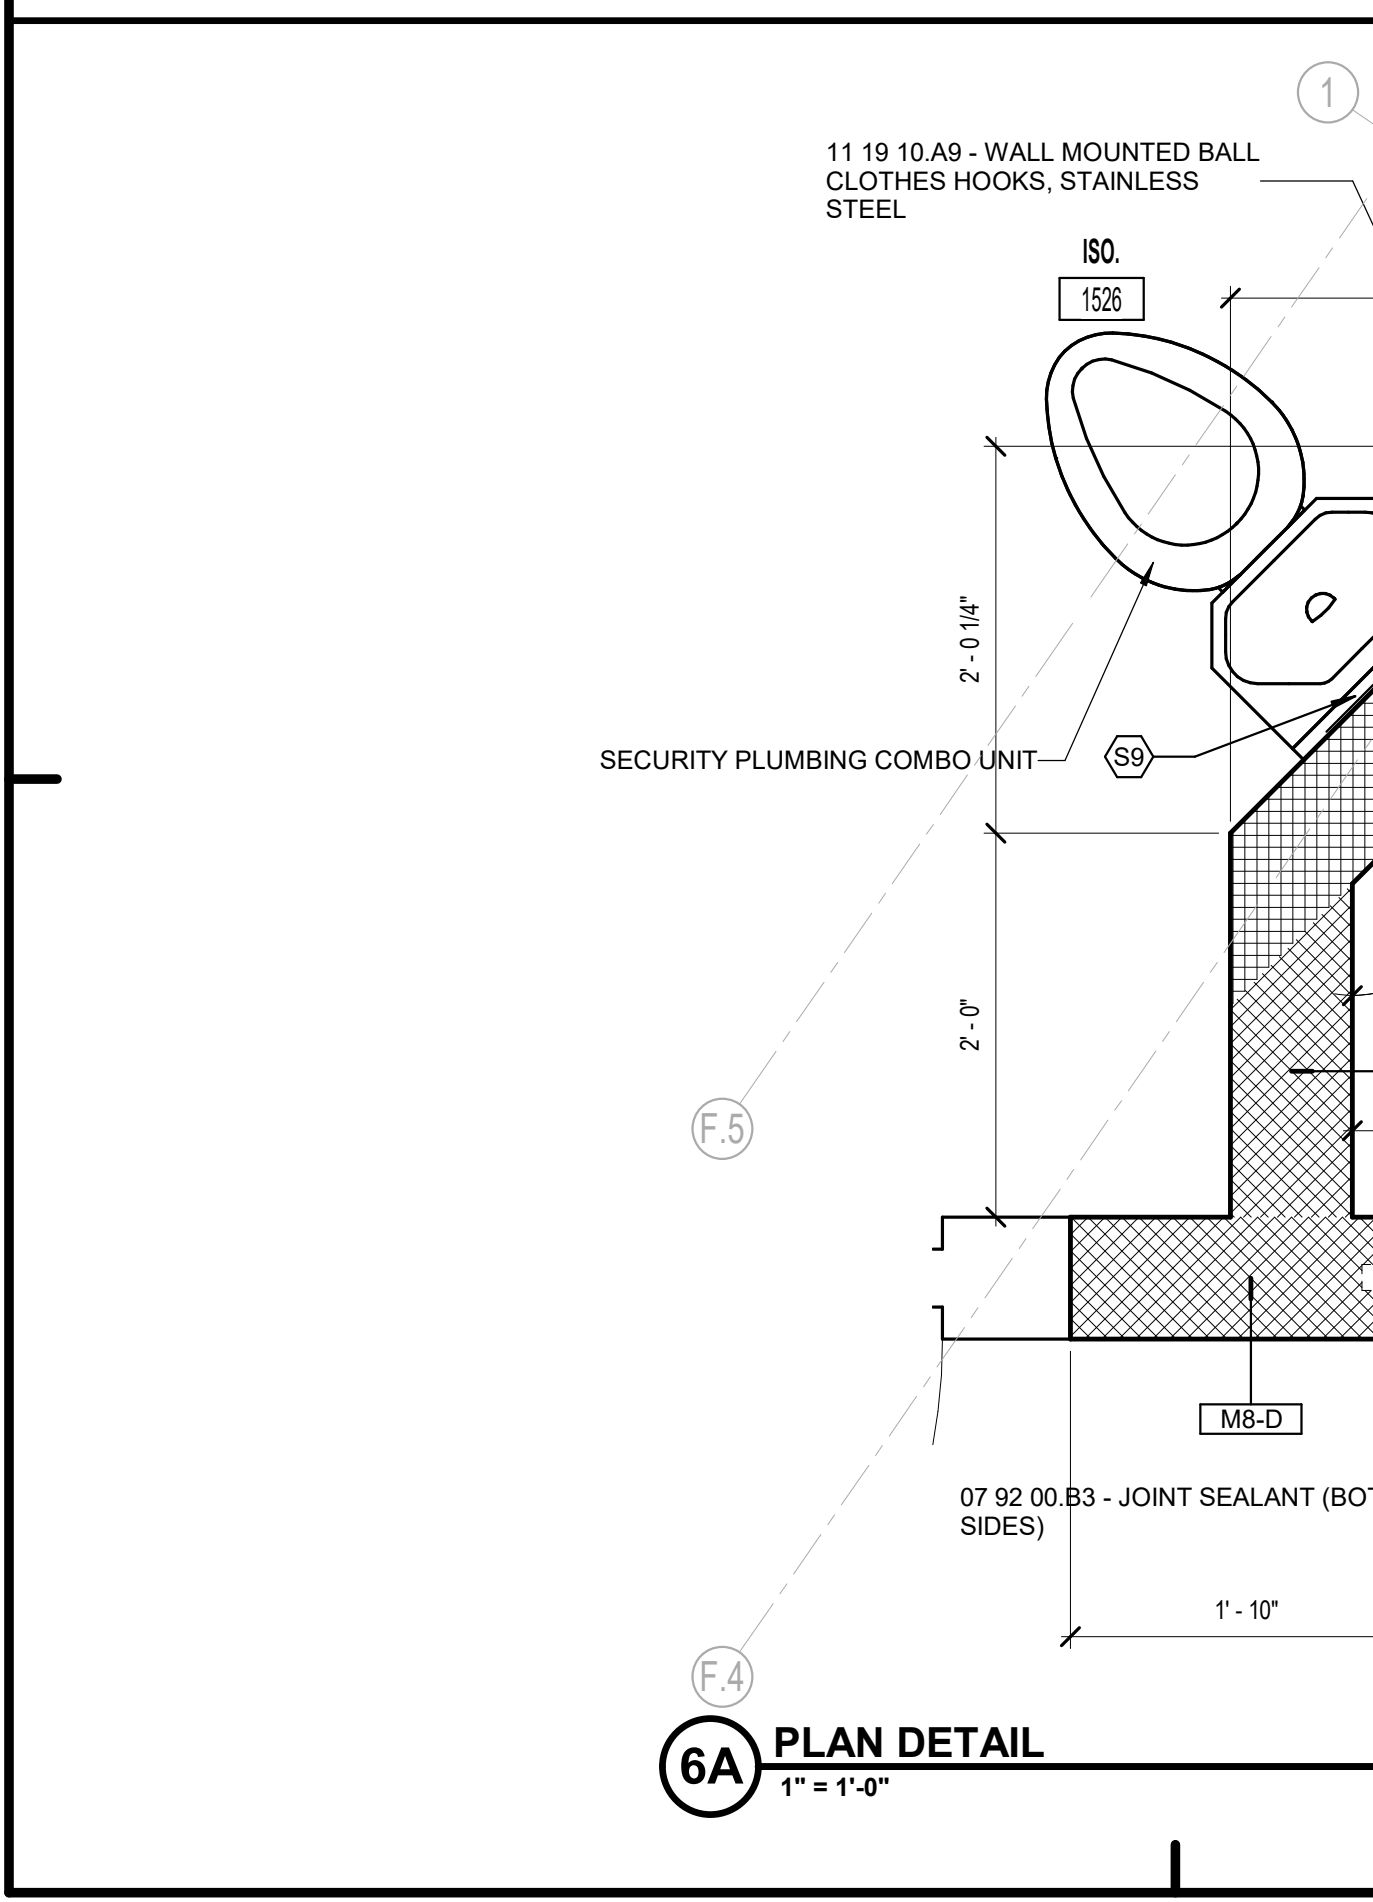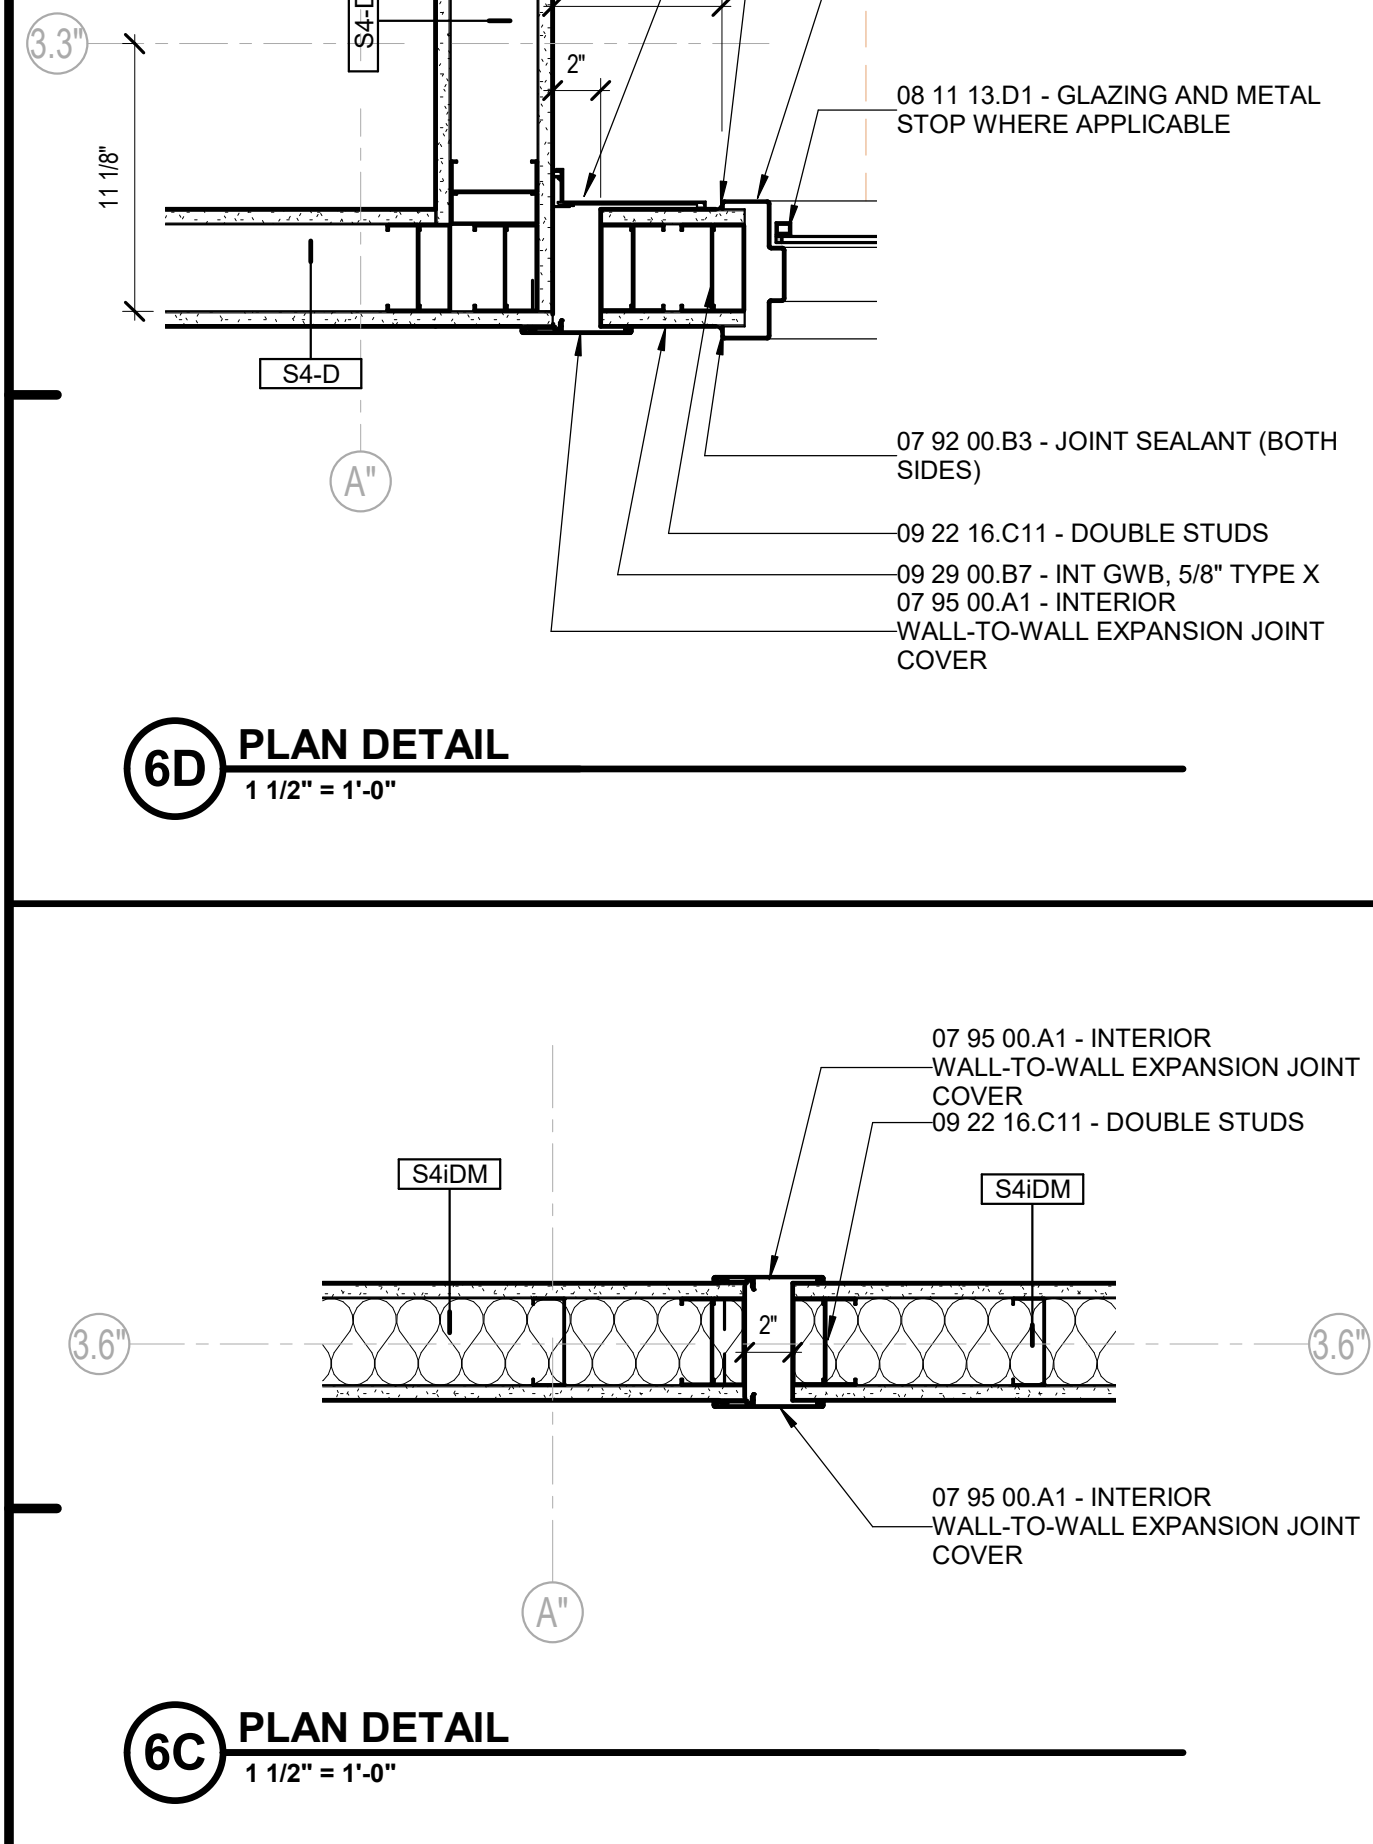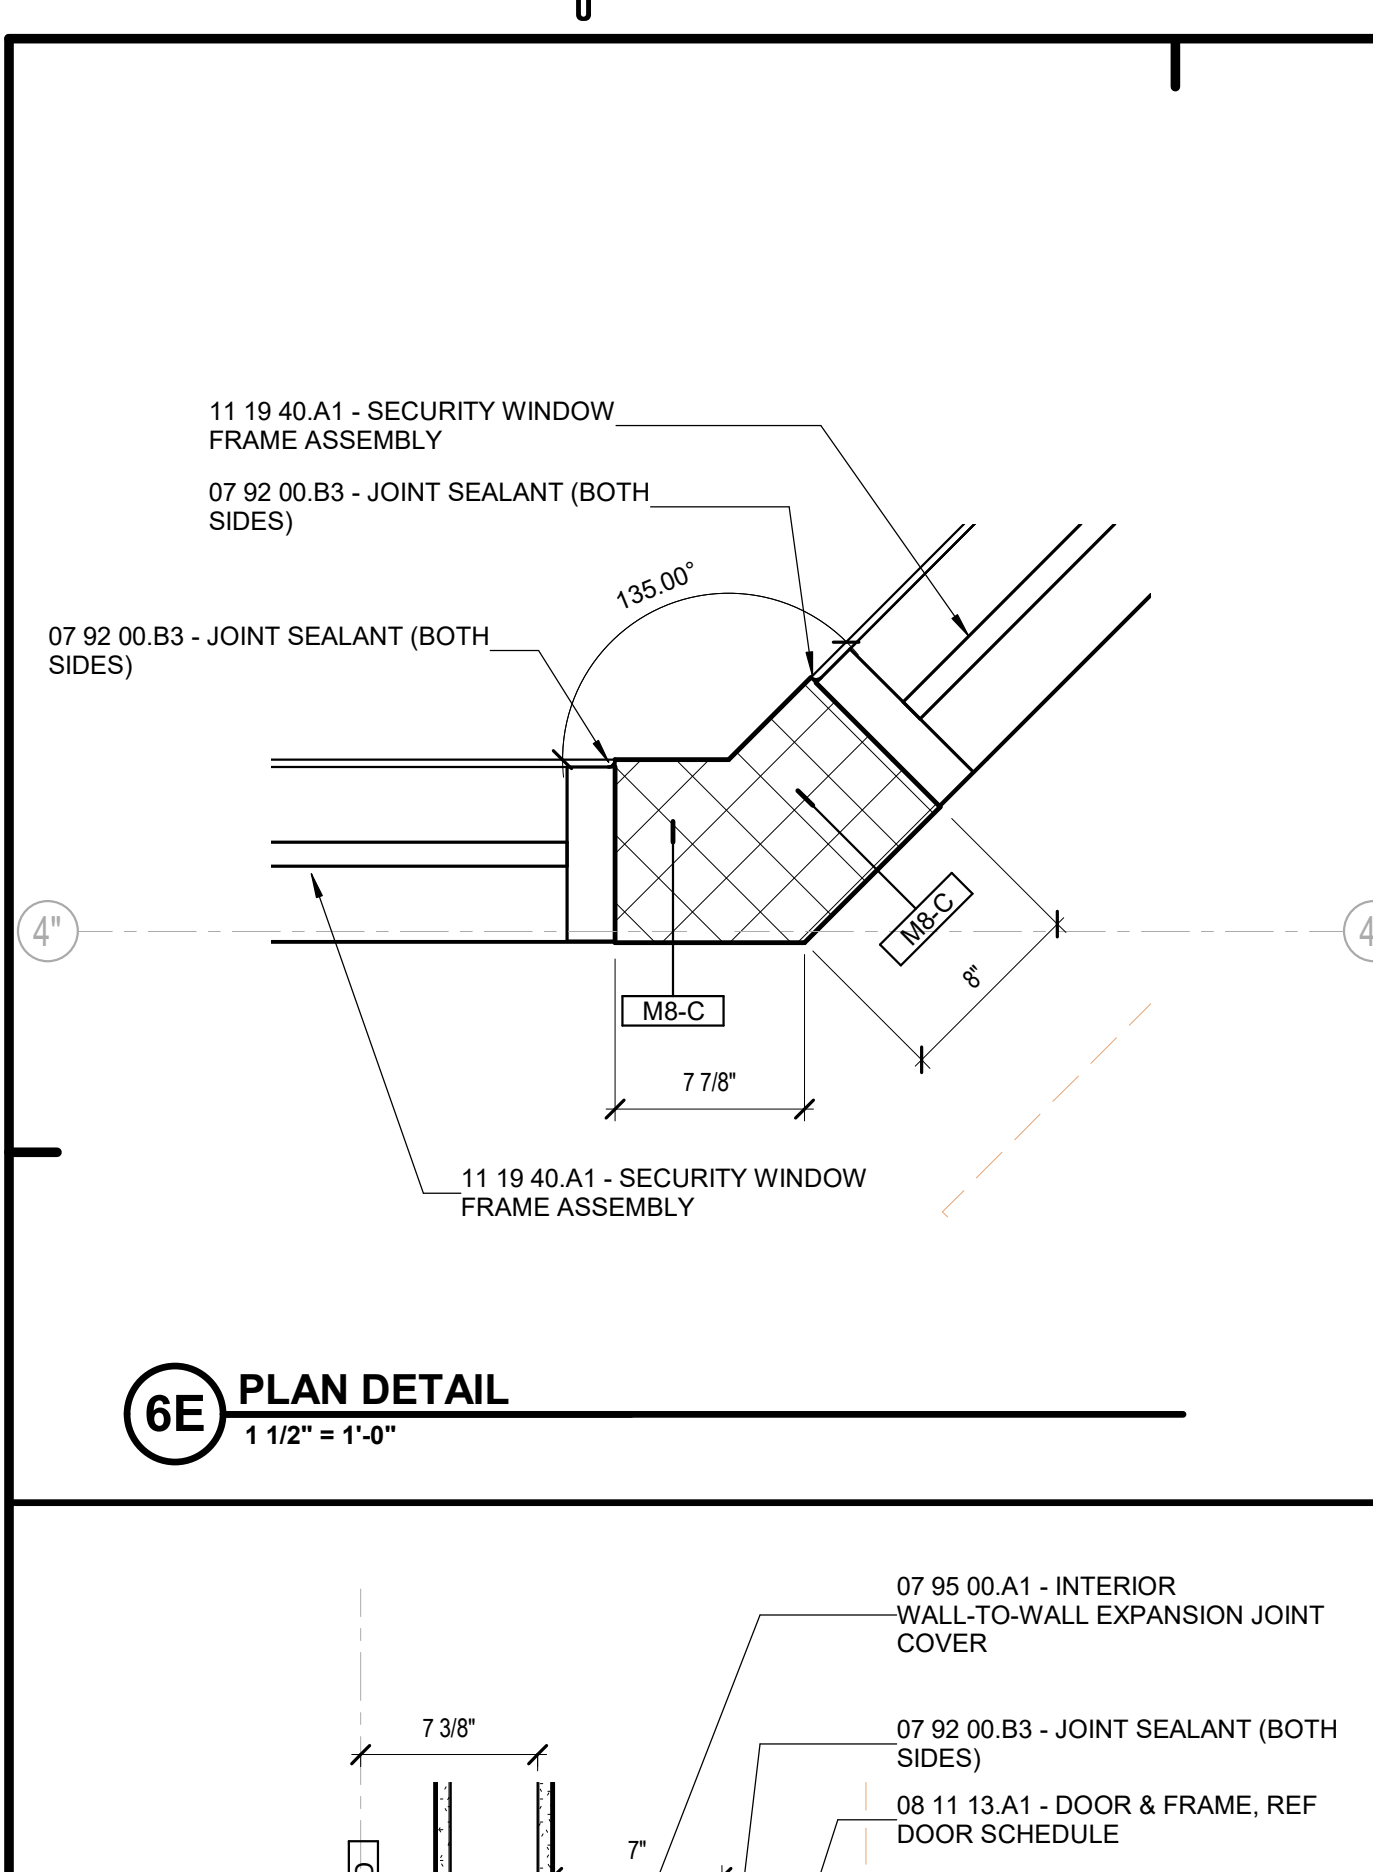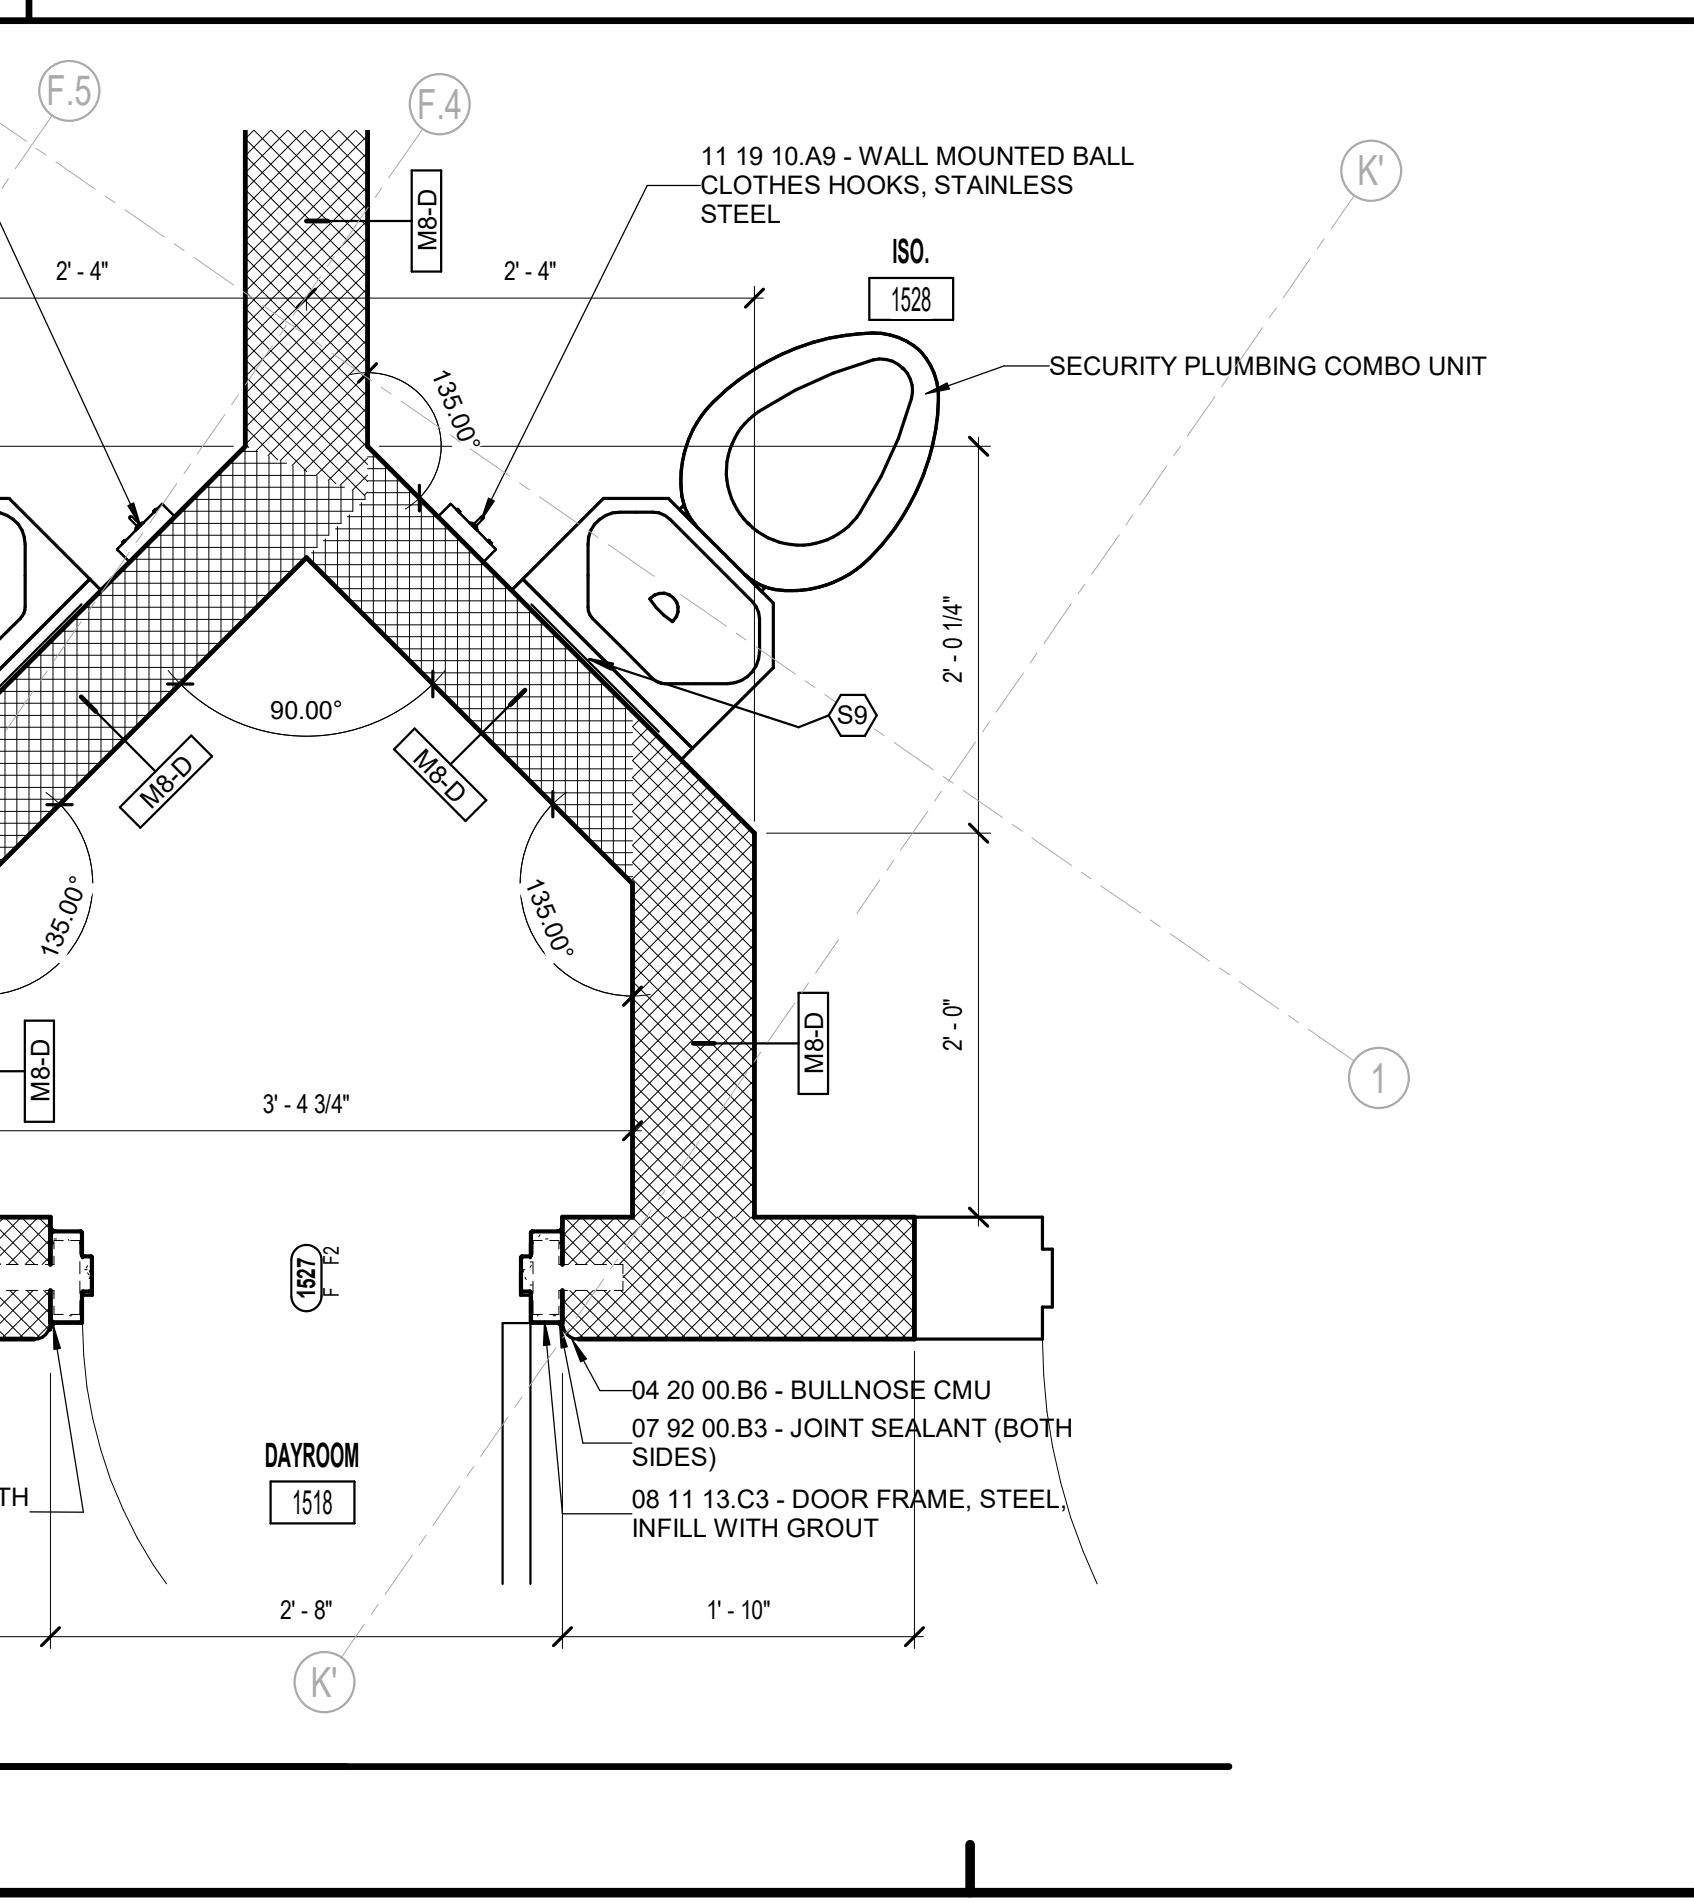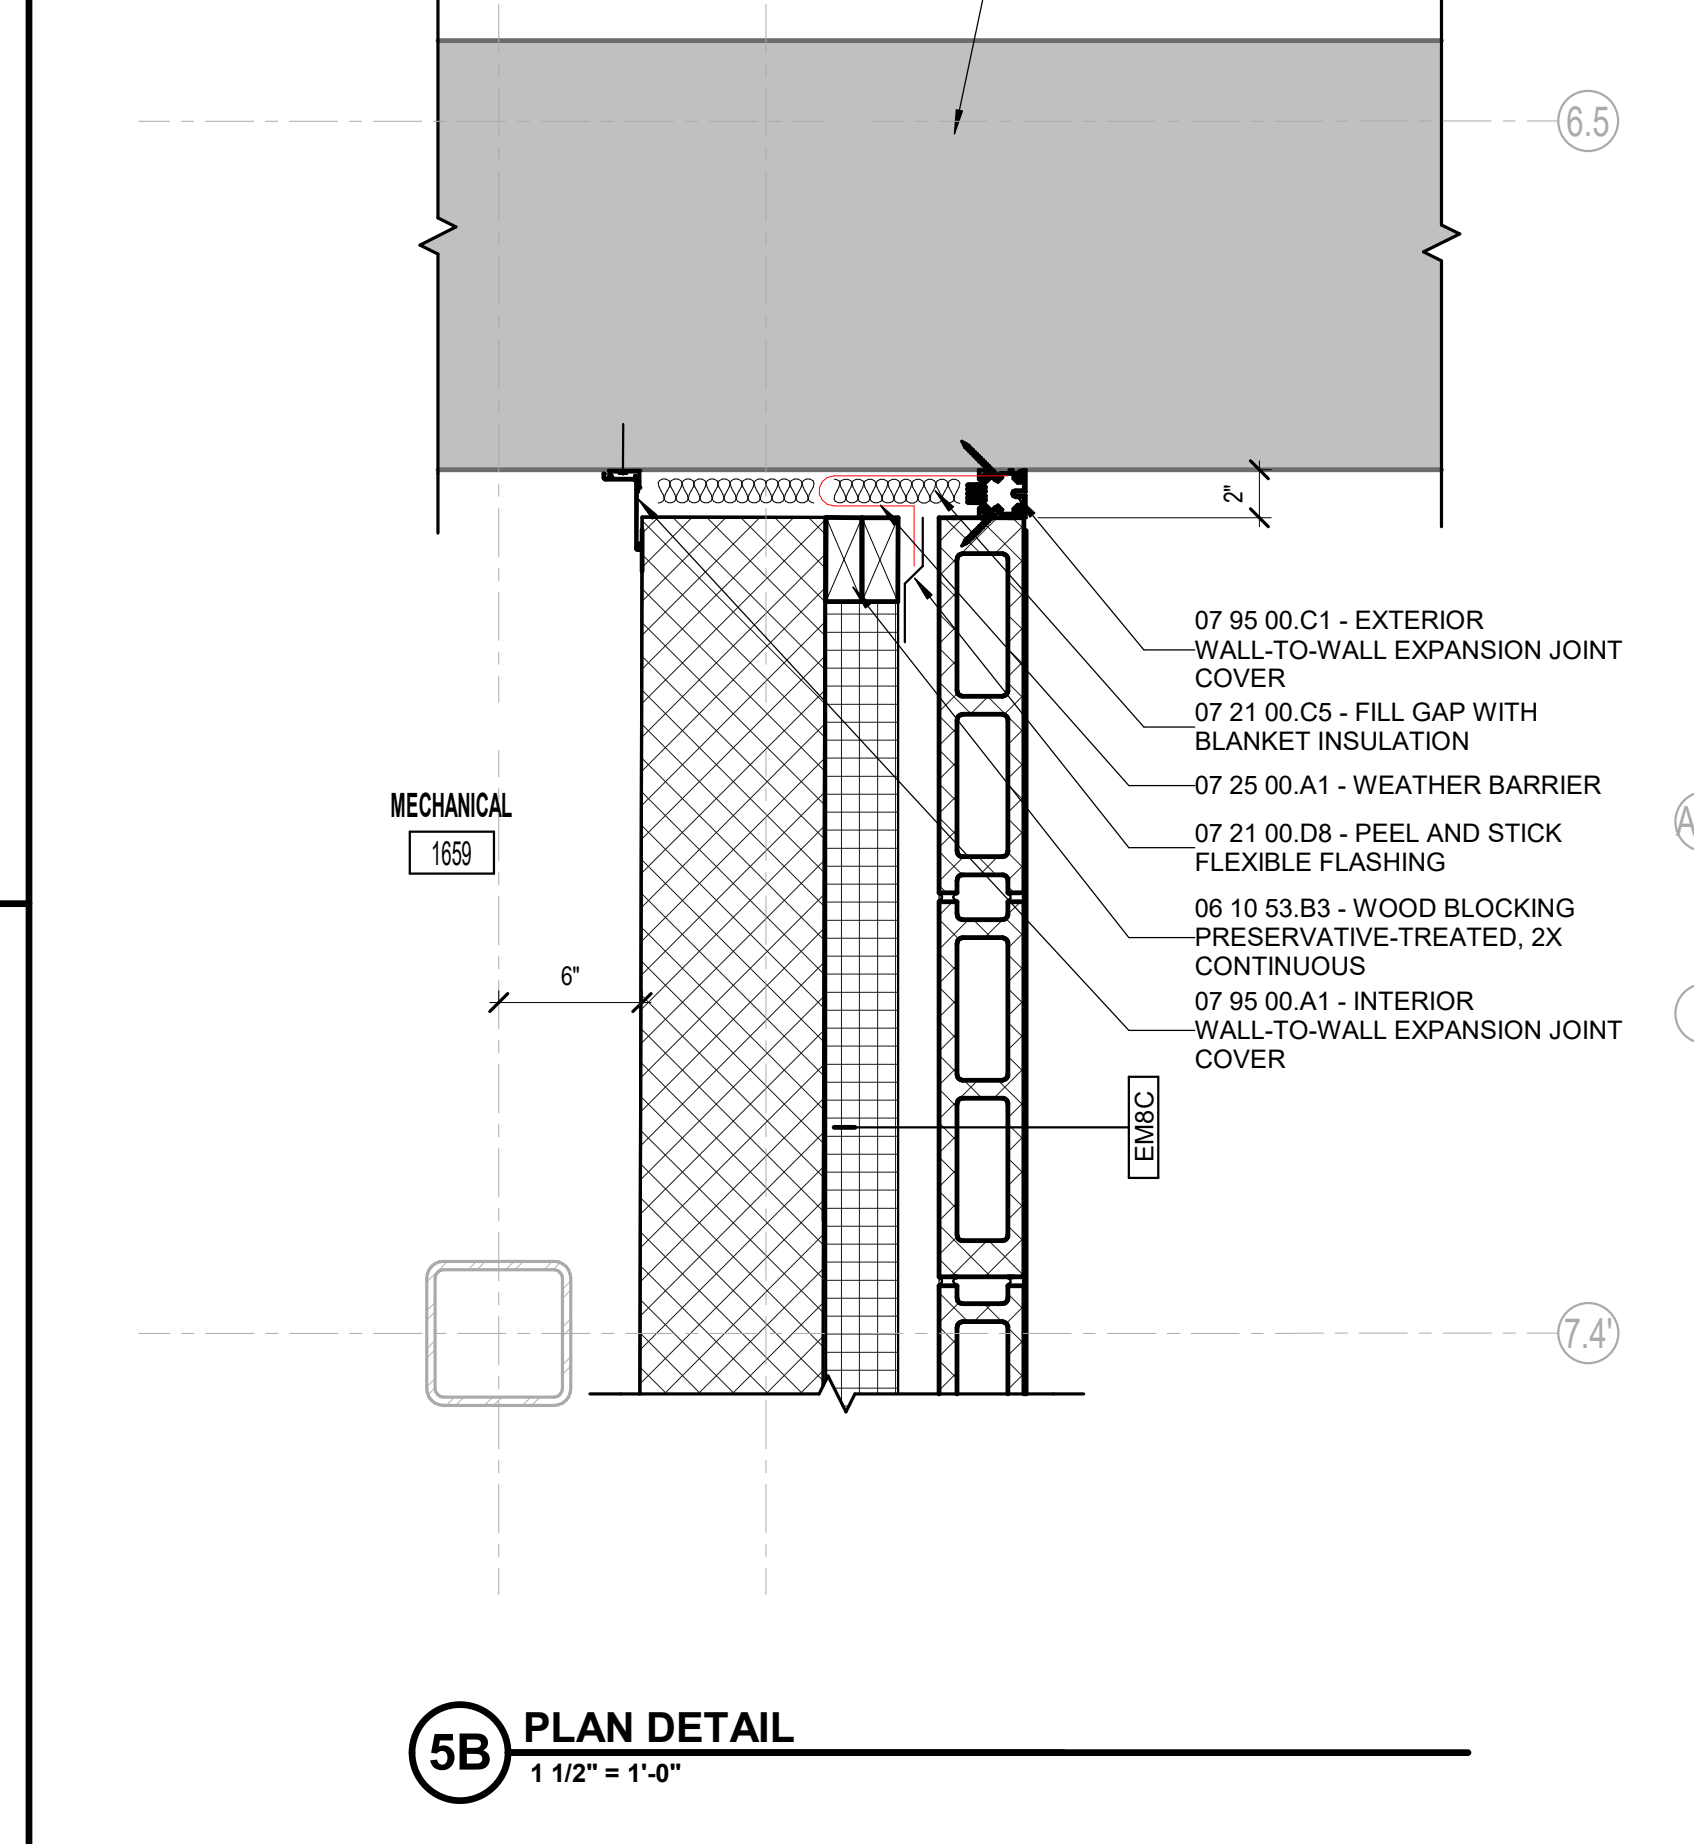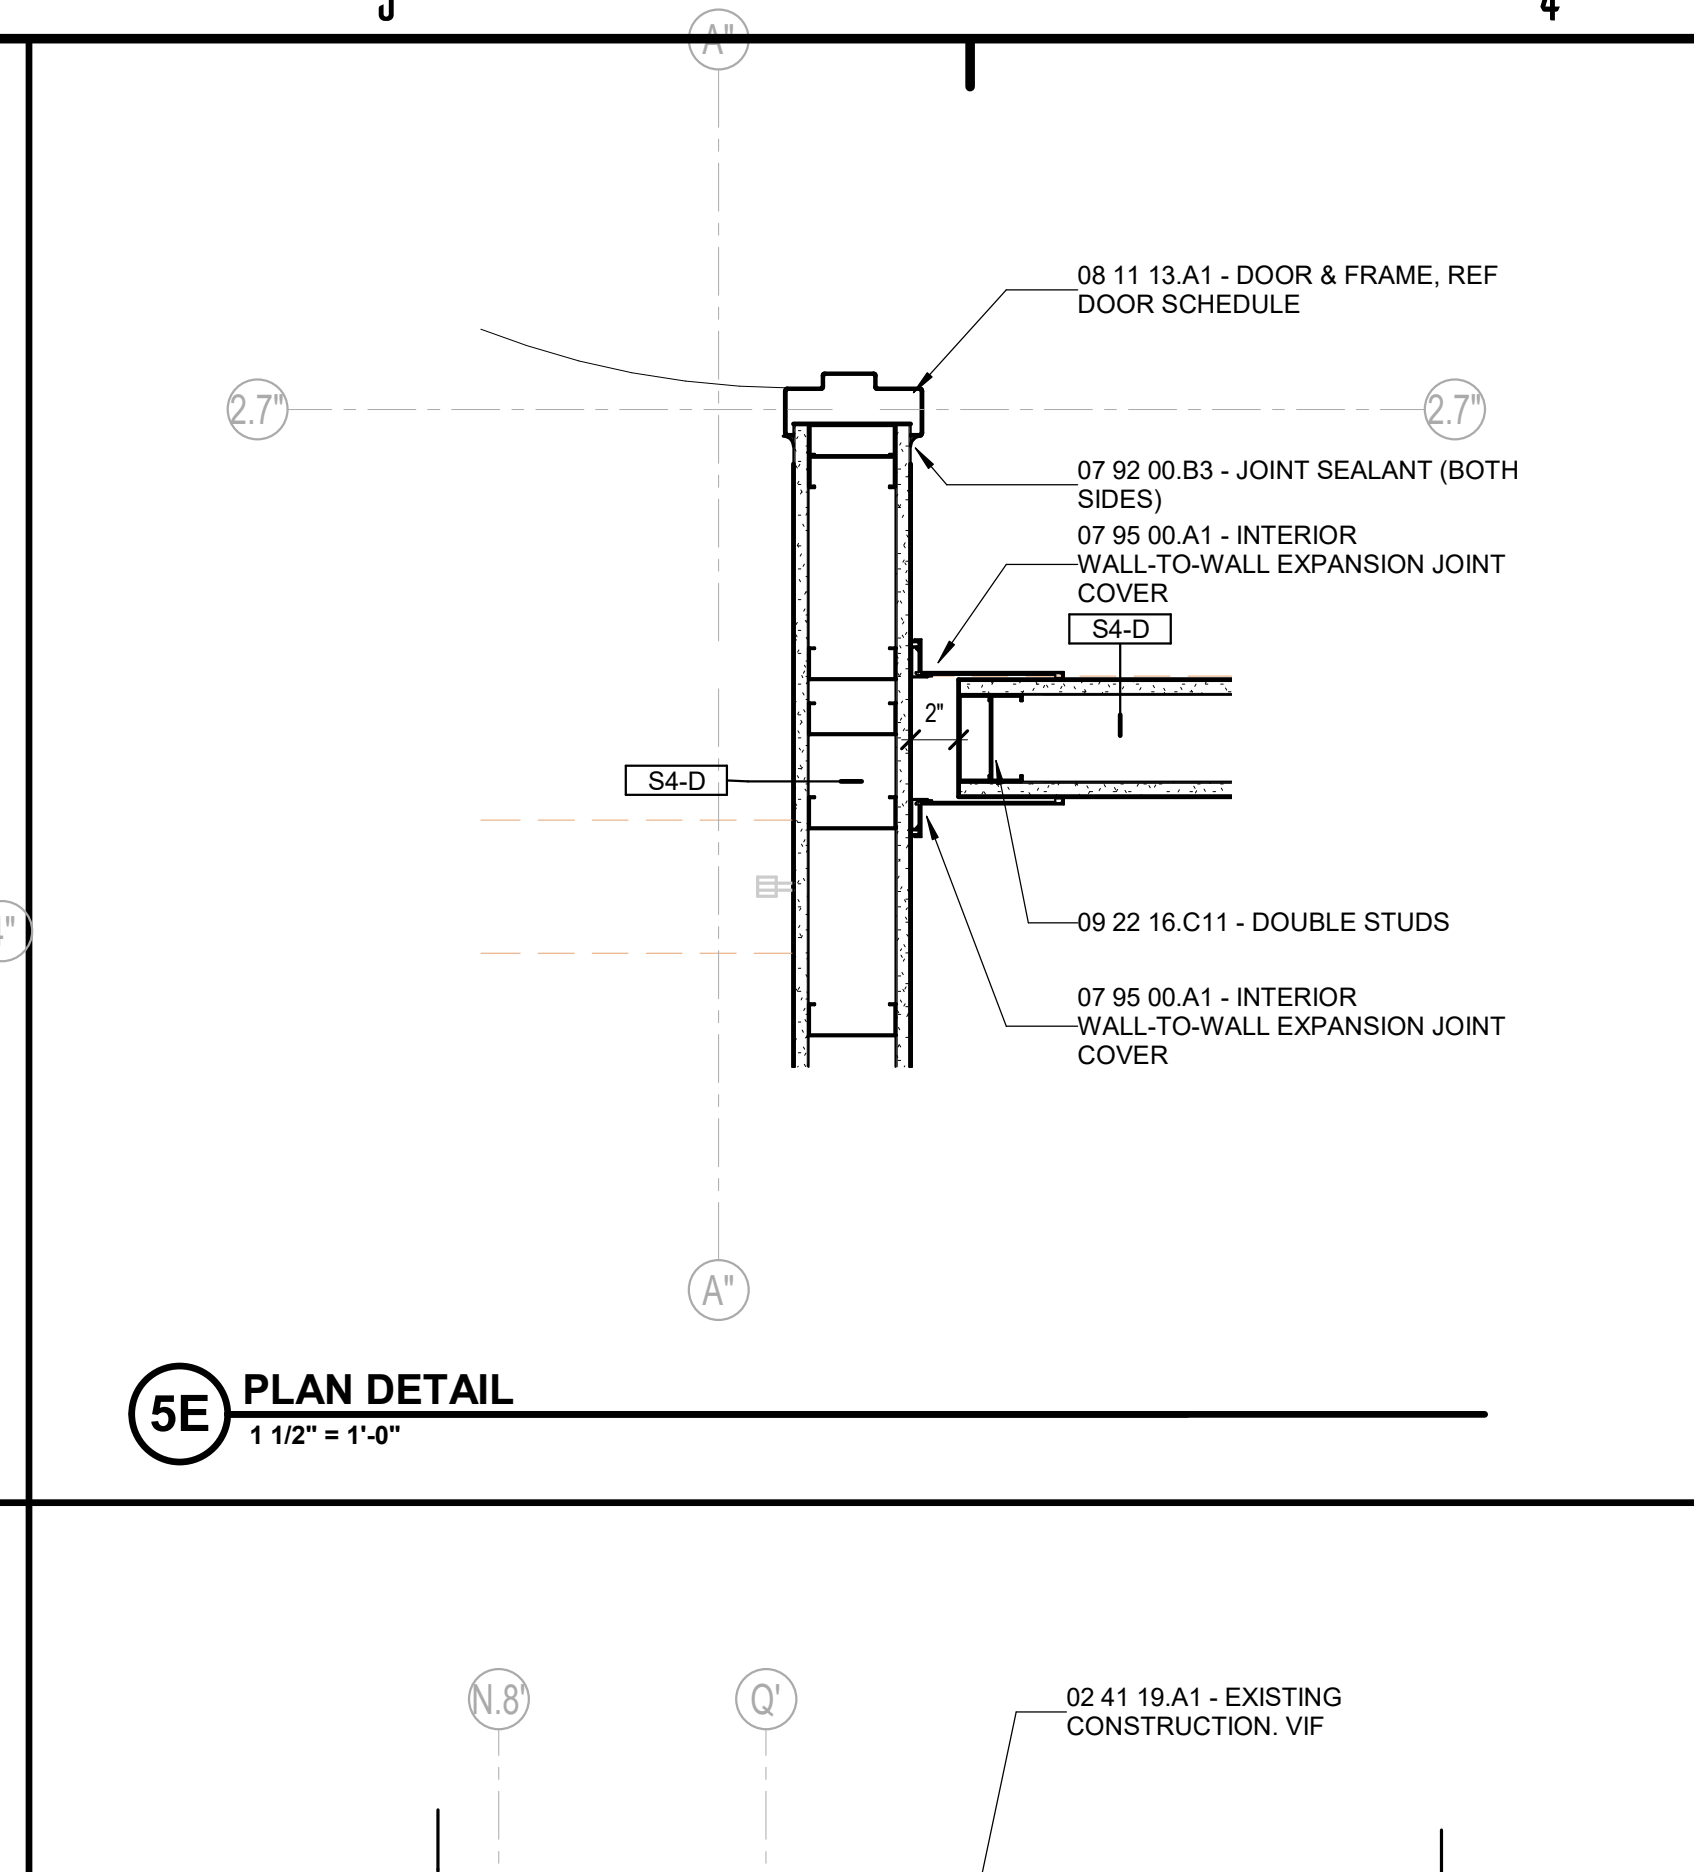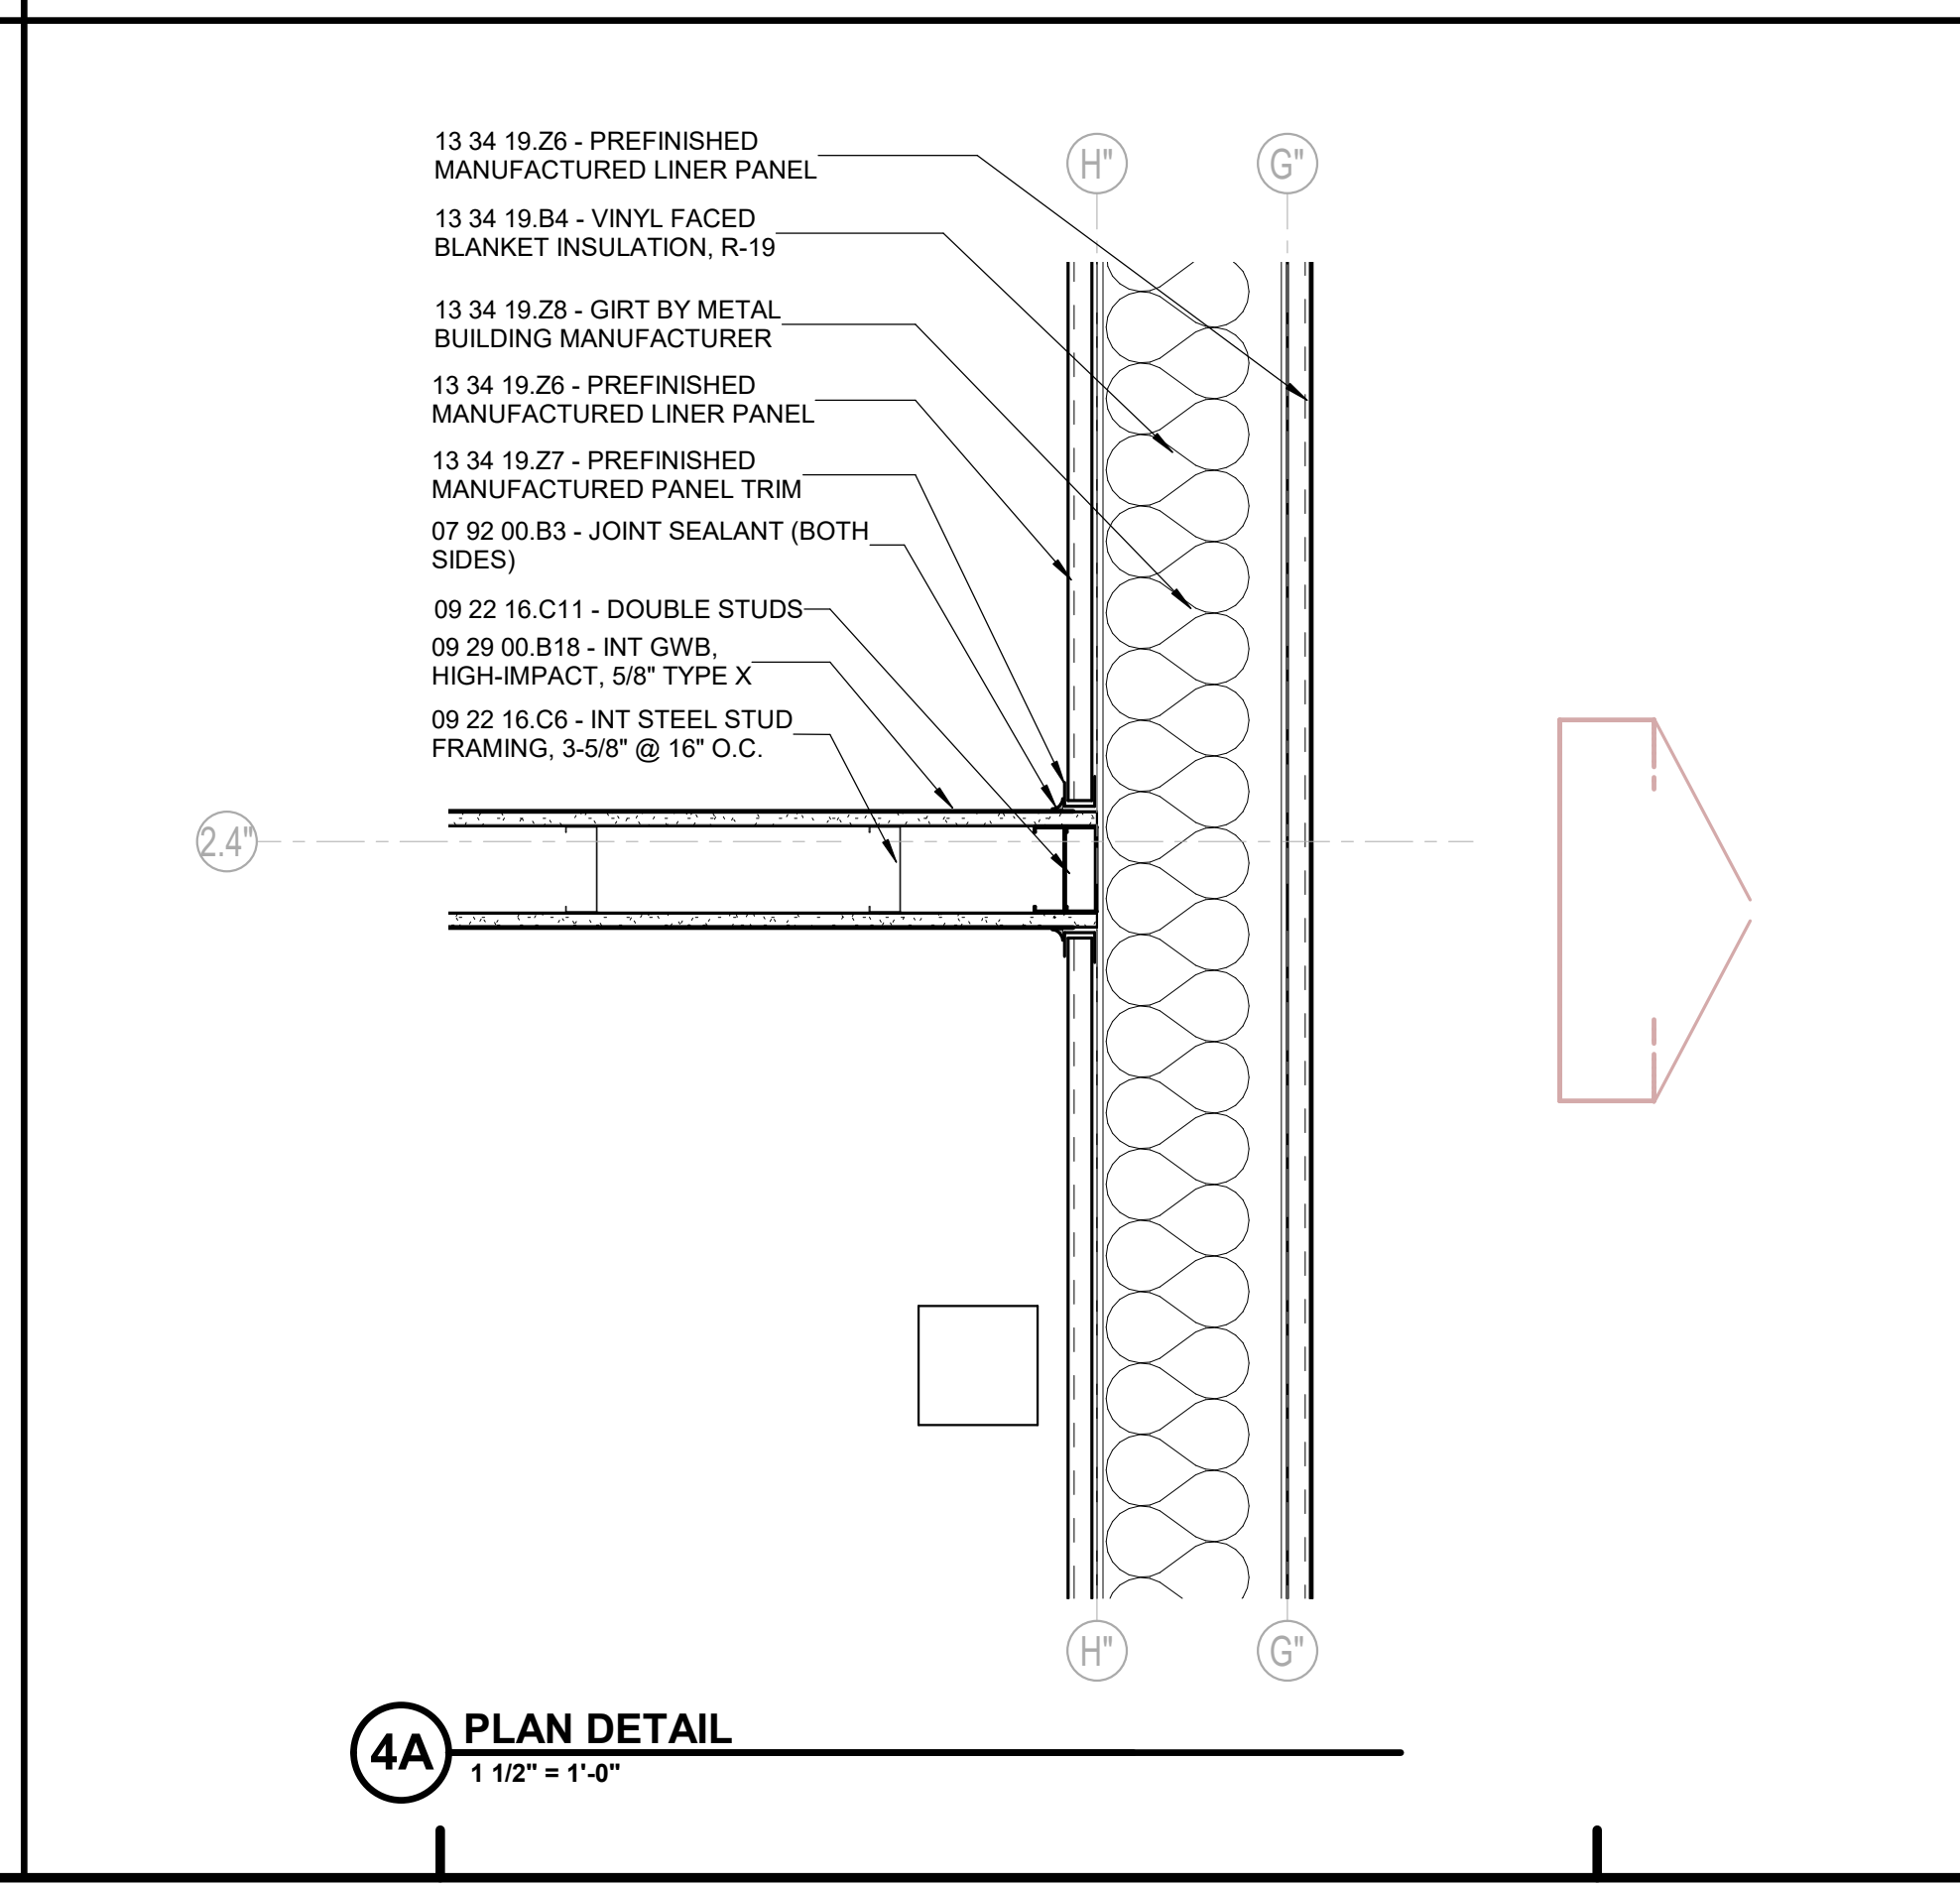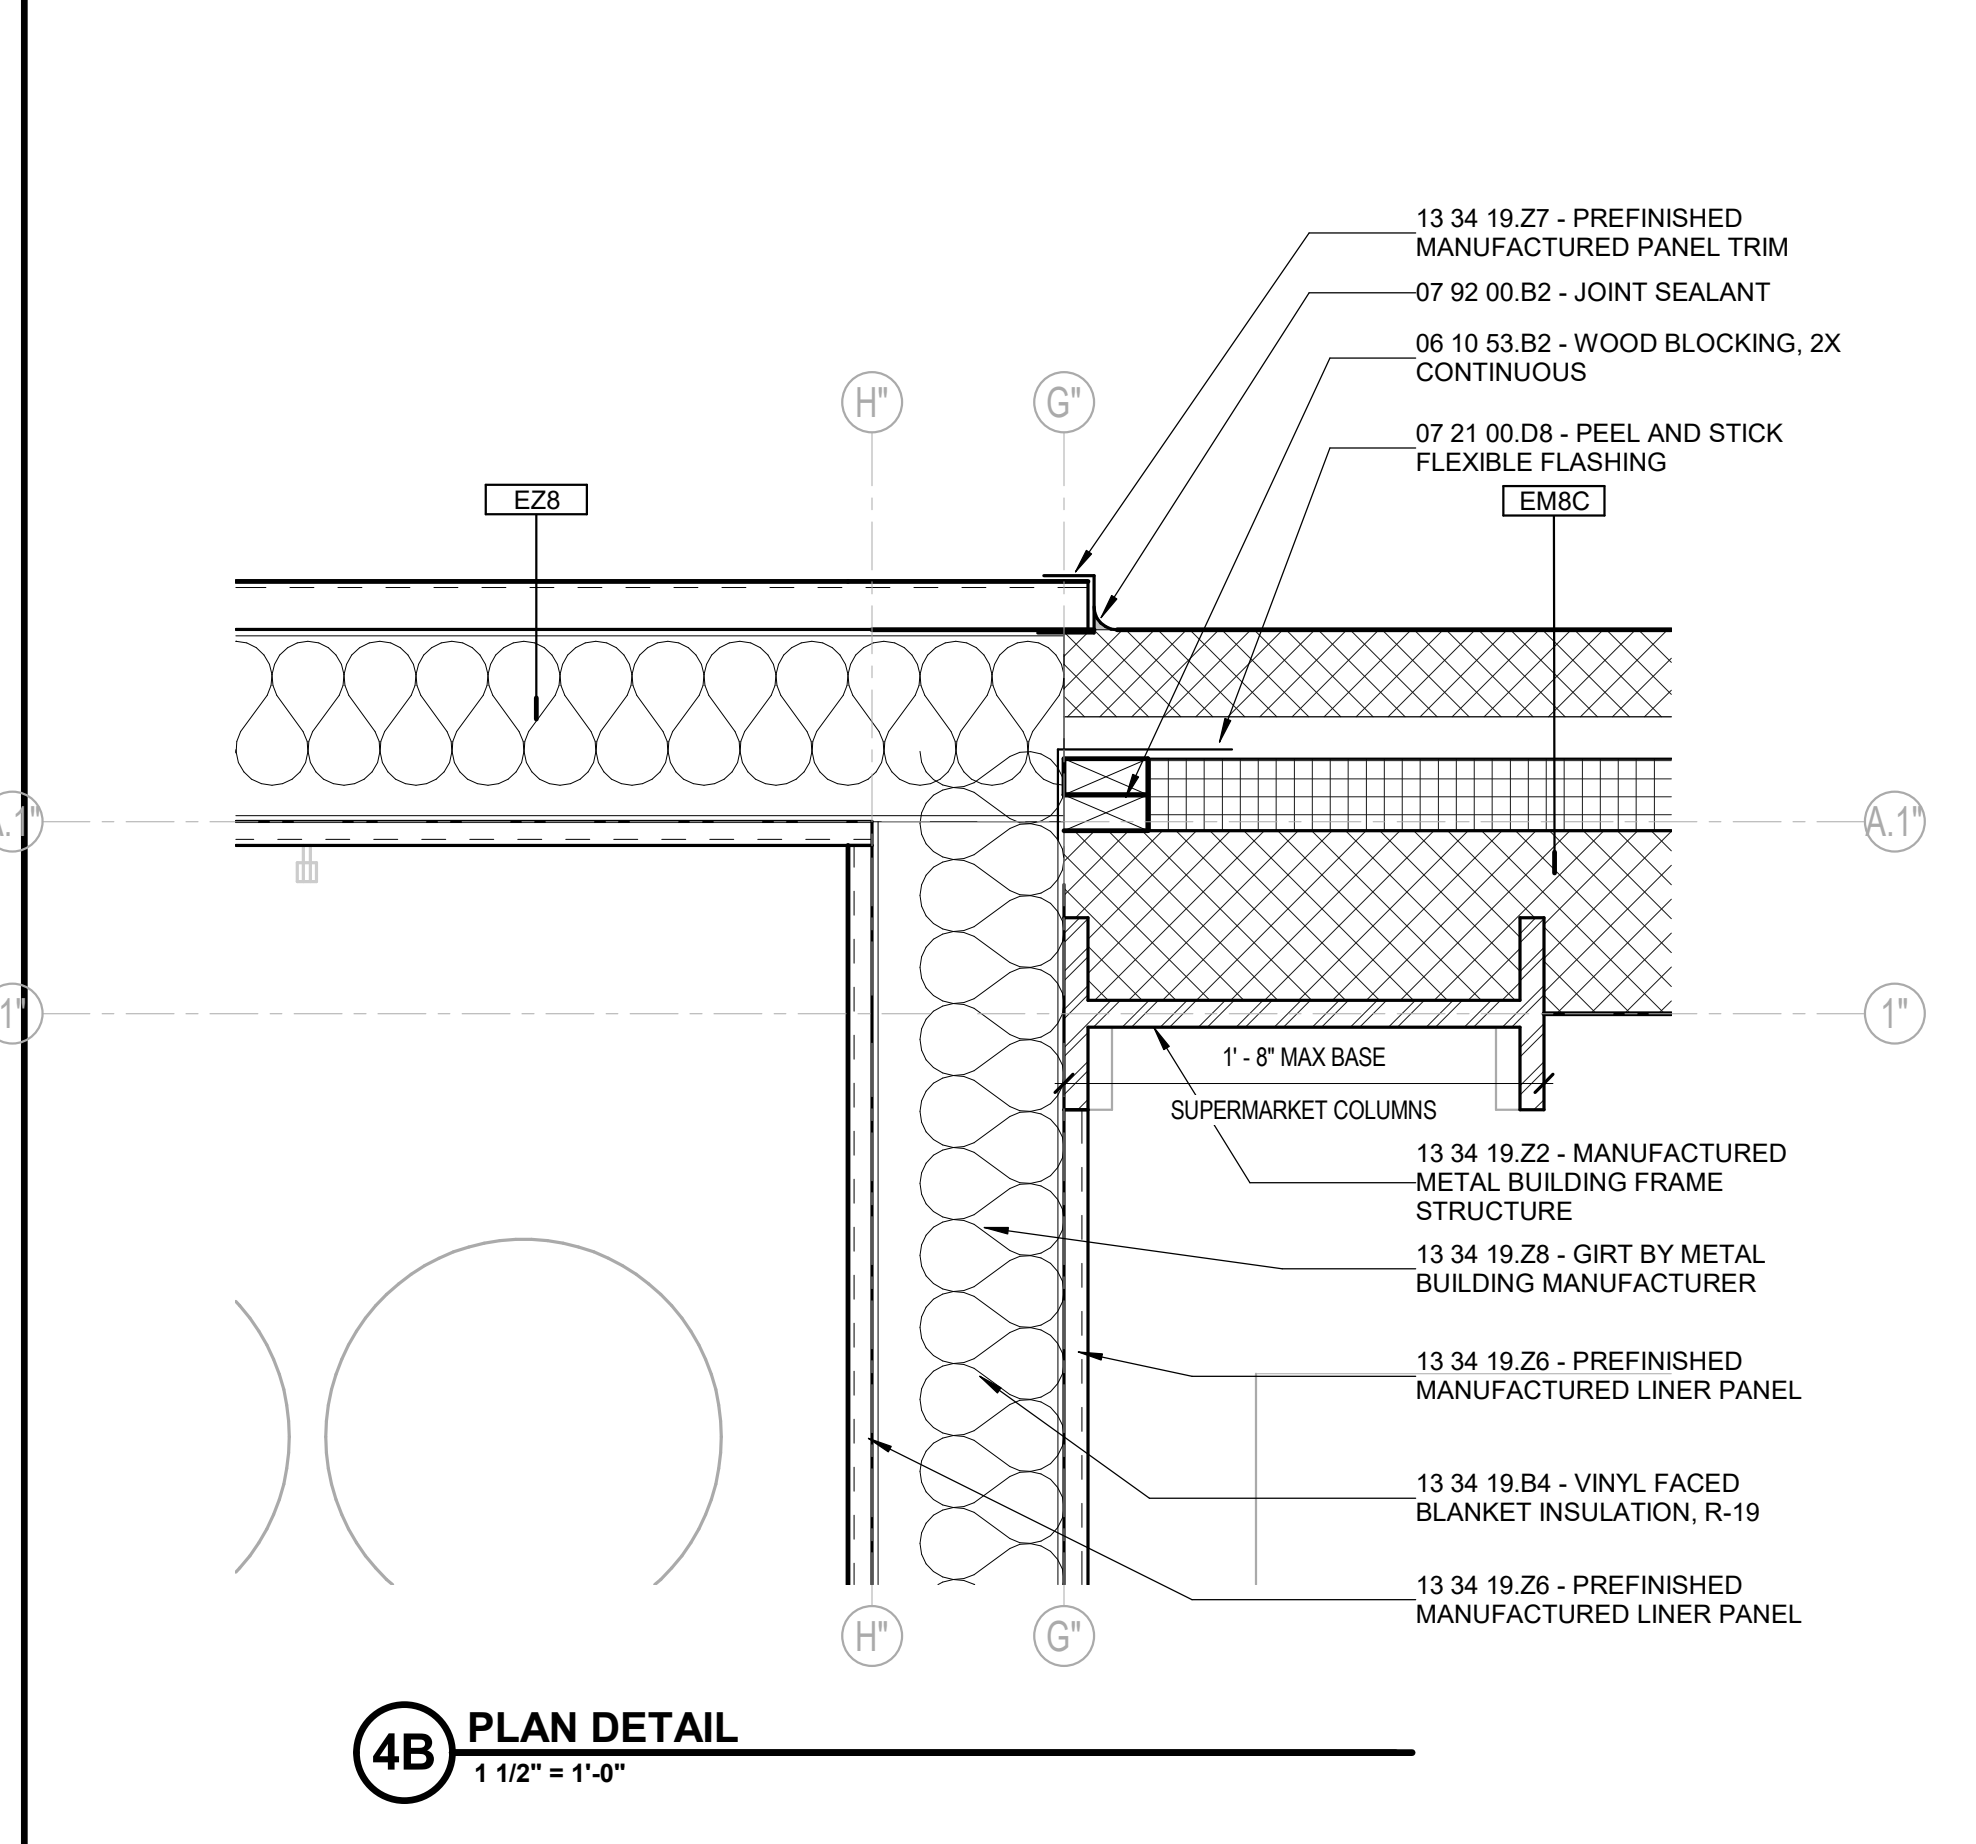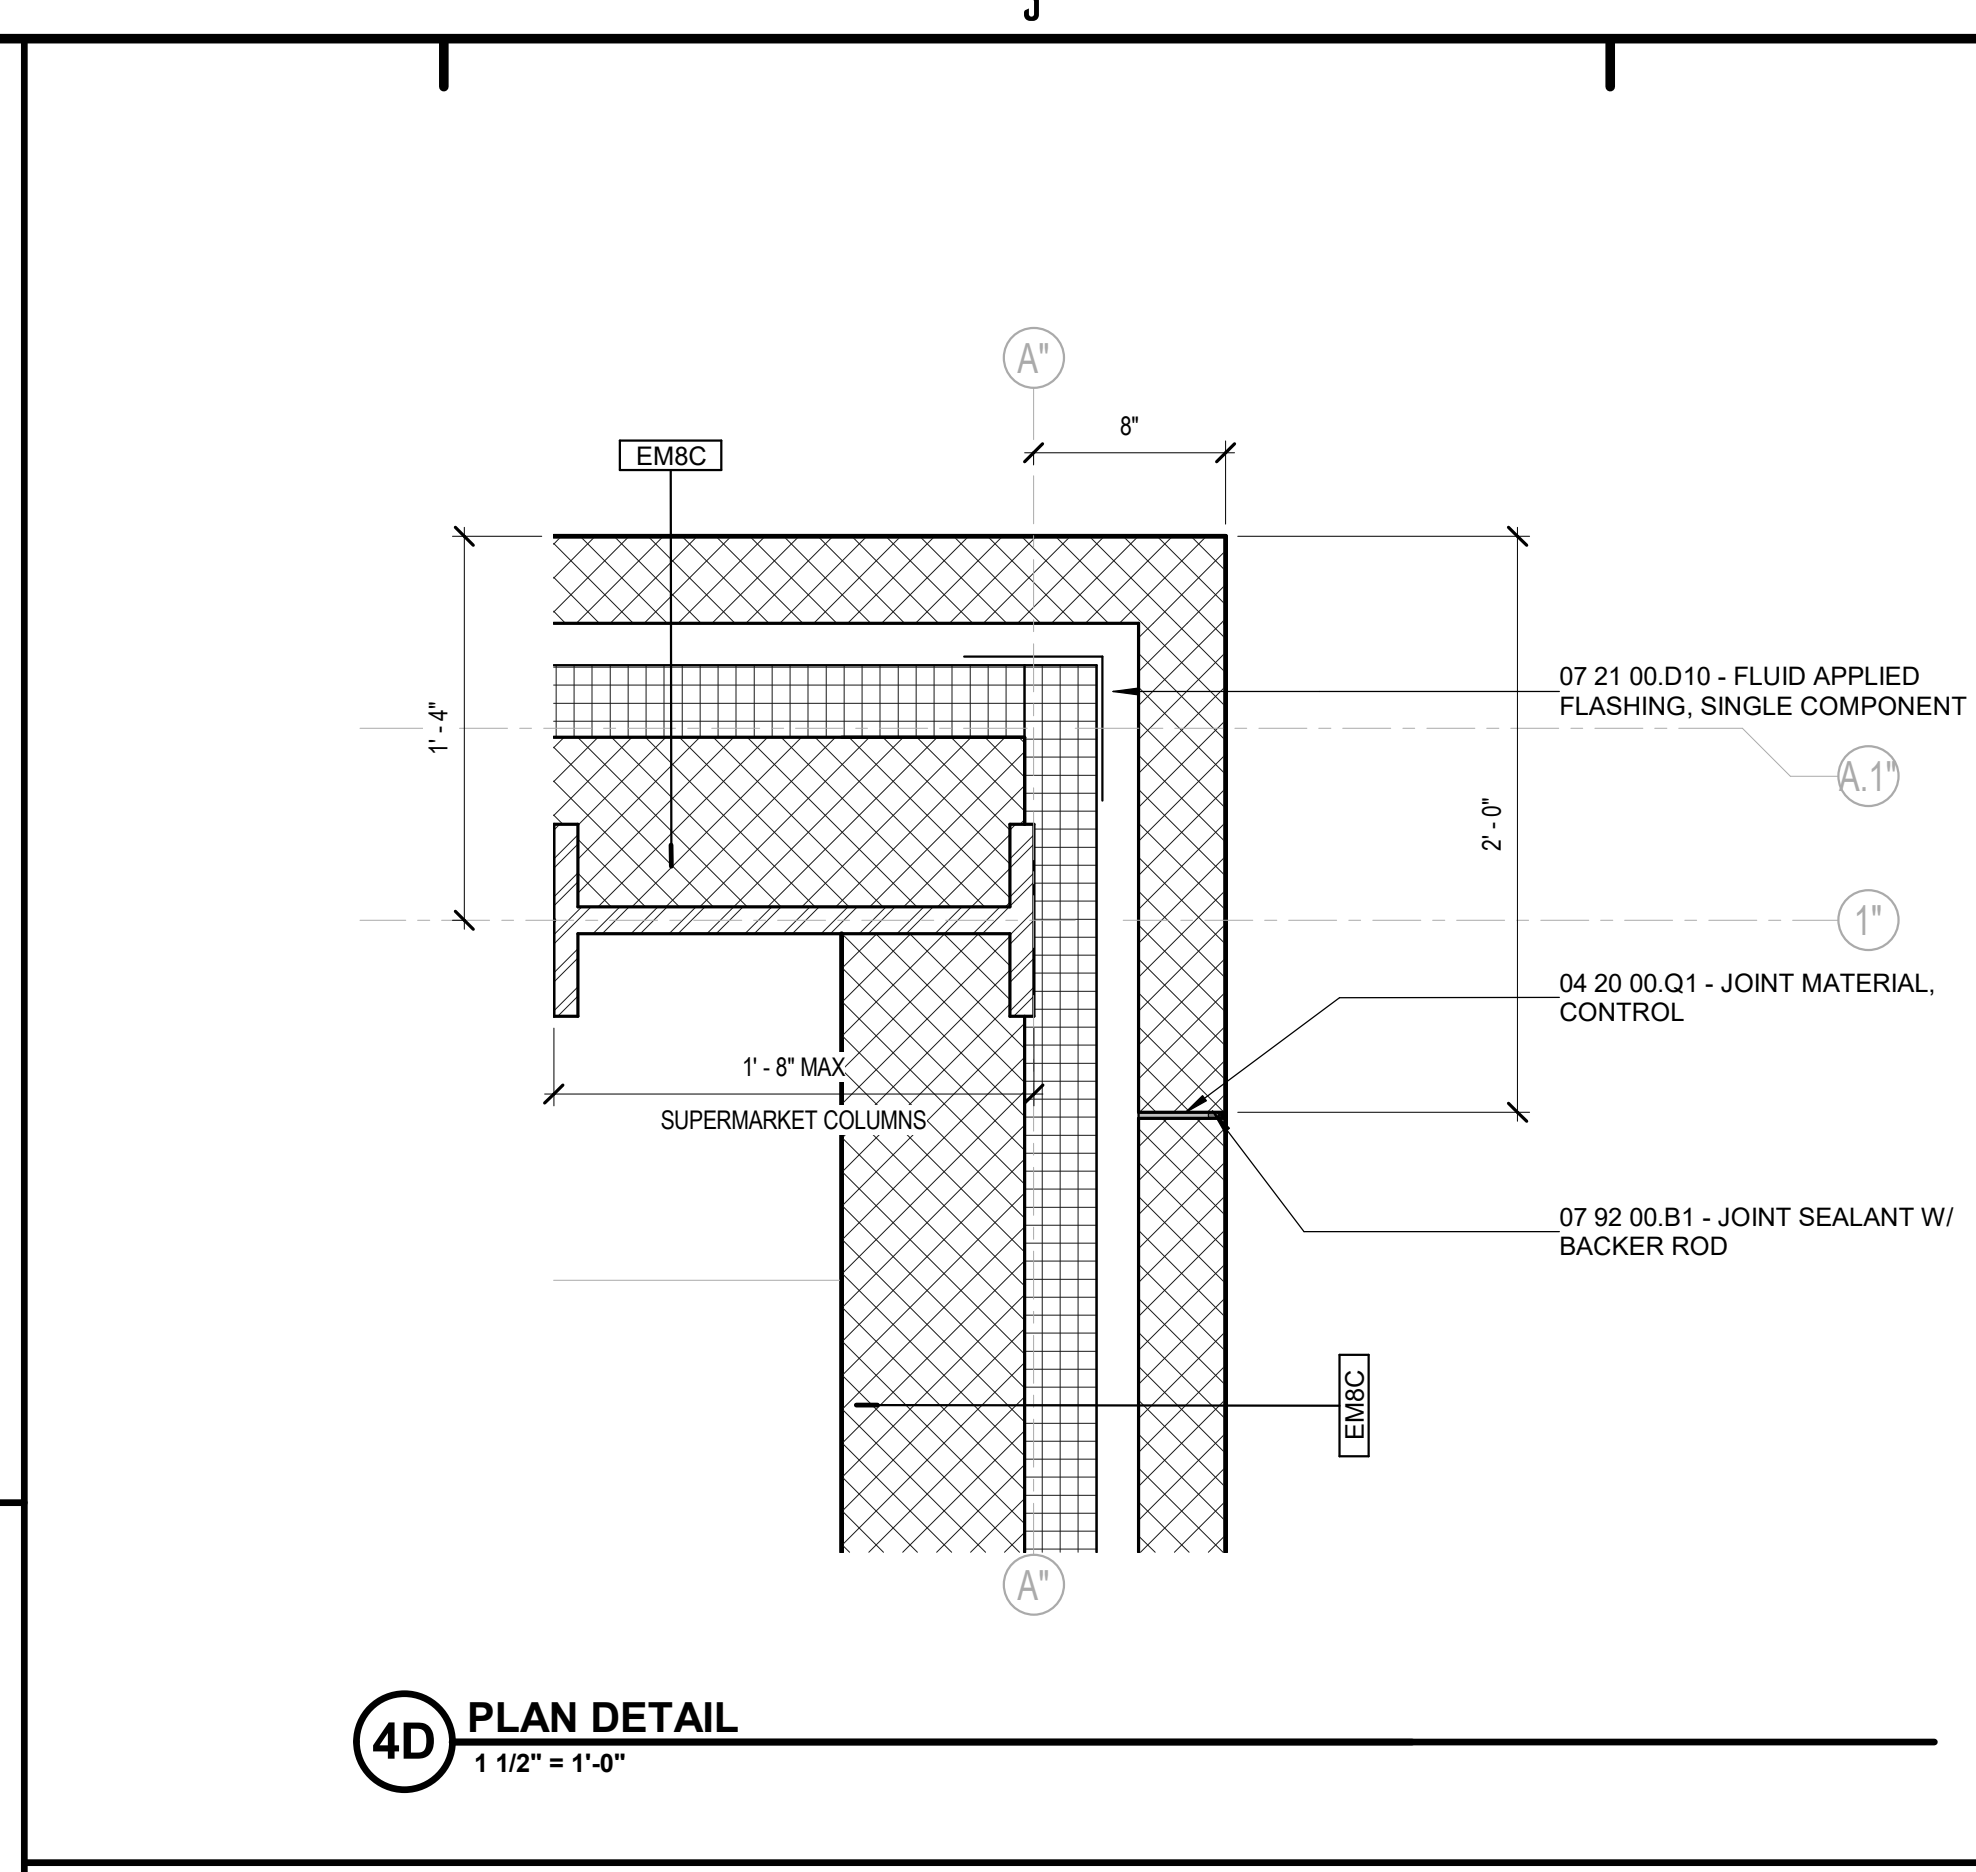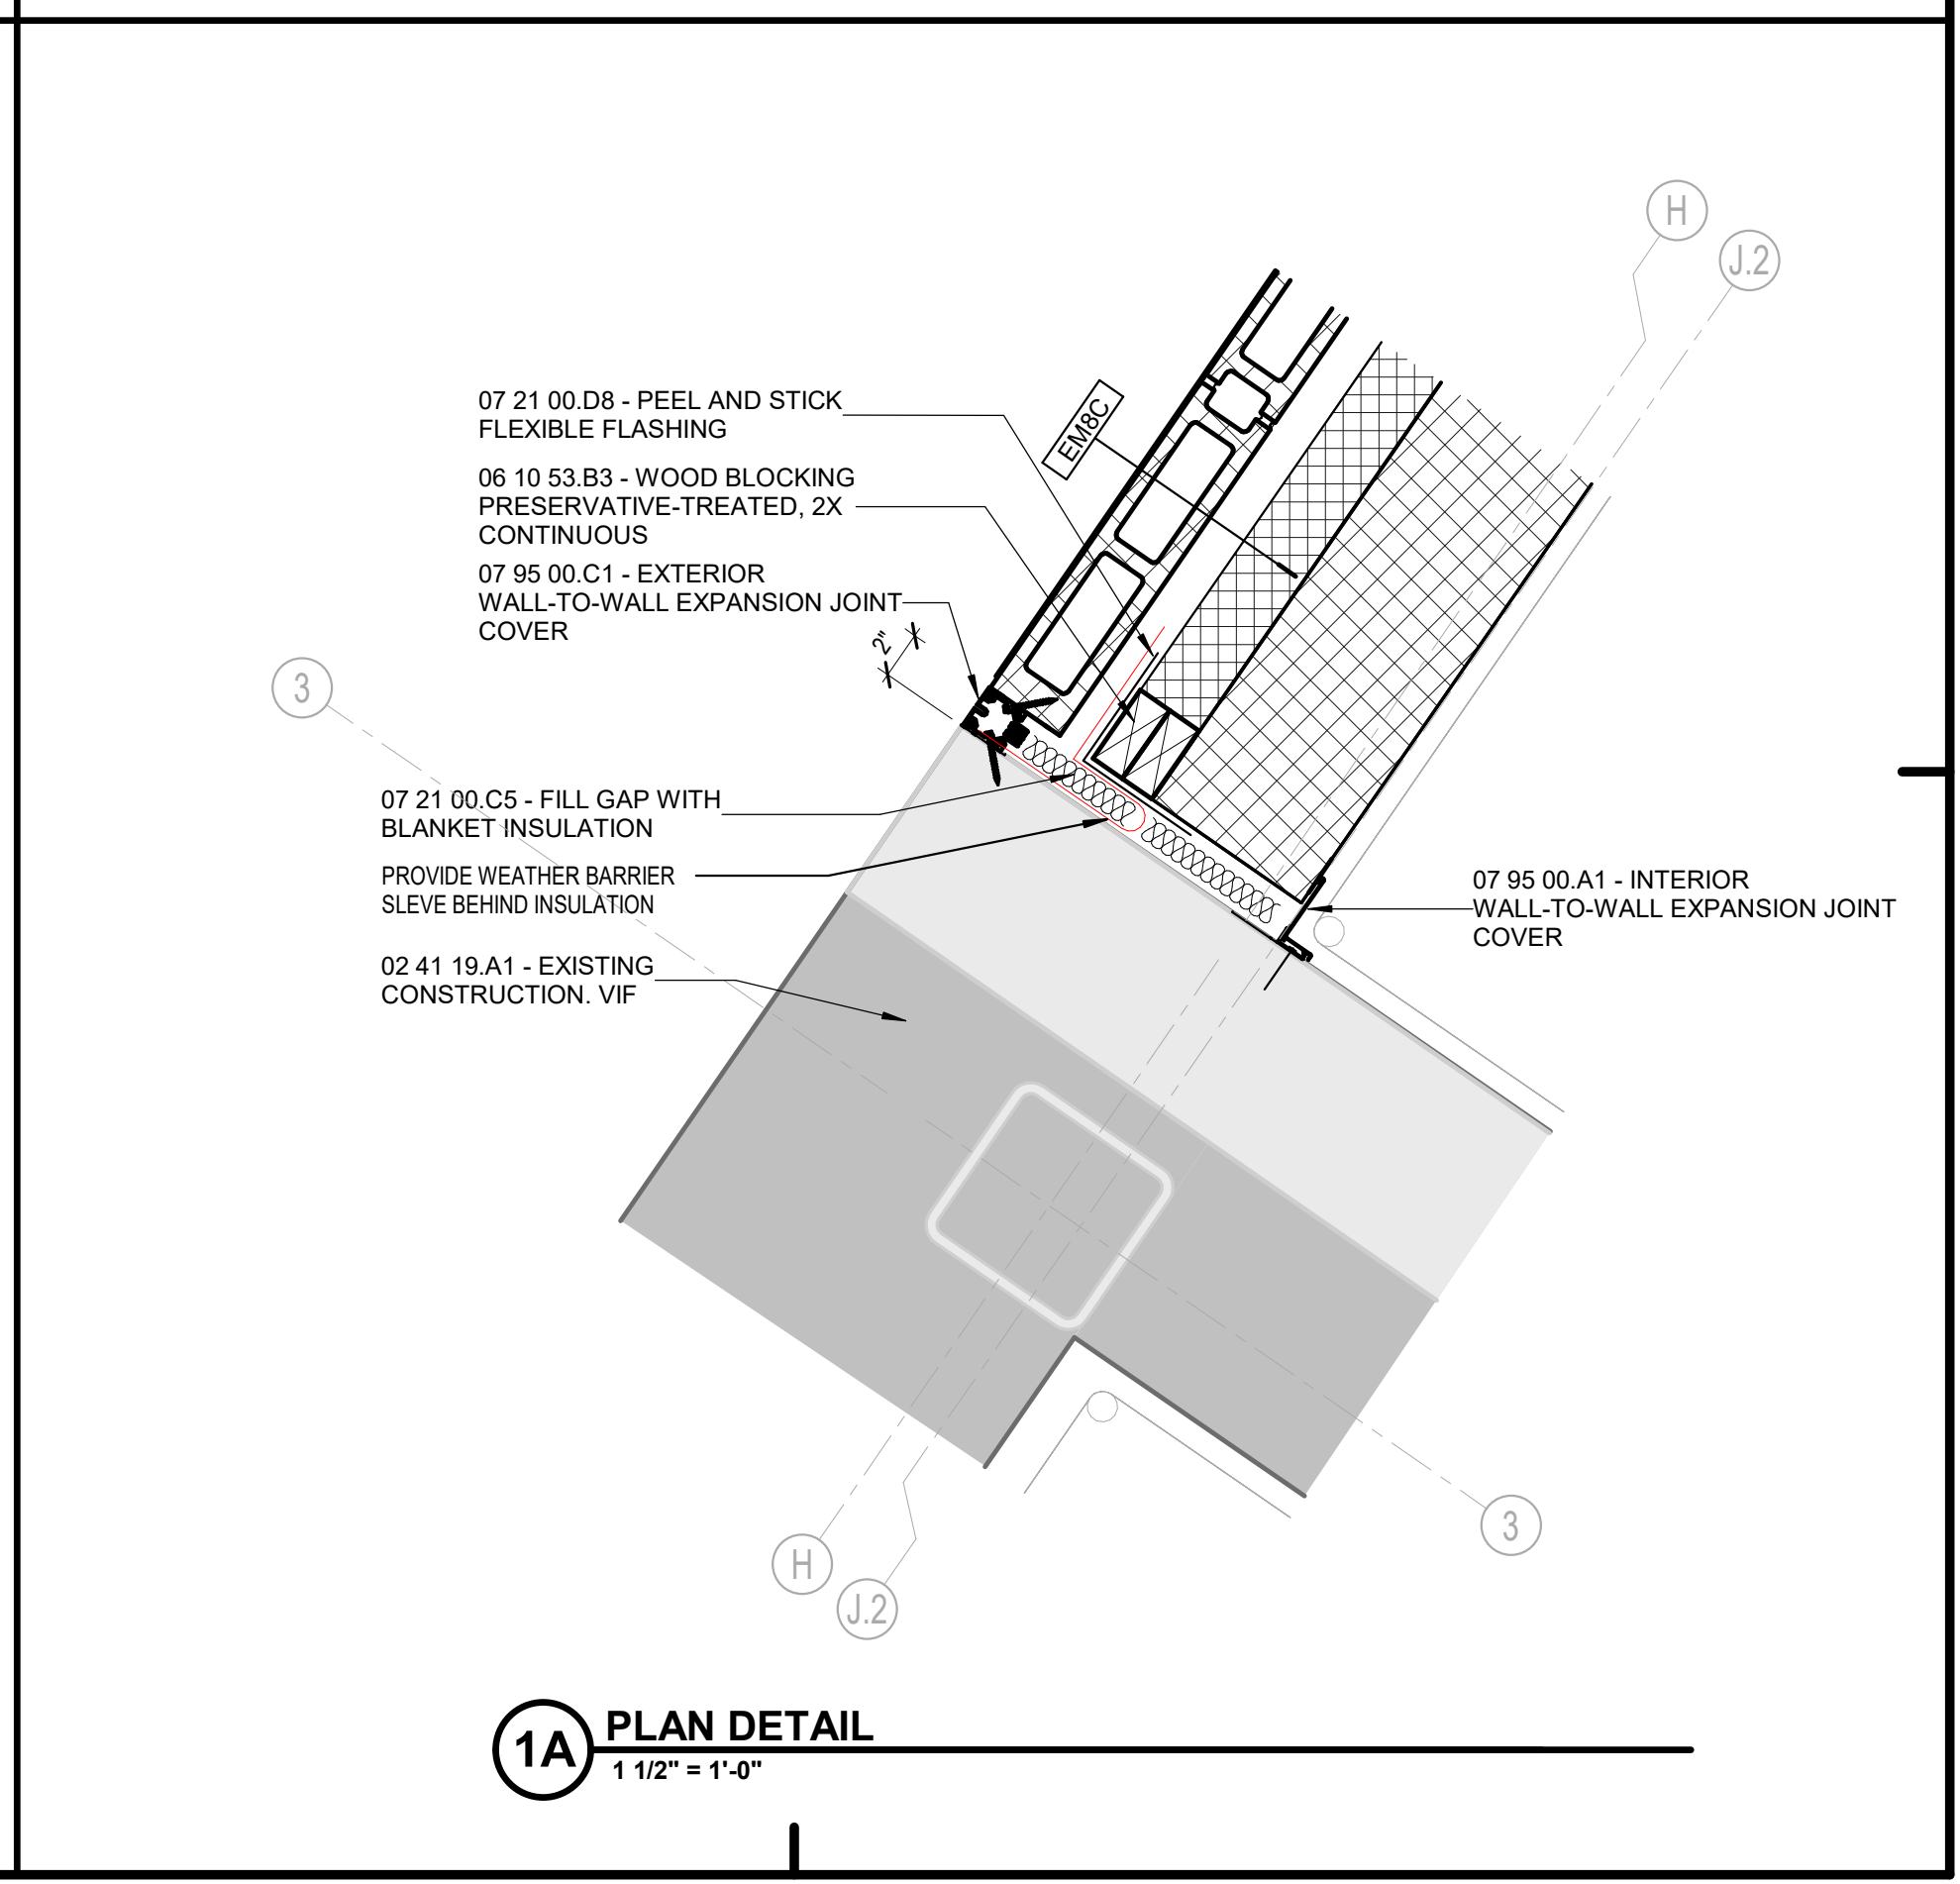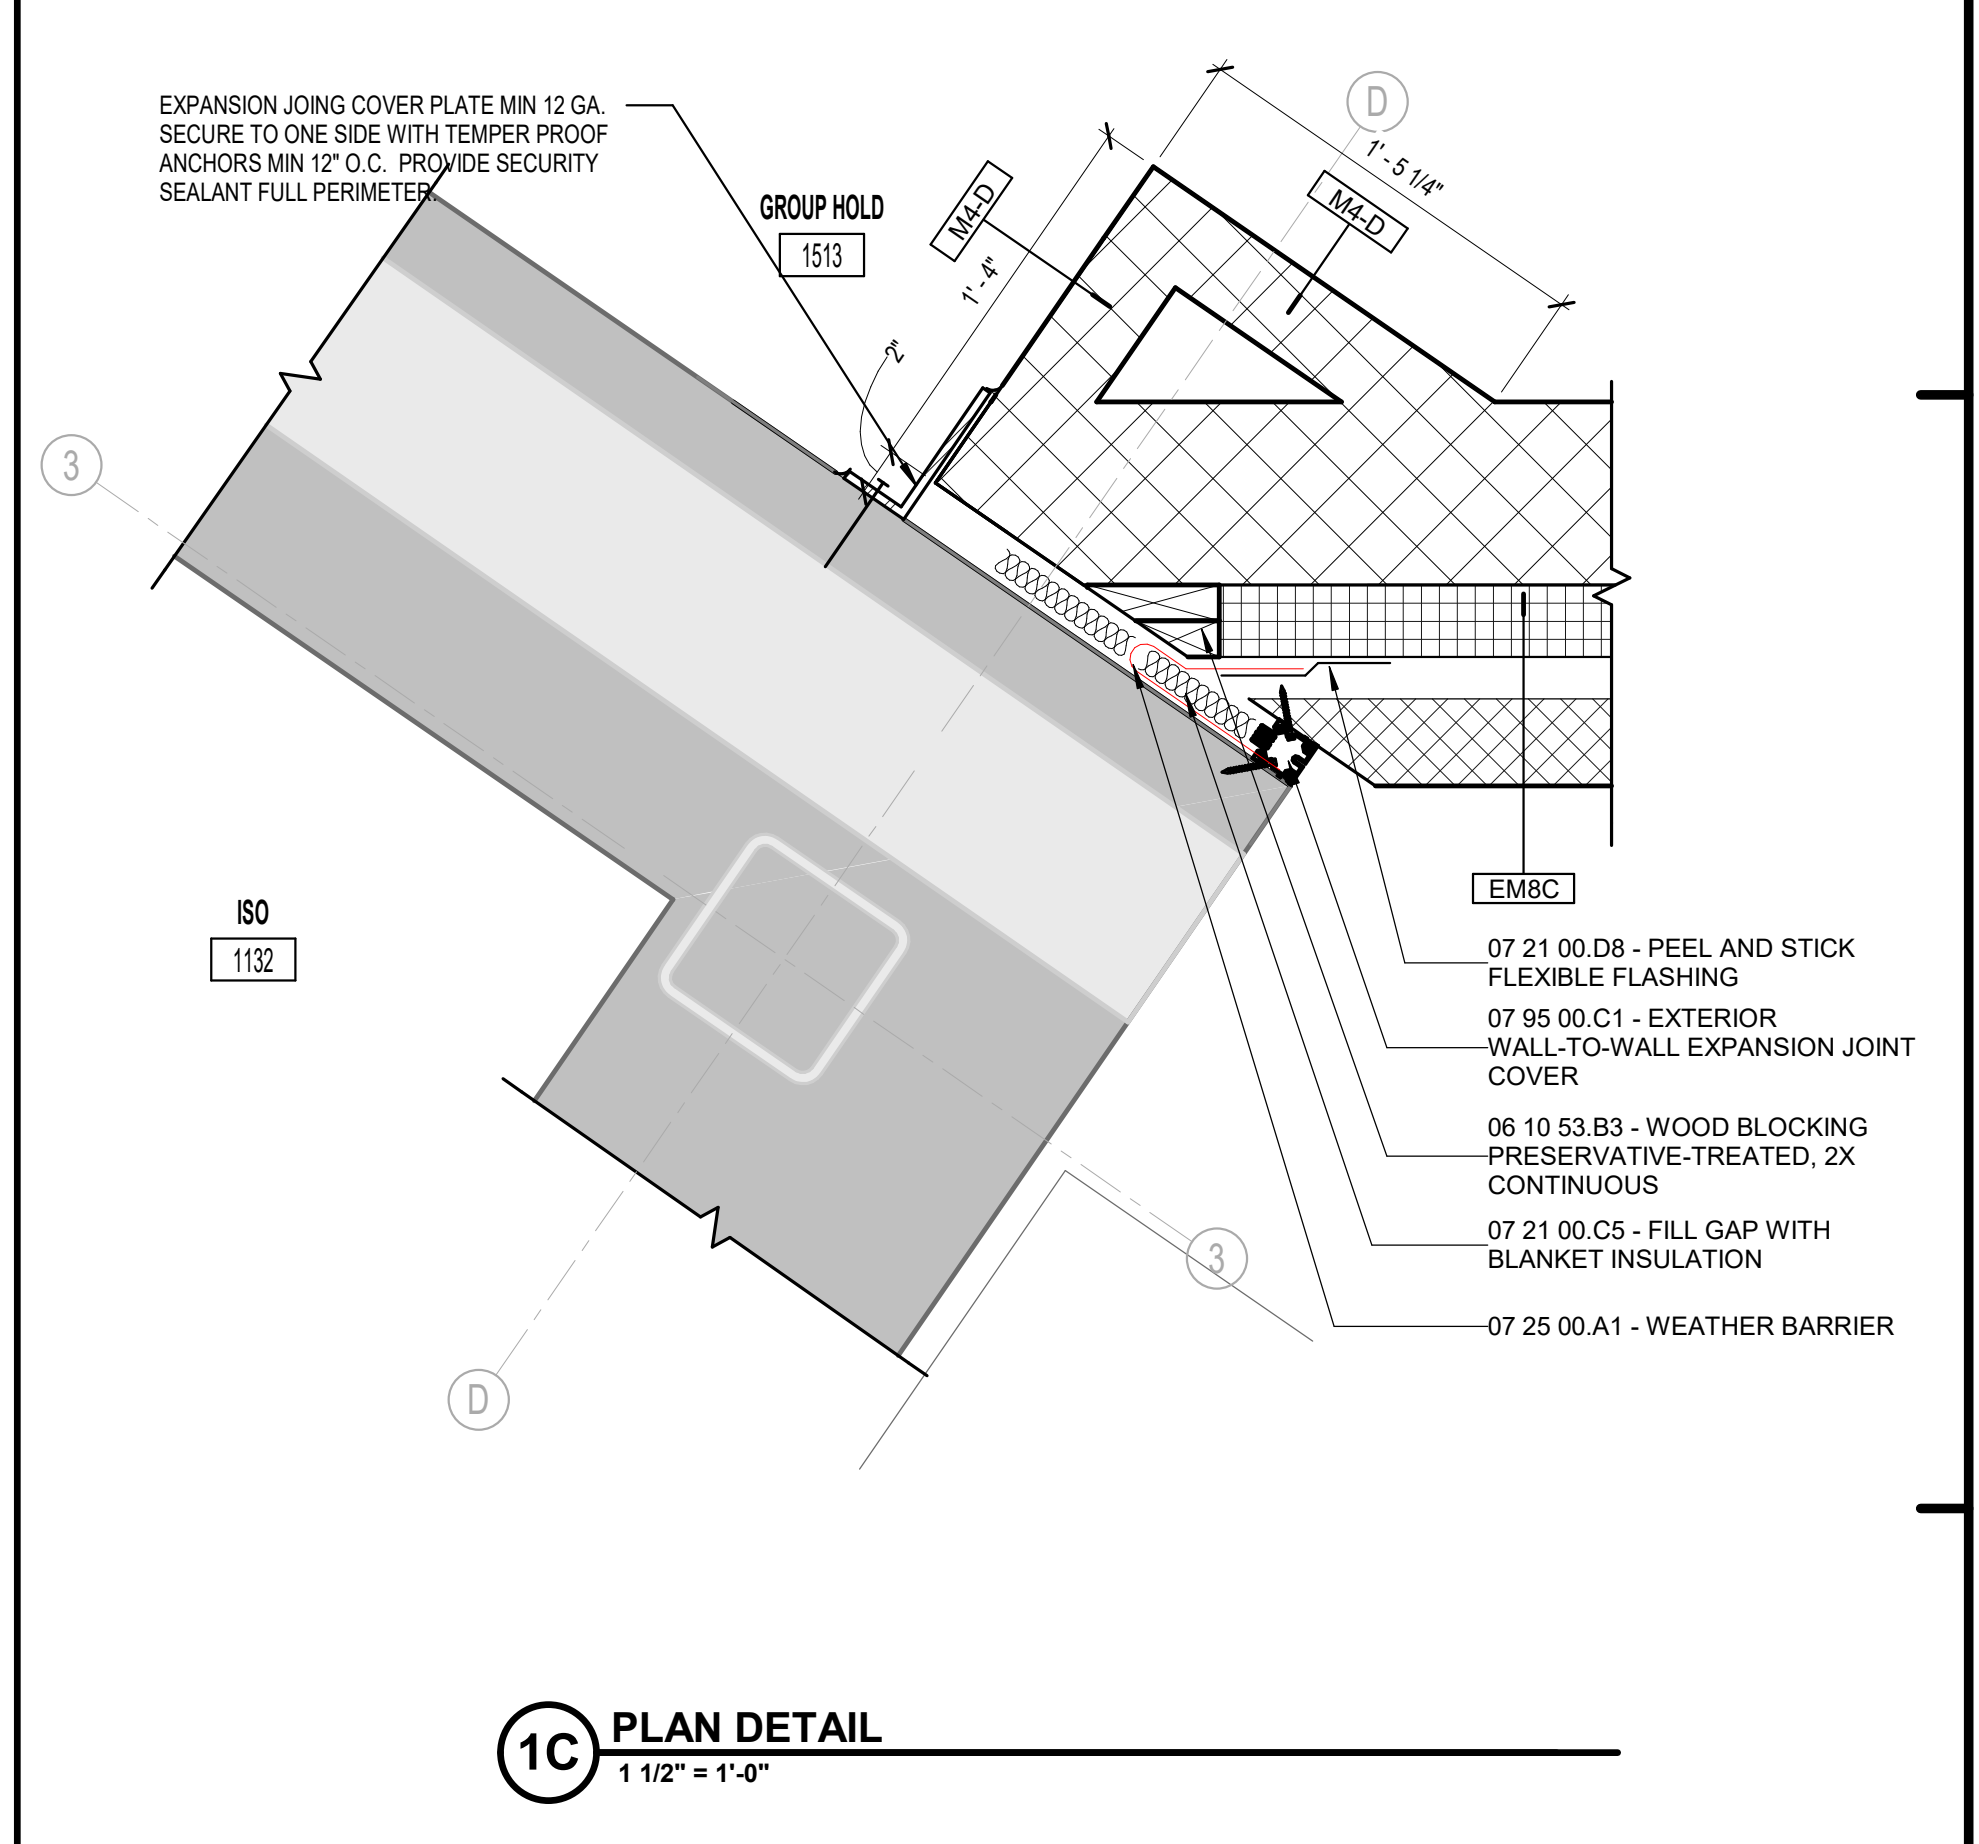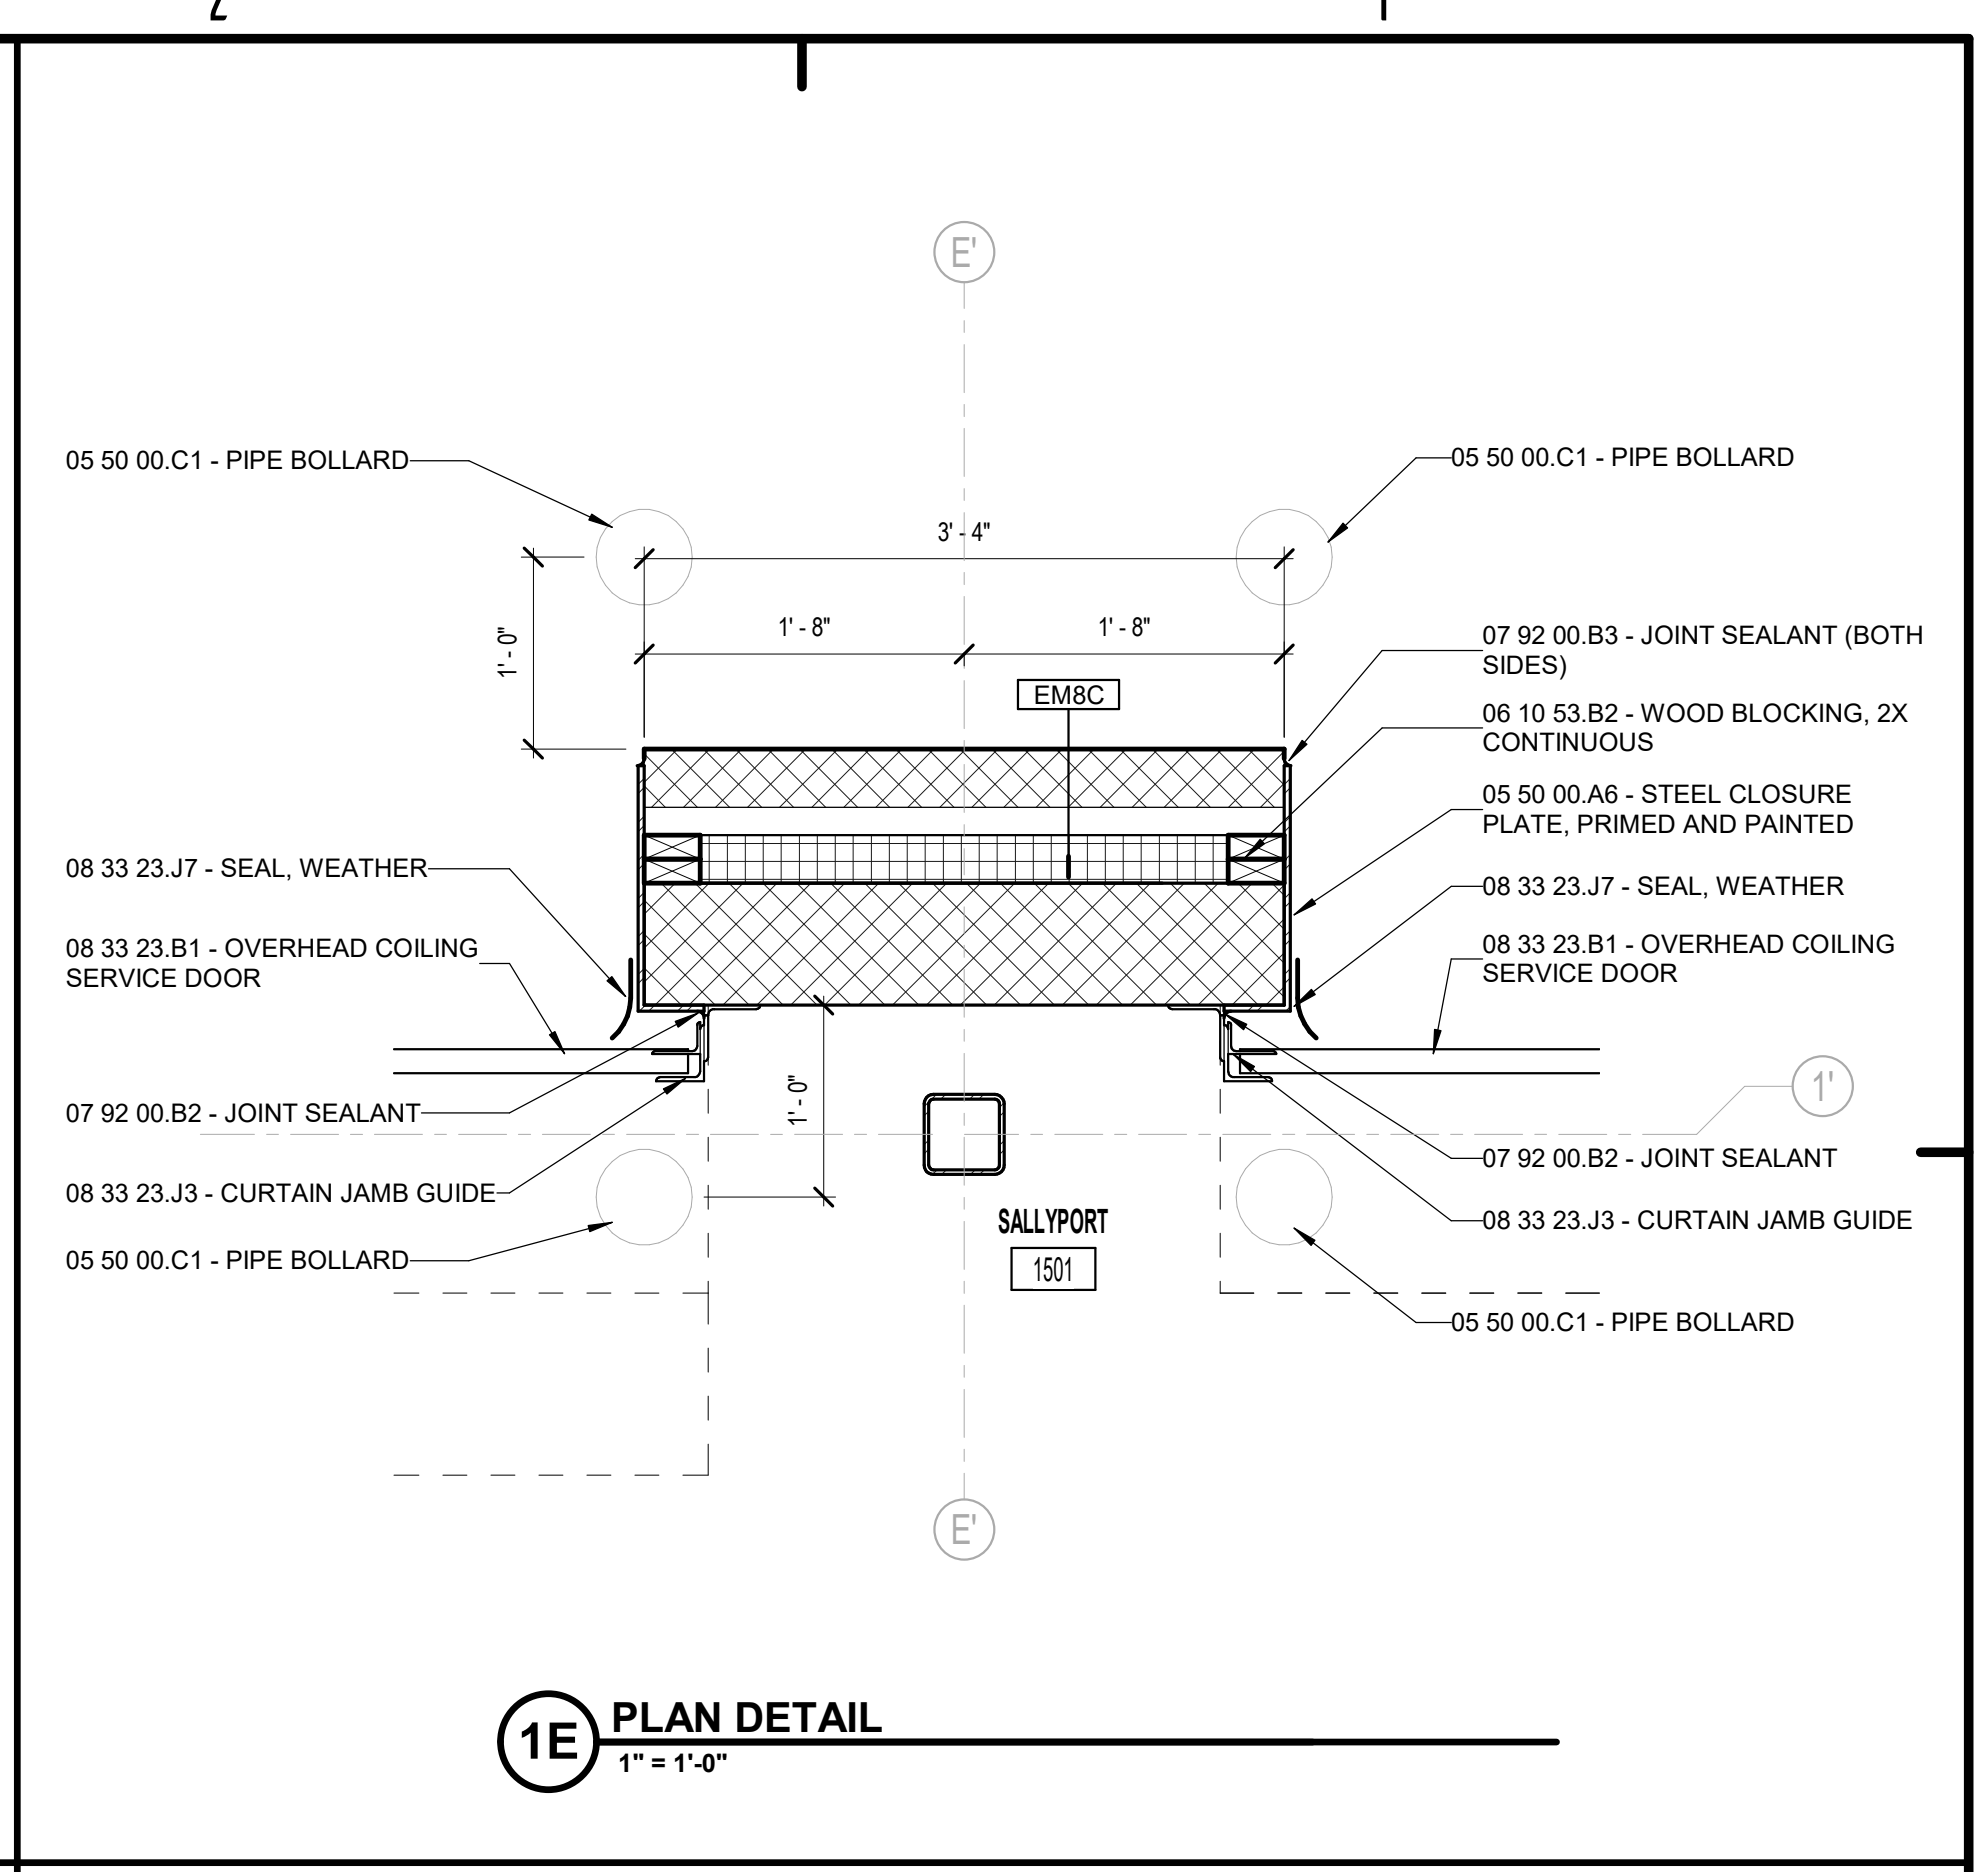KNOX COUNTY BOARD OF COMMISSIONERS  
**KNOX COUNTY JUSTICE CAMPUS**  
2375 OLD DECKER RD. VINCENNES, IN 47591


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Designed By: Designer  
Drawn By: Author  
Checked By: Checker  
Date: 01.28.2022

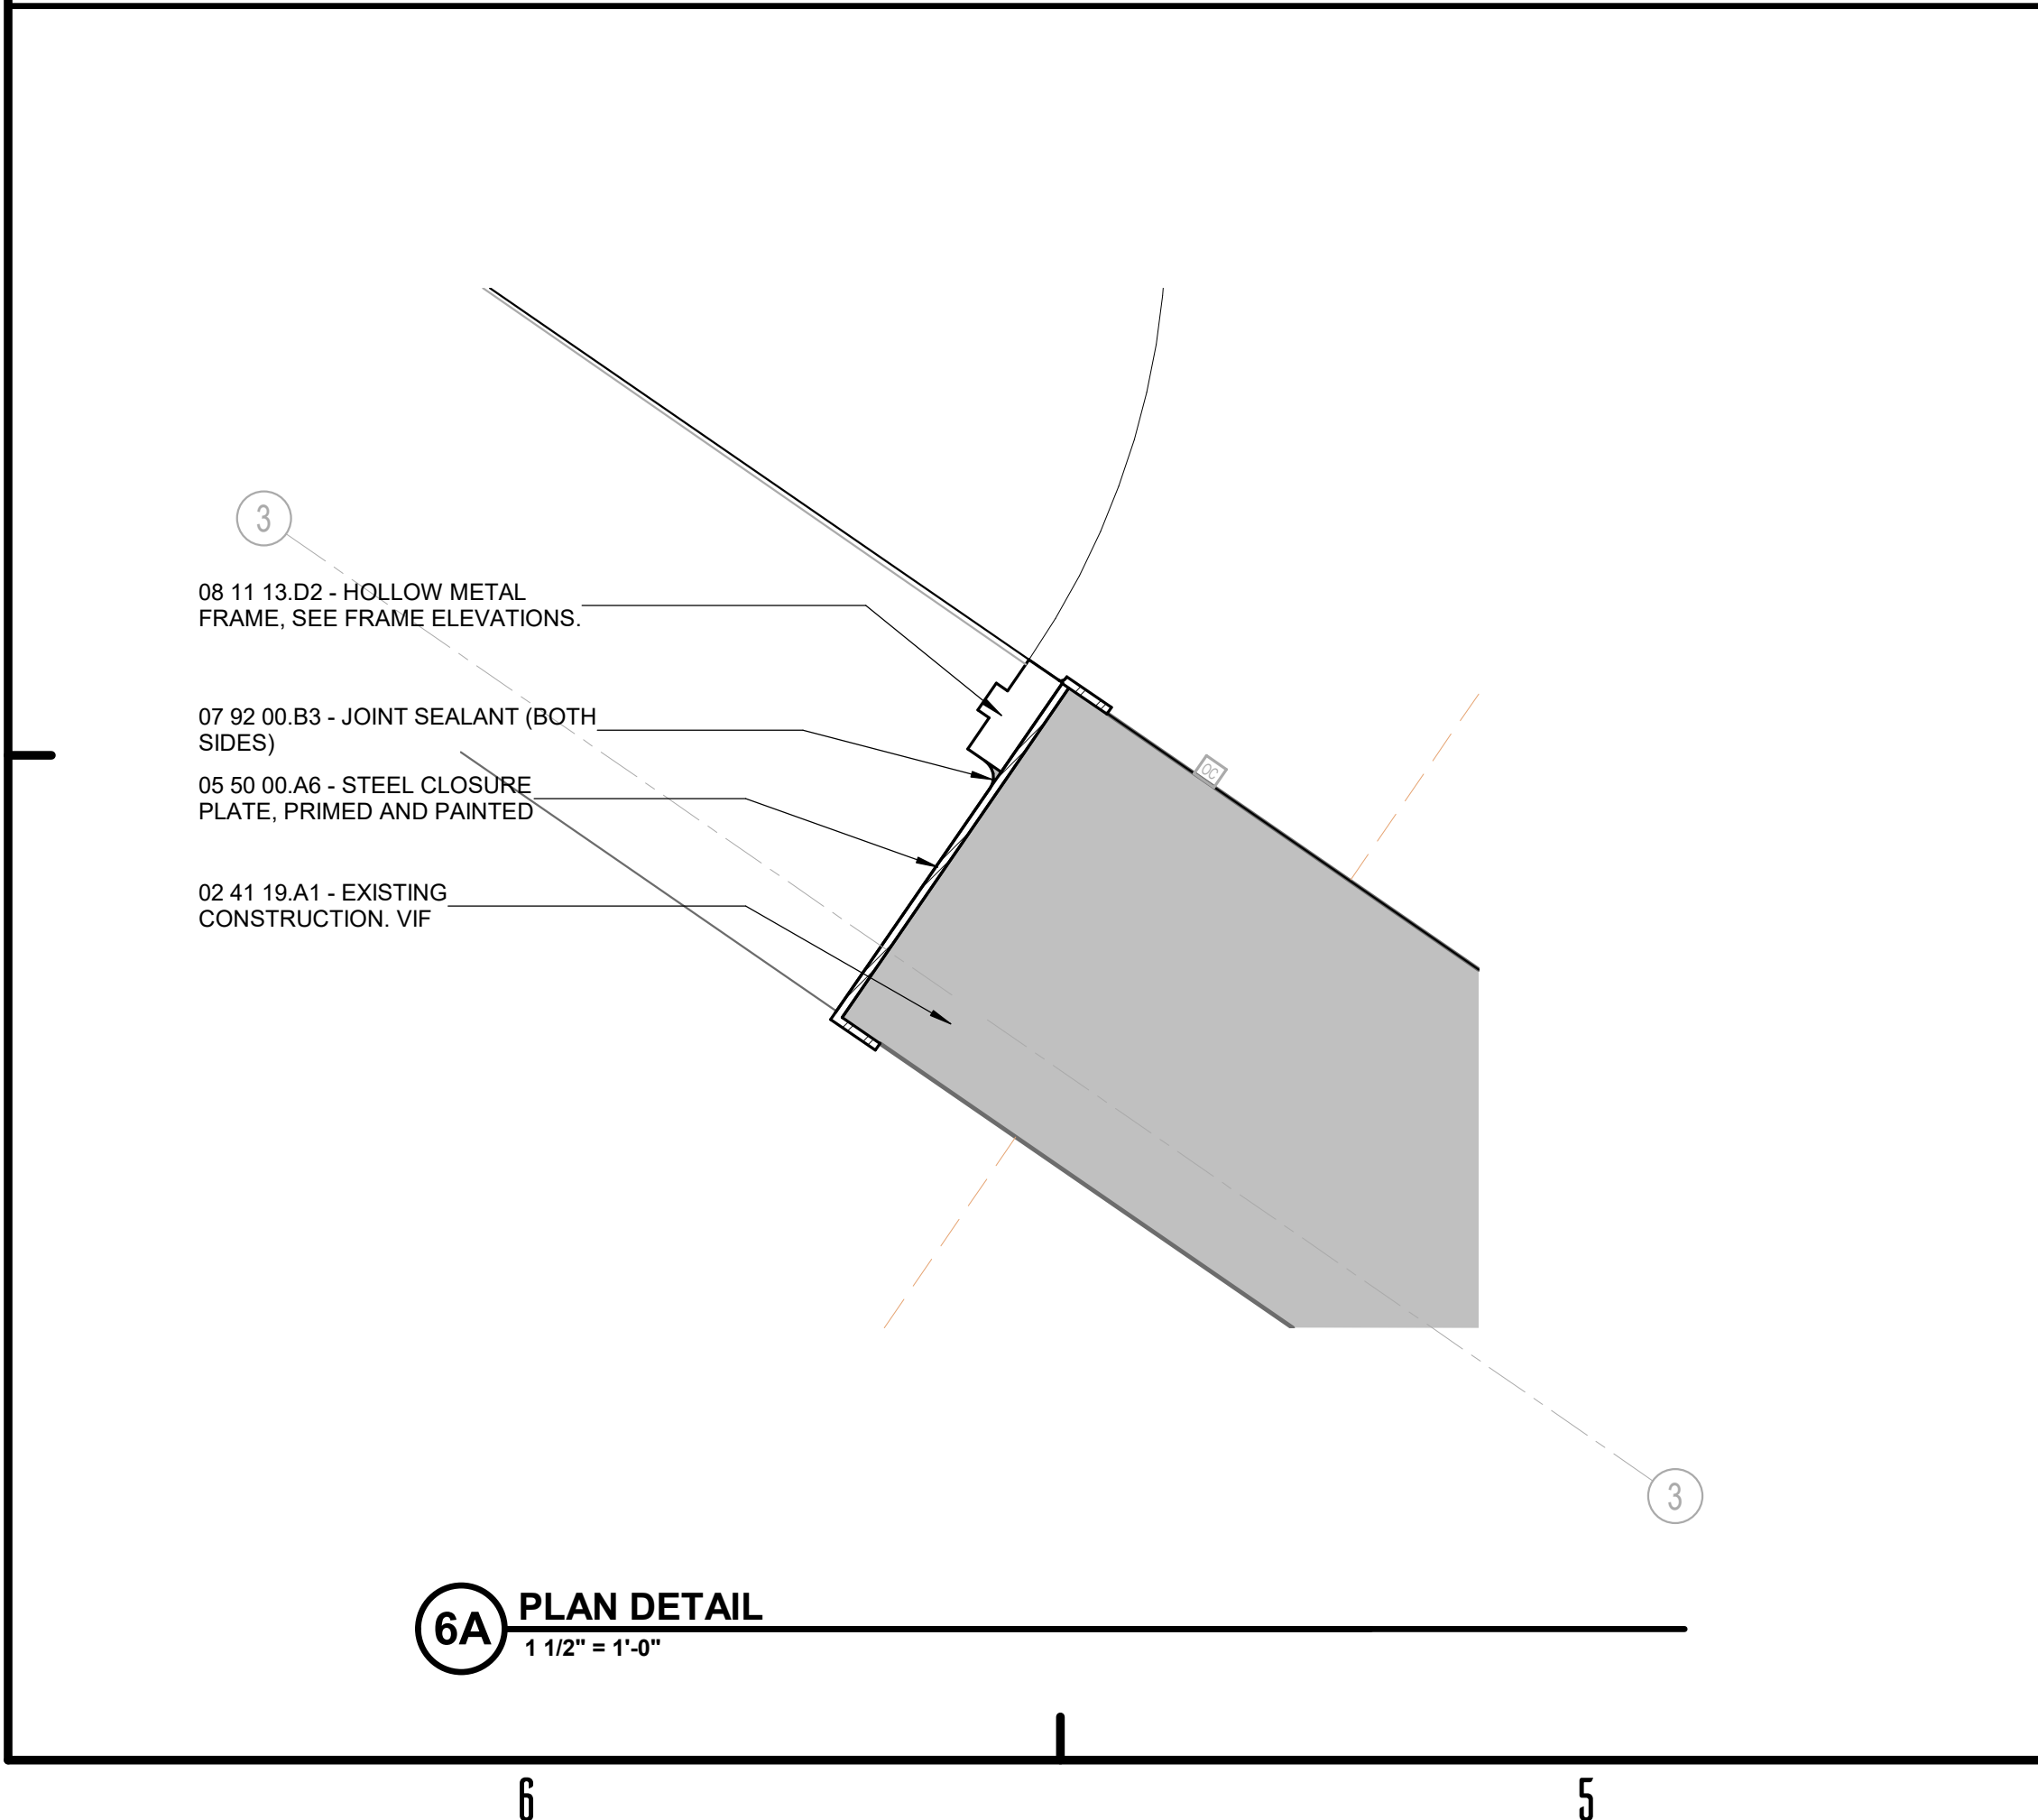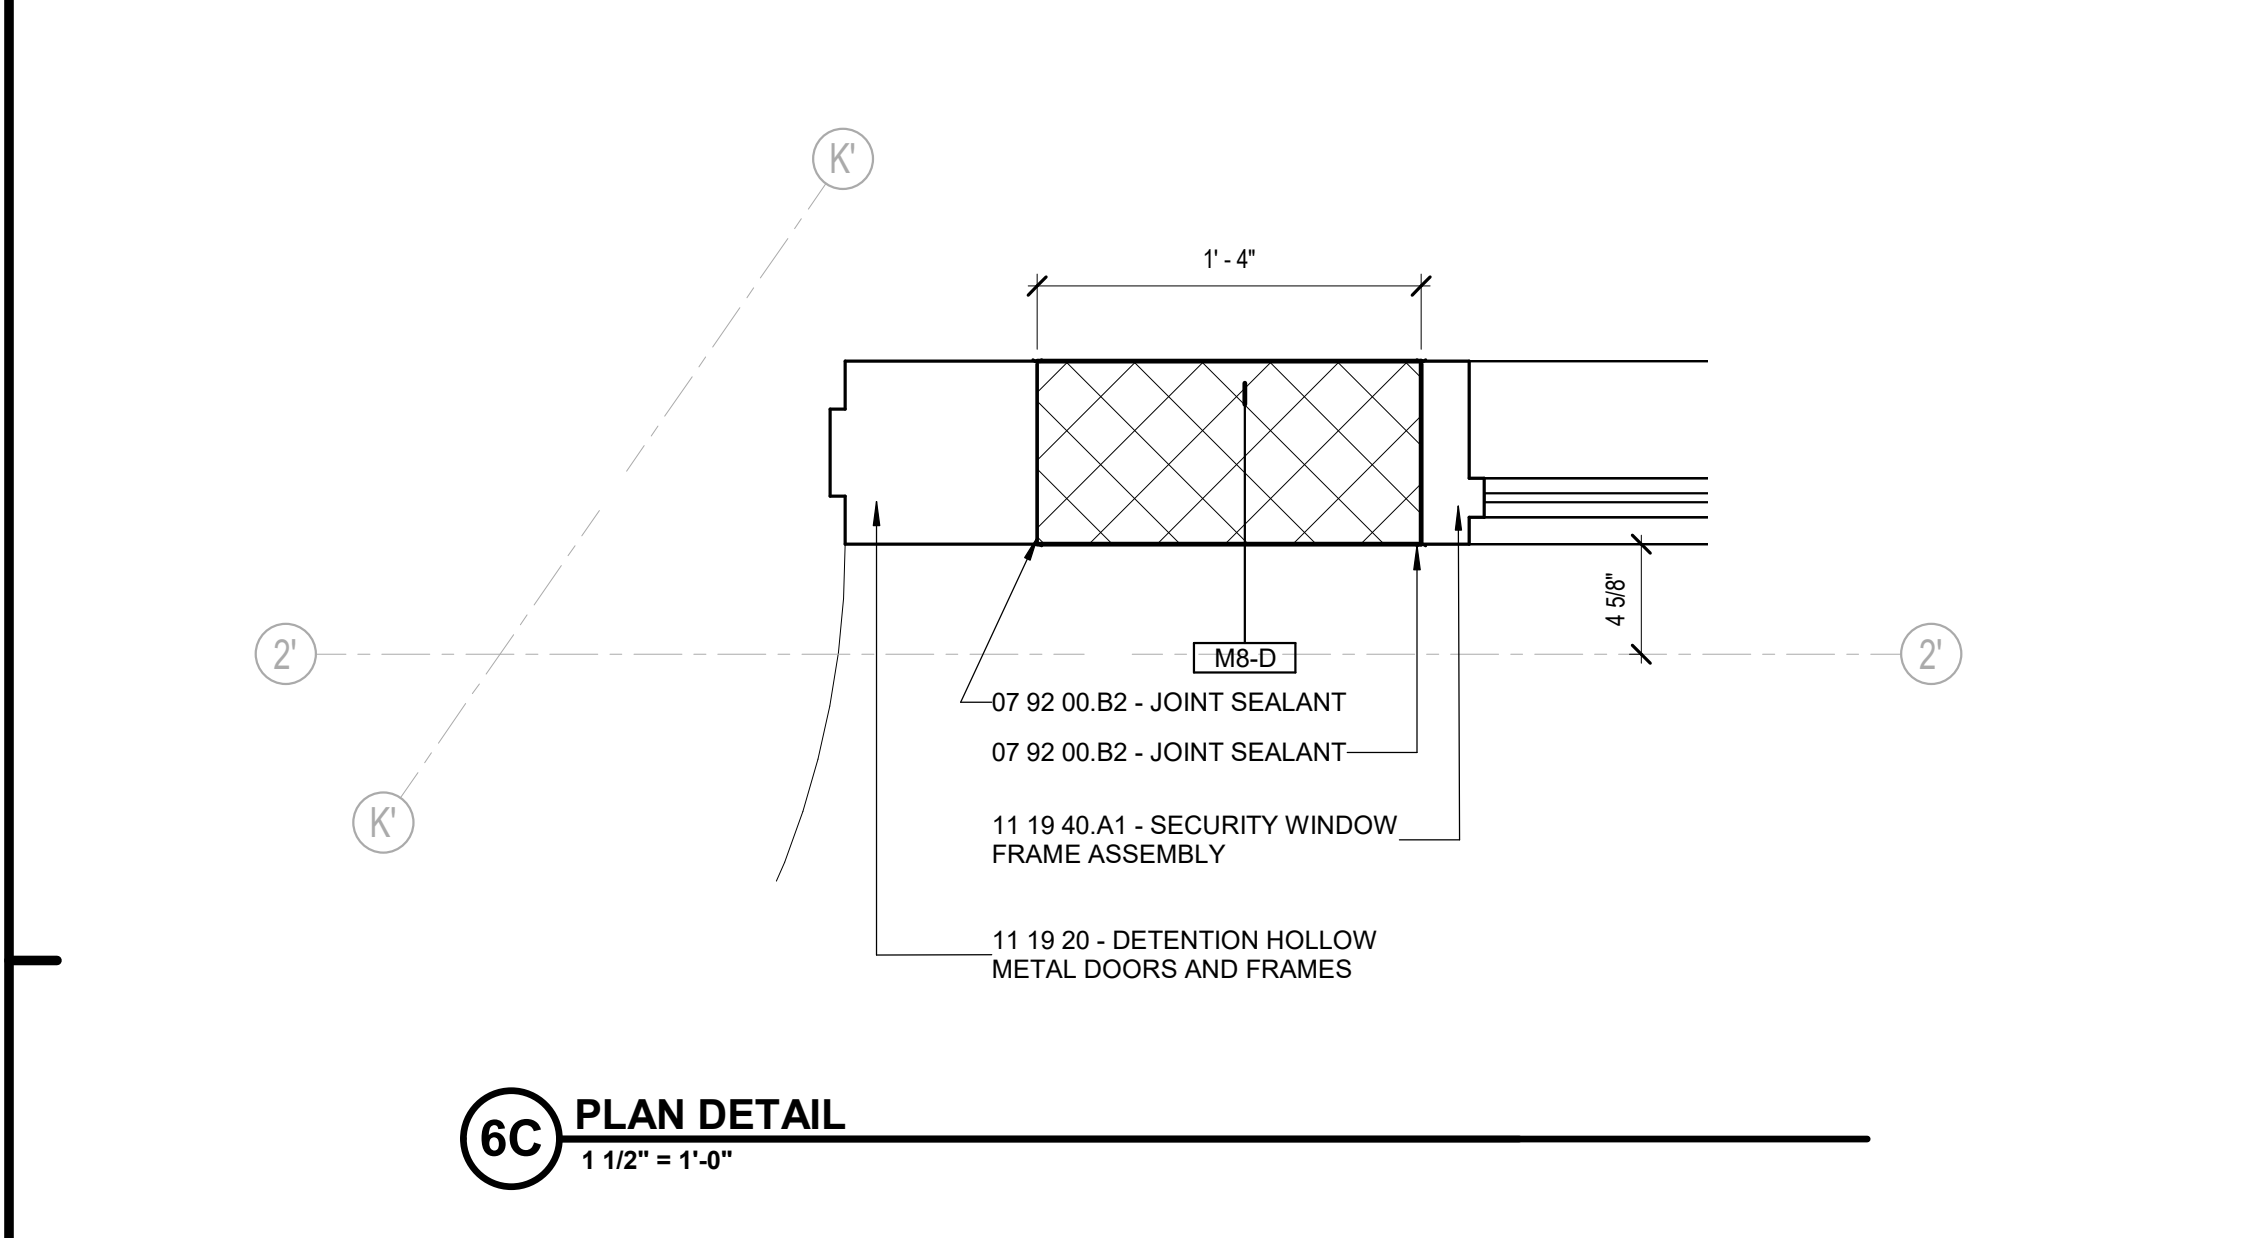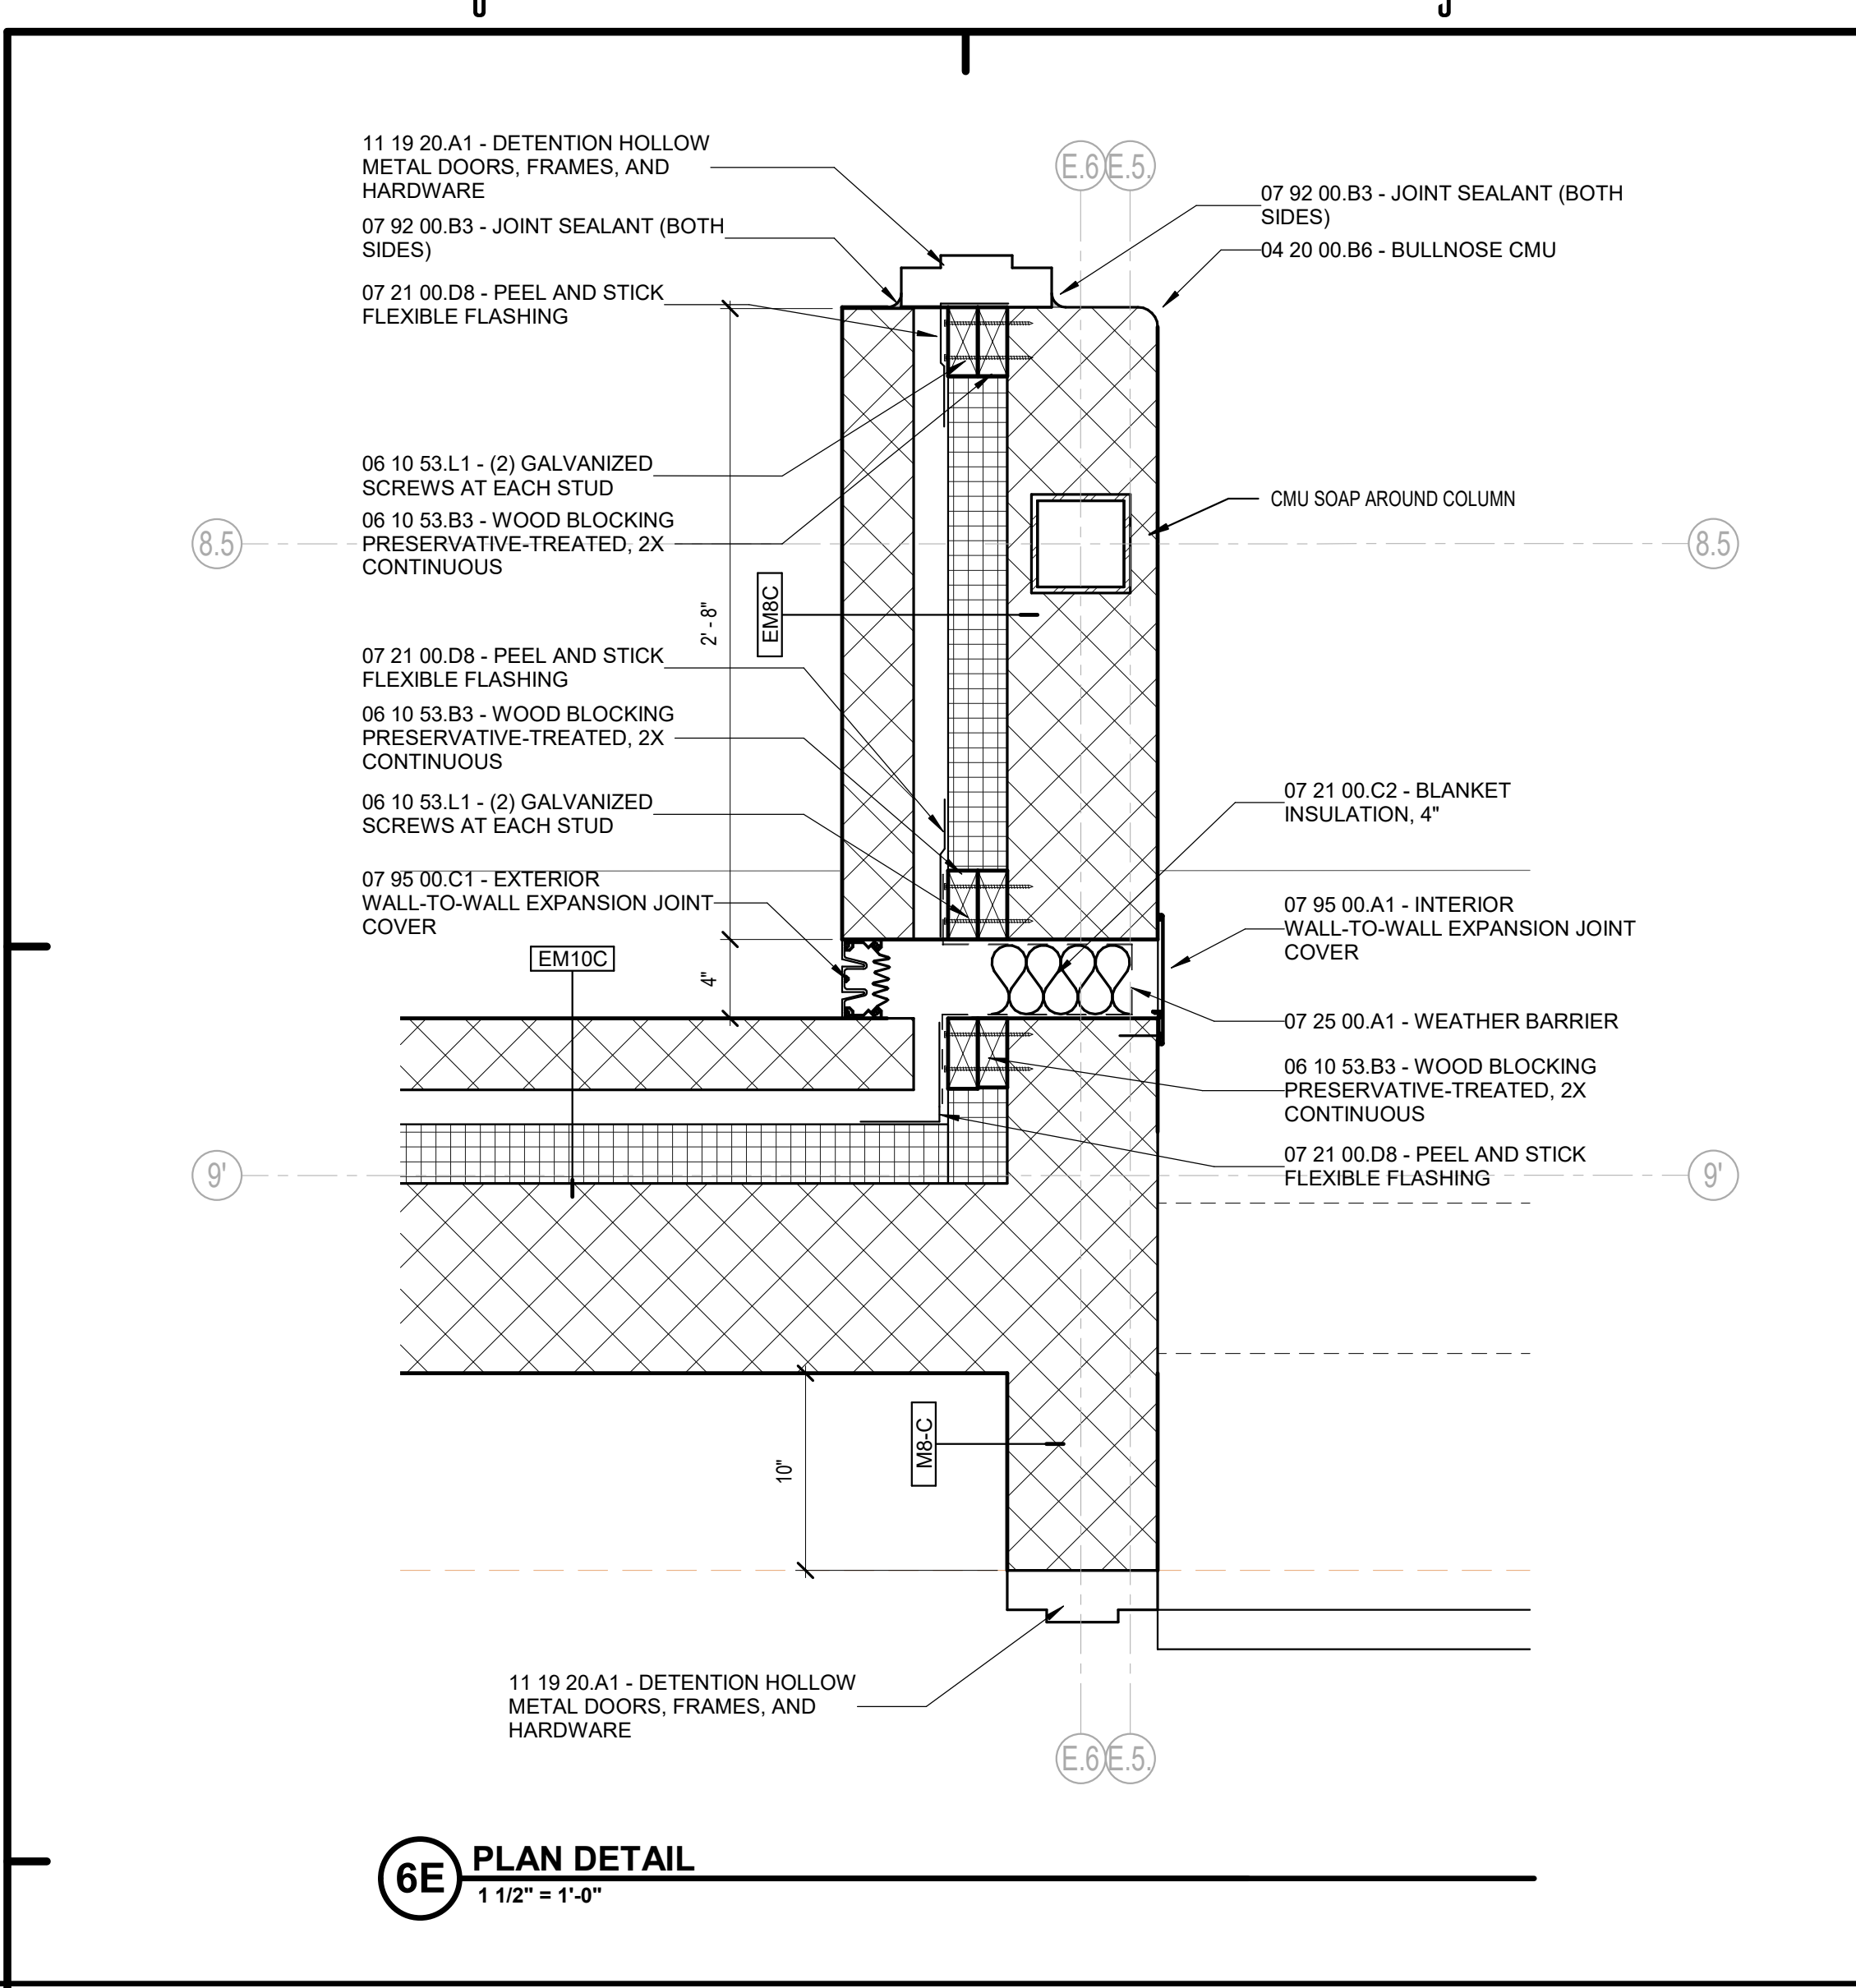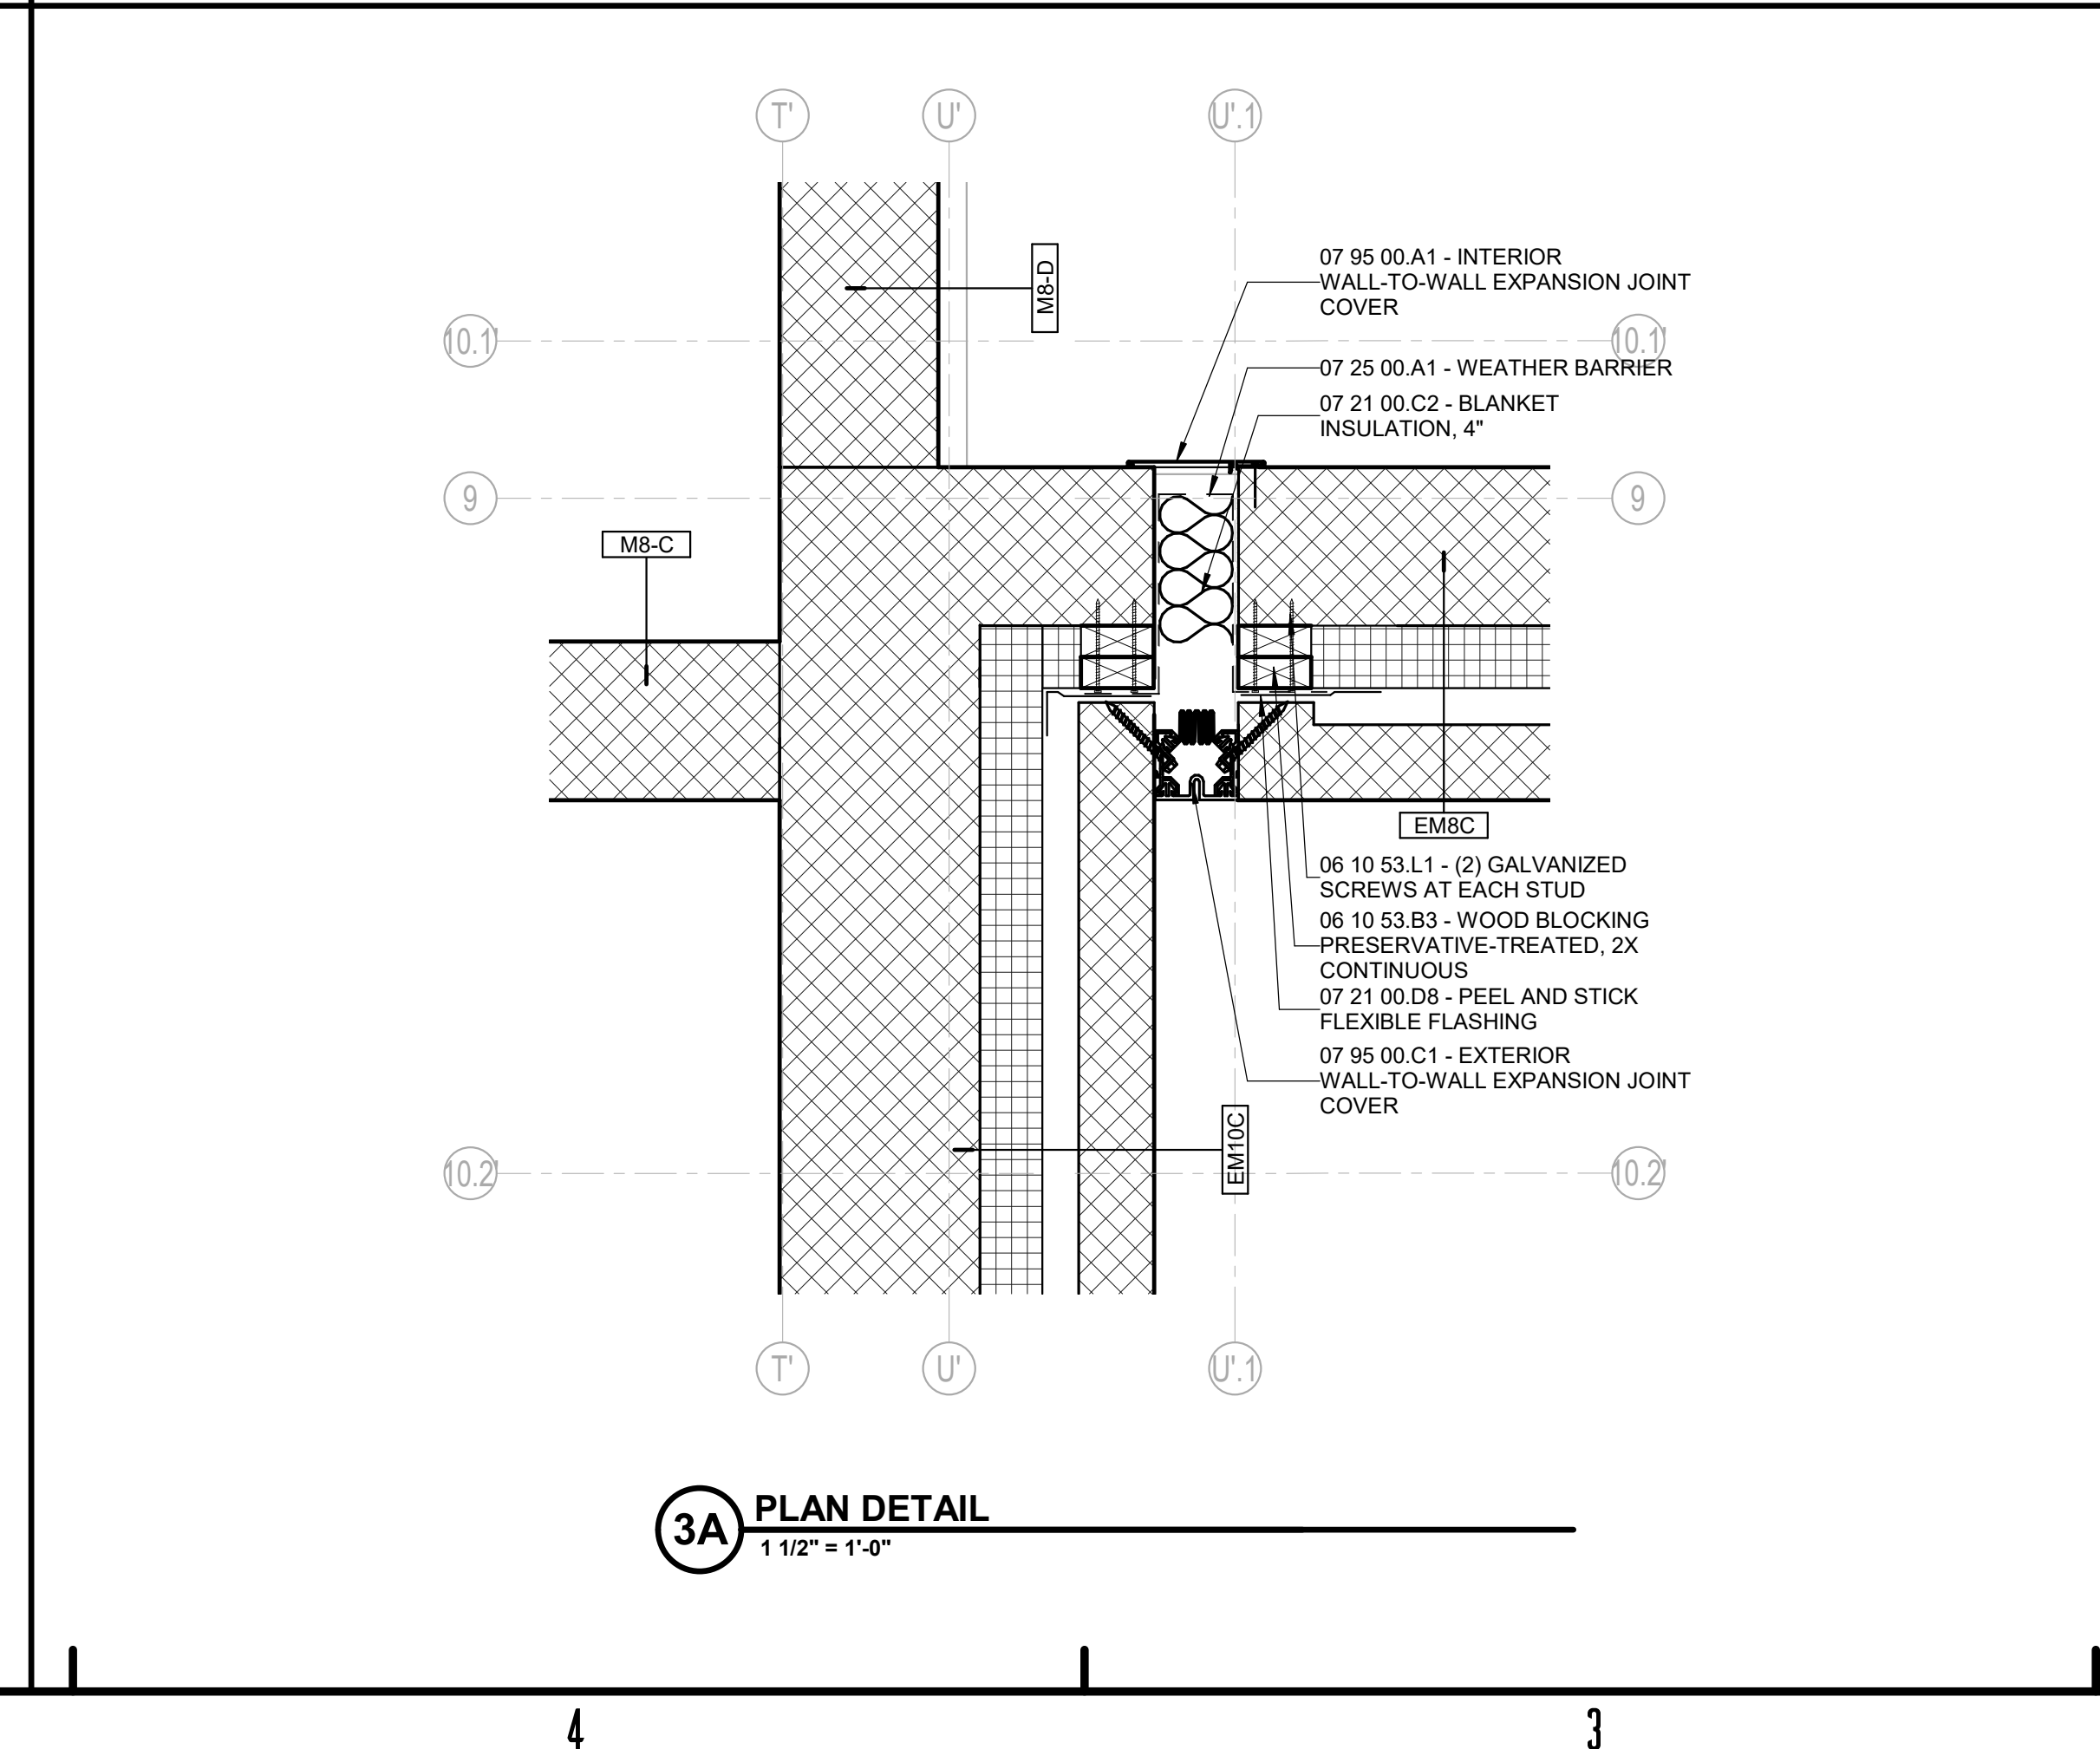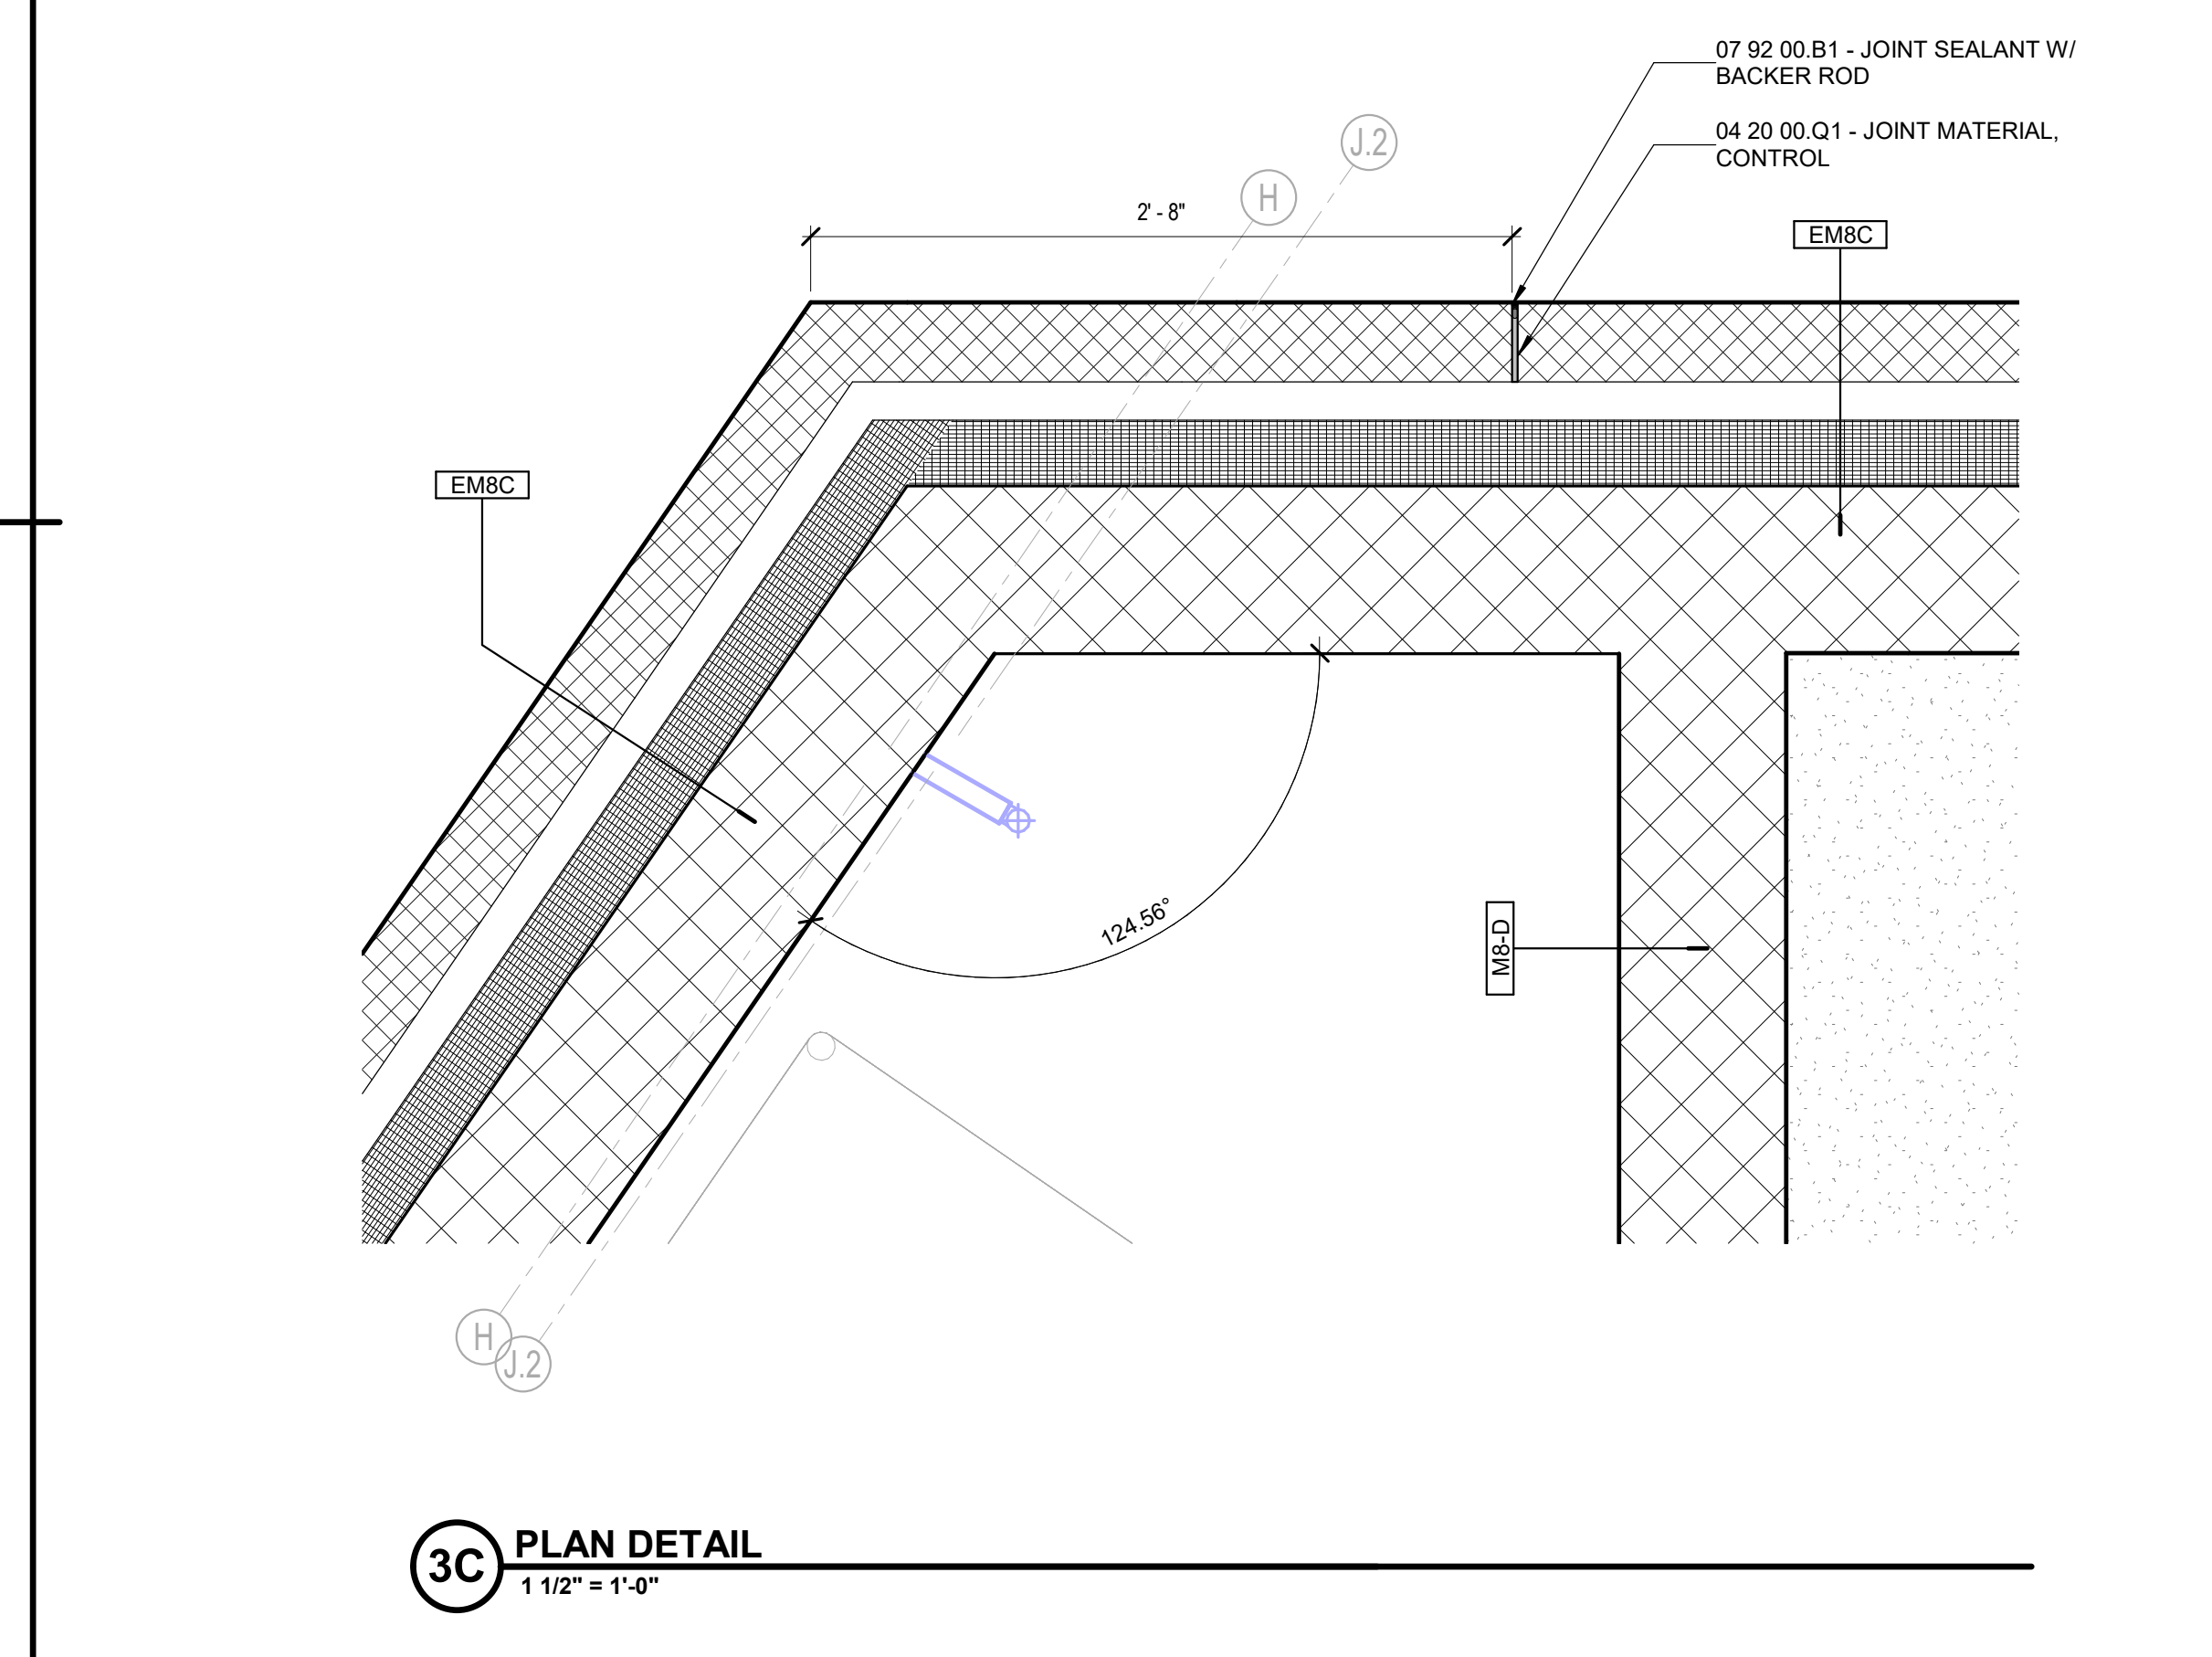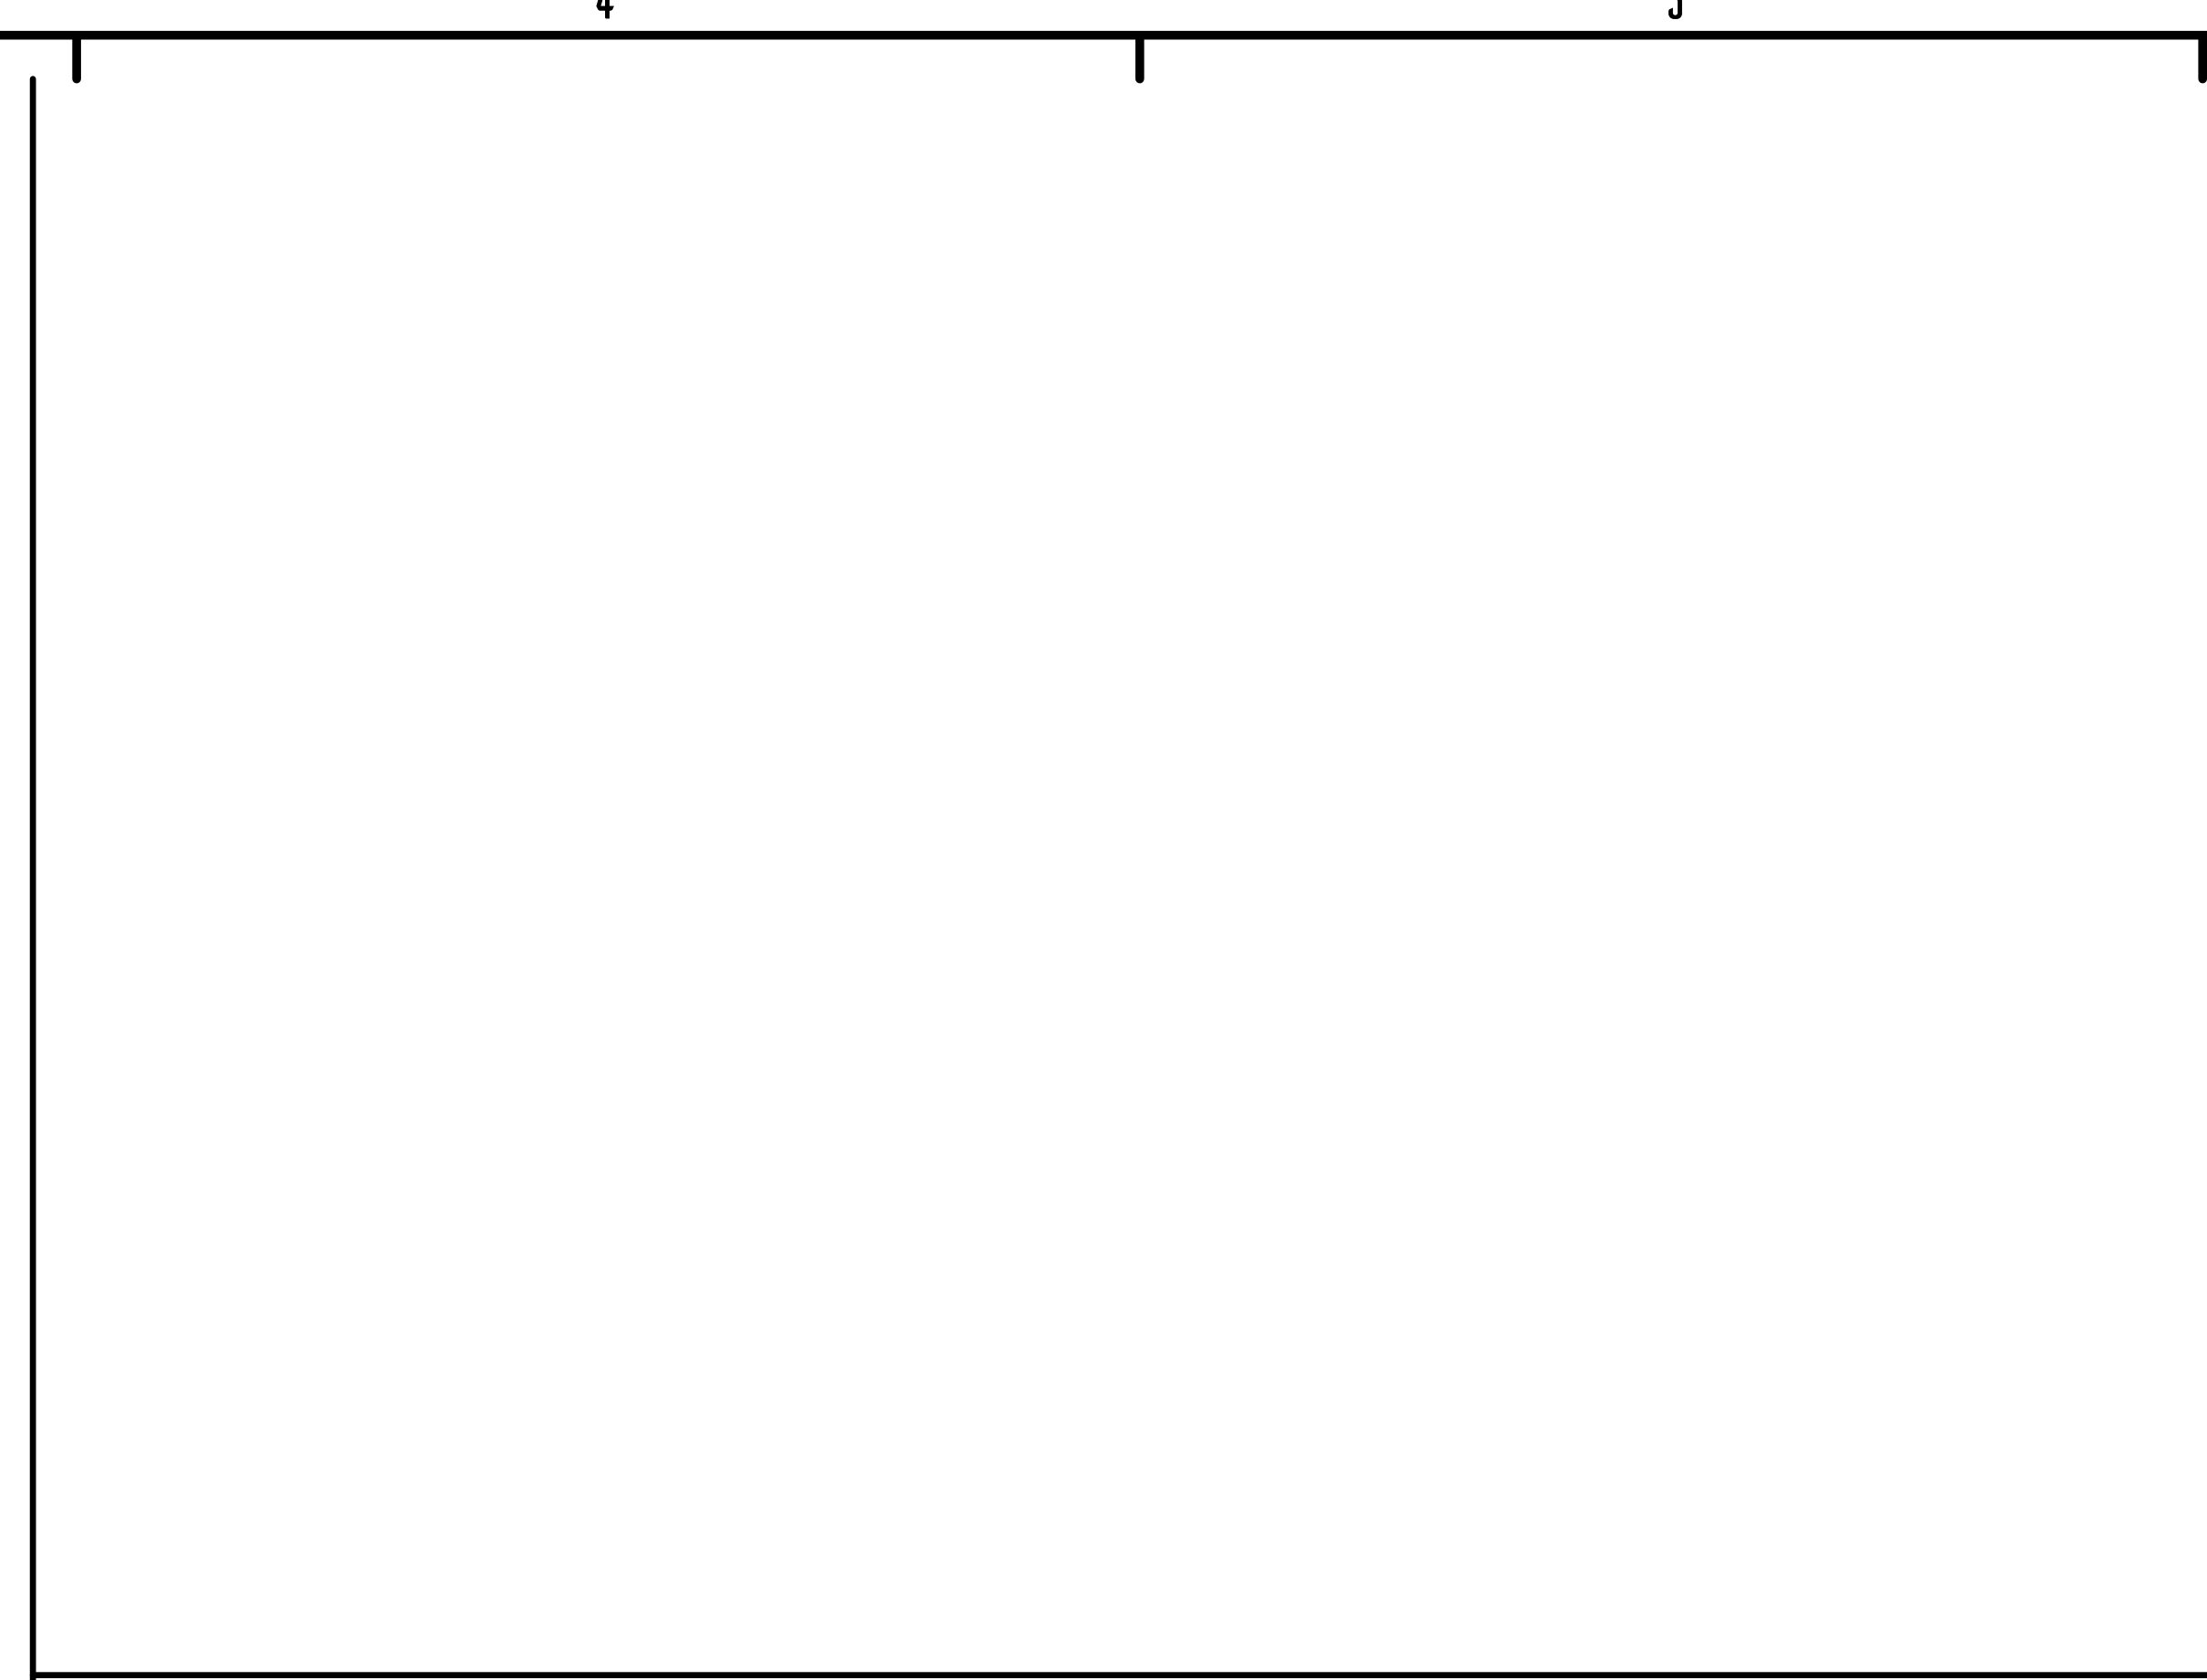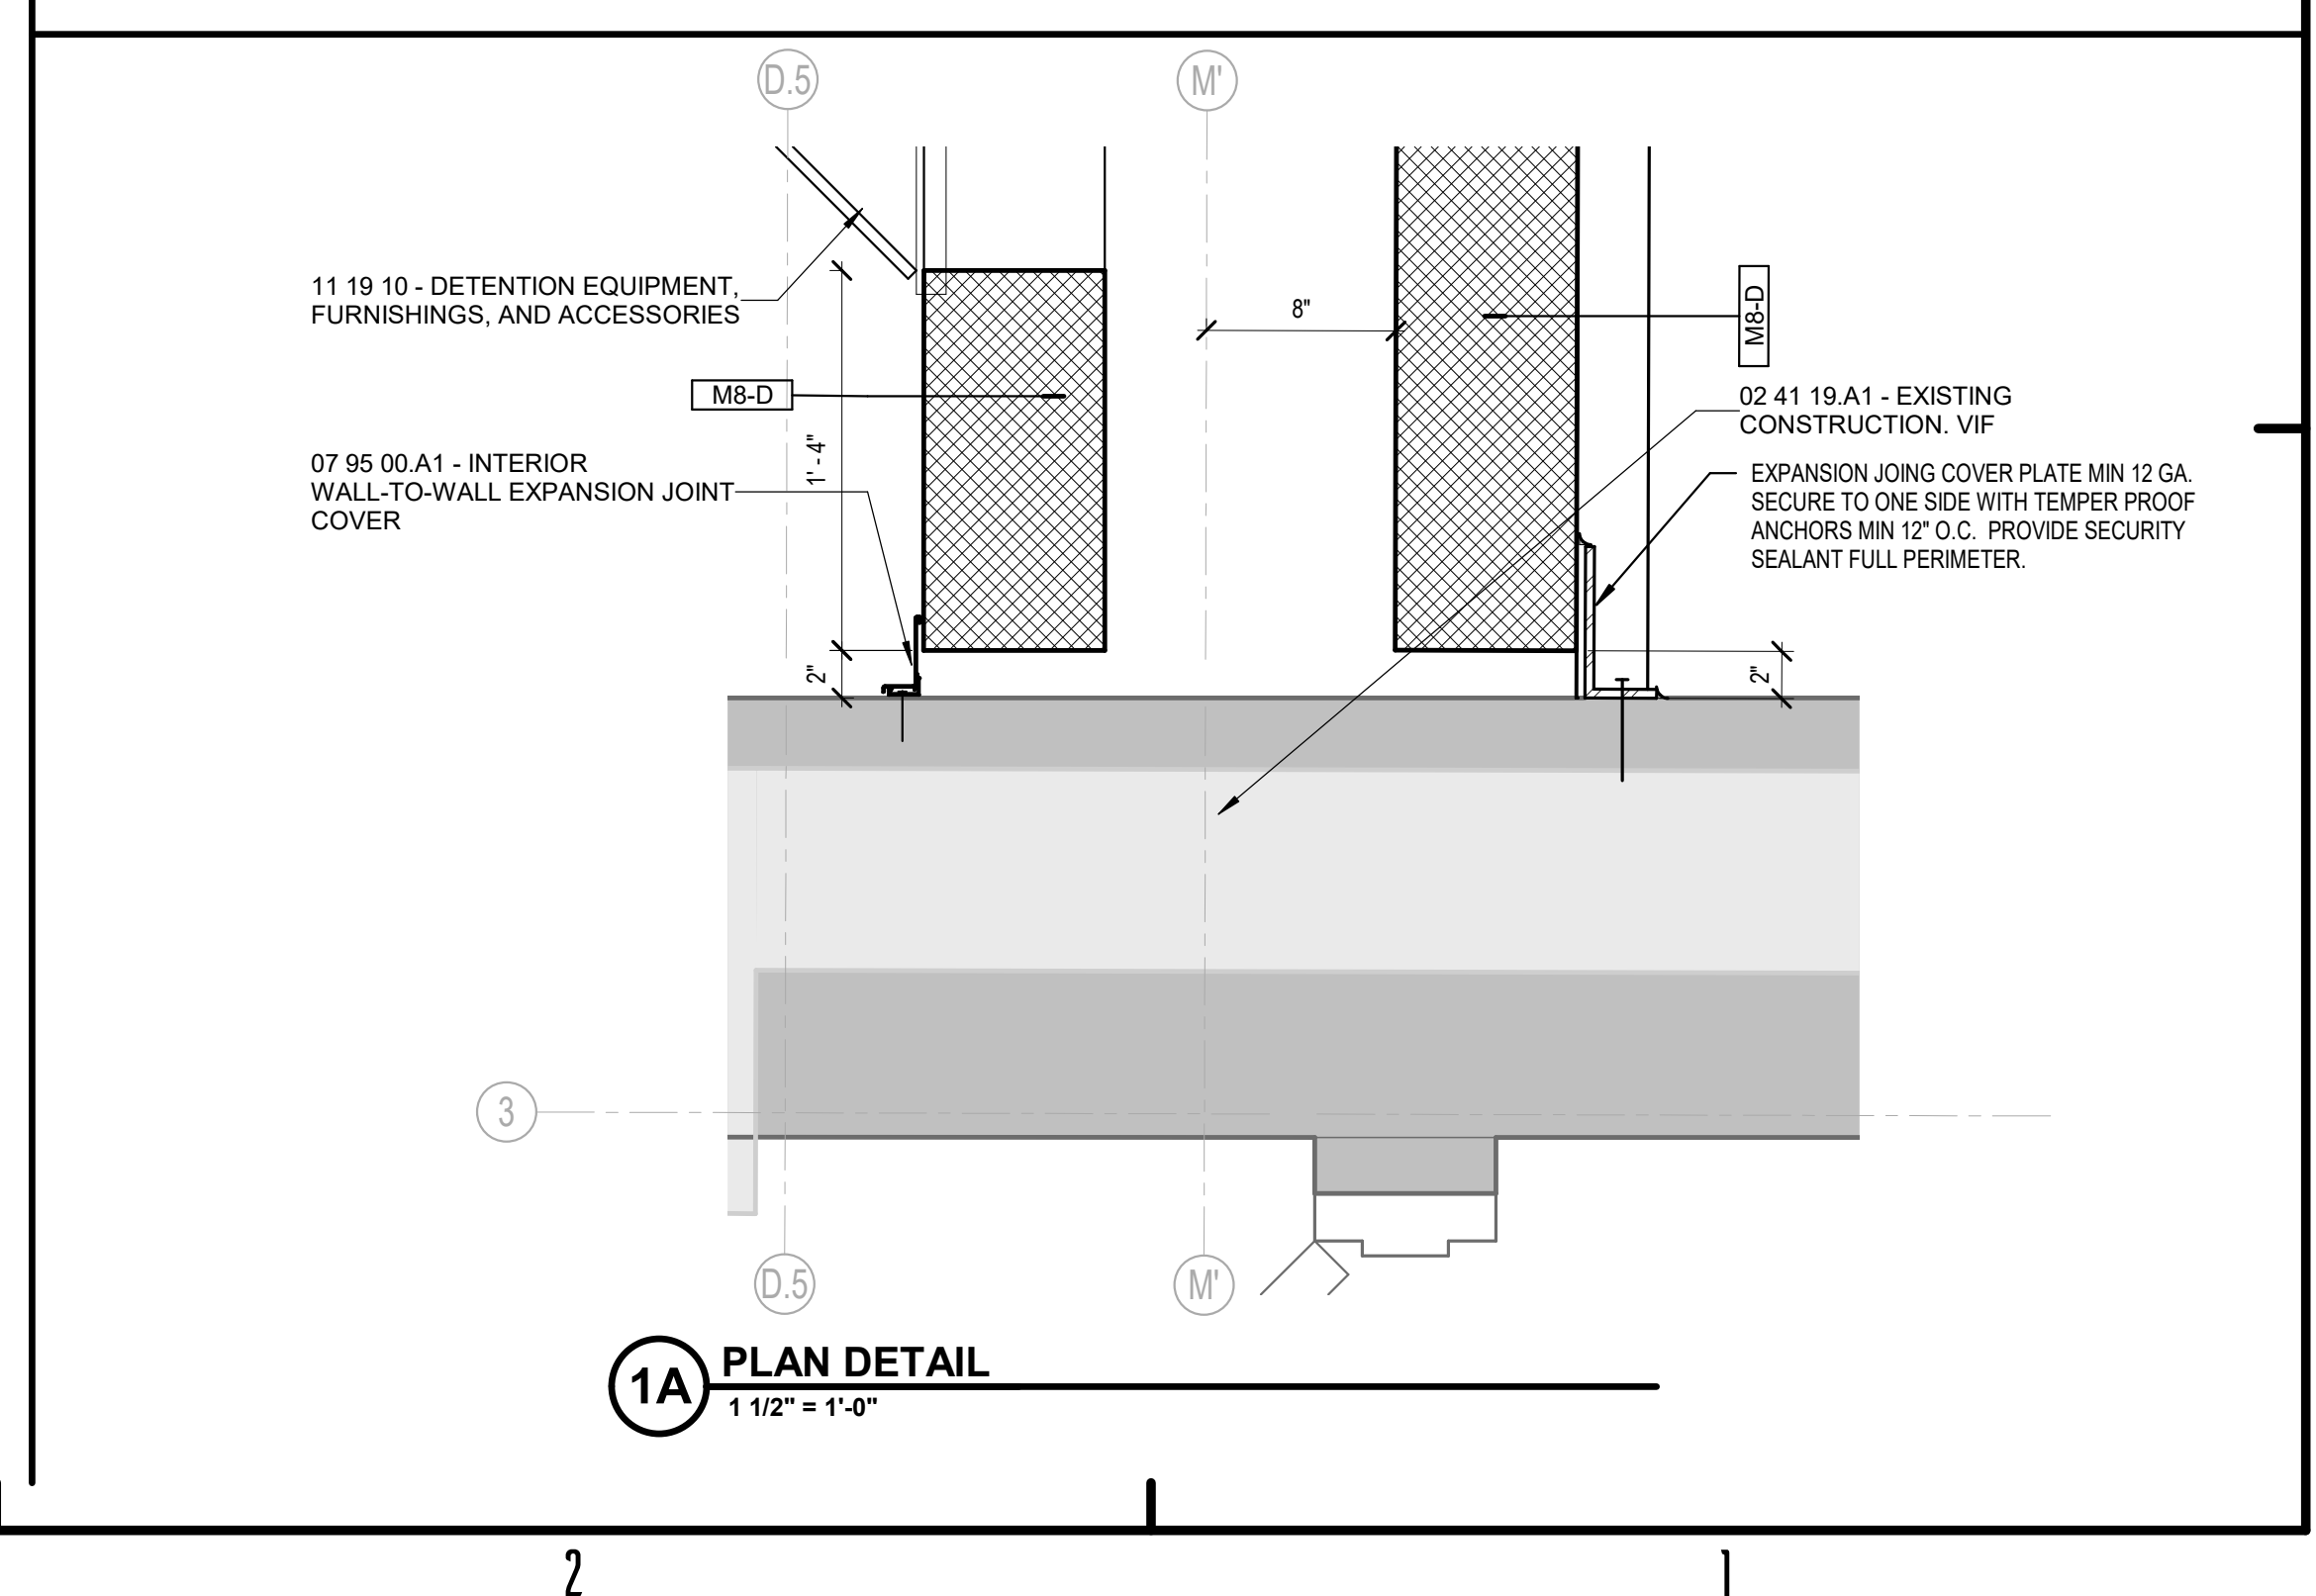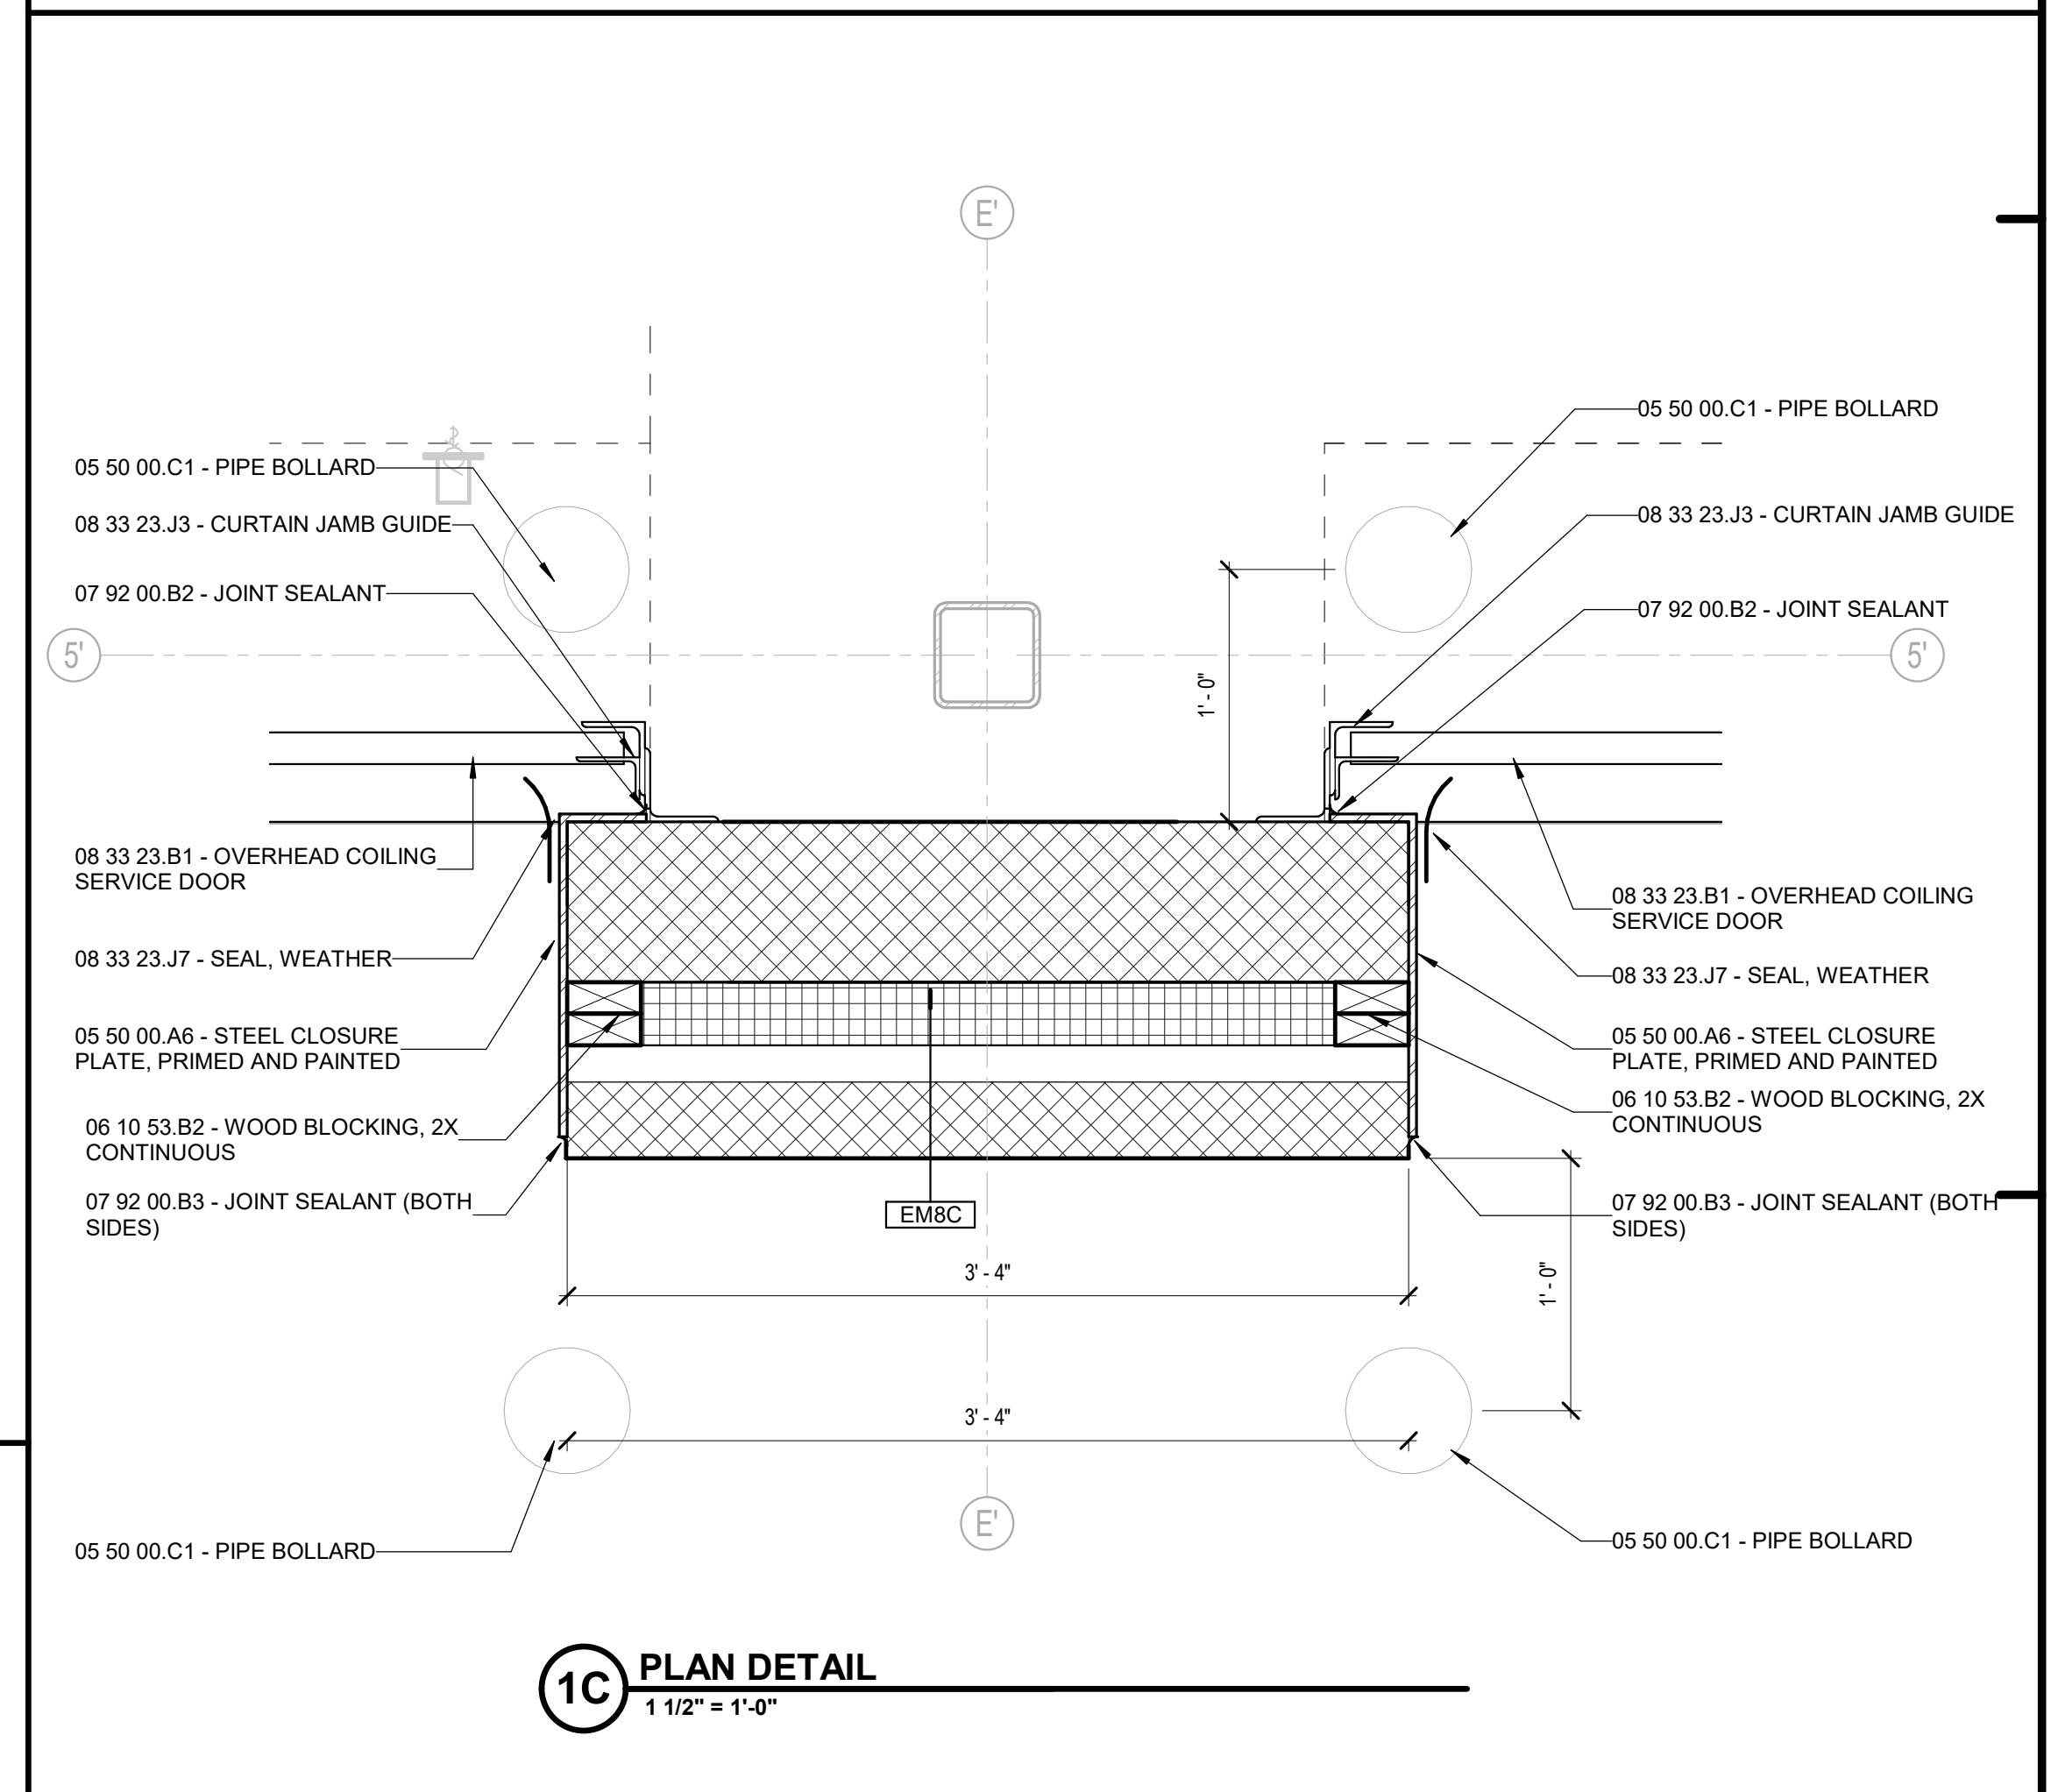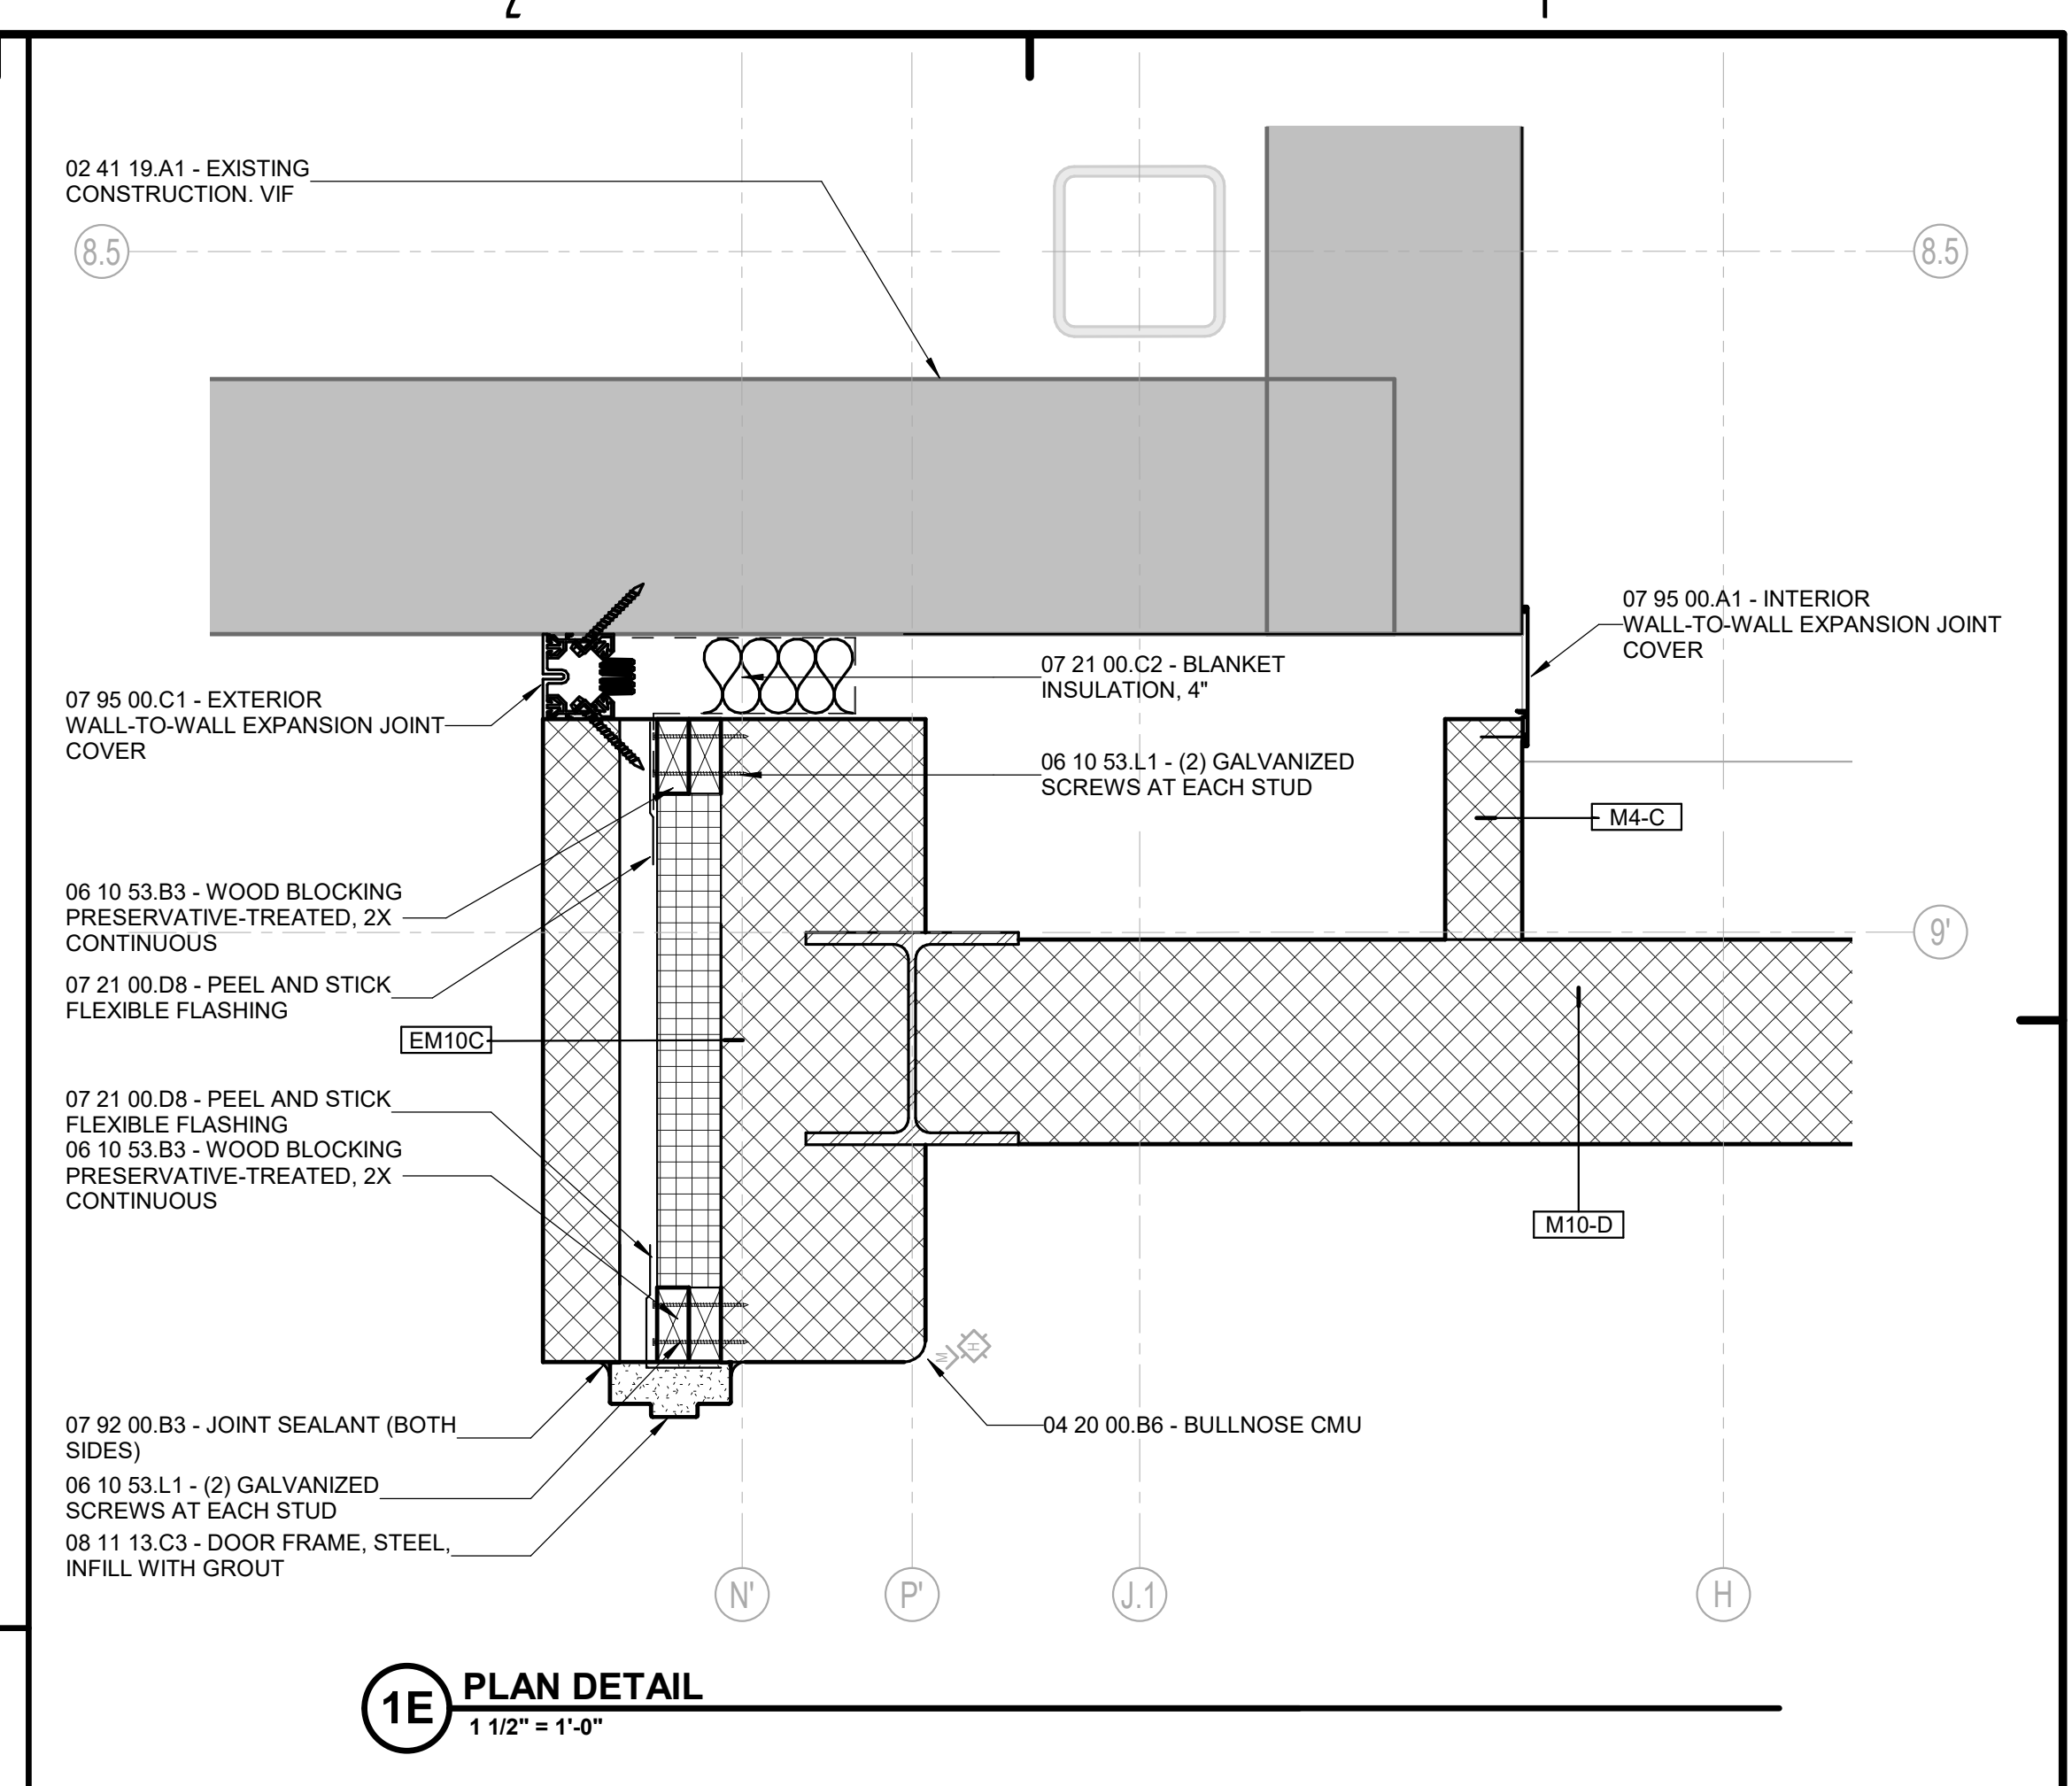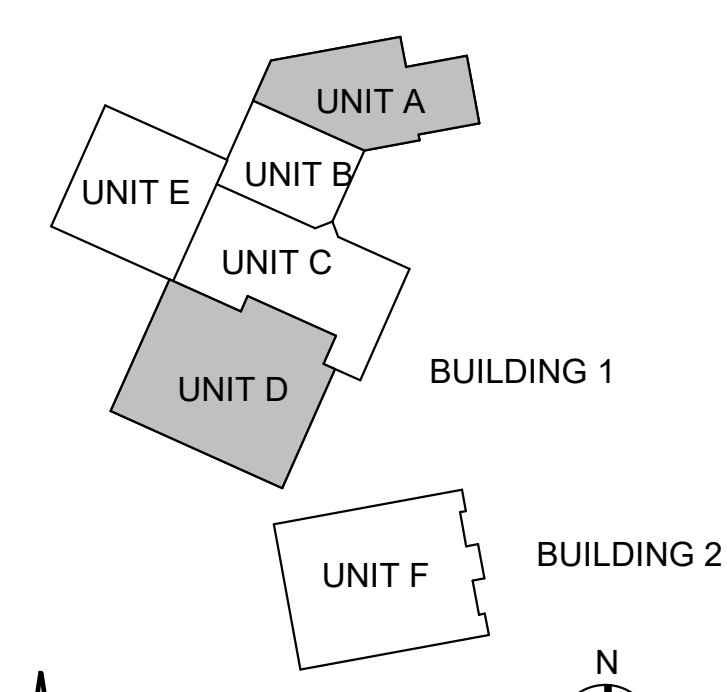


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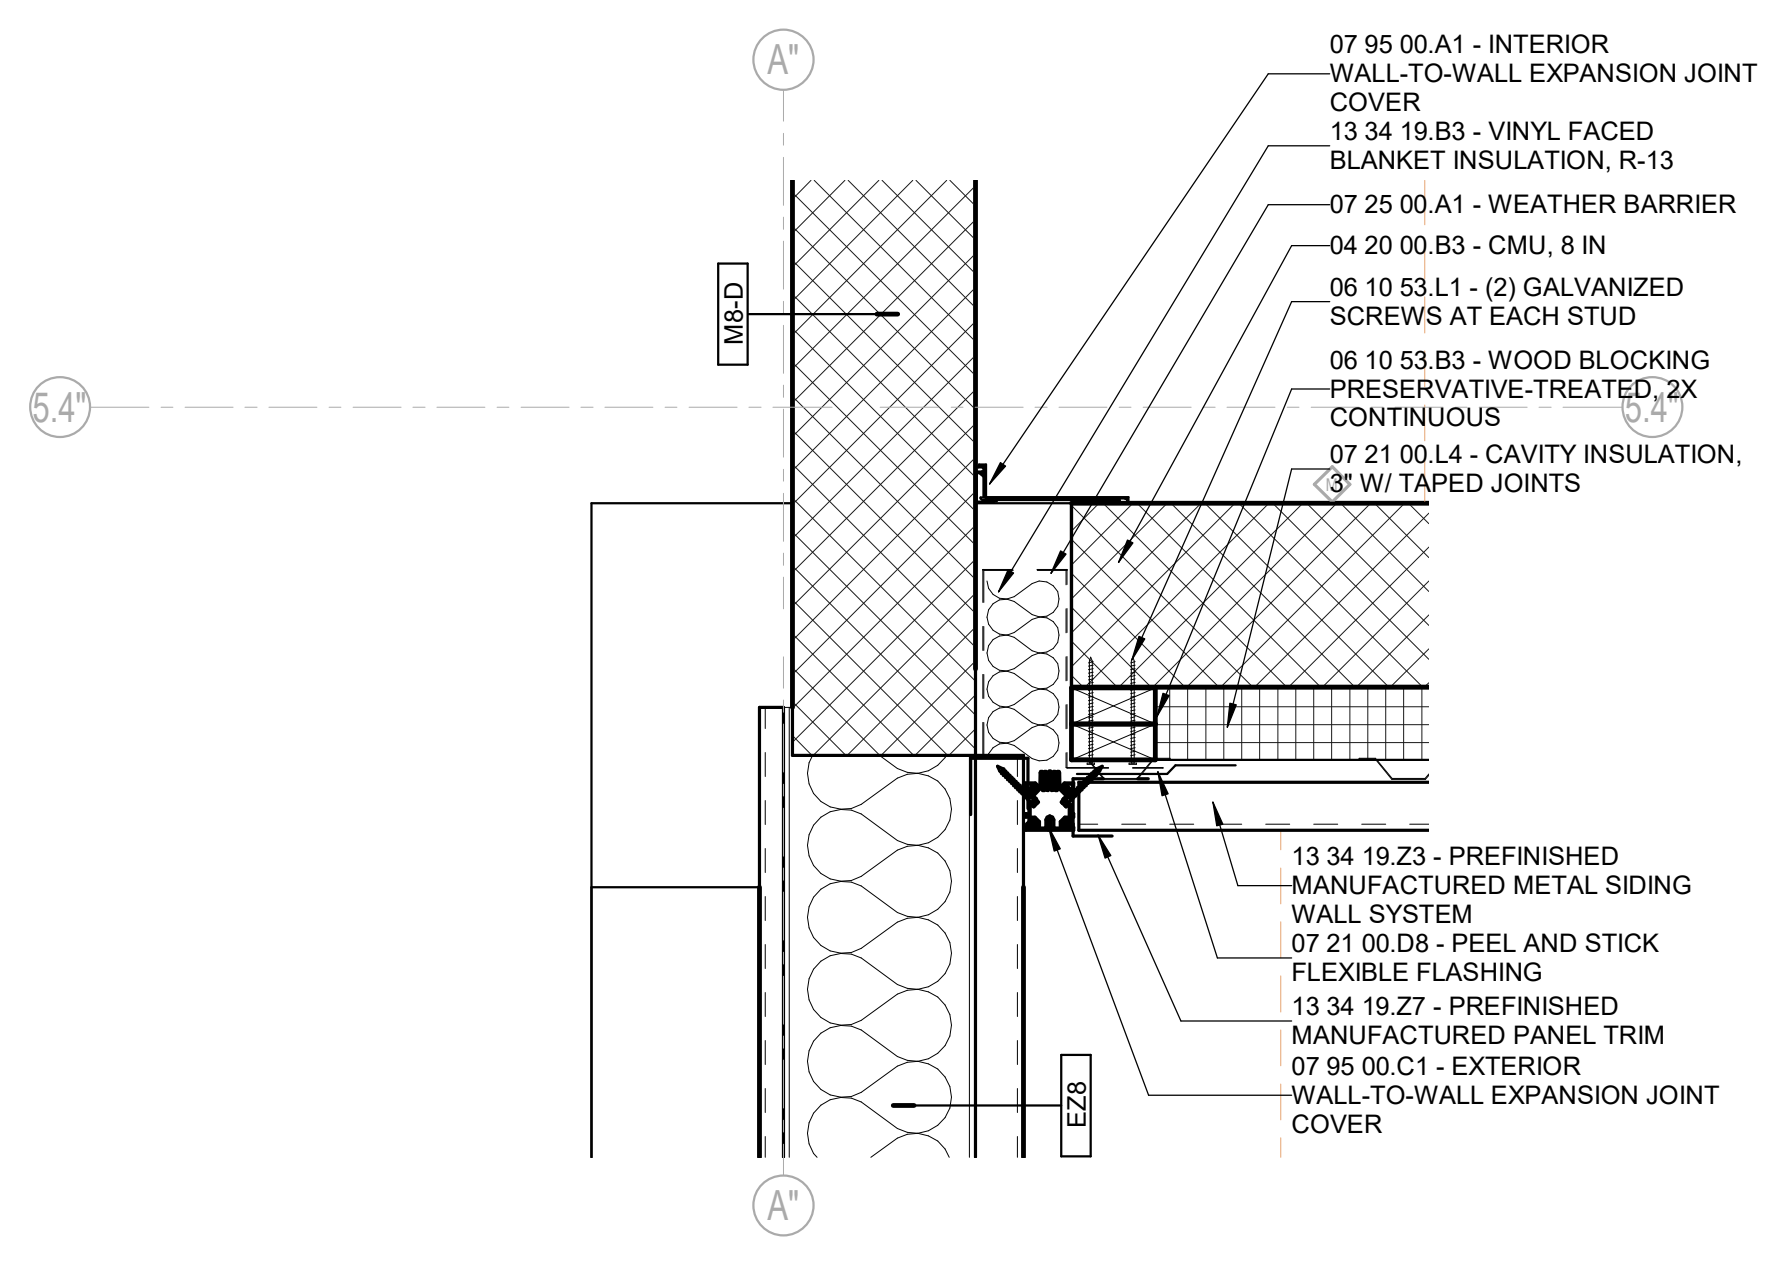


PLAN DETAILS


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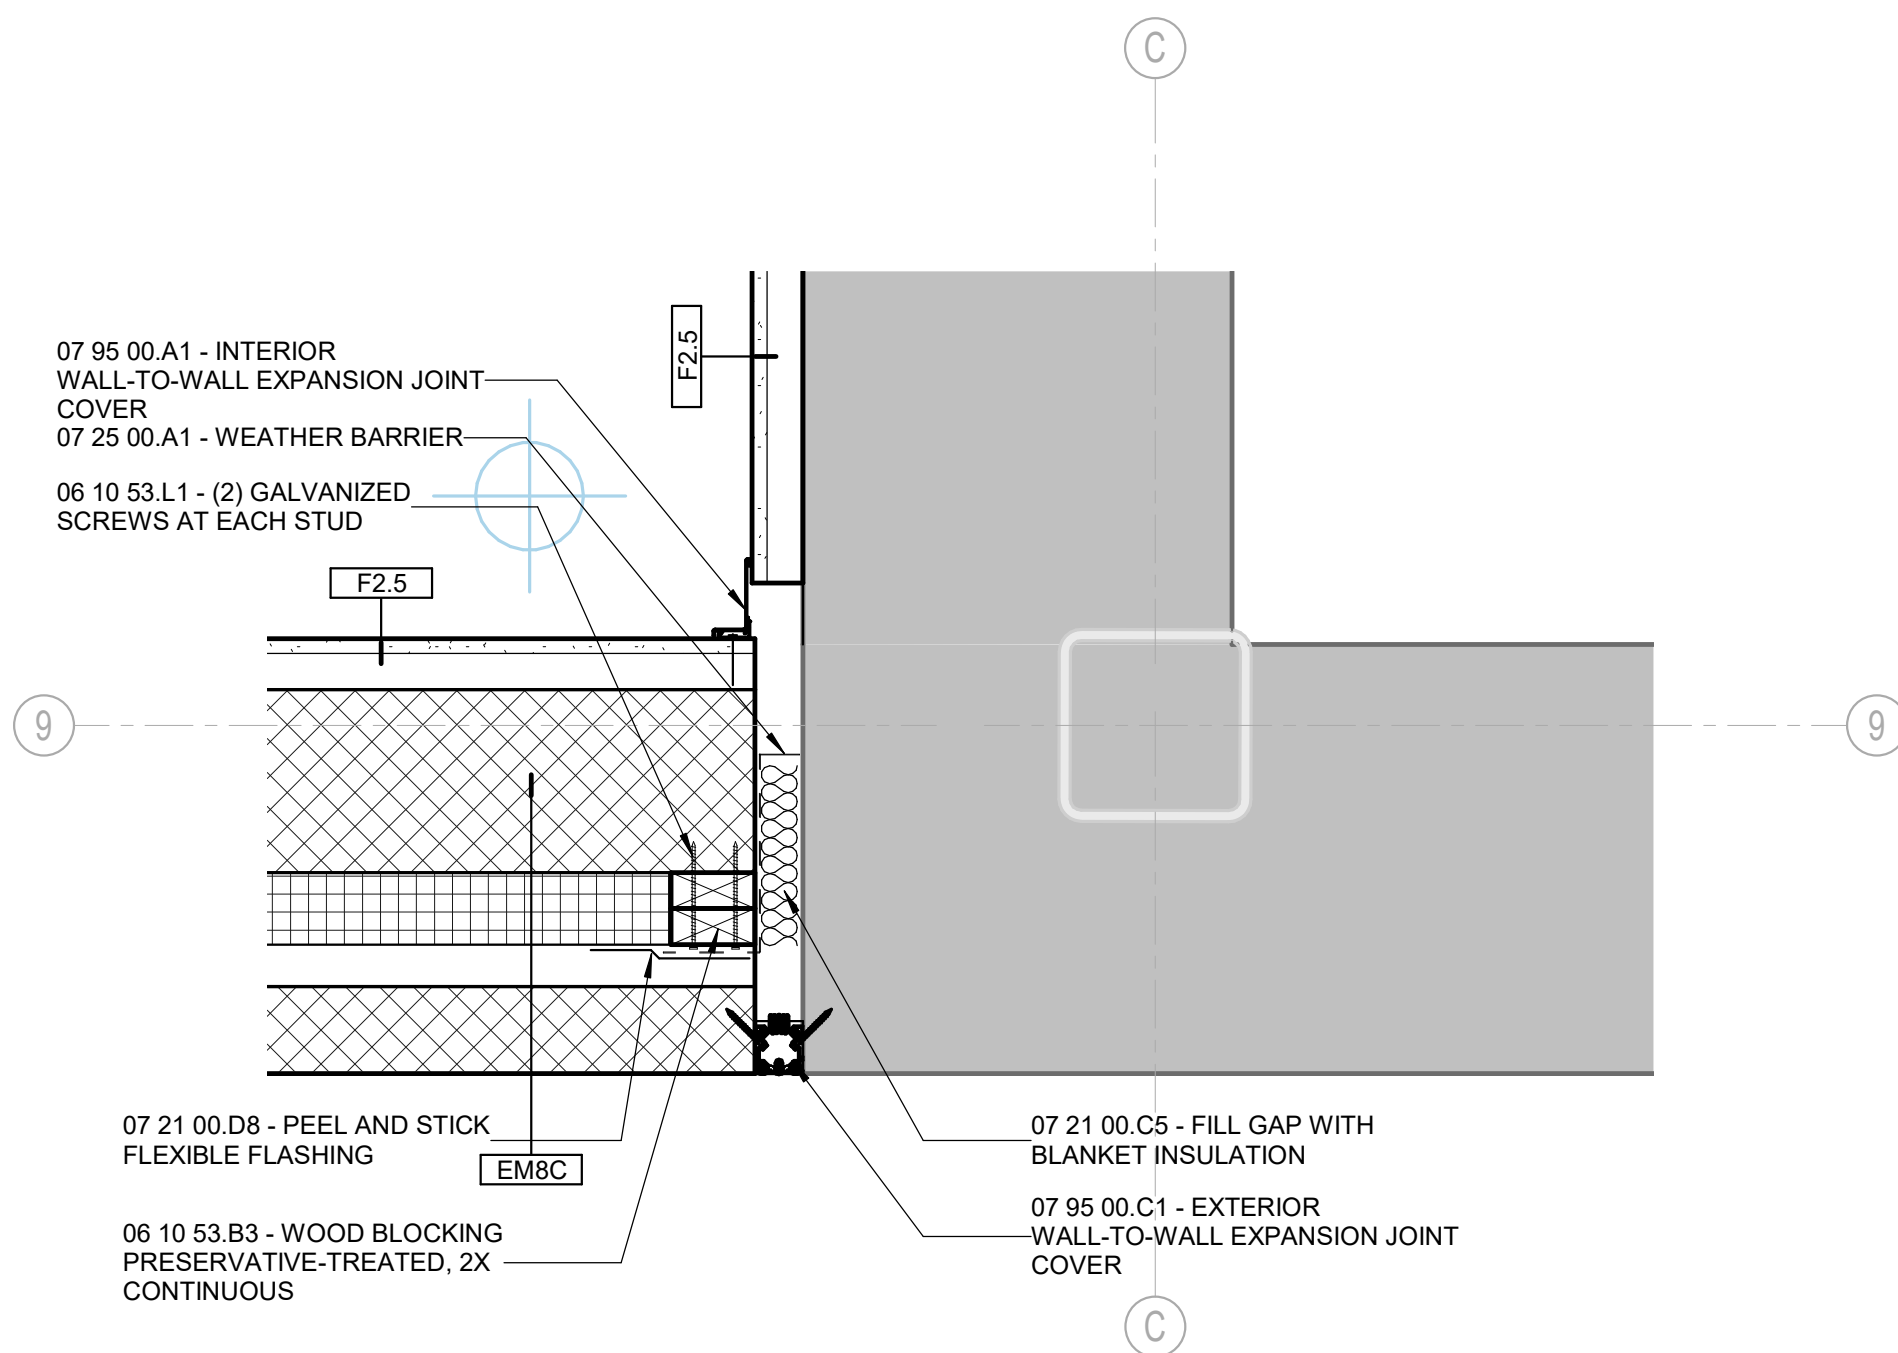
**1E PLAN DETAIL**  
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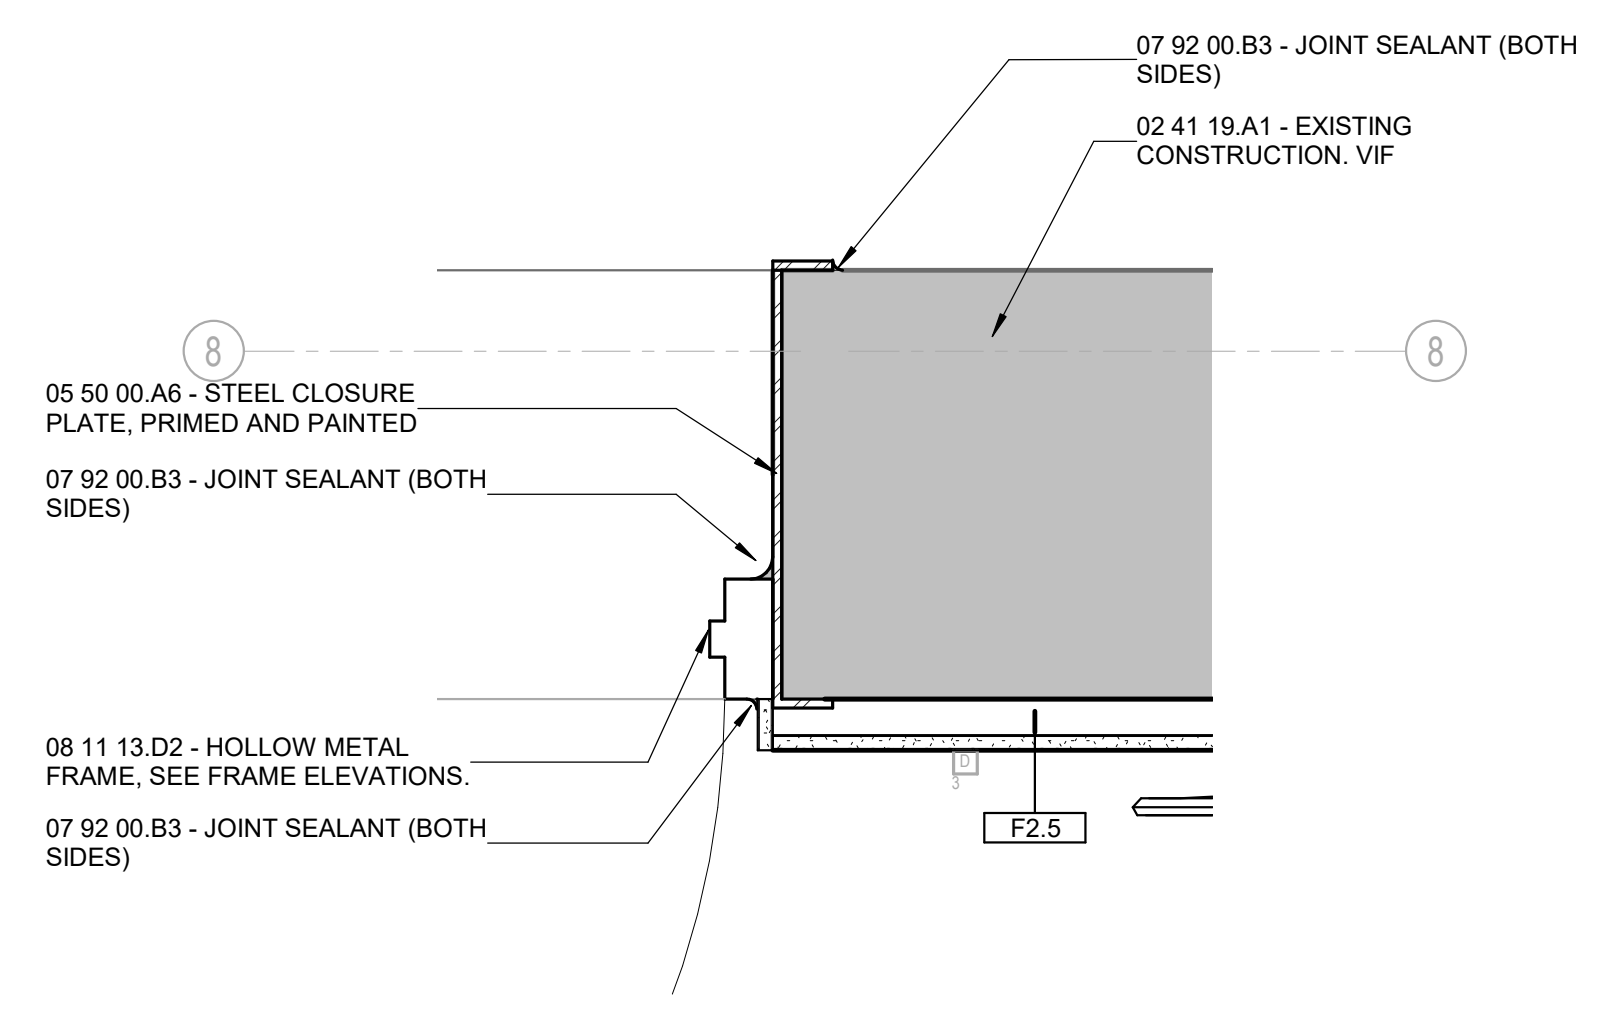
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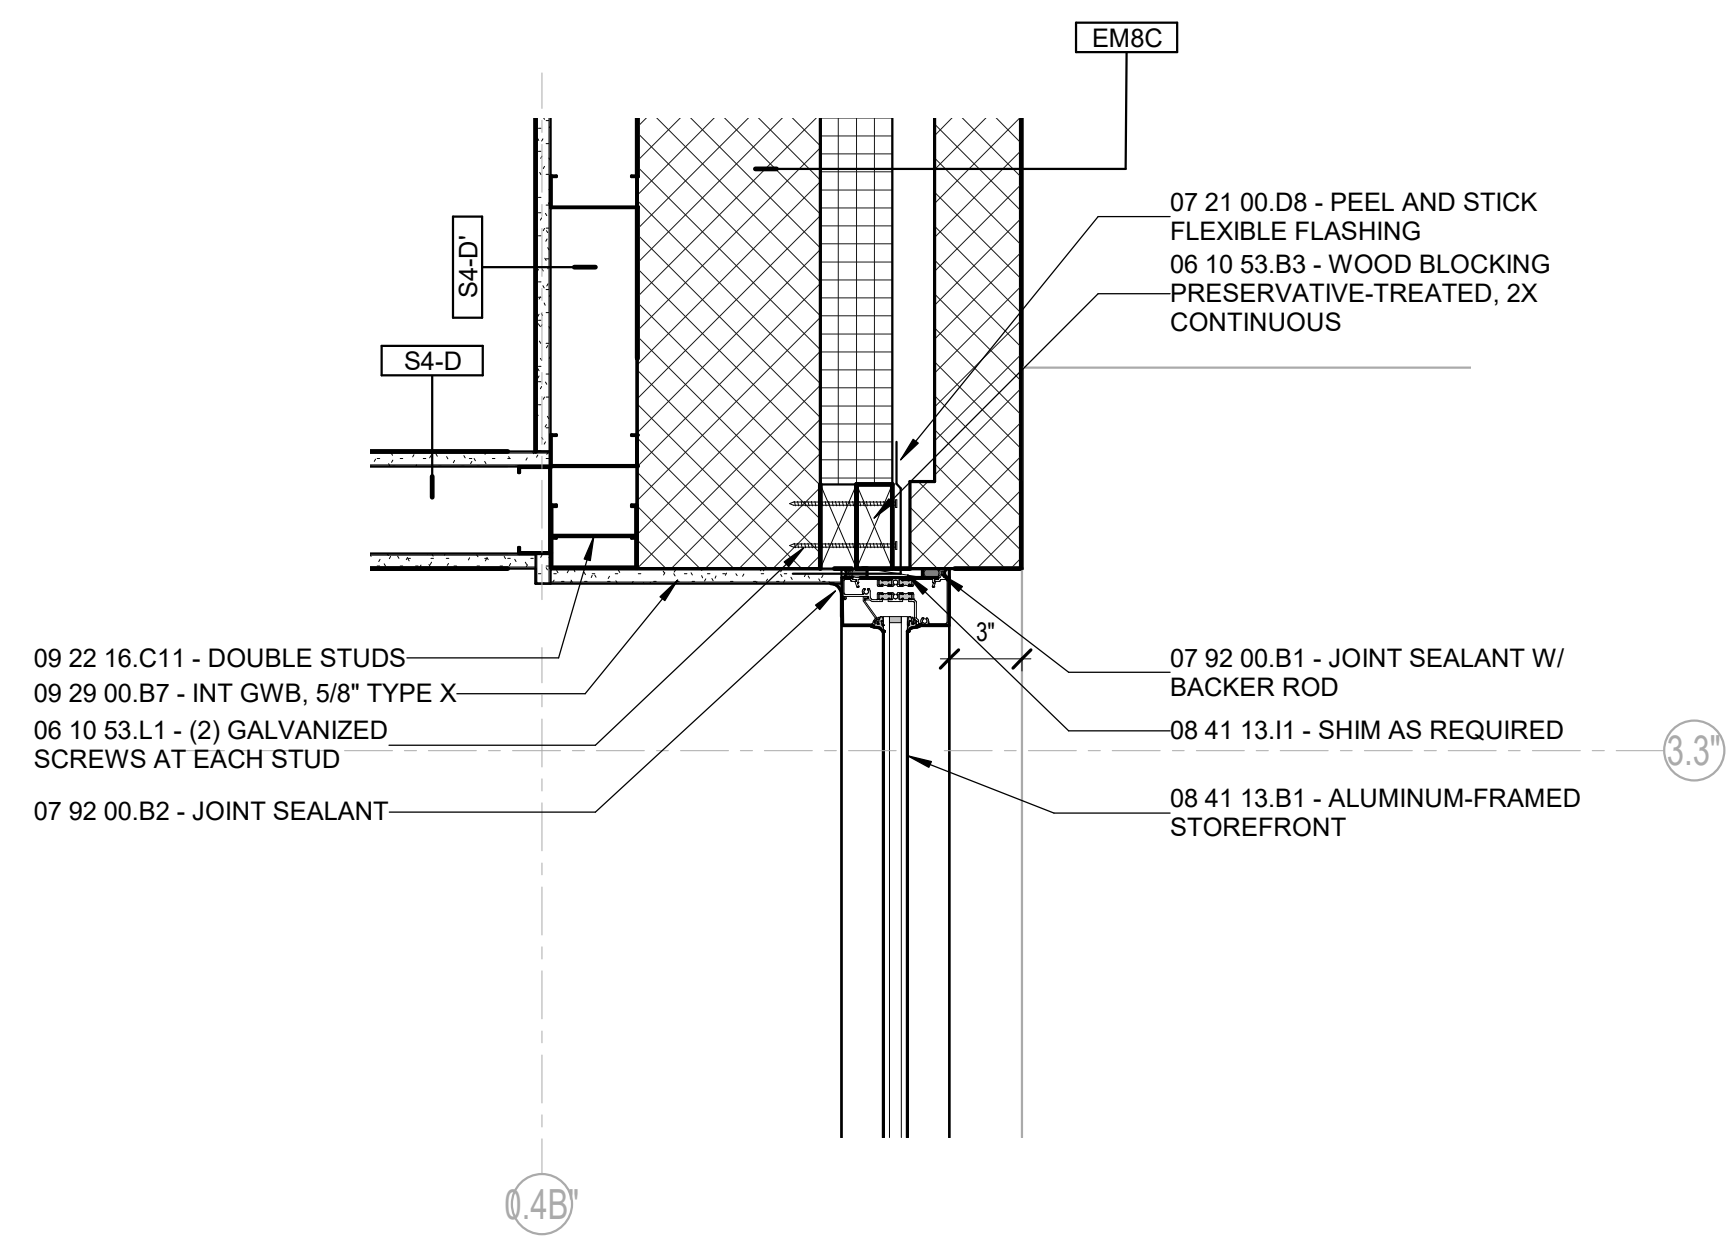
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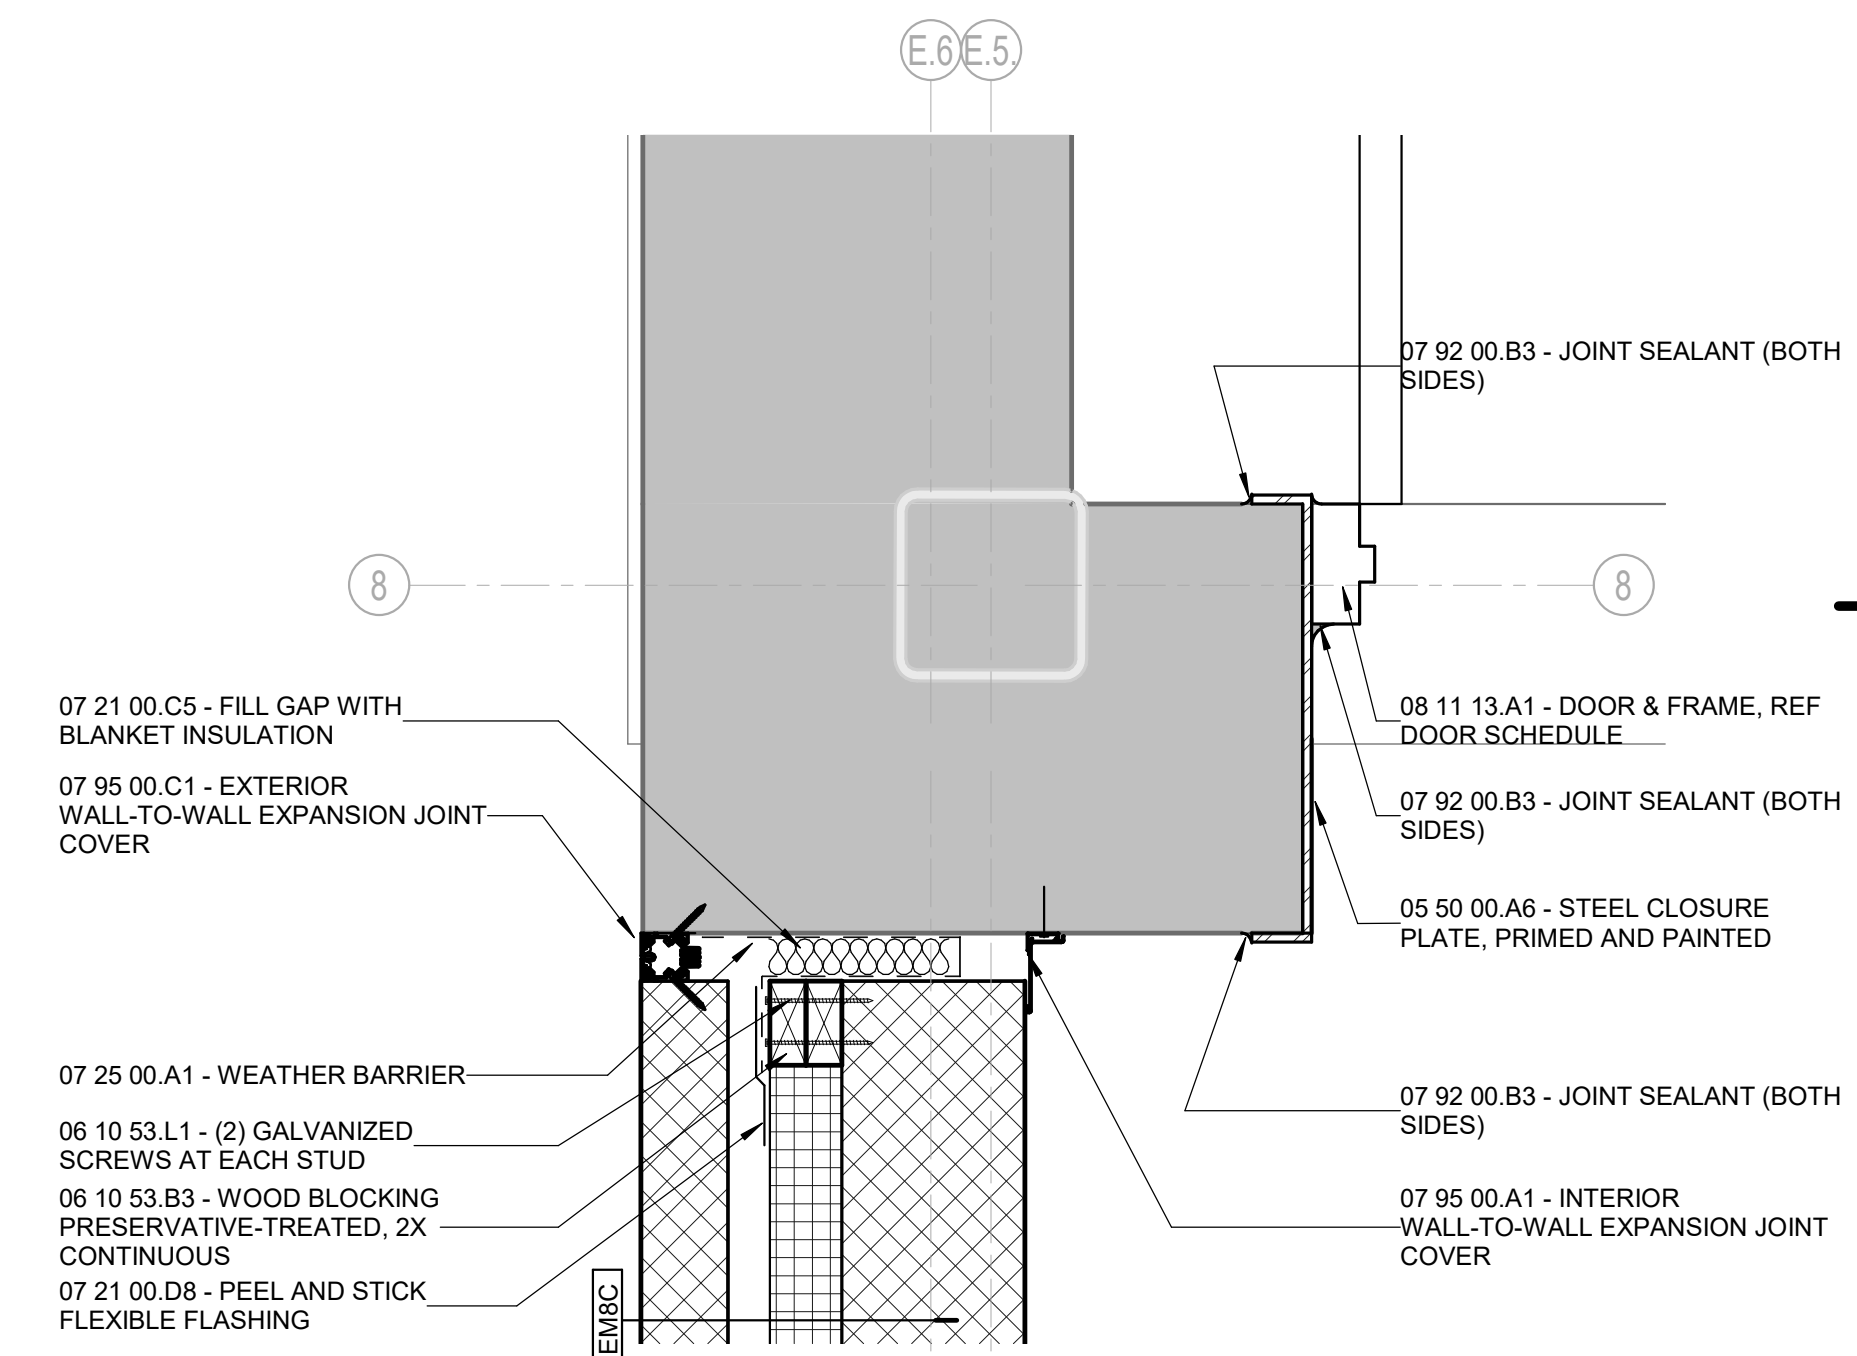
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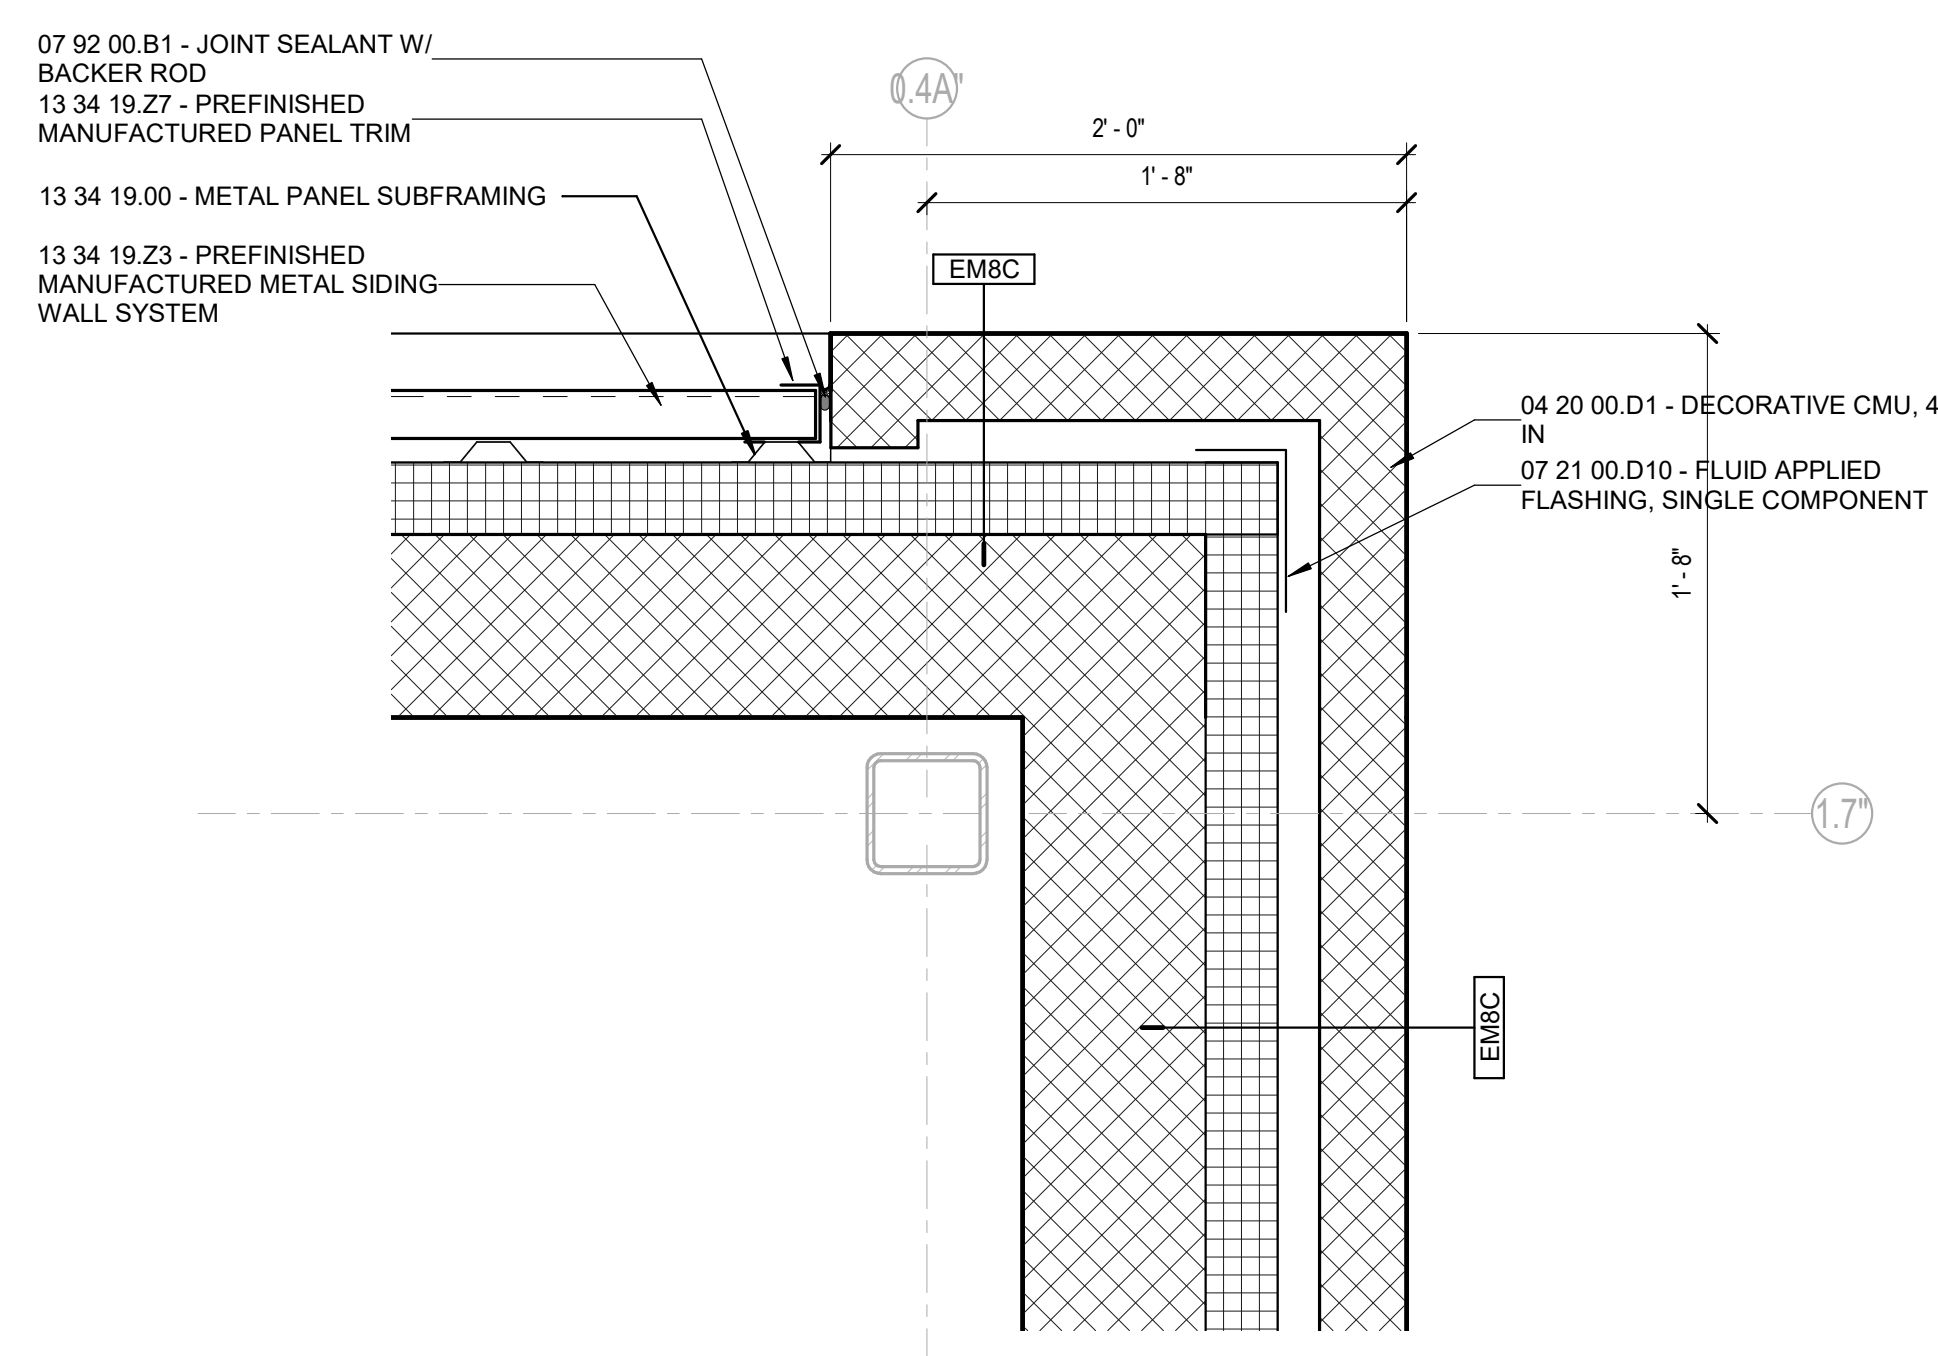
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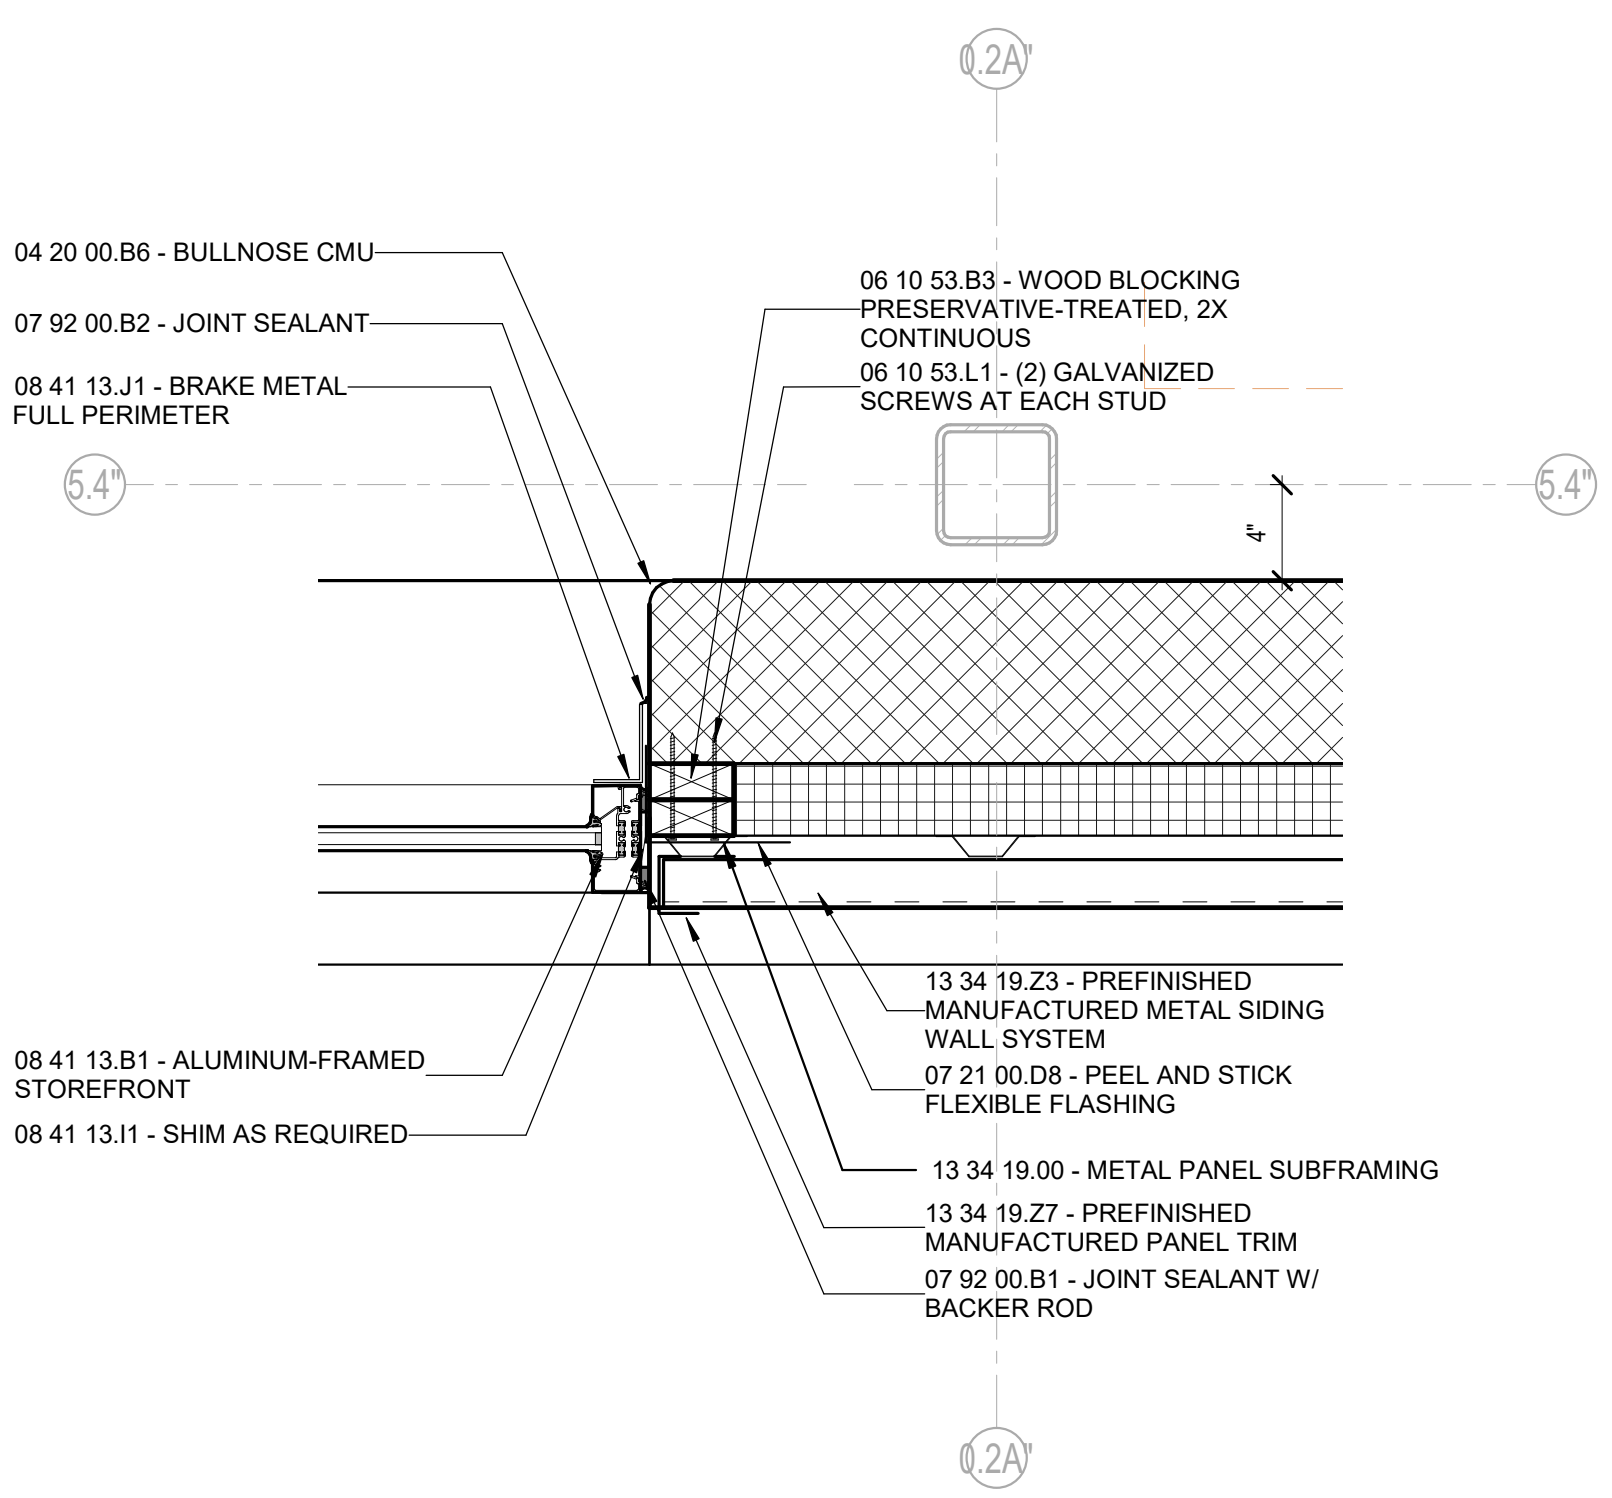
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**1A PLAN DETAIL**  
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**3A PLAN DETAIL**  
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**5A PLAN DETAIL**  
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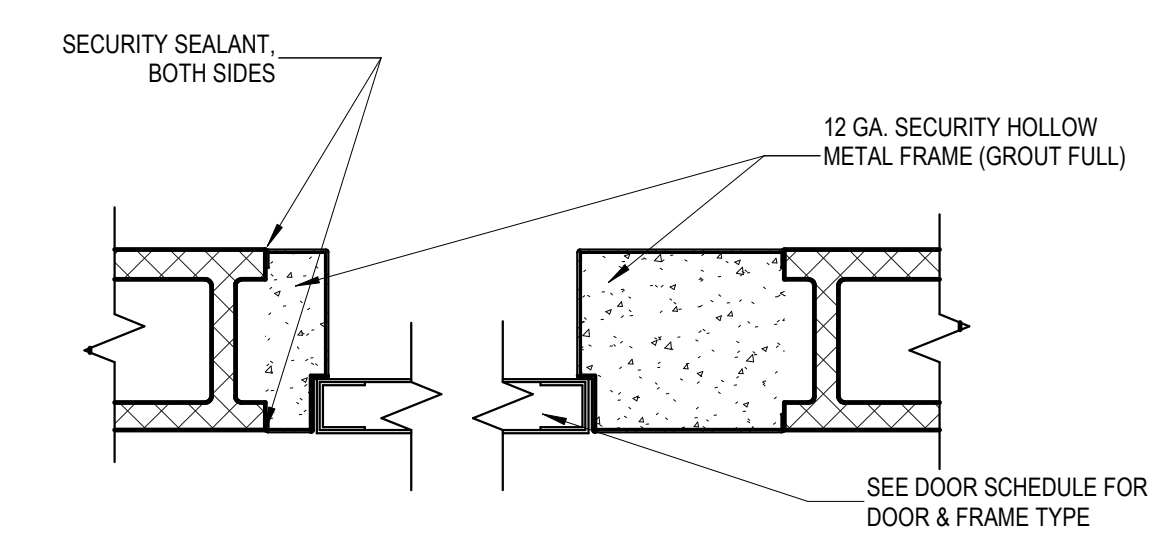
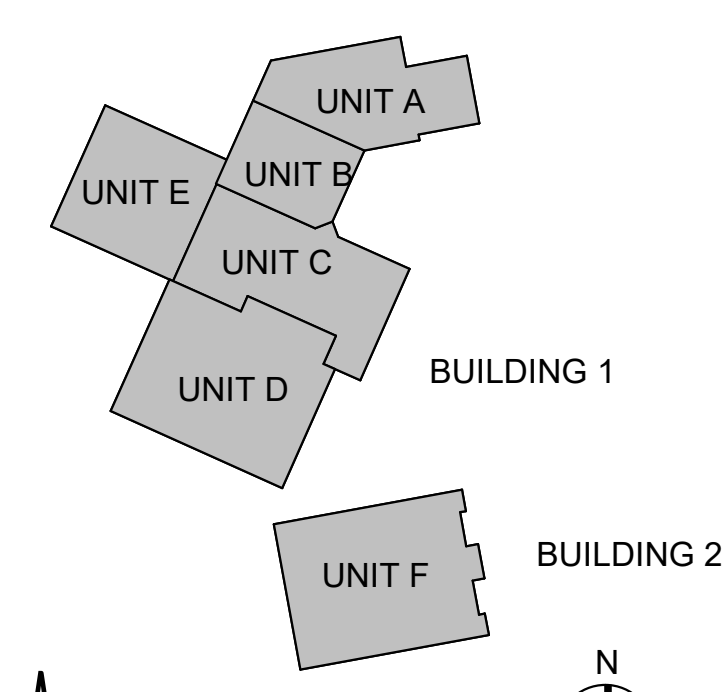

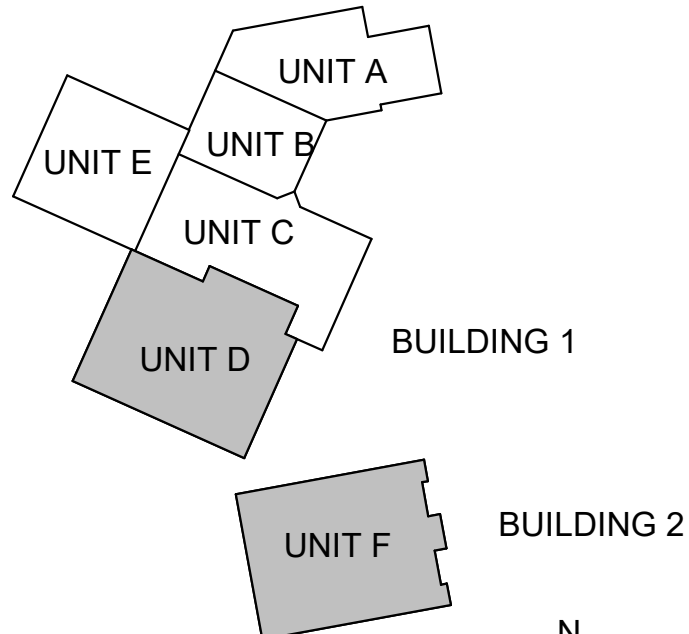
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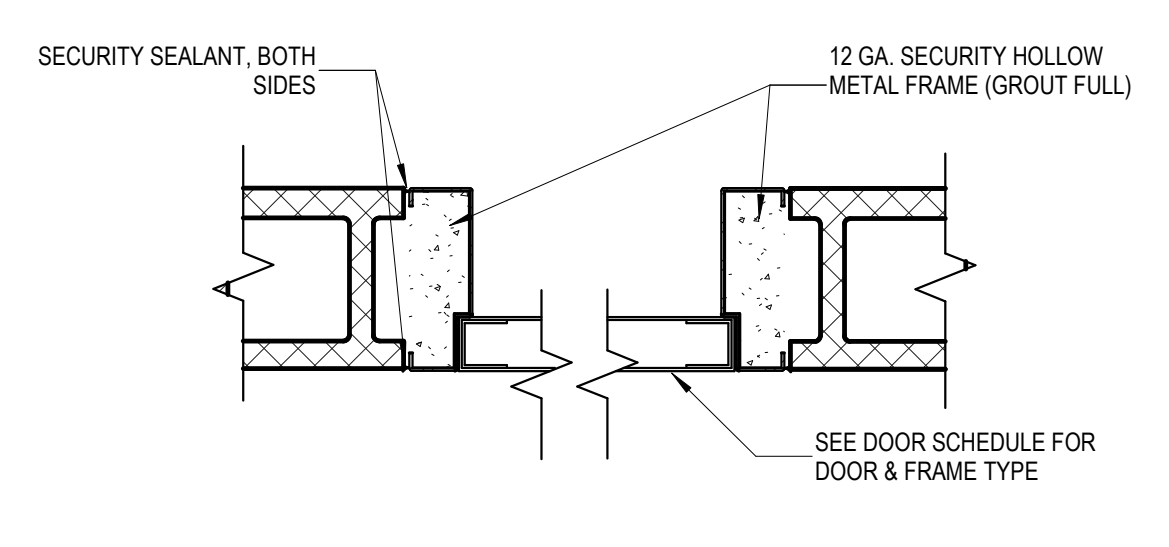
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Designed By: LD/SP  
Drawn By: CP  
Checked By: LD/EV  
Date: 01.28.2022

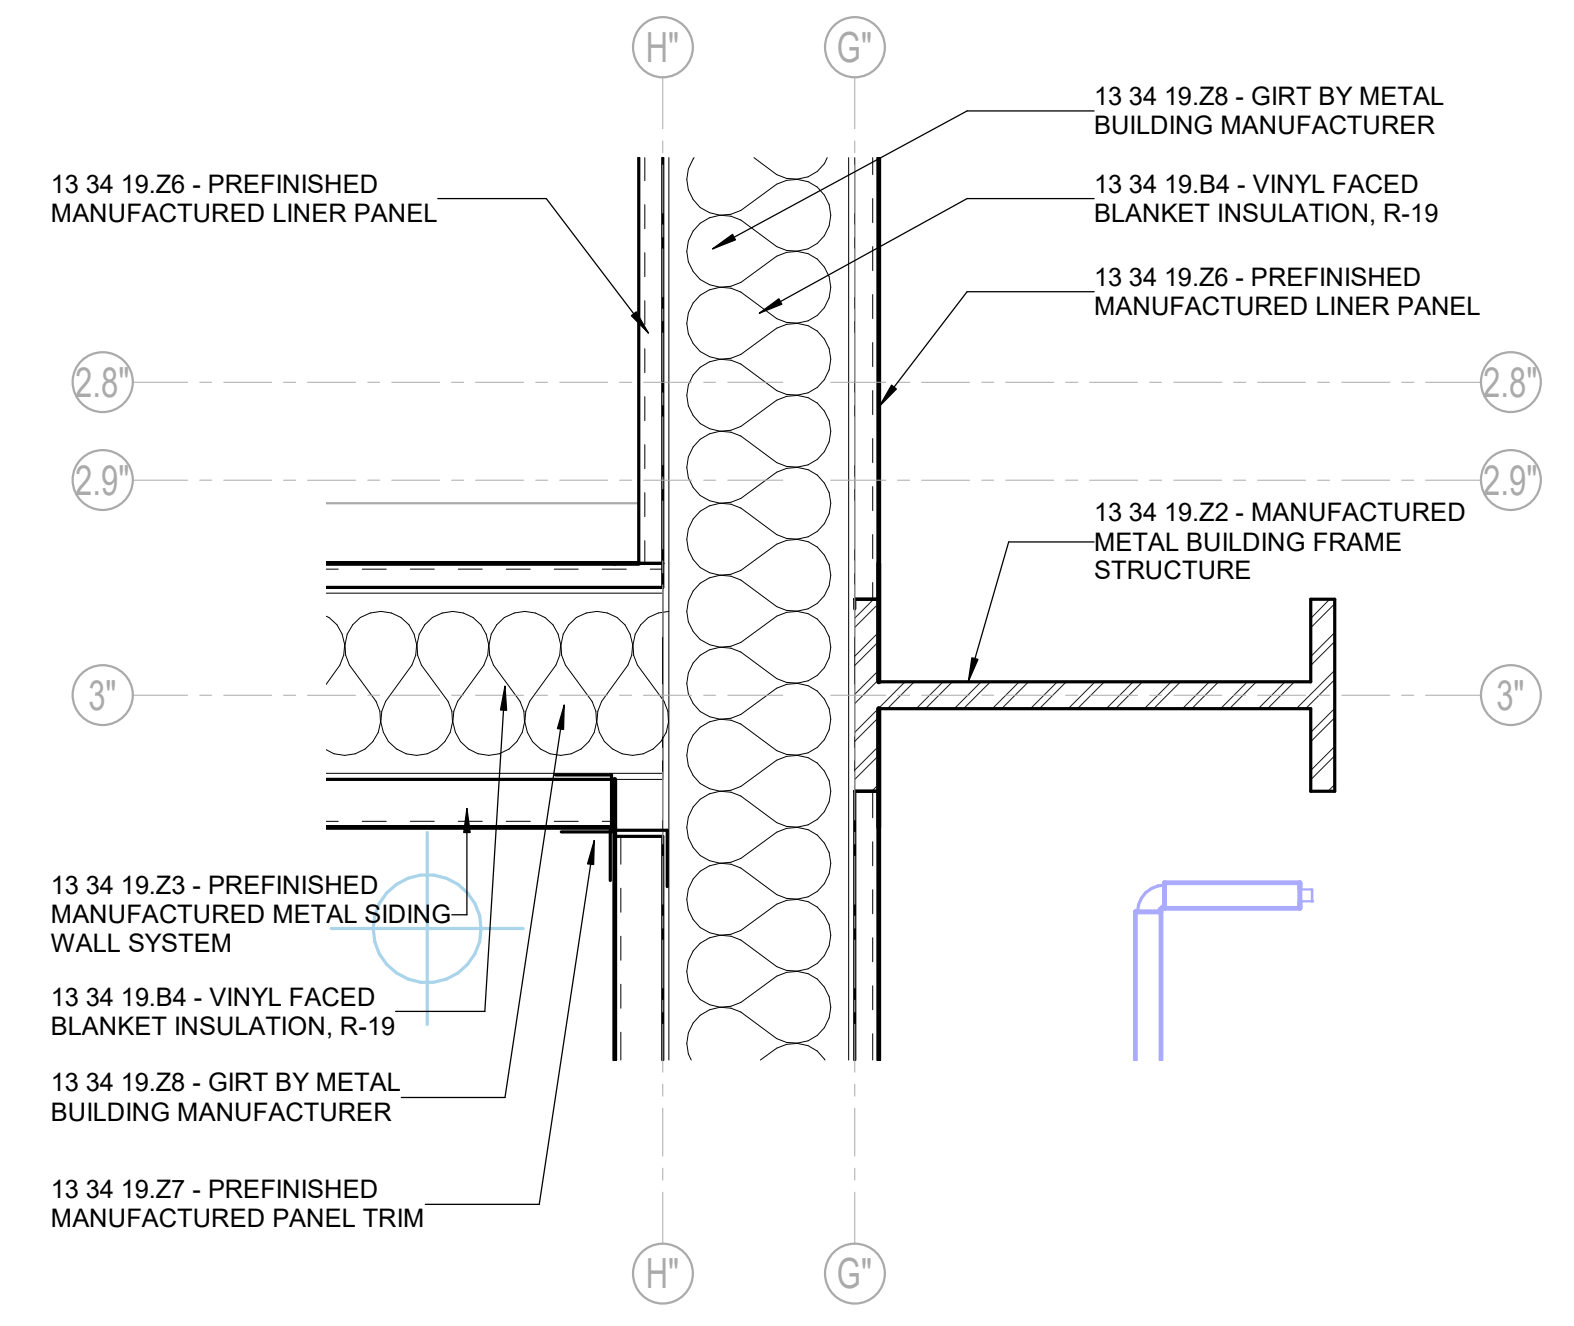


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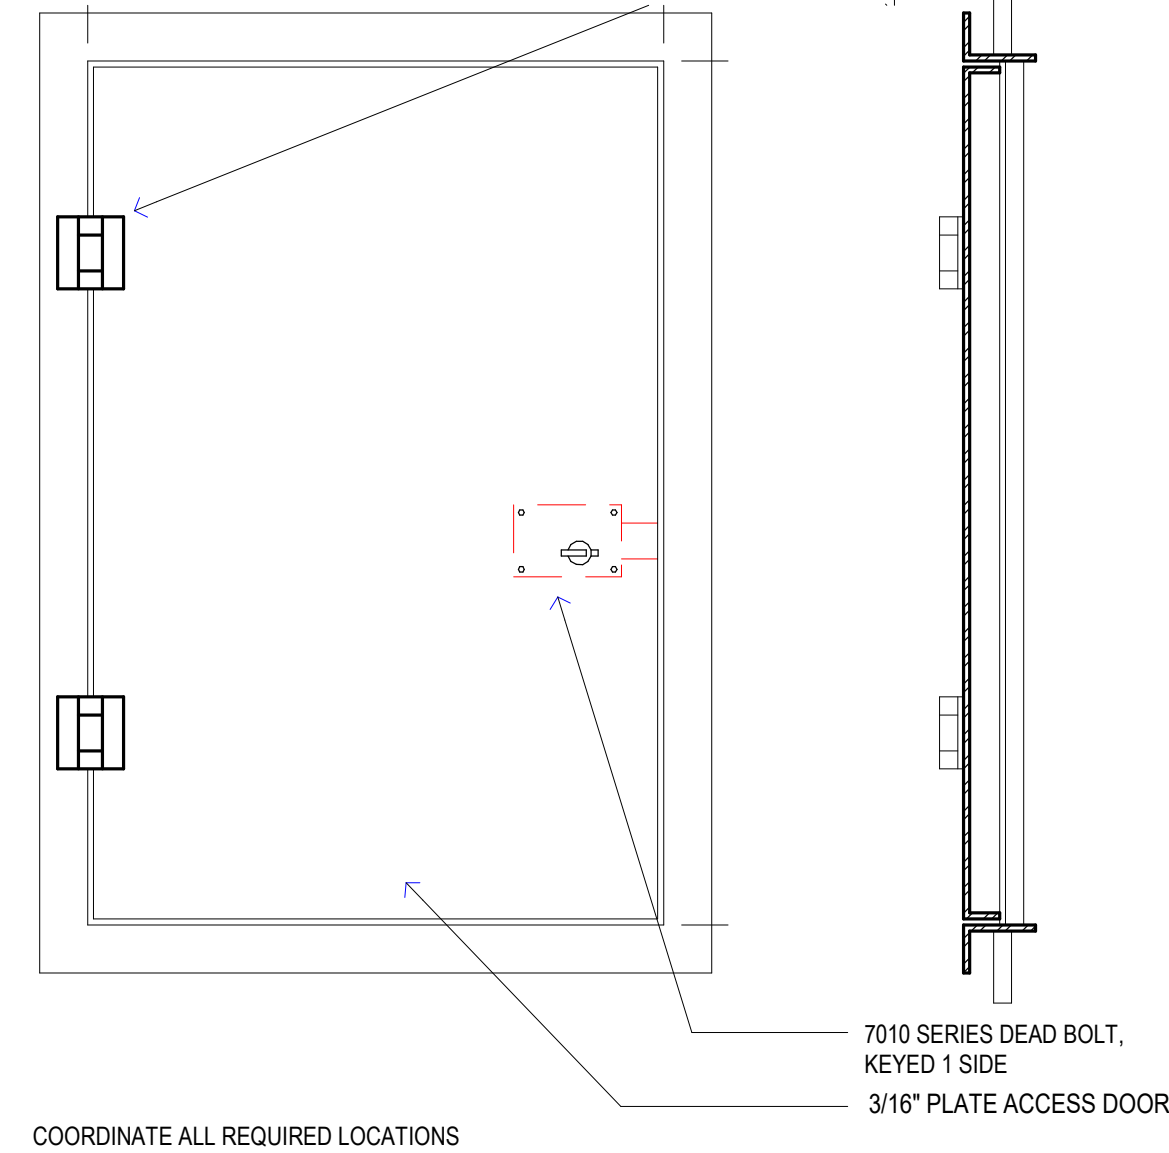
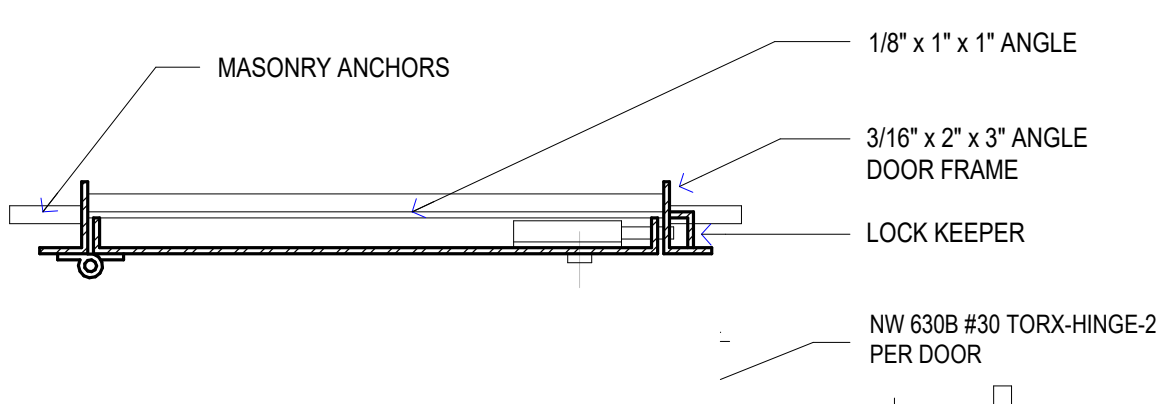
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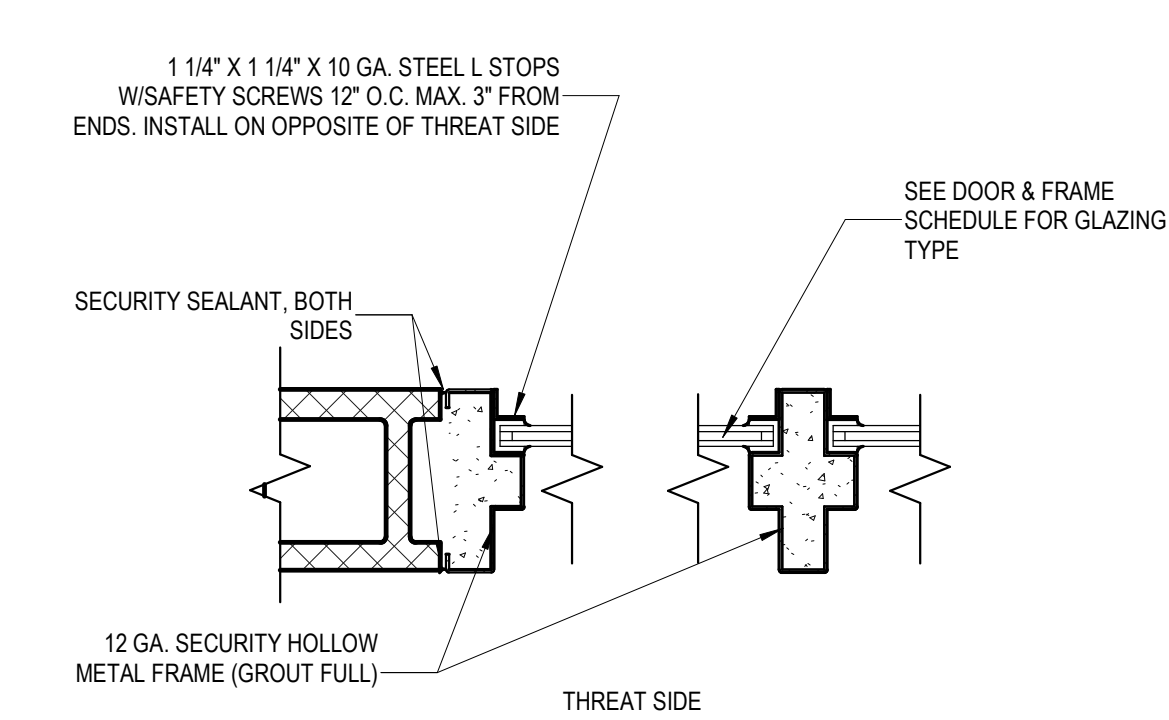
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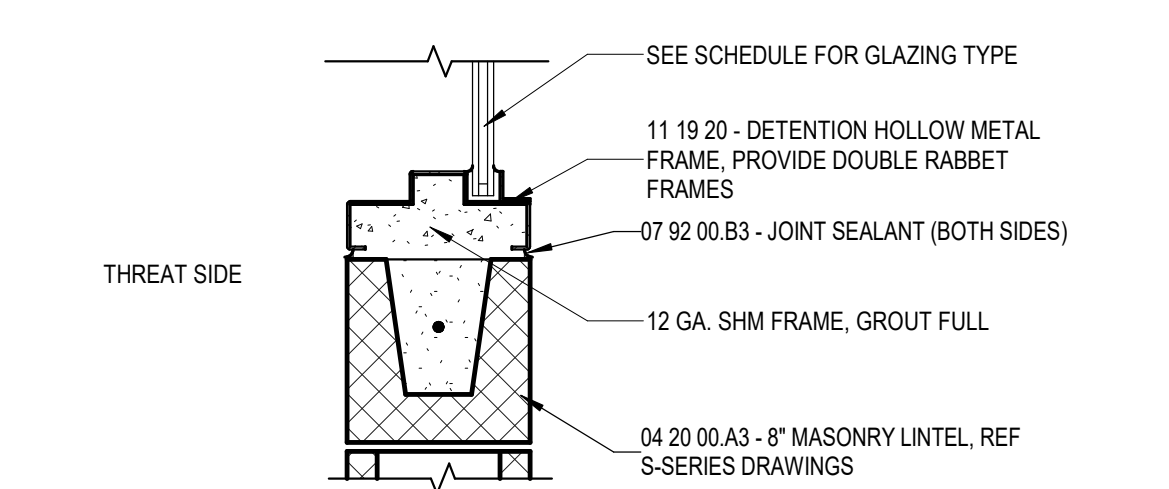
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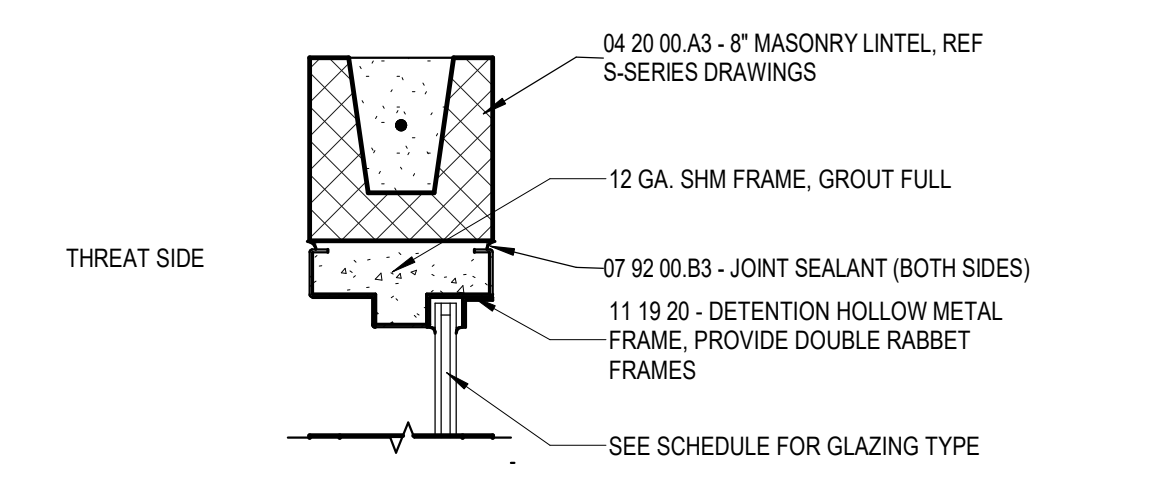
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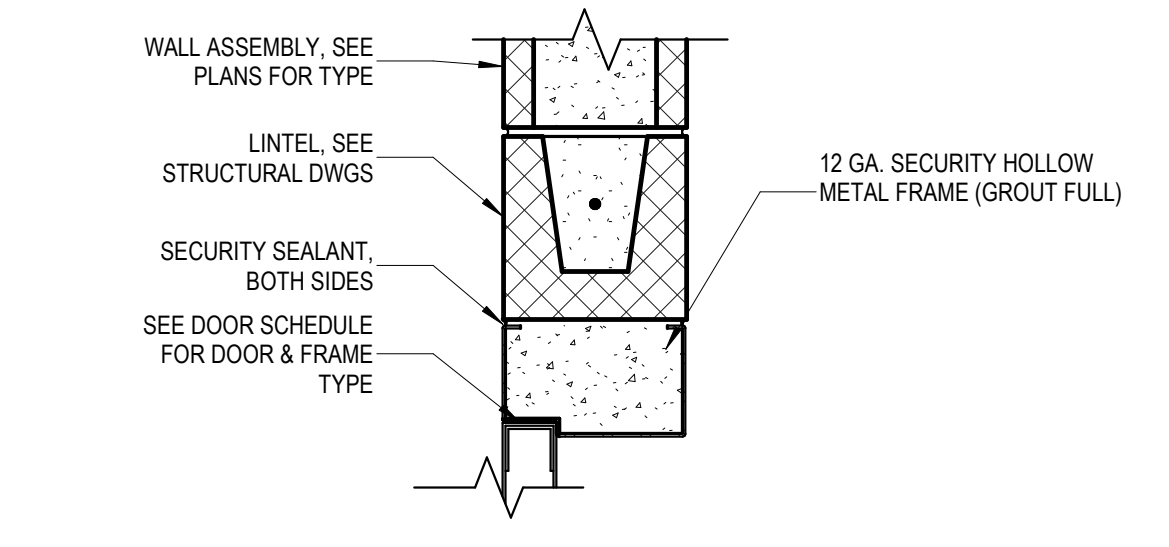
**2E SECURITY WINDOW FRAME JAMB DETAIL**  
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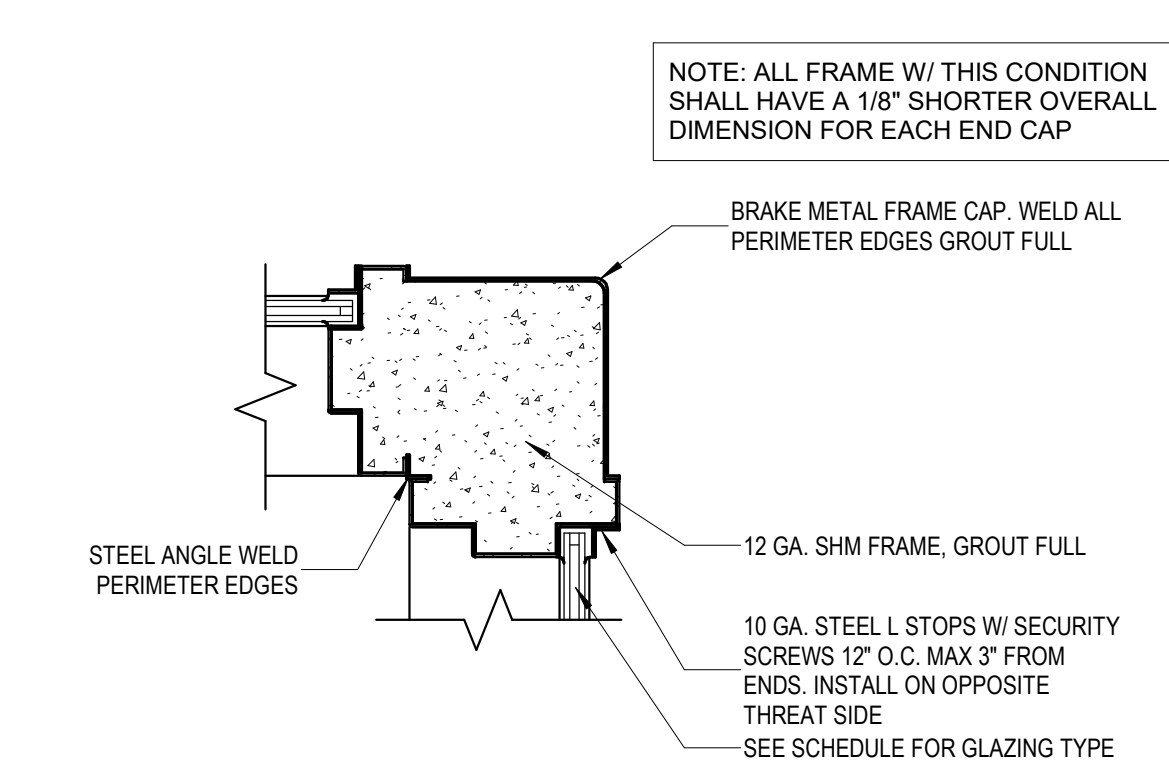
**2D SECURITY WINDOW FRAME SILL DETAIL**  
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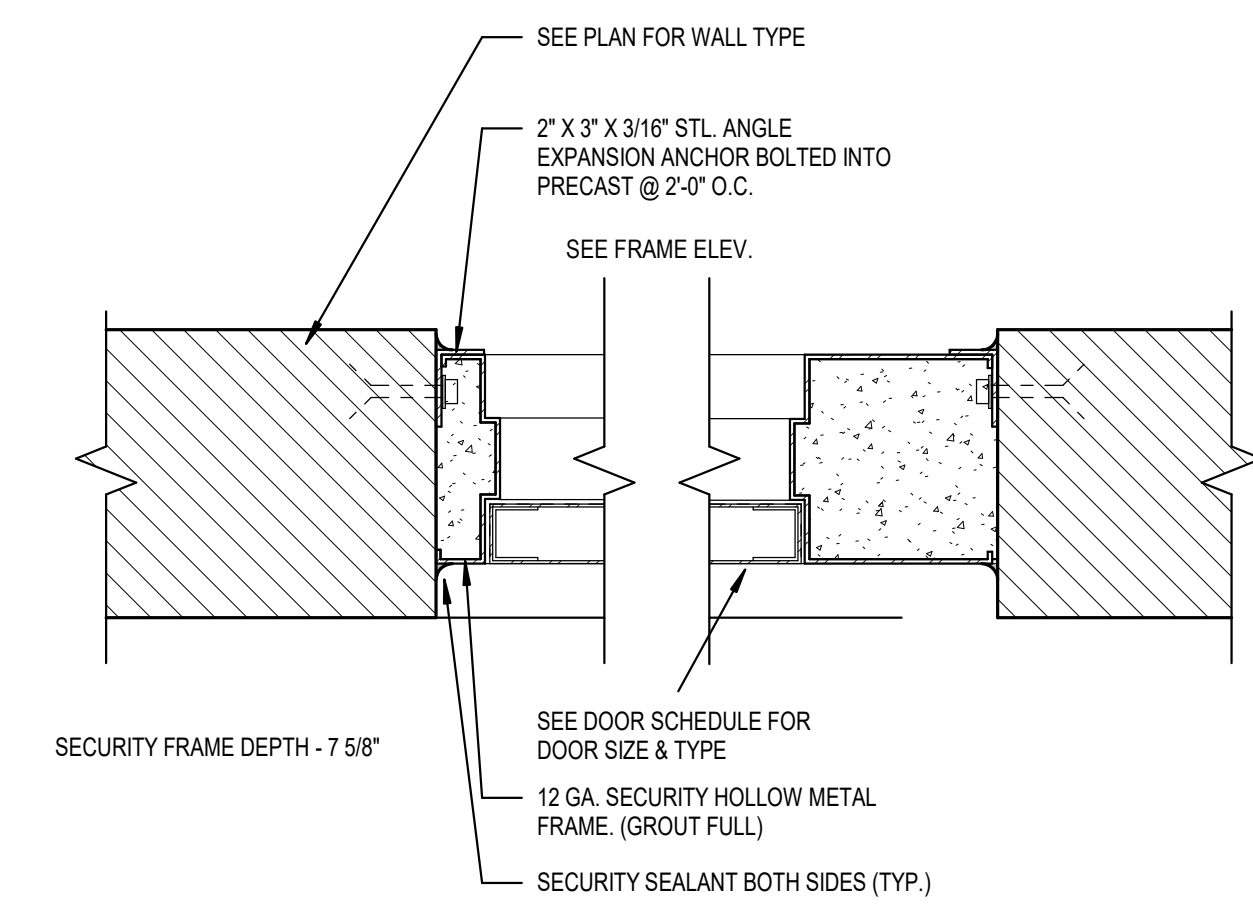
**2C SECURITY WINDOW FRAME HEAD DETAIL**  
1 1/2" = 1'-0"

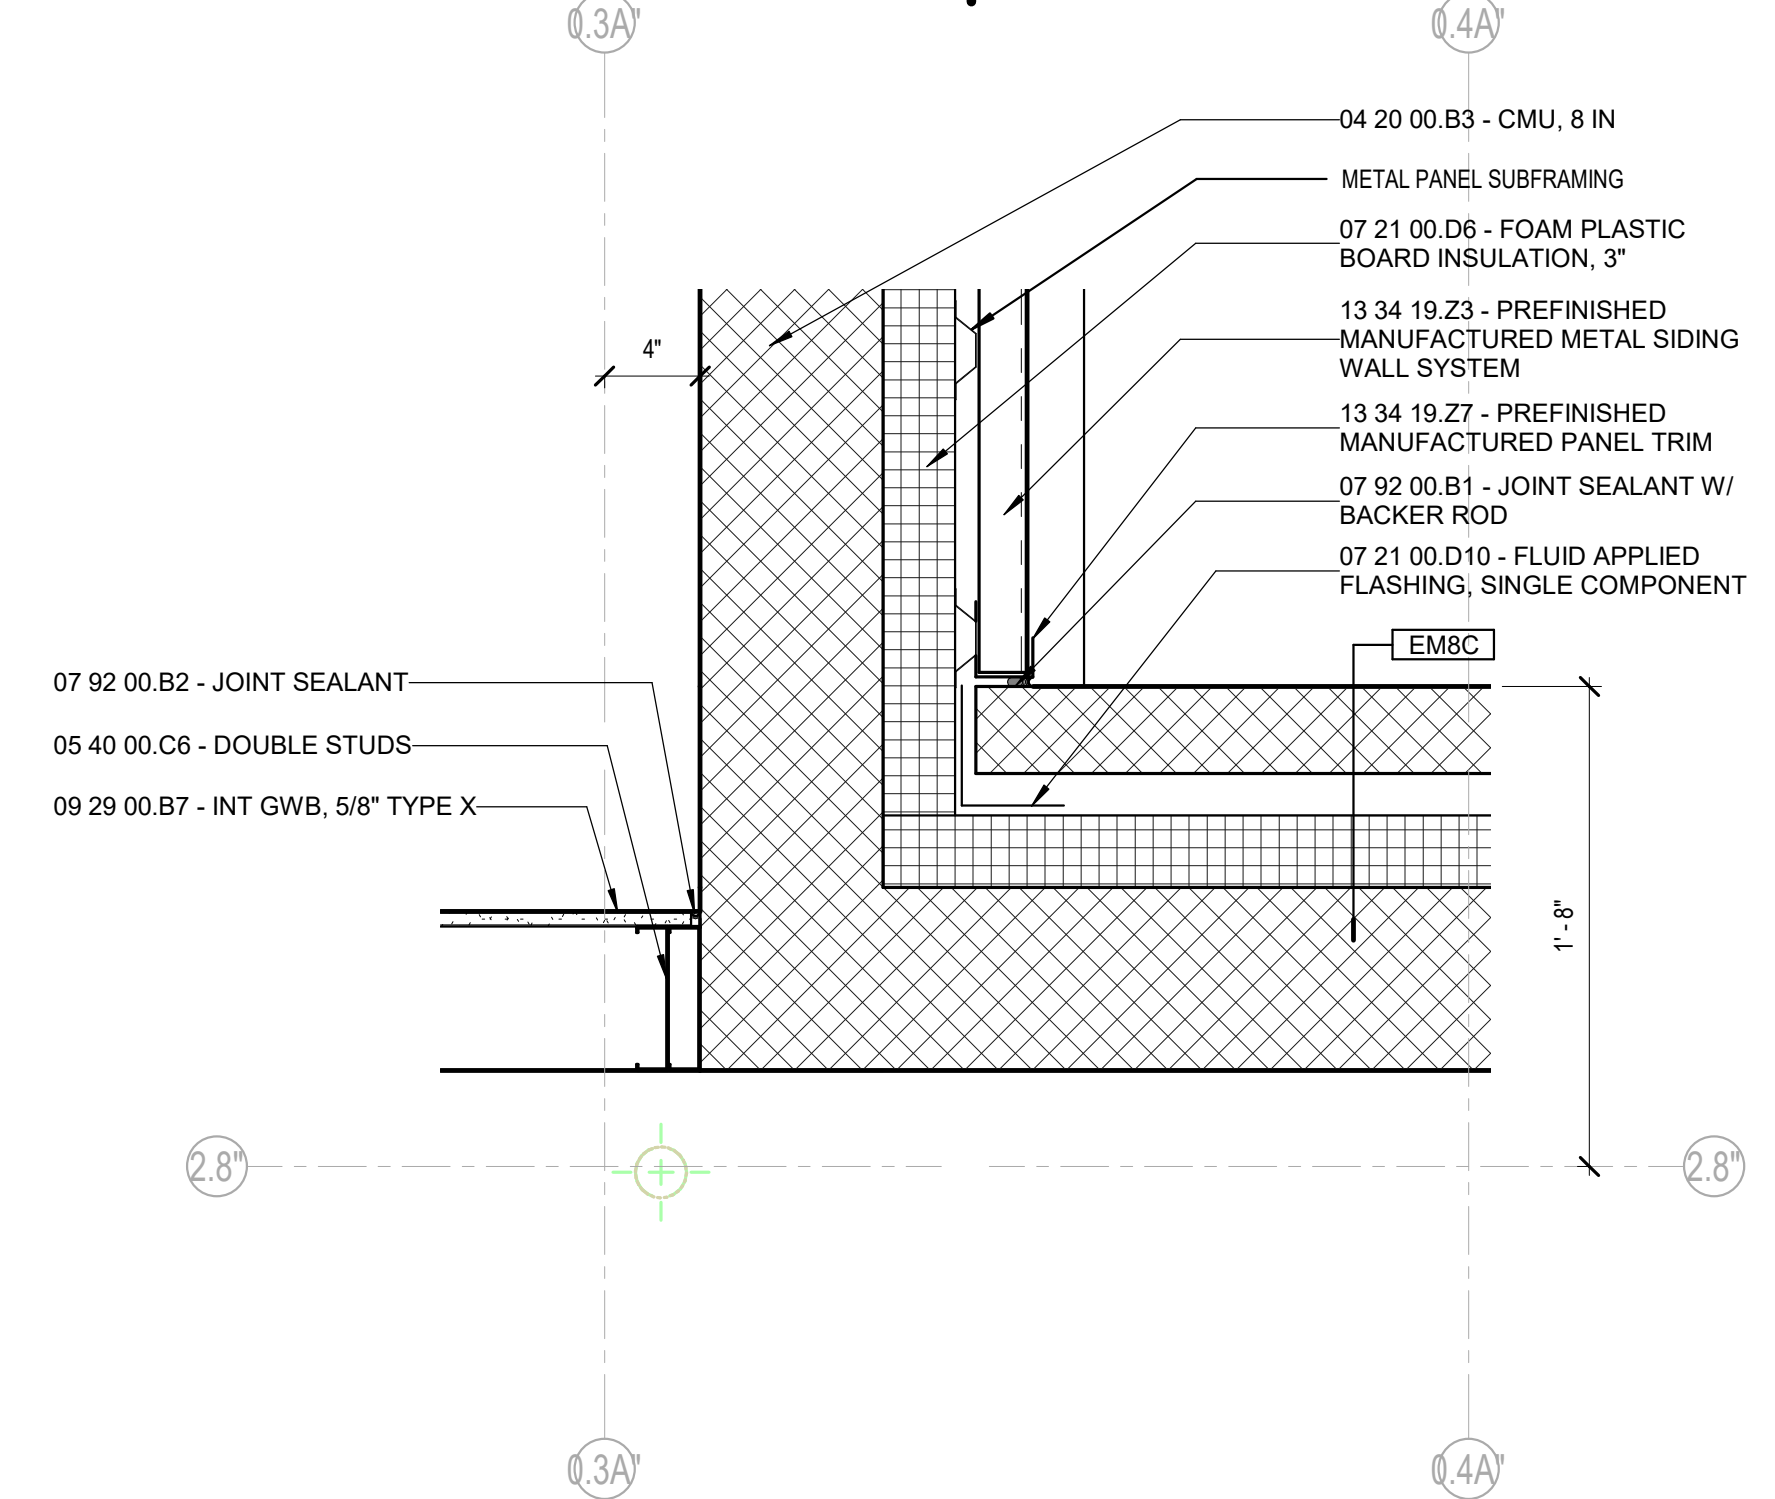


**2B SECURITY FRAME HEAD DETAIL**  
1 1/2" = 1'-0"





**2A SECURITY FRAME CORNER DETAIL**  
1 1/2" = 1'-0"

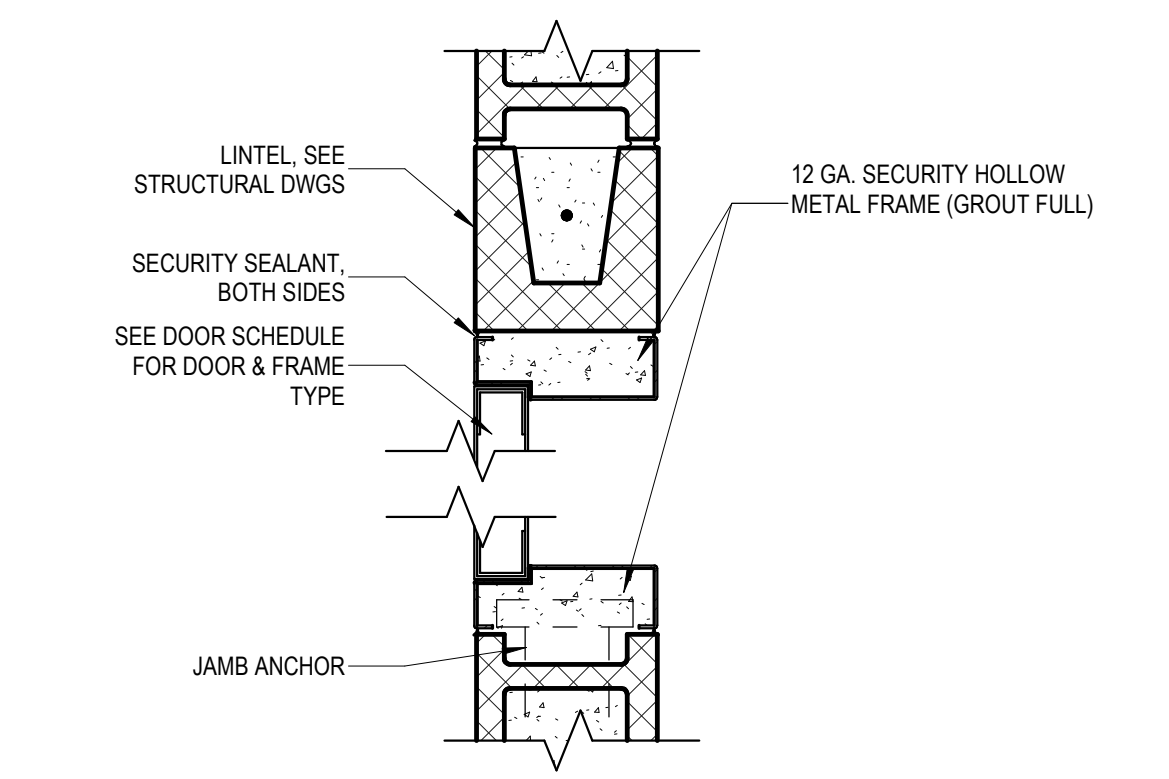

**4E SECURITY HOLLOW METAL JAMB DETAILS**  
1 1/2" = 1'-0"

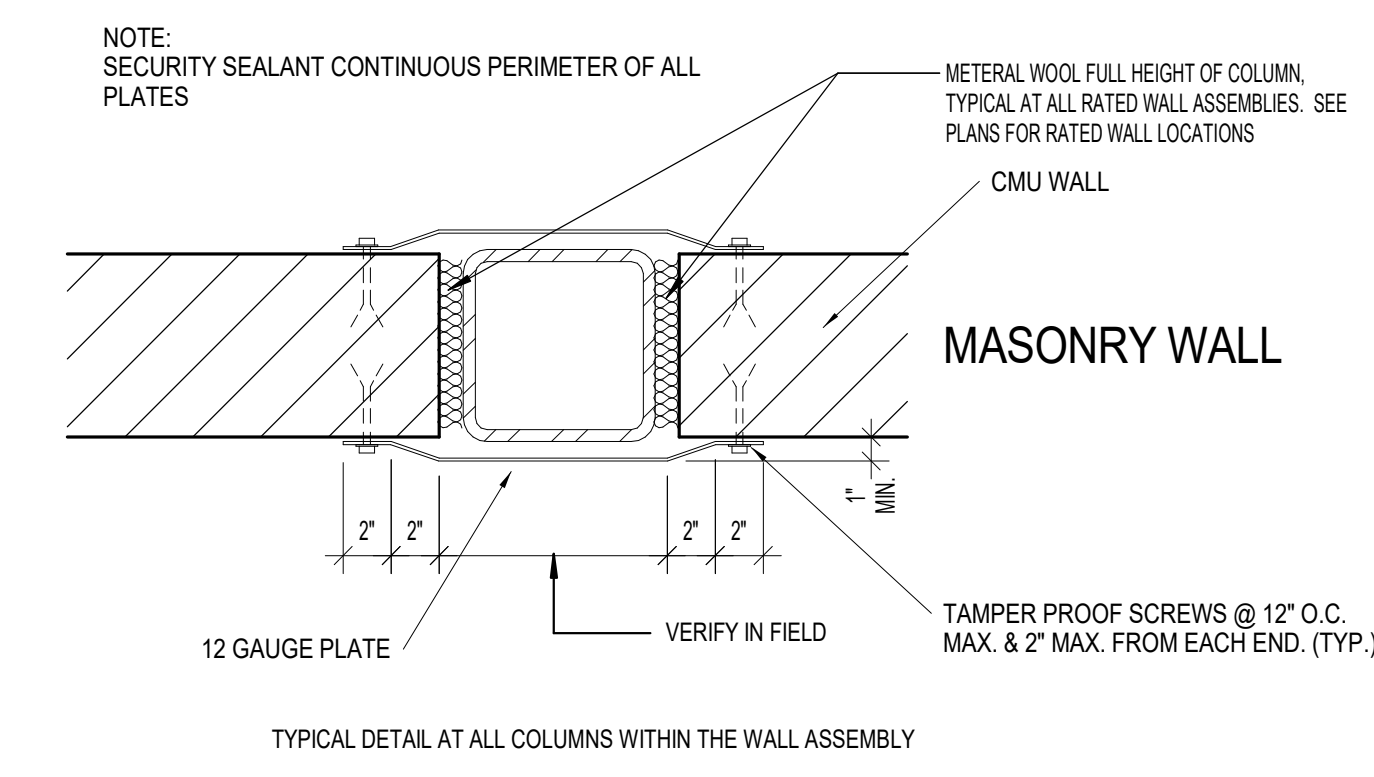


**4C SECURITY PLATE DETAIL**  
1 1/2" = 1'-0"

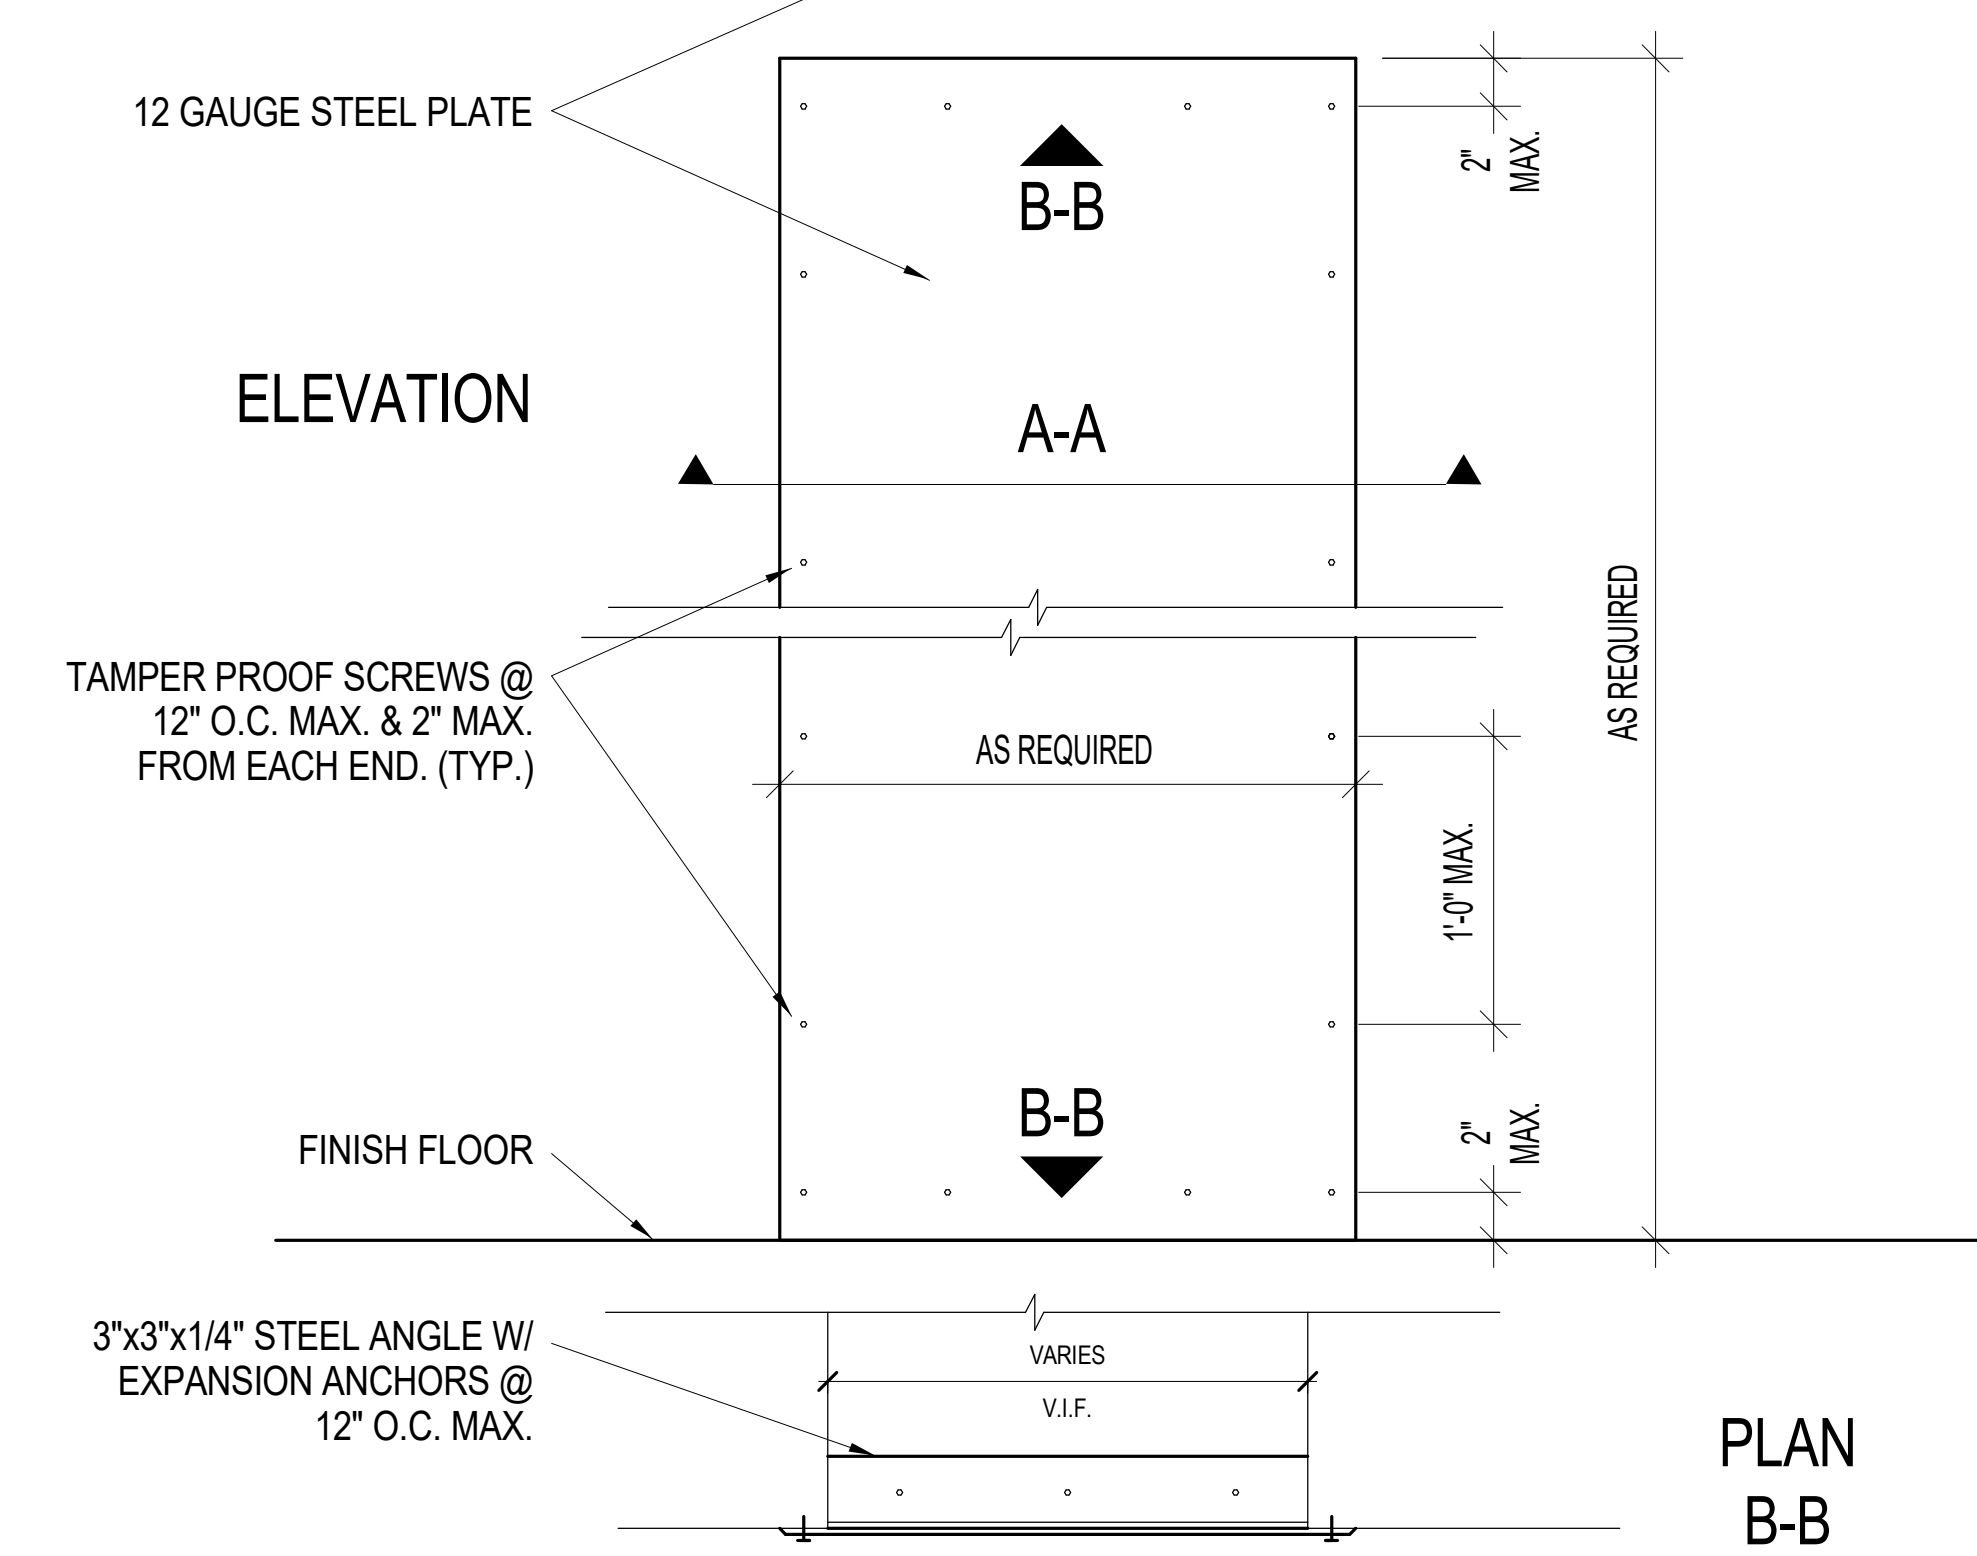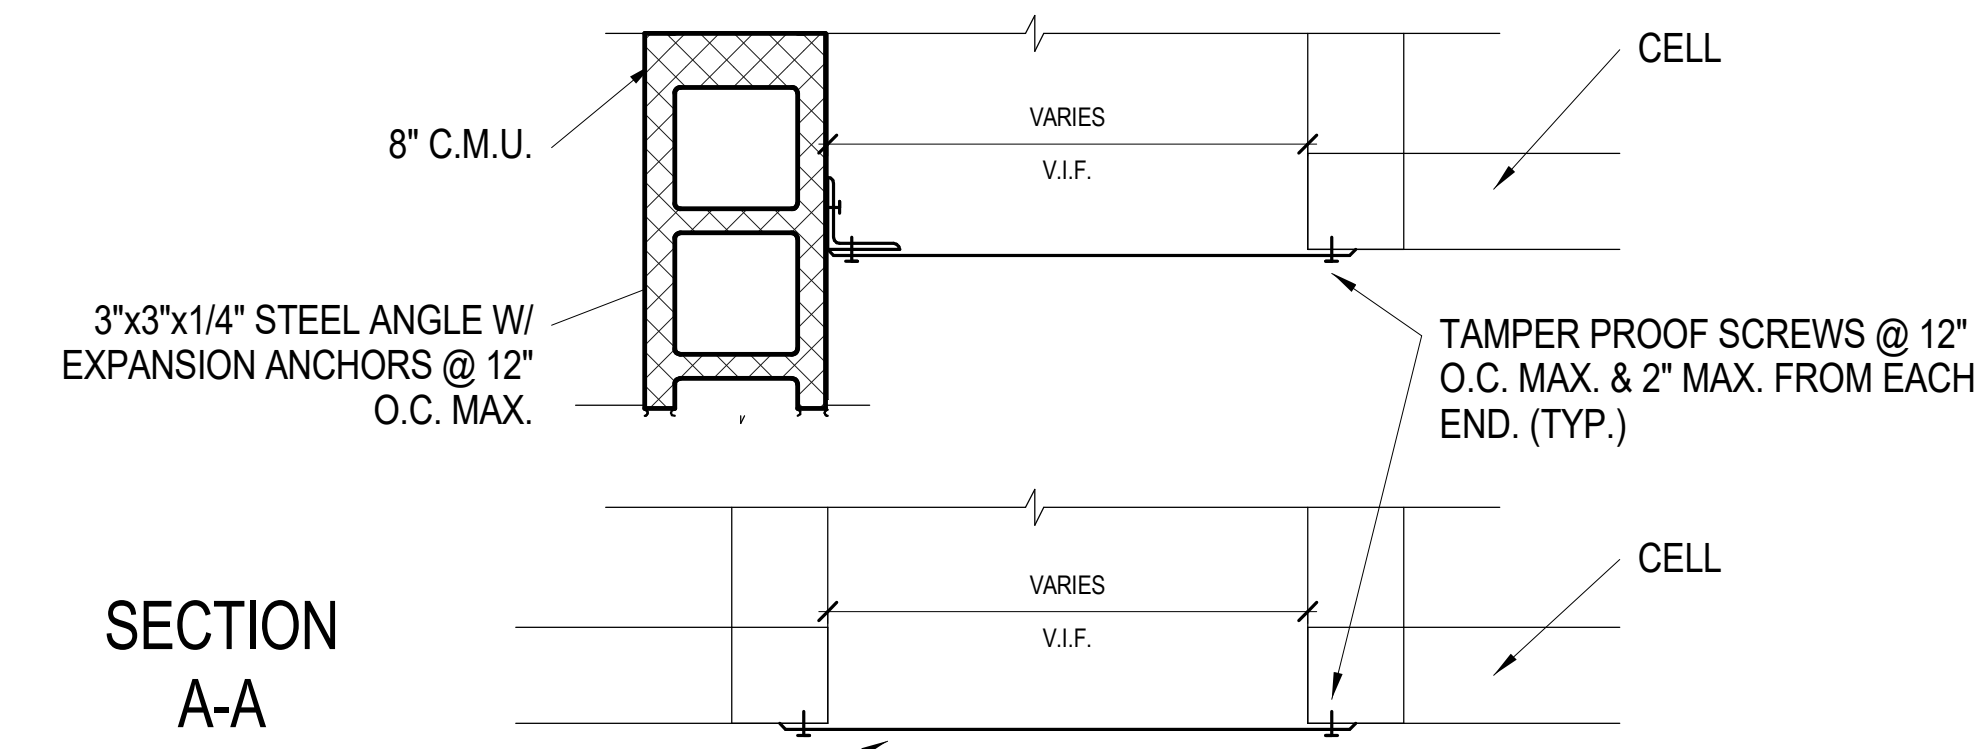

NOTE: SECURITY SEALANT CONTINUOUS PERIMETER OF ALL PLATES

TYPICAL DETAIL BETWEEN ALL STEEL CELLS AND STEEL CELL TO ADJACENT CMU


**4A SECURITY COVER PLATE**  
1 1/2" = 1'-0"

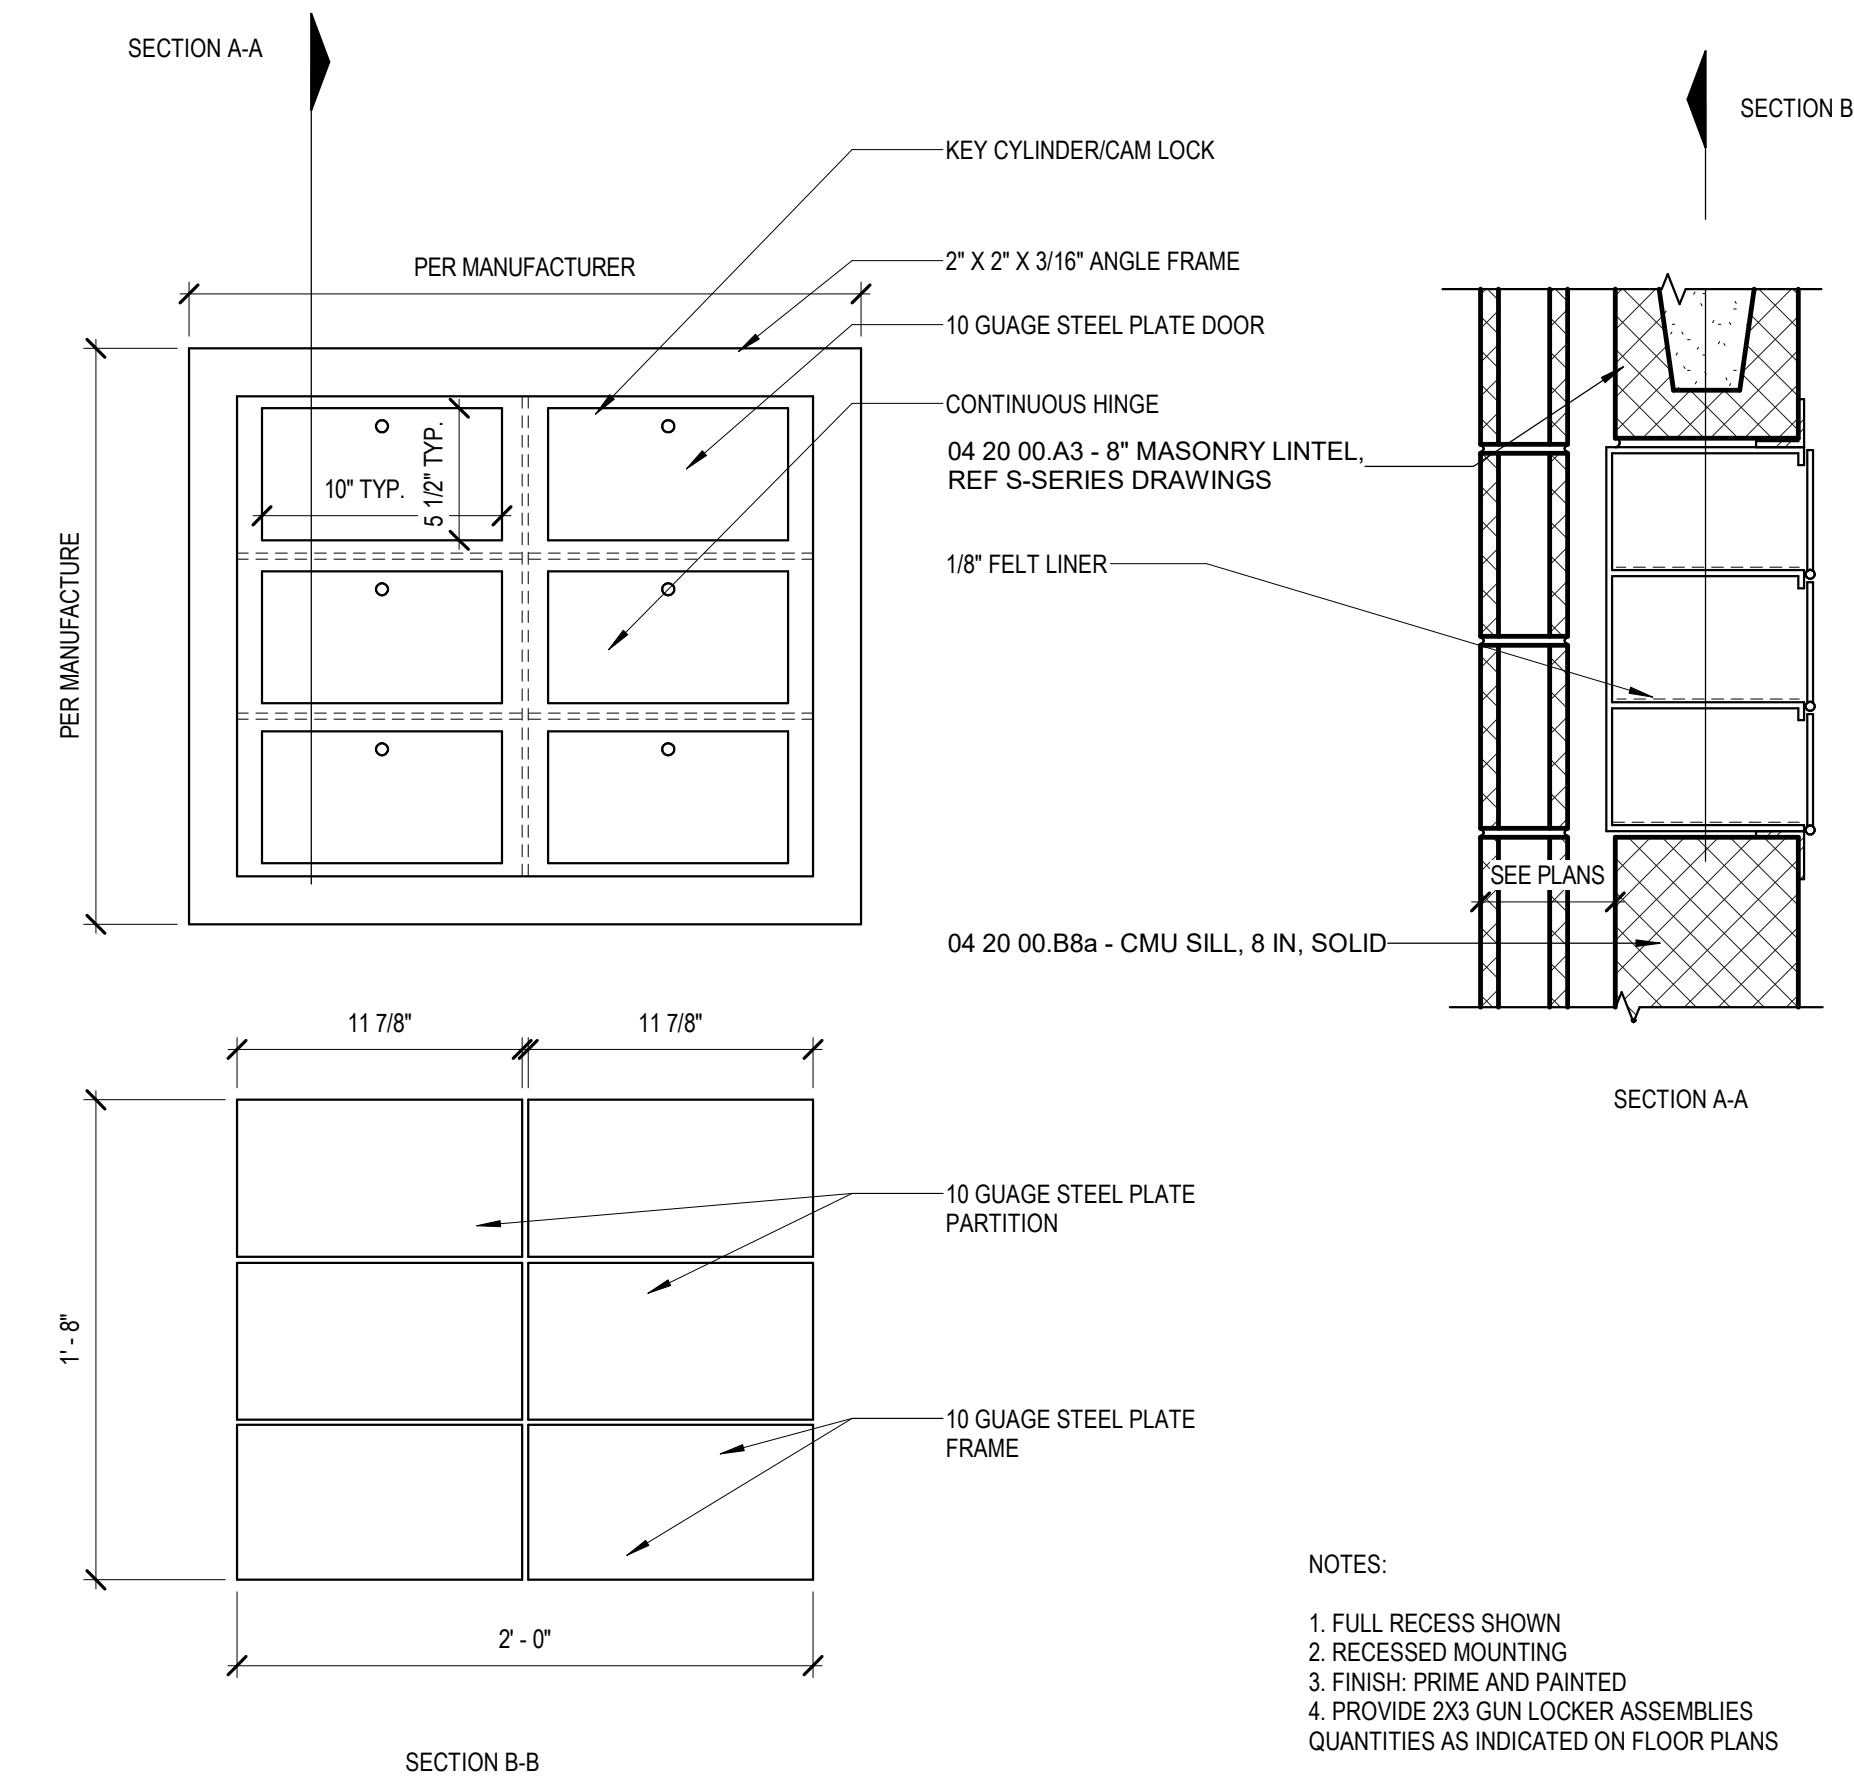

- NOTES:
1. FULL RECESS SHOWN
  2. RECESSED MOUNTING
  3. FINISH: PRIME AND PAINTED
  4. PROVIDE 2X3 GUN LOCKER ASSEMBLIES QUANTITIES AS INDICATED ON FLOOR PLANS

**1 GUN LOCKER DETAIL**  
1 1/2" = 1'-0"



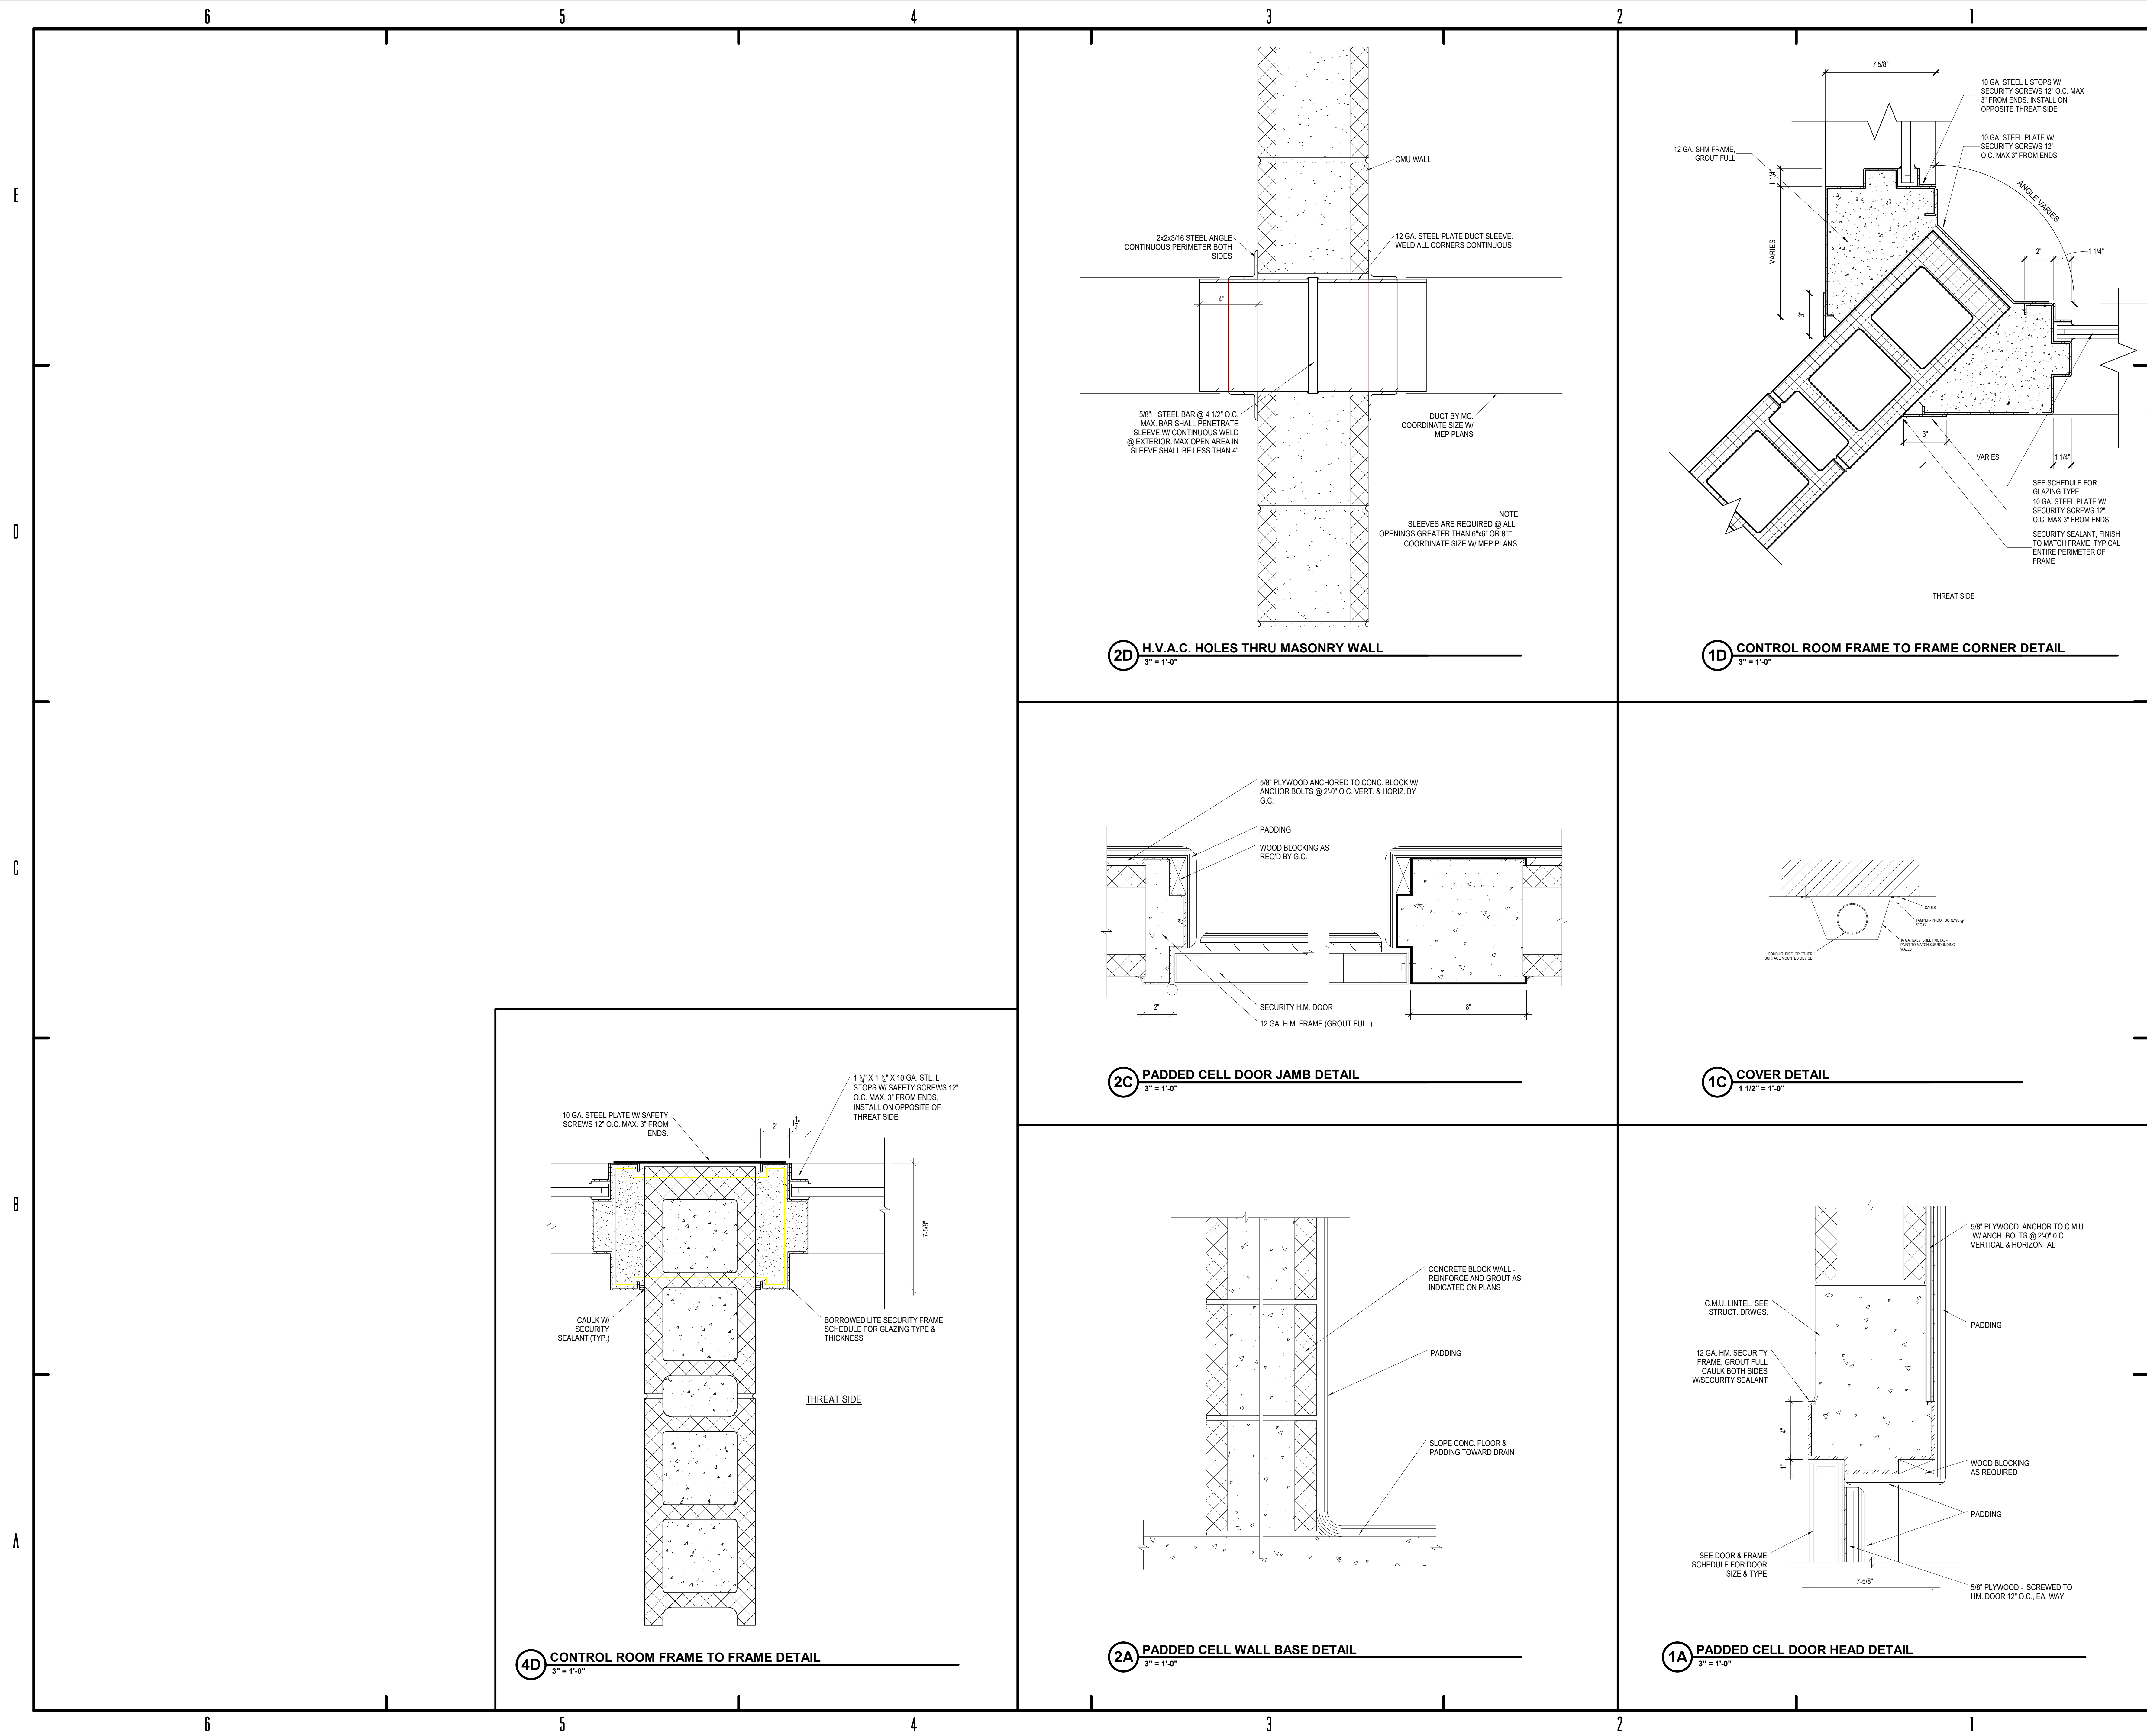


#	Revision	Date
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Project #: 20-700-151-2  
Designed By: LD/SP  
Drawn By: CP  
Checked By: LD/EV  
Date: 01.28.2022



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5.4.601 - DOOR & FRAME SCHEDULE - BASE BID															
MARK	From Room: Name	To Room: Name	DOOR PANEL					FRAME					LABEL	HW Set	NOTES
			TYPE	MATL	GLAZ	H	W	TH	MARK	MATL	GLAZ				
1112	PADDED	SECURED CORRIDOR	SGS5	SHM	SG2	7'-0"	3'-0"	2"	S1	SHM	--		S01.5		
1113	RR	SECURED CORRIDOR	SGS1	SHM	SG2	7'-0"	3'-0"	2"	S1	SHM	--		S04.4		
1114	PADDED	SECURED CORRIDOR	SGS5	SHM	SG-FR2	7'-0"	3'-0"	2"	S1	SHM	--	45 MIN.	S01.5		
1115.1	PADDED	SECURED CORRIDOR	SGS5	SHM	SG-FR2	7'-0"	3'-0"	2"	S1	SHM	--	45 MIN.	S01.5		
1117	WAITING	RR	SGS1	SHM	SG2	7'-0"	3'-0"	2"	S1	SHM	--		S04.1		
1119	DAYROOM	DAYROOM	SF	SHM	--	7'-0"	3'-0"	2"	S1	SHM	--	45 MIN.	S06.1		
1120.1	SECURED CORRIDOR	NURSE OFFICE	SN	SHM	SG2	7'-0"	3'-0"	2"	S6	SHM	SG2		S04.1		
1120.2	SECURED CORRIDOR	NURSE OFFICE	SN	SHM	SG2	7'-0"	3'-0"	2"	S6	SHM	SG2		S04.1		
1125	BOOK IN CENTER	PROPERTY STORAGE	SF	HM	--	7'-0"	3'-0"	2"	S1	SHM	--	90 MIN.	S04.1		
1126	NURSE OFFICE	NURSE STORAGE	F	HM	--	7'-0"	3'-0"	13/4"	F2	HM	--		14.0		
1127	NURSE OFFICE	STOR.	F	HM	--	7'-0"	3'-0"	13/4"	F2	HM	--		21.0		
1128A	SECURED CORRIDOR	EXAM	N	HM	SG2	7'-0"	3'-0"	13/4"	F1	HM	--		24.0		
1128B	SECURED CORRIDOR	EXAM	N	HM	SG2	7'-0"	3'-0"	13/4"	F1	HM	--		24.0		
1129	DRESS	SECURED CORRIDOR	SGS1	SHM	SG2	7'-0"	3'-0"	2"	S1	SHM	--		S04.1		
1139A	PADDED	RR	SF	SHM	--	7'-0"	3'-0"	2"	S1	SHM	--	45 MIN.	S01.4		
1139B	SECURED CORRIDOR	RR	SGS1	SHM	SG2	7'-0"	3'-0"	2"	S1	SHM	--		S04.4		
1139C	RR	PADDED	SGS1	SHM	SG2	7'-0"	3'-0"	2"	S1	SHM	--	45 MIN.	S01.4		
1246.1	ELECT.	ELECT.	F	HM	--	7'-0"	3'-0"	13/4"	F2	HM	--		20.0		
1246.2	ELECT.	F	HM	--	7'-0"	3'-0"	13/4"	F2	HM	--			5.0		
1301.1	OFFICE	OFFICE	F	HM	--	7'-0"	6'-0"	13/4"	F2	HM	--	45 MIN.	18.5		
1501.1	SALLYPORT	OH	SF	SHM	--	7'-0"	3'-0"	2"	S1	SHM	--		S09.1		
1501.2	SALLYPORT	OH	ST	--	14'-0"	16'-0"	2"	-	ST	--					
1501.3	SALLYPORT	OH	ST	--	14'-0"	16'-0"	2"	-	ST	--					
1501.4	SALLYPORT	SF	SHM	--	7'-0"	3'-0"	2"	S1	SHM	--			S09.1		
1501.5	SALLYPORT	OH	ST	--	14'-0"	16'-0"	2"	-	ST	--					
1501.6	SALLYPORT	OH	ST	--	14'-0"	16'-0"	2"	-	ST	--					
1502	SALLYPORT	MATERIAL STORAGE	F	HM	--	7'-0"	6'-0"	13/4"	F2	HM	--		27.0		
1503	SALLYPORT	MAINTENANCE WORK AREA	F	HM	--	7'-0"	3'-0"	13/4"	F2	HM	--		21.0		
1504	SALLYPORT	MAINT. OFFICE	F	HM	--	7'-0"	3'-0"	13/4"	F2	HM	--		28.0		
1505	PRE-PROCESS	SALLYPORT	SGD	SHM	SG2	7'-0"	3'-0"	2"	S2	SHM	SG2		S04.1		
1506	PREPROCESS HOLD	PRE-PROCESS	SGP3	SHM	SG2	7'-0"	3'-0"	2"	S1	SHM	--		S01.1		
1507	PREPROCESS HOLD	PRE-PROCESS	SGP3	SHM	SG2	7'-0"	3'-0"	2"	S1	SHM	--		S01.1		
1508	GROUP HOLD	BOOK IN CENTER	SGP3	SHM	SG2	7'-0"	3'-0"	2"	S1	SHM	--		S04.5		
1509	FILE STOR.	PRE-PROCESS	F	HM	--	7'-0"	3'-0"	13/4"	F2	HM	--		25.0		
1510.1	PRE-PROCESS	BREATH	SG	SHM	SG2	7'-0"	3'-0"	2"	S1	SHM	--		S04.1		
1510.2	BREATH	SALLYPORT	G	HM	SG2	7'-0"	3'-0"	13/4"	F2	HM	--		15.0		
1511.1	BOOK IN CENTER	PRE-PROCESS	SN	SHM	SG2	7'-0"	3'-0"	2"	S6	SHM	SG2		S04.1		
1511.2	SECURED CORRIDOR	BOOK IN CENTER	SN	SHM	SG2	7'-0"	3'-0"	2"	S1	SHM	--		S04.1		
1513	GROUP HOLD	BOOK IN CENTER	SGP3	SHM	SG2	7'-0"	3'-0"	2"	S1	SHM	--		S01.1		
1514	IT ROOM	BOOK IN CENTER	F	HM	--	7'-0"	3'-0"	13/4"	F2	HM	--		25.0		
1515	BOOK IN COUNTER	STAFF RR	F	HM	--	7'-0"	3'-0"	13/4"	F2	HM	--		31.0		
1516	BOOK IN COUNTER	OFFICE	SN	SHM	SG2	7'-0"	3'-0"	13/4"	S6	SHM	SG2		S04.1		
1517	JAN.	BOOK IN CENTER	SF	SHM	--	7'-0"	3'-0"	2"	S1	SHM	--		S04.1		
1518	DAYROOM	BOOK IN CENTER	SGP2	SHM	SG2	7'-0"	3'-0"	2"	S1	SHM	SG2		S04.1		
1519	DAYROOM	ISO	SGS2	SHM	SG2	7'-0"	3'-0"	2"	S1	SHM	--		S01.2		
1520	DAYROOM	F	HM	--	7'-0"	2'-4"	13/4"	F2	HM	--			24.0		
1521	DAYROOM	ISO	SGS2	SHM	SG2	7'-0"	3'-0"	2"	S1	SHM	--		S01.2		
1522	GROUP HOLDING	DAYROOM	SGS2	SHM	SG2	7'-0"	3'-0"	2"	S1	SHM	--		S01.2		
1523	DAYROOM	ISO	SGS2	SHM	SG2	7'-0"	3'-0"	2"	S1	SHM	--		S01.2		
1524	DAYROOM	F	HM	--	7'-0"	2'-4"	13/4"	F2	HM	--			24.0		
1525	DAYROOM	ISO	SGS2	SHM	SG2	7'-0"	3'-0"	2"	S1	SHM	--		S01.2		
1526	DAYROOM	ISO	SGS2	SHM	SG2	7'-0"	3'-0"	2"	S1	SHM	--		S01.2		
1527	DAYROOM	F	HM	--	7'-0"	2'-4"	13/4"	F2	HM	--			24.0		
1528	DAYROOM	ISO	SGS2	SHM	SG2	7'-0"	3'-0"	2"	S1	SHM	--		S01.2		
1529	ISO	DAYROOM	SGS2	SHM	SG2	7'-0"	3'-0"	2"	S1	SHM	--		S01.2		
1531.1	SHOWER	DAYROOM	SGS1	SHM	SG2	7'-0"	3'-0"	2"	S1	SHM	--		S04.2		
1531.2	SHOWER	BOOK IN CENTER	SGS1	SHM	SG2	7'-0"	3'-0"	2"	S1	SHM	--		S04.1		
1531A	STORAGE	BOOK IN CENTER	F	HM	--	7'-0"	2'-4"	13/4"	F2	HM	--		24.0		
1532	MECHANICAL	F	HM	--	7'-0"	6'-0"	13/4"	F2	HM	--			7.0		
1542	DRY STORAGE	KITCHEN STORAGE	F	HM	--	7'-0"	3'-0"	13/4"	F2	HM	--	90 MIN.			
1544	PADDED	RR	SF	SHM	--	7'-0"	3'-0"	2"	S1	SHM	--		S01.4		
1546	PADDED	RR	SF	SHM	--	7'-0"	3'-0"	2"	S1	SHM	--		S01.4		
1902.1	OFFICE	OUTDOOR RECREATION	SF	SHM	--	7'-0"	3'-0"	2"	S1	SHM	--		S04.1		
1603	DETENTION CORRIDOR	PROGRAMMING	SG	SHM	SG2	7'-0"	3'-0"	2"	S1	SHM	--	90 MIN.	S04.1		
1604	STOR	PROGRAMMING	F	HM	--	7'-0"	3'-0"	13/4"	F2	HM	--		21.0		
1604.2	OUTDOOR RECREATION	SGS4	SHM	SG2	7'-0"	3'-0"	2"	S1	SHM	--			S04.3		
1605	DETENTION CORRIDOR	VIDEO COURT	SF	SHM	SG2	7'-0"	3'-0"	2"	S1	SHM	--		S04.1		
1606	STOR	VIDEO COURT	F	HM	--	7'-0"	3'-0"	13/4"	F2	HM	--		24.0		
1607	JAN.	DETENTION CORRIDOR	F	HM	--	7'-0"	3'-0"	13/4"	F2	HM	--		24.0		
1608.1	INDOOR/OUTDOOR REC	DETENTION CORRIDOR	SGS4	SHM	SG-FR2	7'-0"	3'-0"	2"	S1	SHM	--	45 MIN.	S04.3		
1608.2	OUTDOOR RECREATION	INDOOR/OUTDOOR REC	SF	SHM	--	7'-0"	3'-0"	2"	S1	SHM	--	45 MIN.	S04.1		
1609	INDOOR/OUTDOOR REC	RR	SF	SHM	--	7'-0"	3'-0"	2"	S1	SHM	--		S04.4		
1610.1	INDOOR/OUTDOOR REC	SALLYPORT	SF	SHM	--	7'-0"	3'-0"	2"	S1	SHM	--		S04.1		
1610.2	SALLYPORT	SF	SHM	--	7'-0"	3'-0"	2"	S1	SHM	--			S01.1		
1611	STOR	SALLYPORT	F	HM	SG2	7'-0"	3'-0"	13/4"	F2	HM	--		21.0		
1612.1	MECHANICAL	SALLYPORT	F	HM	--	7'-0"	6'-0"	13/4"	F2	HM	--		27.5		
1612.2	MECHANICAL	MECHANICAL	F	HM	--	7'-0"	6'-0"	13/4"	F2	HM	--		27.5		
1612.3	MECH	MECHANICAL	F	HM	SG2	7'-0"	3'-0"	13/4"	F2	HM	--		24.0		
1614.1	DETENTION CORRIDOR	DAYROOM	SGS4	SHM	SG-FR2	7'-0"	3'-0"	2"	S1	SHM	--	45 MIN.	S04.3		
1614.2	DAYROOM	DAYROOM	SF	SHM	--	7'-0"	3'-0"	2"	S1	SHM	--		S06.1		
1614.3	INDOOR/OUTDOOR REC	DAYROOM	SF	SHM	--	7'-0"	3'-0"	2"	S1	SHM	--		S06.1		
1615.1	DAYROOM	DETENTION CORRIDOR	SGS4	SHM	SG-FR2	7'-0"	3'-0"	2"	S1	SHM	--	45 MIN.	S04.3		
1616	DETENTION CORRIDOR	DAYROOM	SGS4	SHM	SG2	7'-0"	3'-0"	2"	S1	SHM	--		S04.3		
1616.2	DAYROOM	DAYROOM	SF	SHM	--	7'-0"	3'-0"	2"	S1	SHM	--		S06.1		
1617	DAYROOM	4 BED ADA CELL	SGP2	SHM	SG2	7'-0"	3'-0"	2"	S2	SHM	SG2		S01.3		
1618	DAYROOM	4 BED CELL	SGP2	SHM	SG2	7'-0"	3'-0"	2"	S2	SHM	SG2		S01.3		
1619	DAYROOM	4 BED CELL	SGP2	SHM	SG2	7'-0"	3'-0"	2"	S2	SHM	SG2		S01.3		
1620	DAYROOM	4 BED CELL	SGP2	SHM	SG2	7'-0"	3'-0"	2"	S2	SHM	SG2		S01.3		
1621	DETENTION CORRIDOR	DAYROOM	SGS4	SHM	SG2	7'-0"	3'-0"	2"	S1	SHM	--		S01.3		
1622	DAYROOM	4 BED CELL	SGP2	SHM	SG2	7'-0"	3'-0"	2"	S2	SHM	SG2		S01.3		
1623	DAYROOM	4 BED CELL	SGP2	SHM	SG2	7'-0"	3'-0"	2"	S2	SHM	SG2		S01.3		
1624	DAYROOM	4 BED CELL	SGP2	SHM	SG2	7'-0"	3'-0"	2"	S2	SHM	SG2		S01.3		
1639	ATRIUM/CLINET	DETENTION CORRIDOR	SG	SHM	SG2	7'-0"	3'-0"	2"	S1	SHM	--		S04.3		
1640	DETENTION CORRIDOR	ATRIUM/CLINET	SG	SHM	SG2	7'-0"	3'-0"	2"	S1	SHM	--		S04.1		
1641.1	DETENTION CORRIDOR	CLASSROOM	SG	SHM	SG2	7'-0"	3'-0"	2"	S1	SHM	--		S04.1		
1642	DETENTION CORRIDOR	OFFICE	SG	SHM	SG2	7'-0"	3'-0"	2"	S1	SHM	--		S04.1		
1643	OFFICE	F	HM	--	7'-0"	3'-0"	13/4"	F2	HM	--	45 MIN.	28.5			
1644.1	TRAINING ROOM	TRAINING ROOM	F	HM	--	7'-0"	3'-0"	13/4"	F2	HM	--	45 MIN.	28.5		

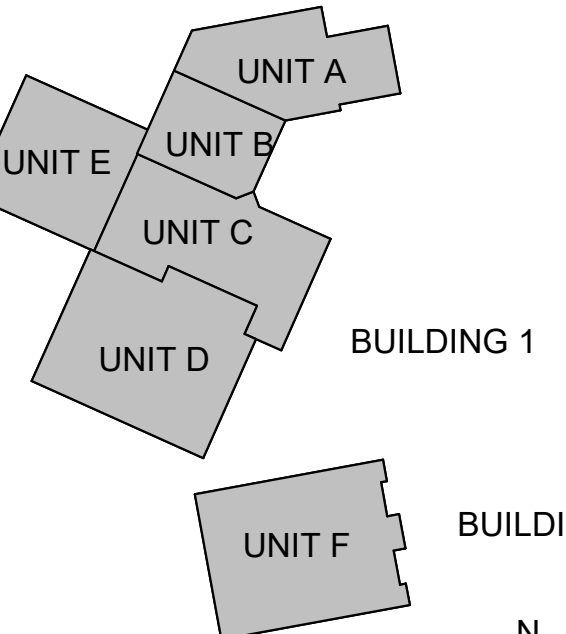


#	Revision	Date
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Project #: 20-700-151-2  
Designed By: Designer  
Drawn By: Author  
Checked By: Checker  
Date: 01.28.2022




*Eric Weiler*  
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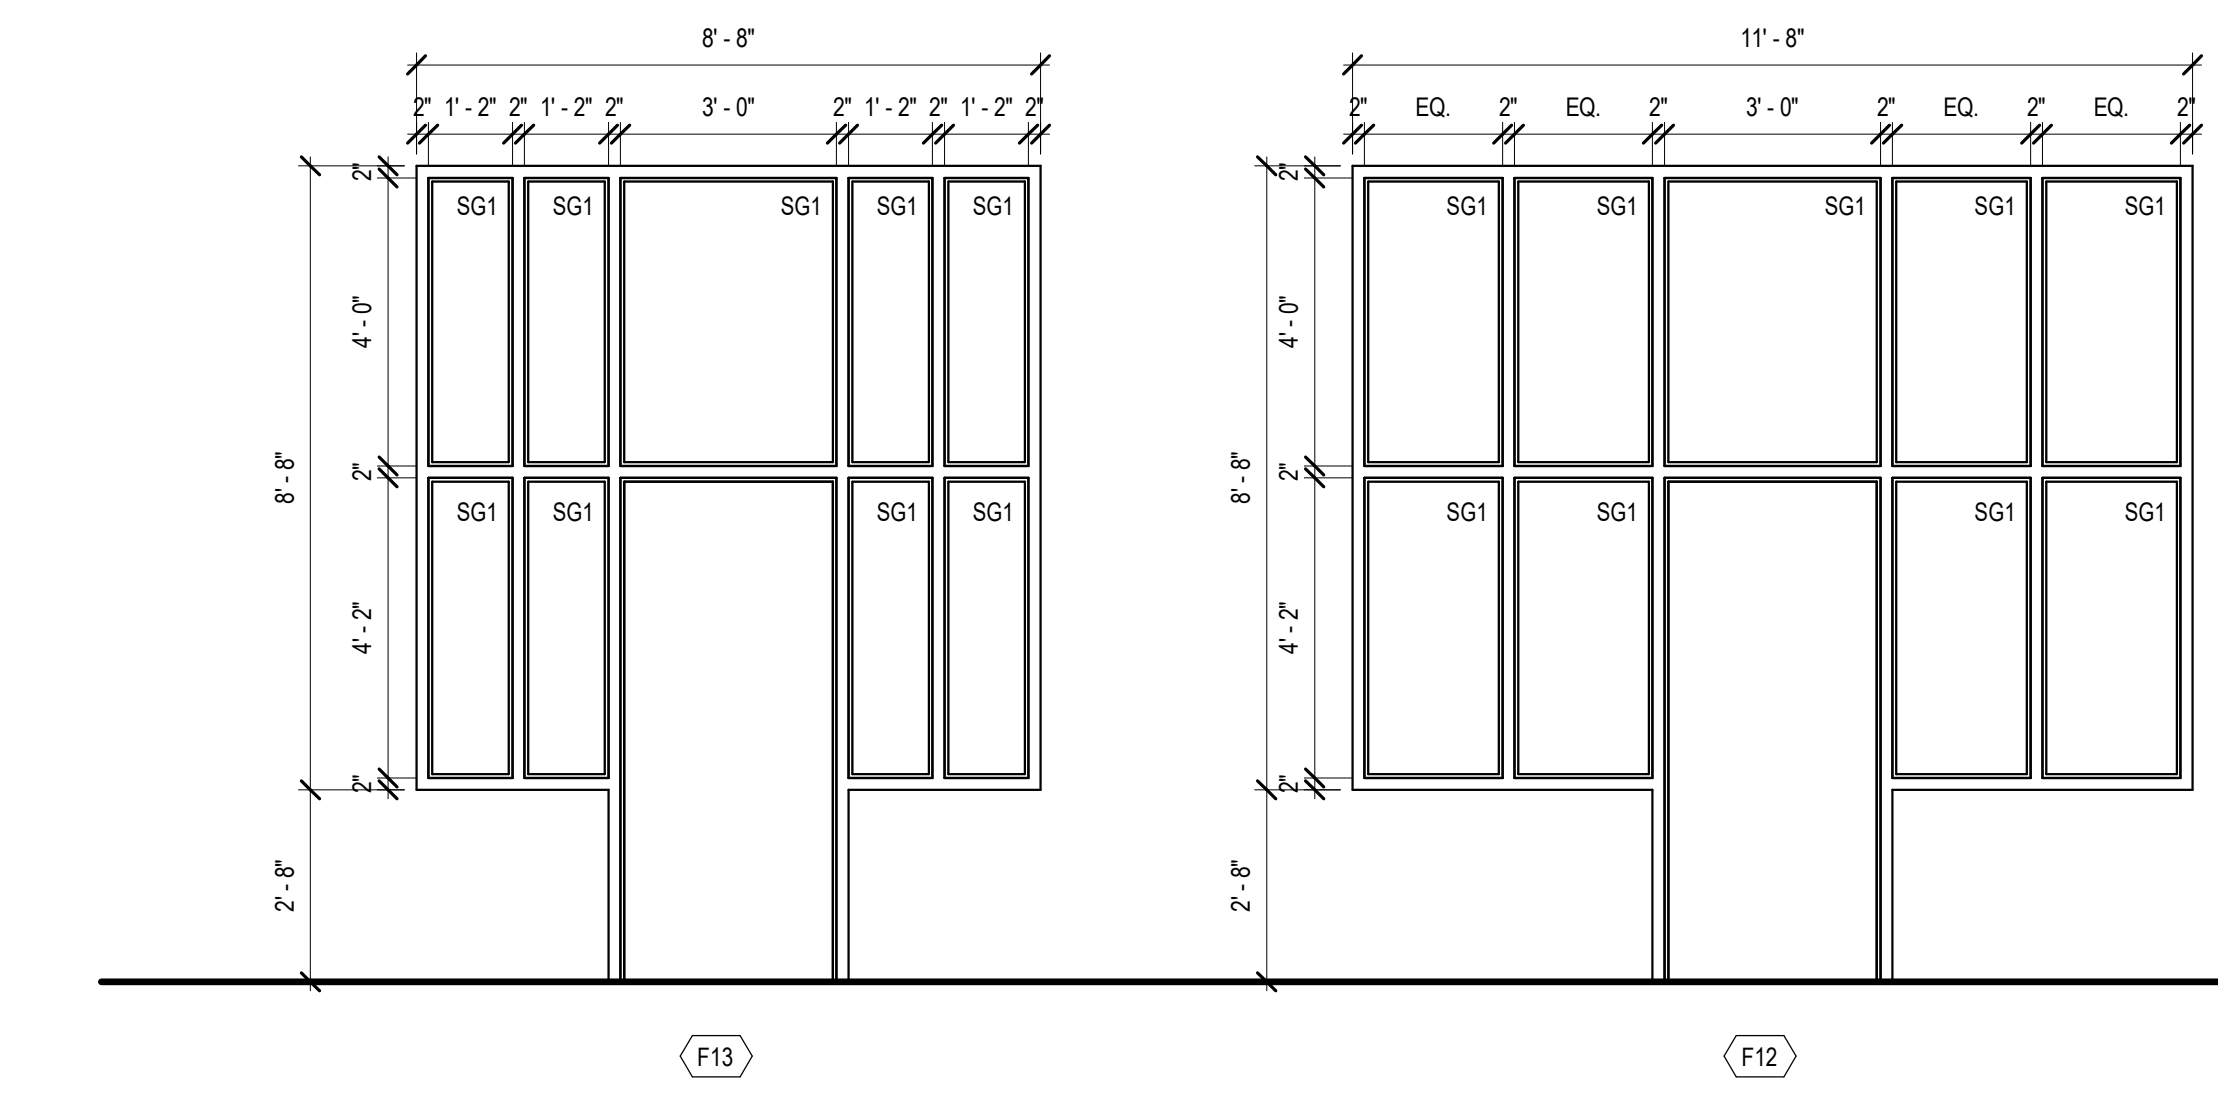
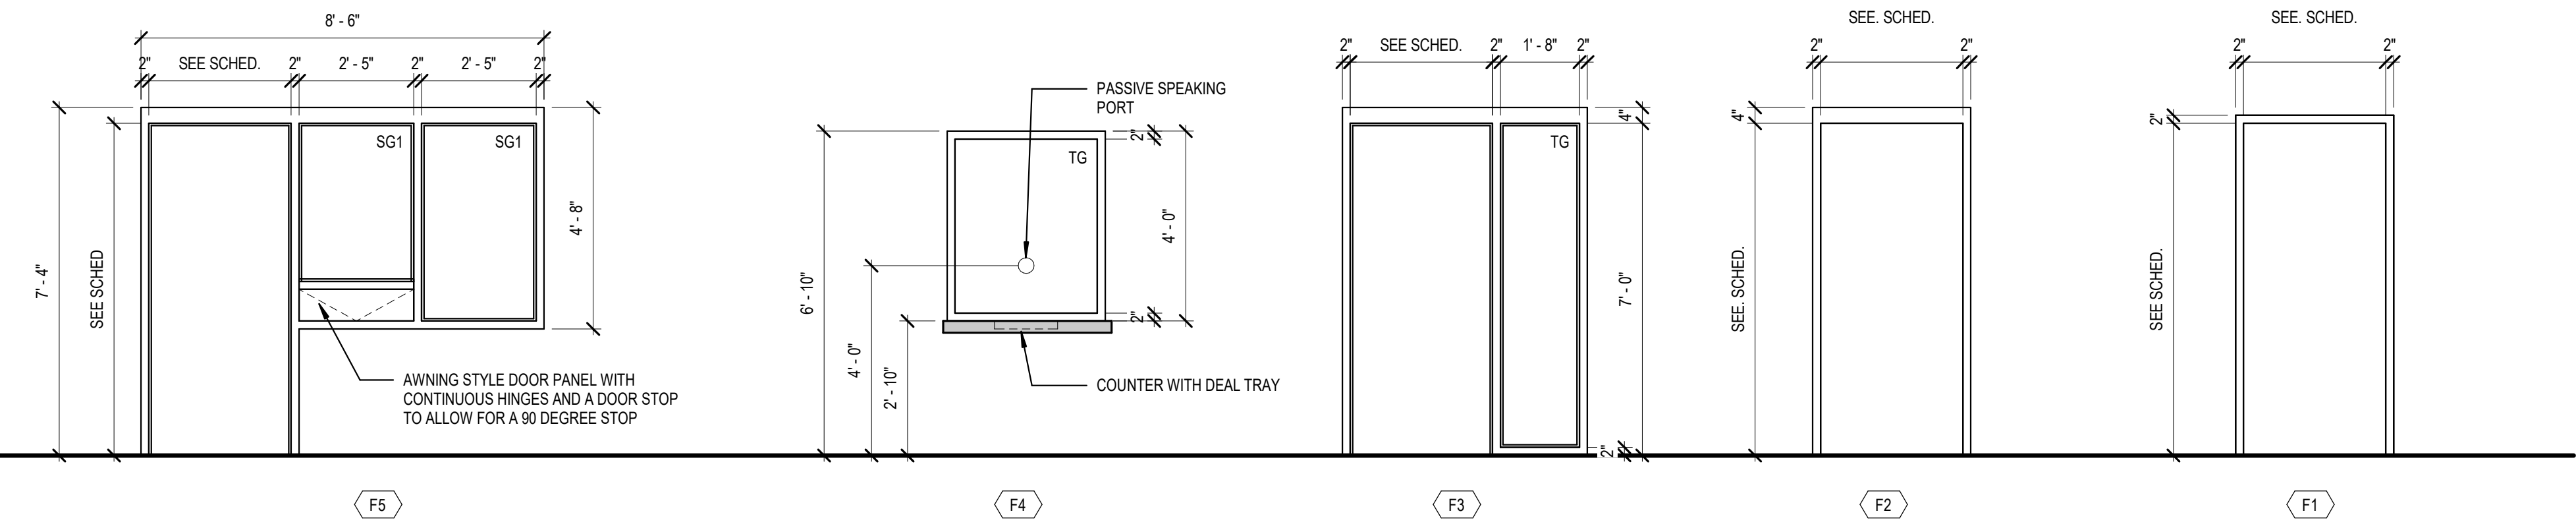
**DOOR & FRAME ELEVATIONS**

**A 601**

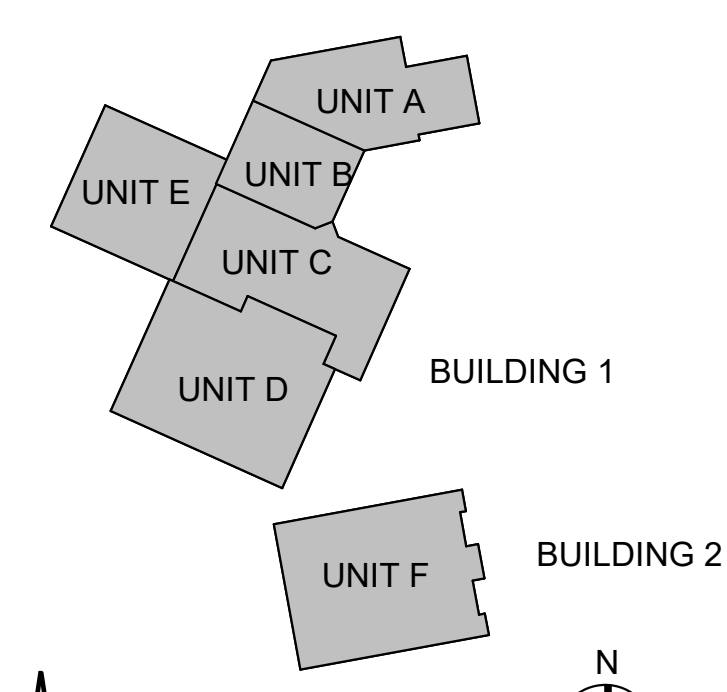**5.4.601 - ALUMINUM STOREFRONT FRAME ELEVATIONS**  
3/8" = 1'-0"




**5.4.601 - HOLLOW METAL FRAME ELEVATIONS**  
3/8" = 1'-0"

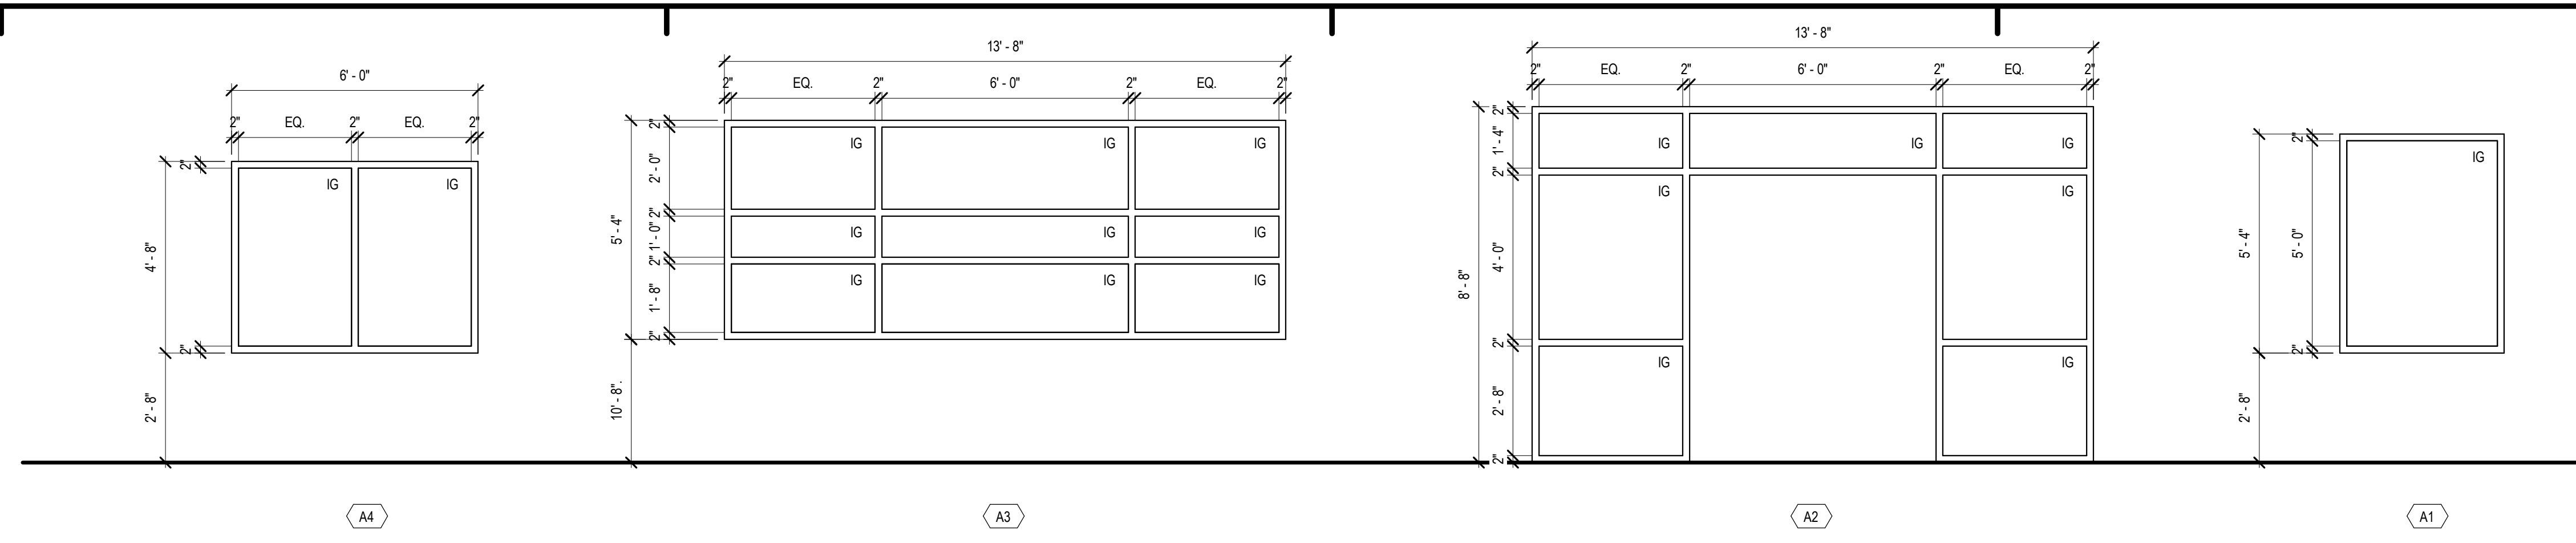

- GENERAL NOTES**
- A. THIS DOOR SCHEDULE(S) IS FURNISHED FOR WHATEVER ASSISTANCE IT MAY AFFORD THE CONTRACTOR. DO NOT CONSIDER IT AS ENTIRELY INCLUSIVE. CAREFULLY EXAMINE THE DRAWINGS (ESPECIALLY THE FLOOR PLANS) AND THE SPECIFICATIONS TO DETERMINE THE EXTENT OF DOOR AND FRAME QUANTITIES REQUIRED (INCLUDING INTERIOR BORROWED LITE OR SIDELITE OPENINGS). SHOULD ANY PARTICULAR DOOR, FRAME, OR INTERIOR BORROWED LITE OR SIDELITE SHOWN ON THE DRAWINGS BE INADVERTENTLY OMITTED FROM THIS SCHEDULE, SUPPLY SAME AS REQUIRED FOR SIMILAR OPENINGS.
- B. VERIFY LOCKSETS WITH THE OWNER DURING SUBMITTALS.
- C. ALL COMMERCIAL 4'-0" WIDE DOORS TO HAVE CONTINUOUS HINGES. ALL SECURITY 4'-0" WIDE DOORS TO HAVE 4 HINGES.
- D. ALL COMMERCIAL DOORS IN DETENTION/SECURITY AREAS TO RECEIVED DETENTION GLAZING SG-2.
- REMARKS**
- SEE DOOR SCHEDULE
1. MODIFY HARDWARE SET TO ALLOW FOR FLUSH PADDED PANEL DESIGN
  2. DESIGN INTENT IS FOR SECURITY GLAZING INSTALLATION IN COMMERCIAL DOOR PANEL
  3. DOOR SCOPE AND ALL ASSOCIATED FRAMES, ANCHORS AND INSTALLATION IS PART OF ALTERNATE.
  4. DOUBLE DUTCH DOOR, WITH HARDWARE FOR EACH DOOR LEAF. PROVIDE STAINLESS STEEL SHELF ON BOTTOM LEAF
  5. EXTERIOR ROOF ACCESS DOOR, PROVIDE THRESHOLDS AND DOOR SWEEPS FOR EXTERIOR INSTALLATION.
  6. PROVIDE PASS PROOF SECURITY THRESHOLDS, AND PASS PROOF DOOR SEALS AT THE DOOR RABBETS
  7. DOOR IS DELETED FROM SCOPE IF STEEL CELL ALTERNATE IS ACCEPTED.
  8. PROVIDE LEVEL III BALLISTIC RATED GLAZING, DOOR, AND FRAME.
  9. PROVIDE FLUSH PULLS DOOR HARDWARE

**ABBREVIATIONS**

AL	ALUMINUM	TG	1/4" TEMPERED GLAZING
HM	HOLLOW METAL	IG	1" INSULATED GLAZING
SHM	SECURITY HOLLOW METAL	LG	LAMINATED GLAZING
ST	STEEL	FG	FROSTED GLAZING
WD	WOOD	SP	SPANDREL PANEL

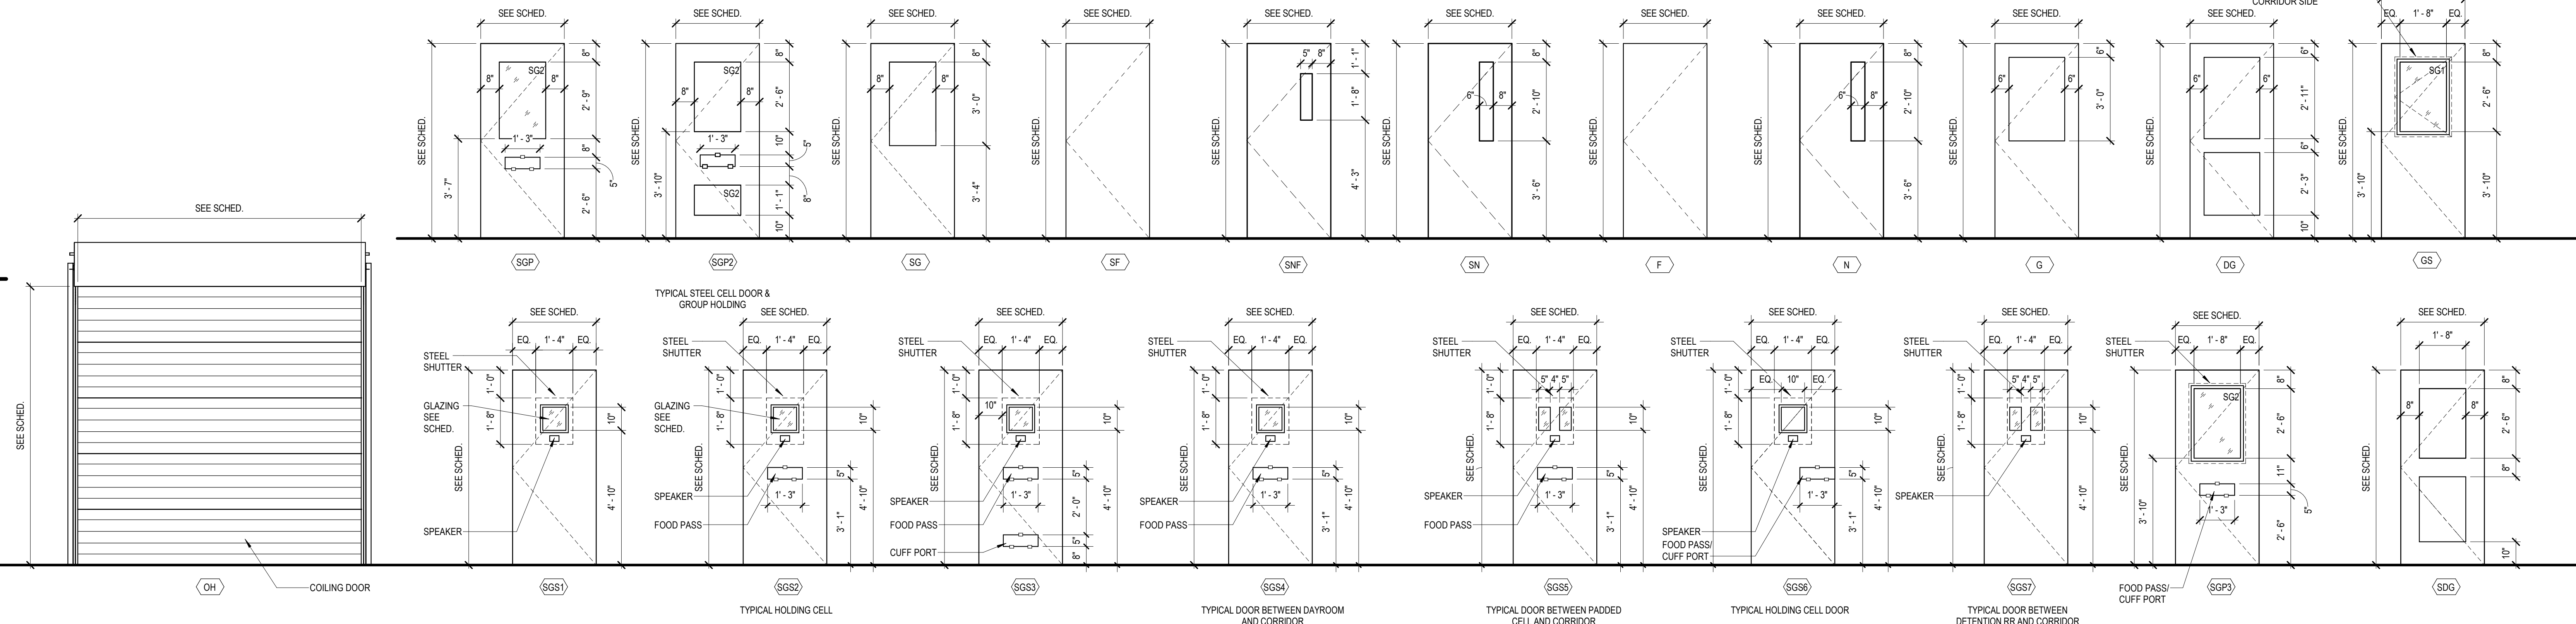

**5.4.601 - DOOR PANEL ELEVATIONS**  
3/8" = 1'-0"



Project #: 20-700-151-2

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Designed By: Designer

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Drawn By: Author

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Checked By: Checker

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Date: 01.28.2022





E

D

C

B

A

6


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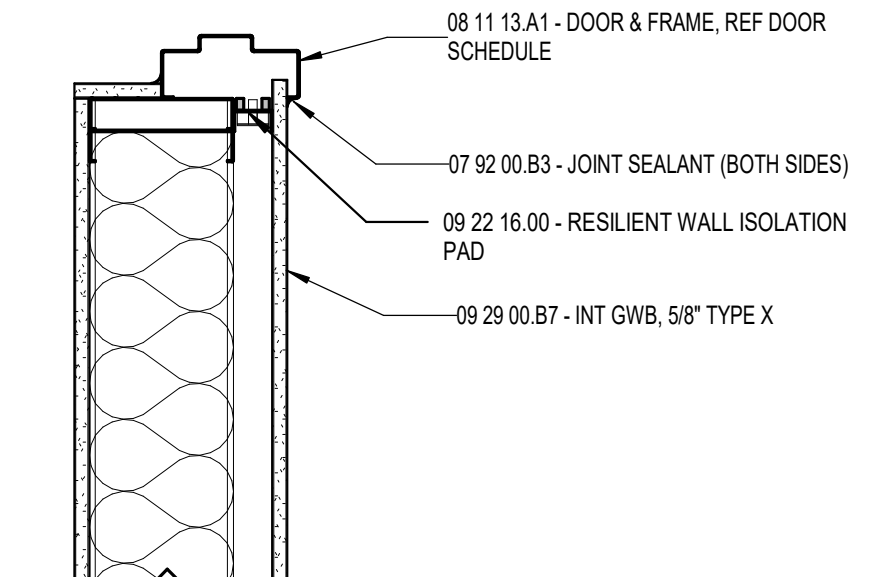
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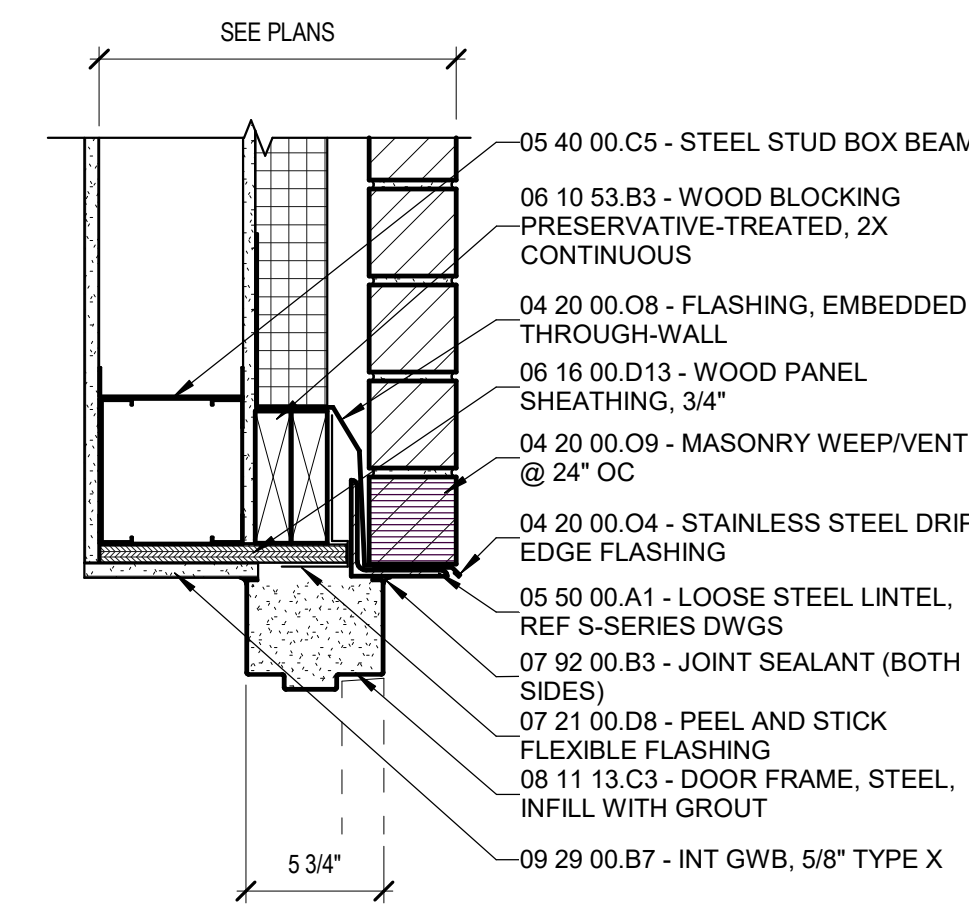
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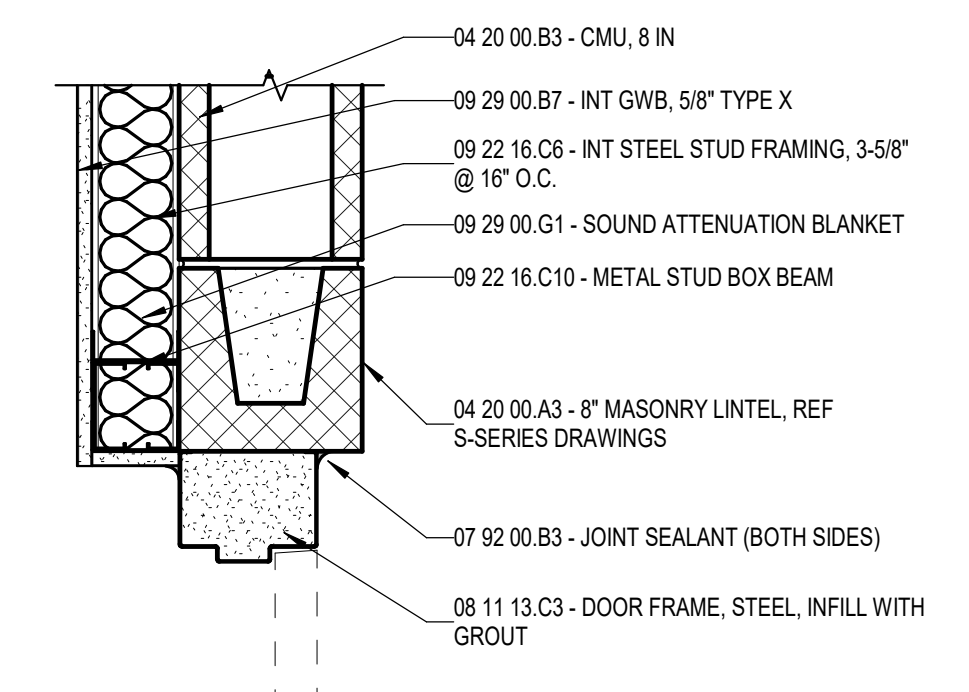
**3E HM FRAME HEADER @ ACOUSTICAL WALL**  
1 1/2" = 1'-0"




**3D HM FRAME JAMB @ ACOUSTICAL WALL**  
1 1/2" = 1'-0"




**3C HEAD**  
1 1/2" = 1'-0"

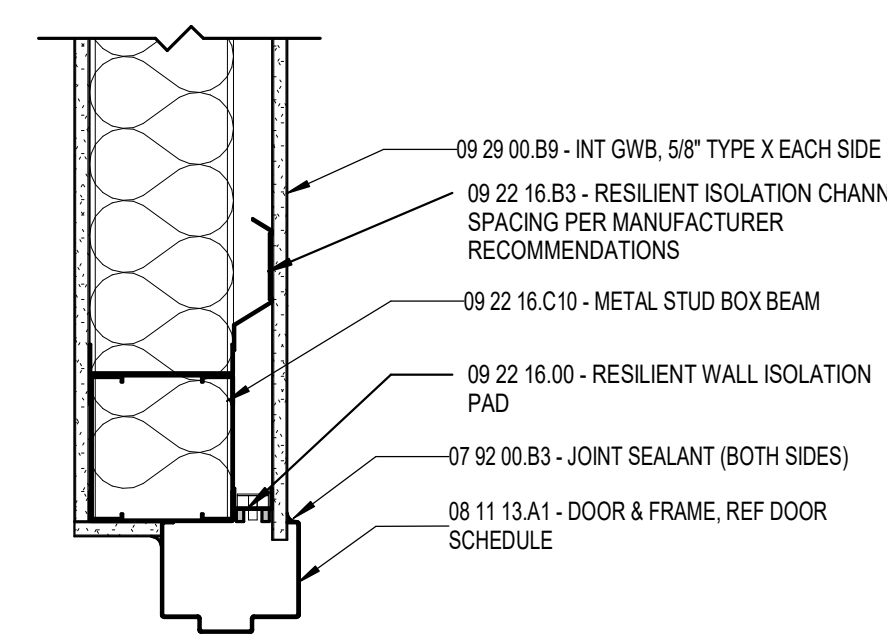


**4B HOLLOW METAL HEAD DETAIL**  
1 1/2" = 1'-0"

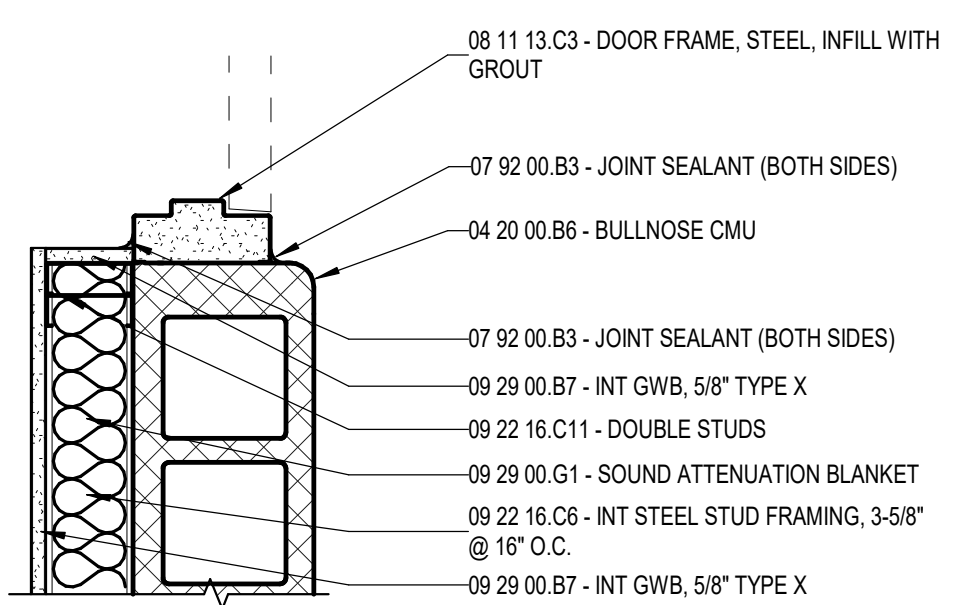


**4A HOLLOW METAL JAMB DETAIL W/FURRING**  
1 1/2" = 1'-0"

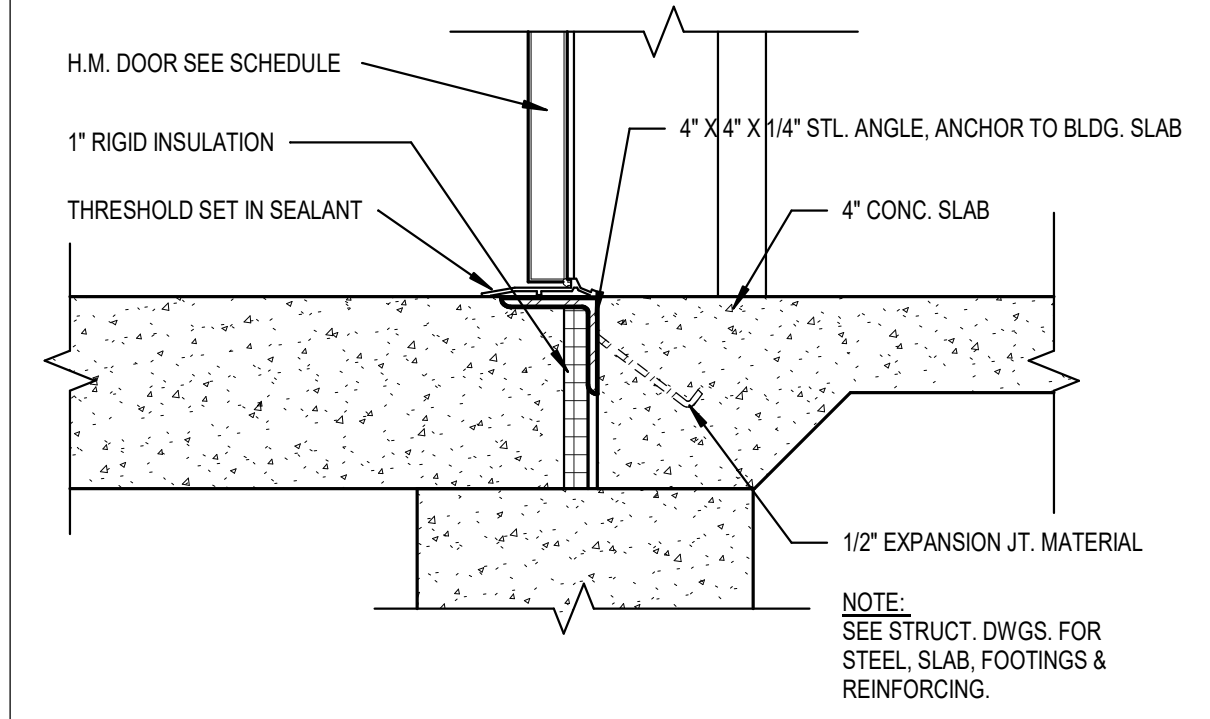


**3A SILL @ EXTERIOR H.M. DOOR**  
1 1/2" = 1'-0"

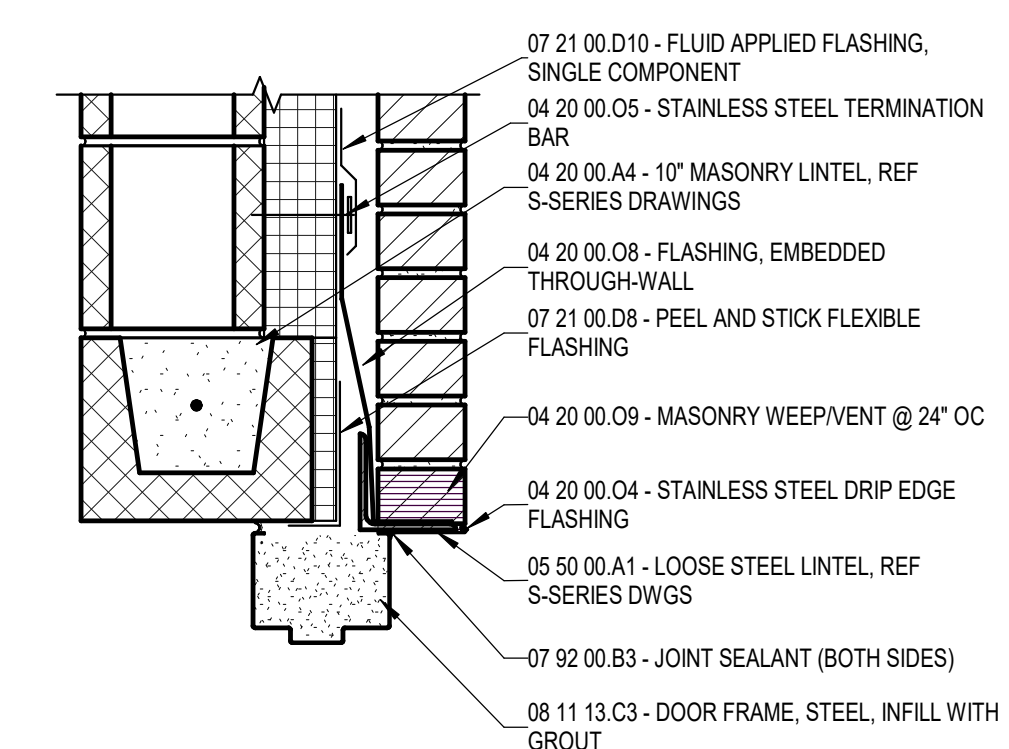


**2D HEAD**  
1 1/2" = 1'-0"

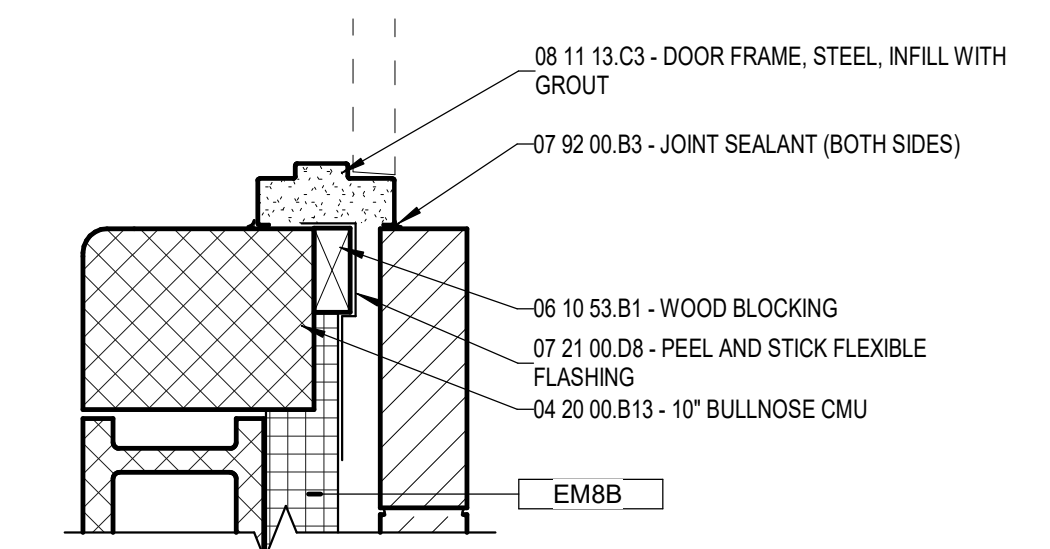


**2C JAMB**  
1 1/2" = 1'-0"

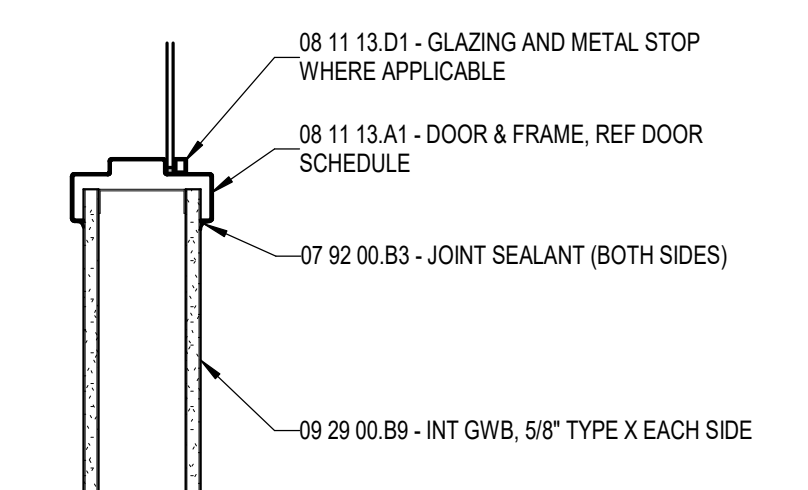


**2B SILL**  
1 1/2" = 1'-0"

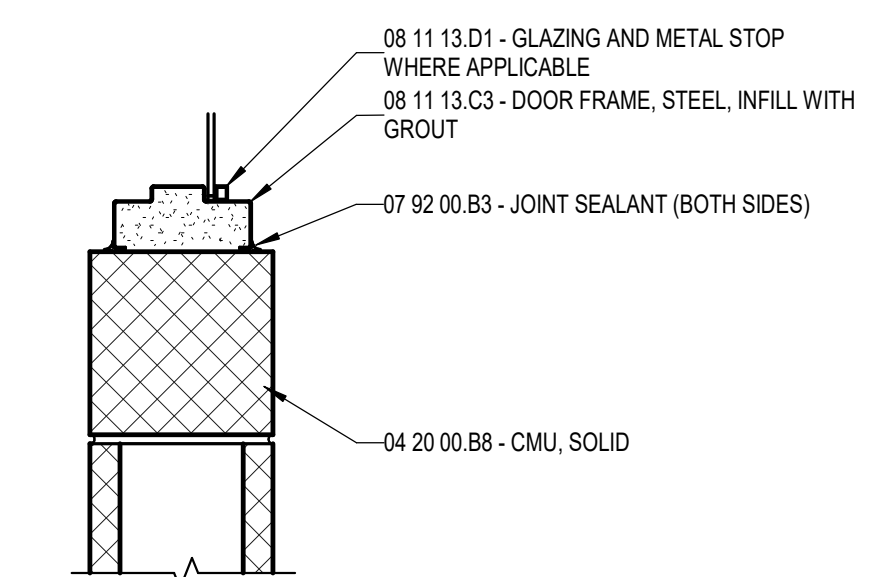


**2A SILL**  
1 1/2" = 1'-0"

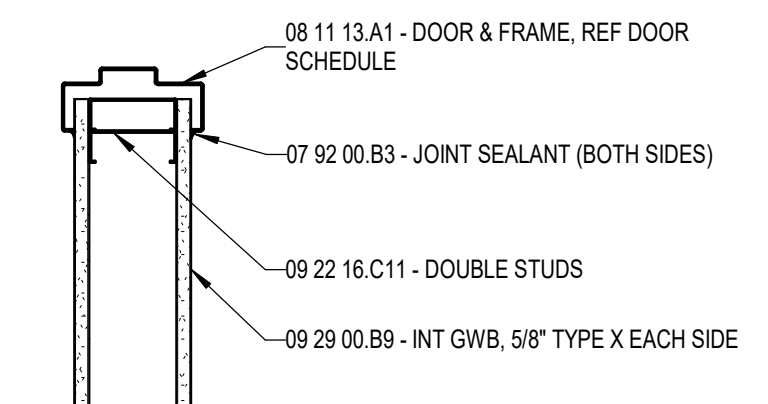


**1E JAMB**  
1 1/2" = 1'-0"

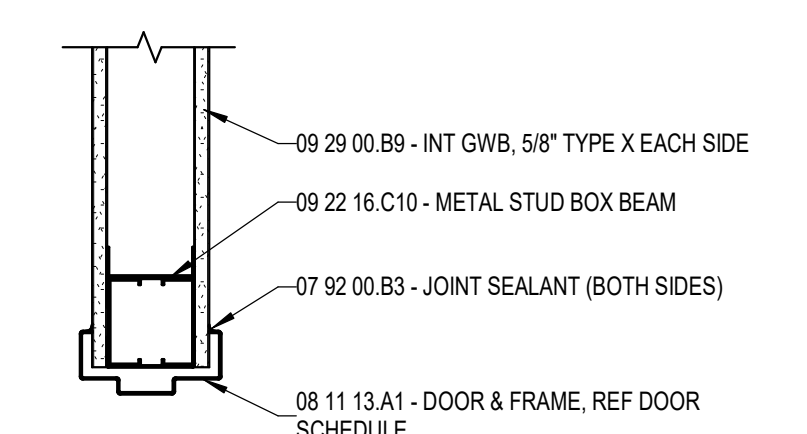


**1D HEAD**  
1 1/2" = 1'-0"

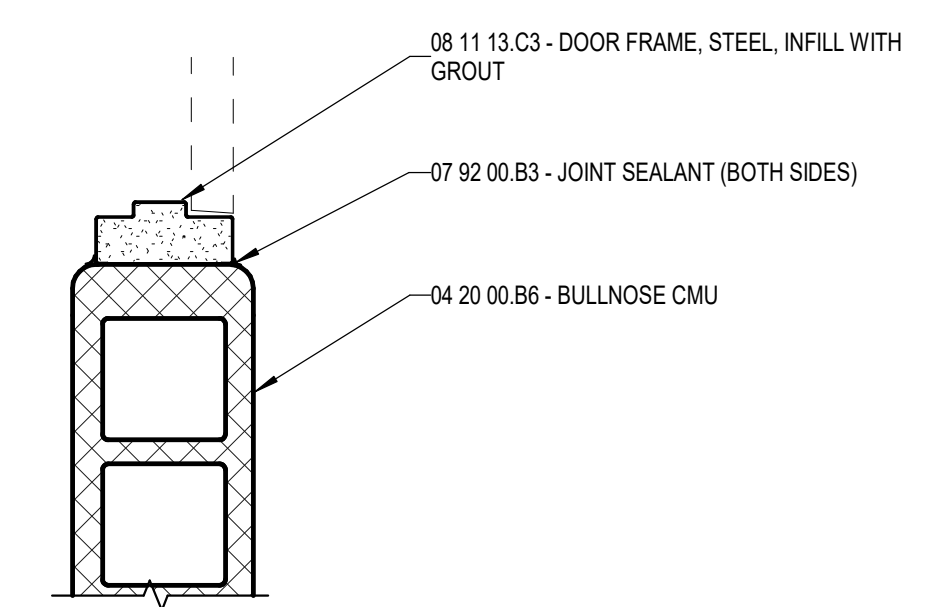

**1C JAMB**  
1 1/2" = 1'-0"

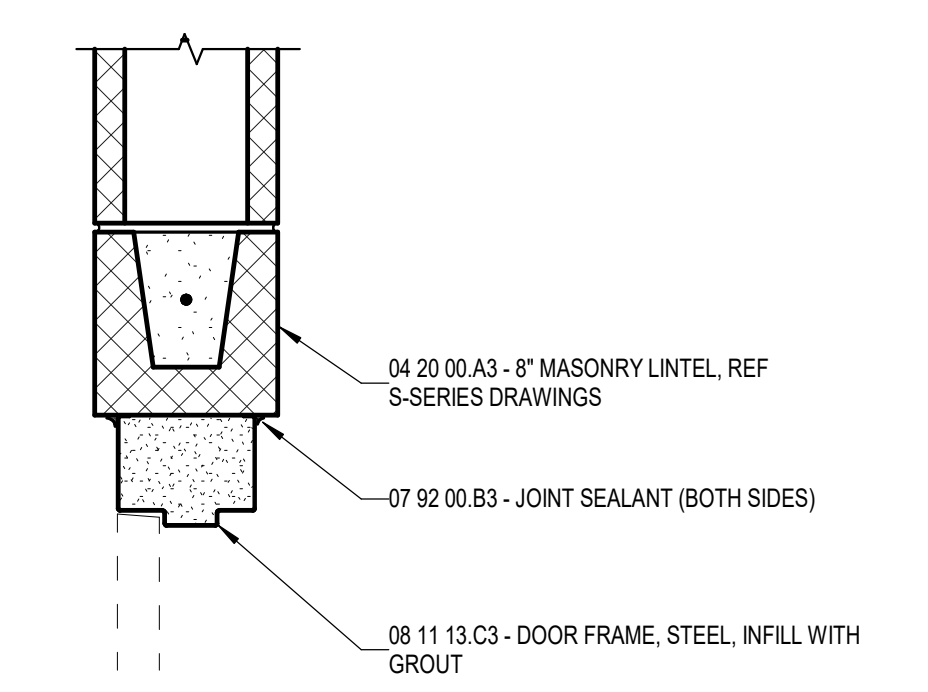

**1B HEAD**  
1 1/2" = 1'-0"

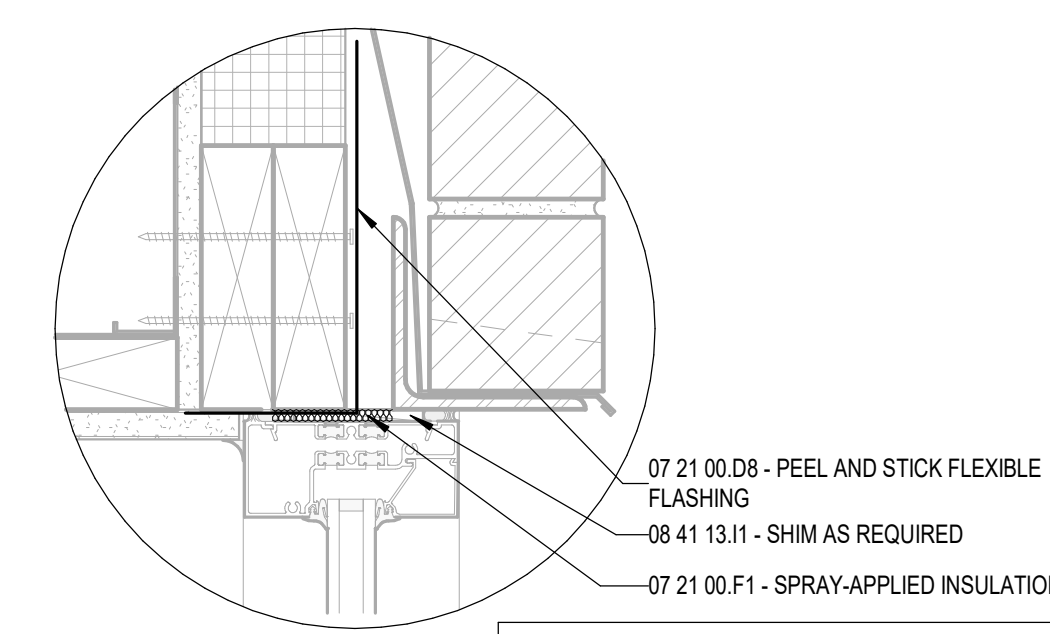


**1A WINDOW OPENING EDGE DETAIL**  
3" = 1'-0"

NOTE:  
TYPICAL, PROVIDE TRANSITION STRIP AND SPRAY APPLIED INSULATION AT ALL EXTERIOR OPENING HEAD, JAMB, AND SILL CONDITIONS. ANY DISCREPANCIES ARE TO BE BROUGHT TO ARCHITECT'S ATTENTION PRIOR TO INSTALLATION.

#	Revision	Date
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Project #: 20-700-151-2  
Designed By: LD/SP  
Drawn By: CP  
Checked By: LD/EV  
Date: 01.28.2022

**ERIC S. WELLEN**  
REGISTERED ARCHITECT  
No. AR1500198  
STATE OF INDIANA  
*Eric Wellen*  
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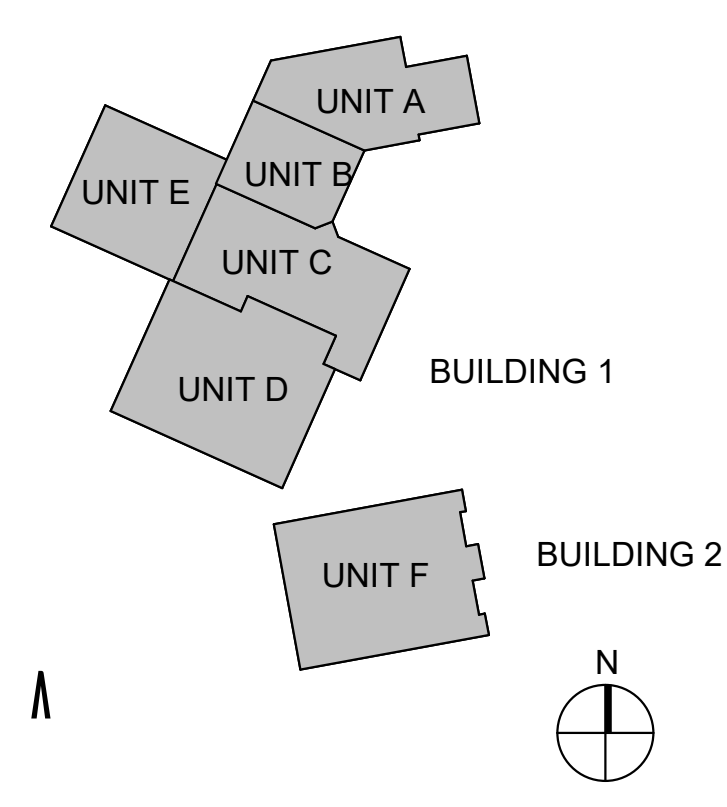


#	Revision	Date
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Project #: 20-700-151-2  
Designed By: Designer  
Drawn By: Author  
Checked By: Checker  
Date: 01.28.2022

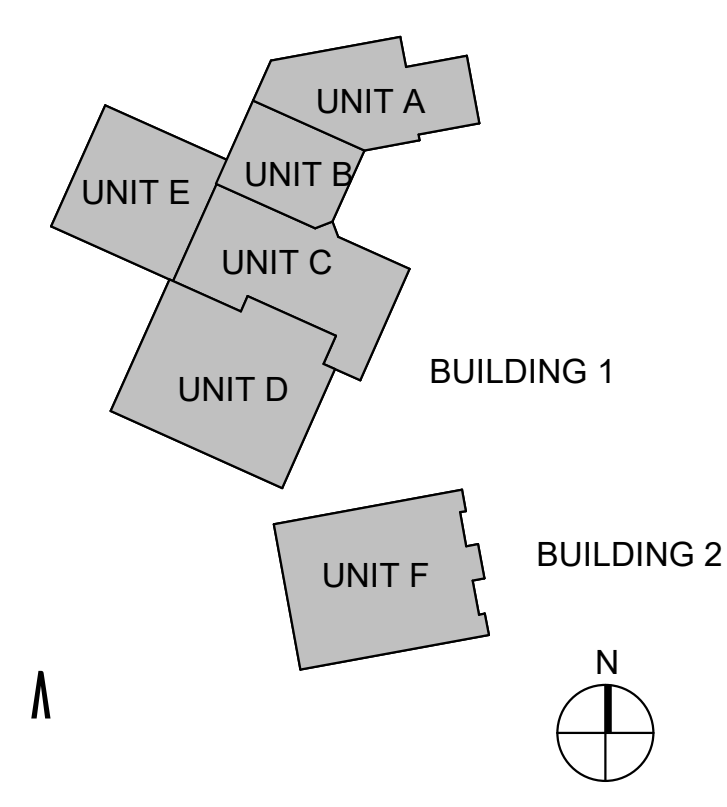


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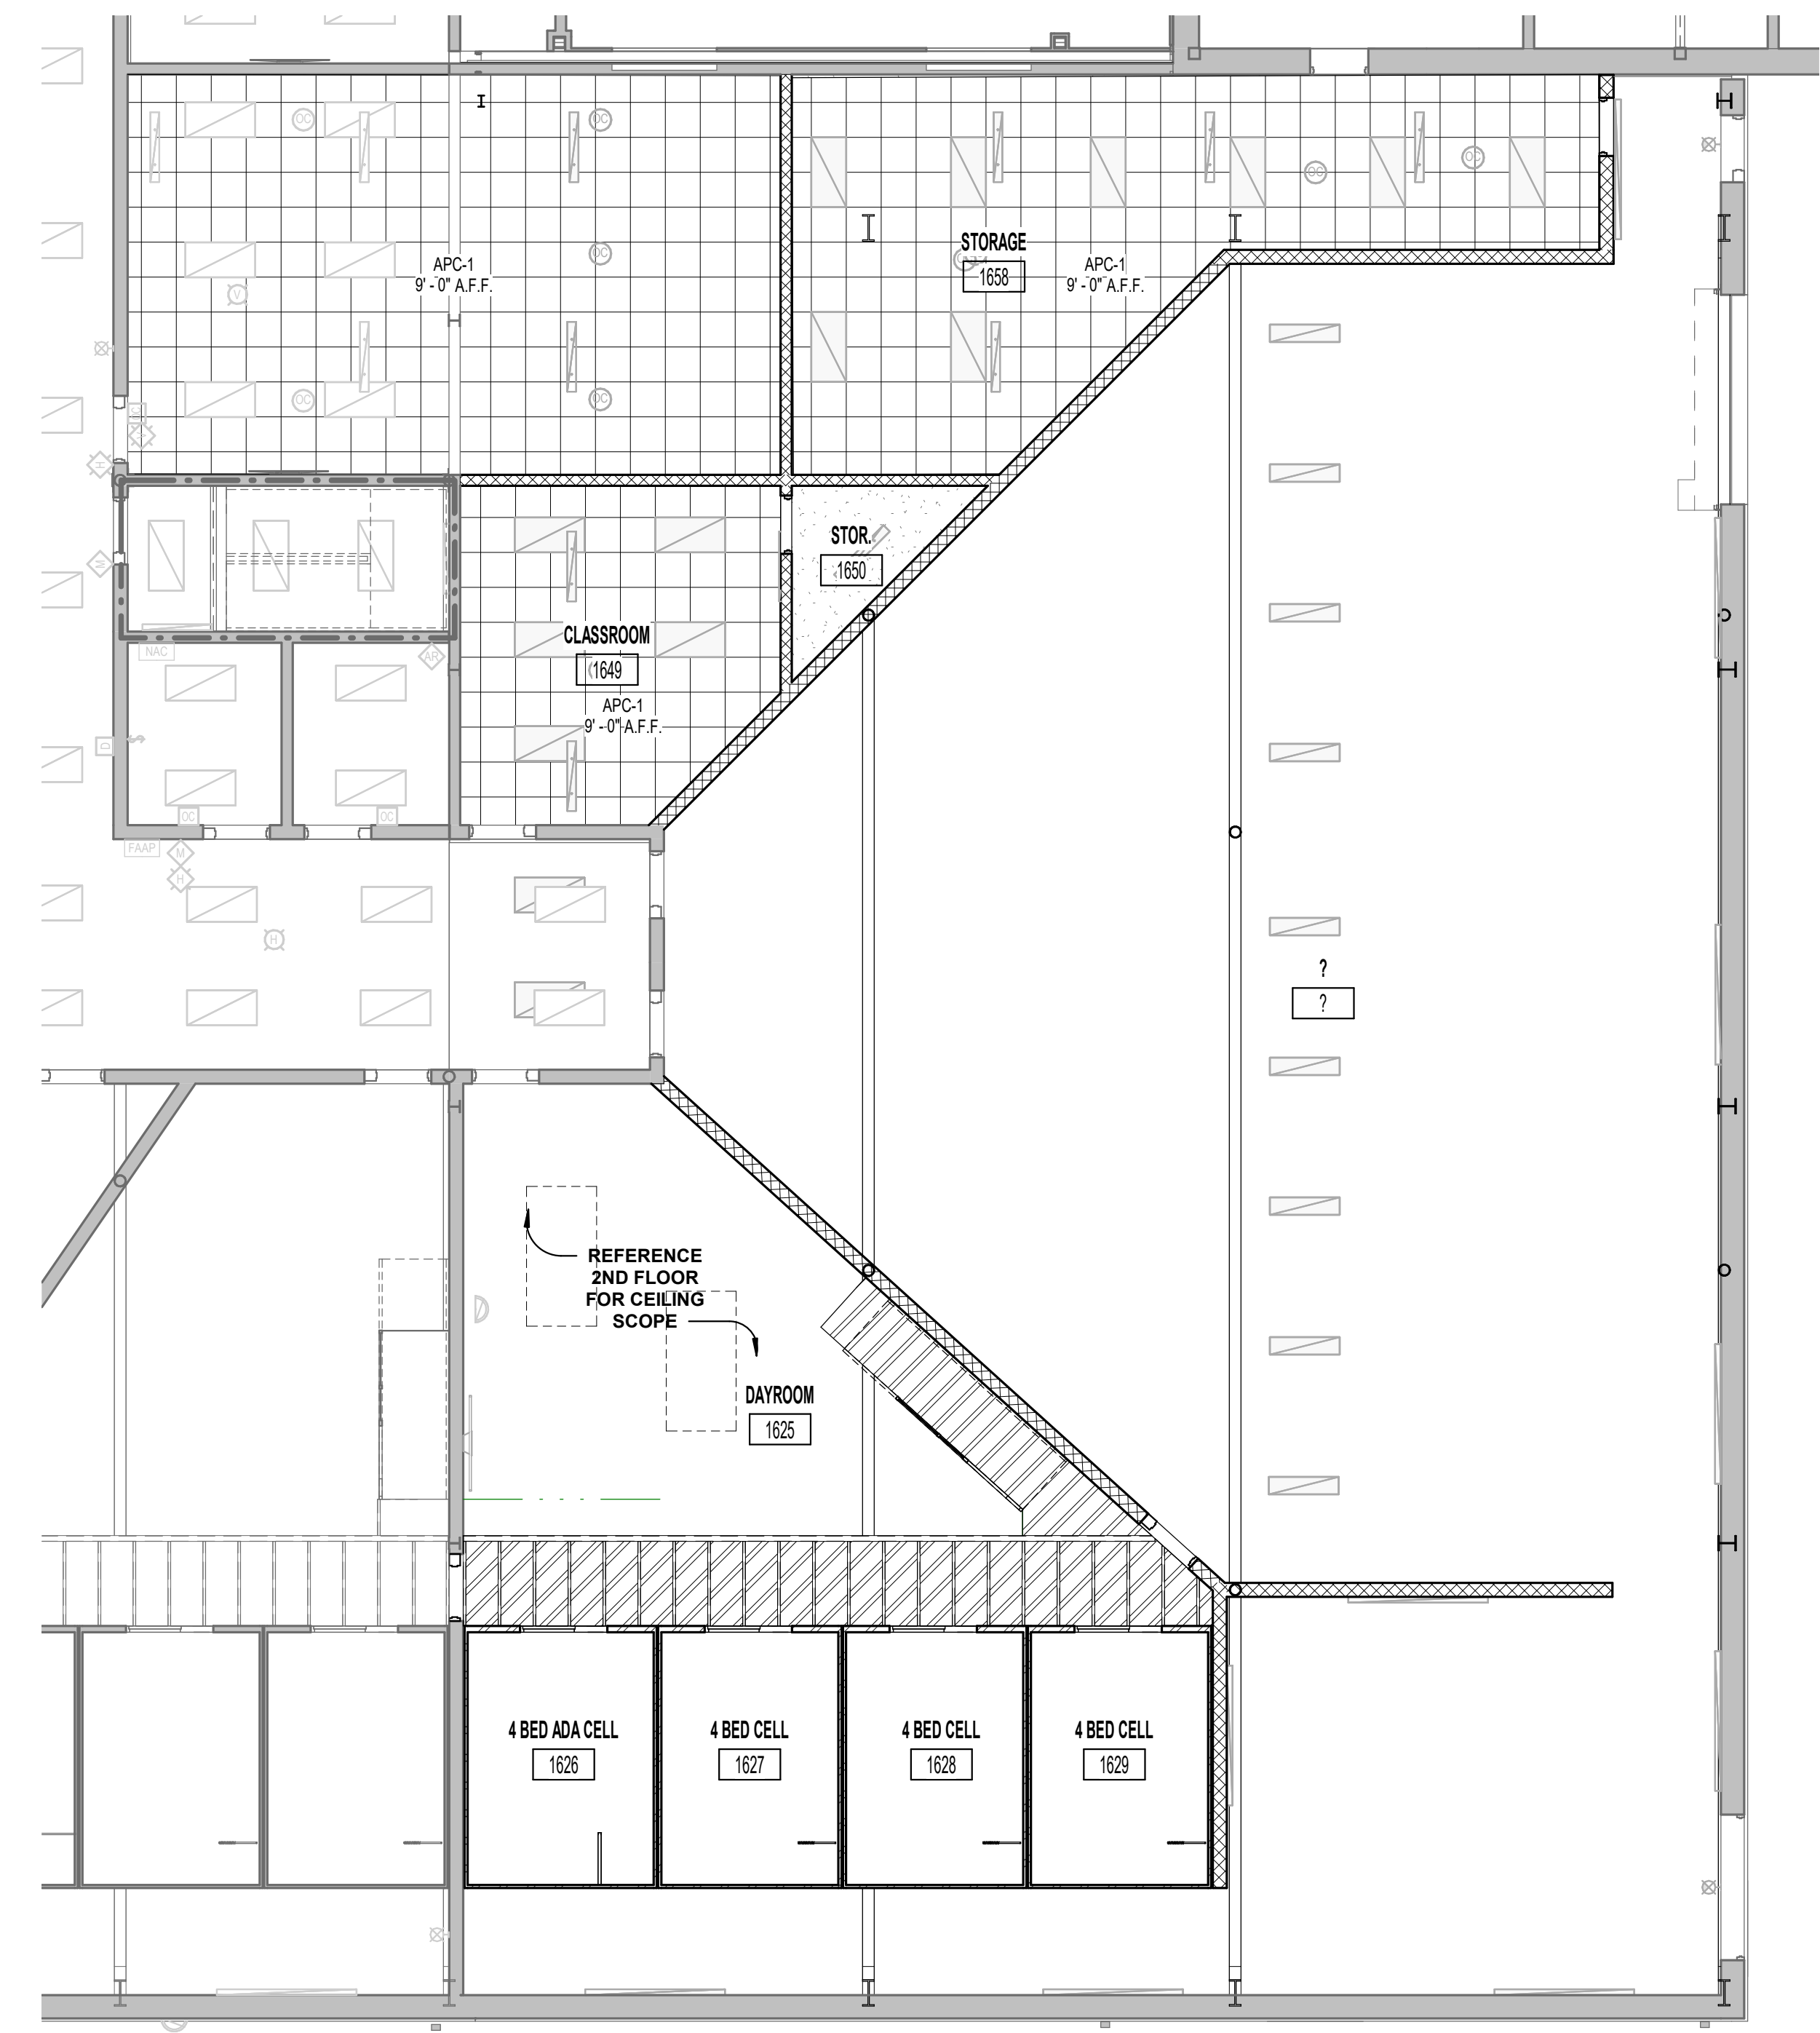
ALTERNATE FIRST FLOOR  
CEILING PLAN

AC ALT  
A1-D5


5.4.120 - CEILING PLAN NOTES	
Key	Note
1	OPEN TO STRUCTURE
2	RETENTION CLIPS, 2 PER EACH CEILING TILE
3	EXISTING CEILING TO REMAIN
4	SKYLIGHT WITH SECURITY BARS, DUCTED SHAFT (INTERIOR TO BE PAINTED). POLYCARBONATE LENS AT CEILING LEVEL. SEE ROOF PLAN FOR SKYLIGHT SIZE. FINAL SKYLIGHT LOCATION TO ADJUST AS REQUIRED TO COORDINATE WITH STRUCTURAL AND MEFP SYSTEMS
6	18 IN CEILING MOUNTED DOMED MIRROR
7	PROVIDE A 5-1/4" SLAB ON TOP OF CELLULAR METAL DECK TO ACHIEVE 1-HR RATED LID ASSEMBLY.
8	OVERHEAD COILING DOOR ASSEMBLY WITH ELECTRICALLY MOTORIZED OPERATOR.
9	CEILING MOUNTED 42" MONITORS. FINAL INSTALLATION TO BE COORDINATED WITH CONTROL STATION INSTALLATION.




2 FIRST FLOOR REFLECTED CEILING PLAN BUILDING 1 - UNIT D ALTERNATE "D"  
1/16" = 1'-0"

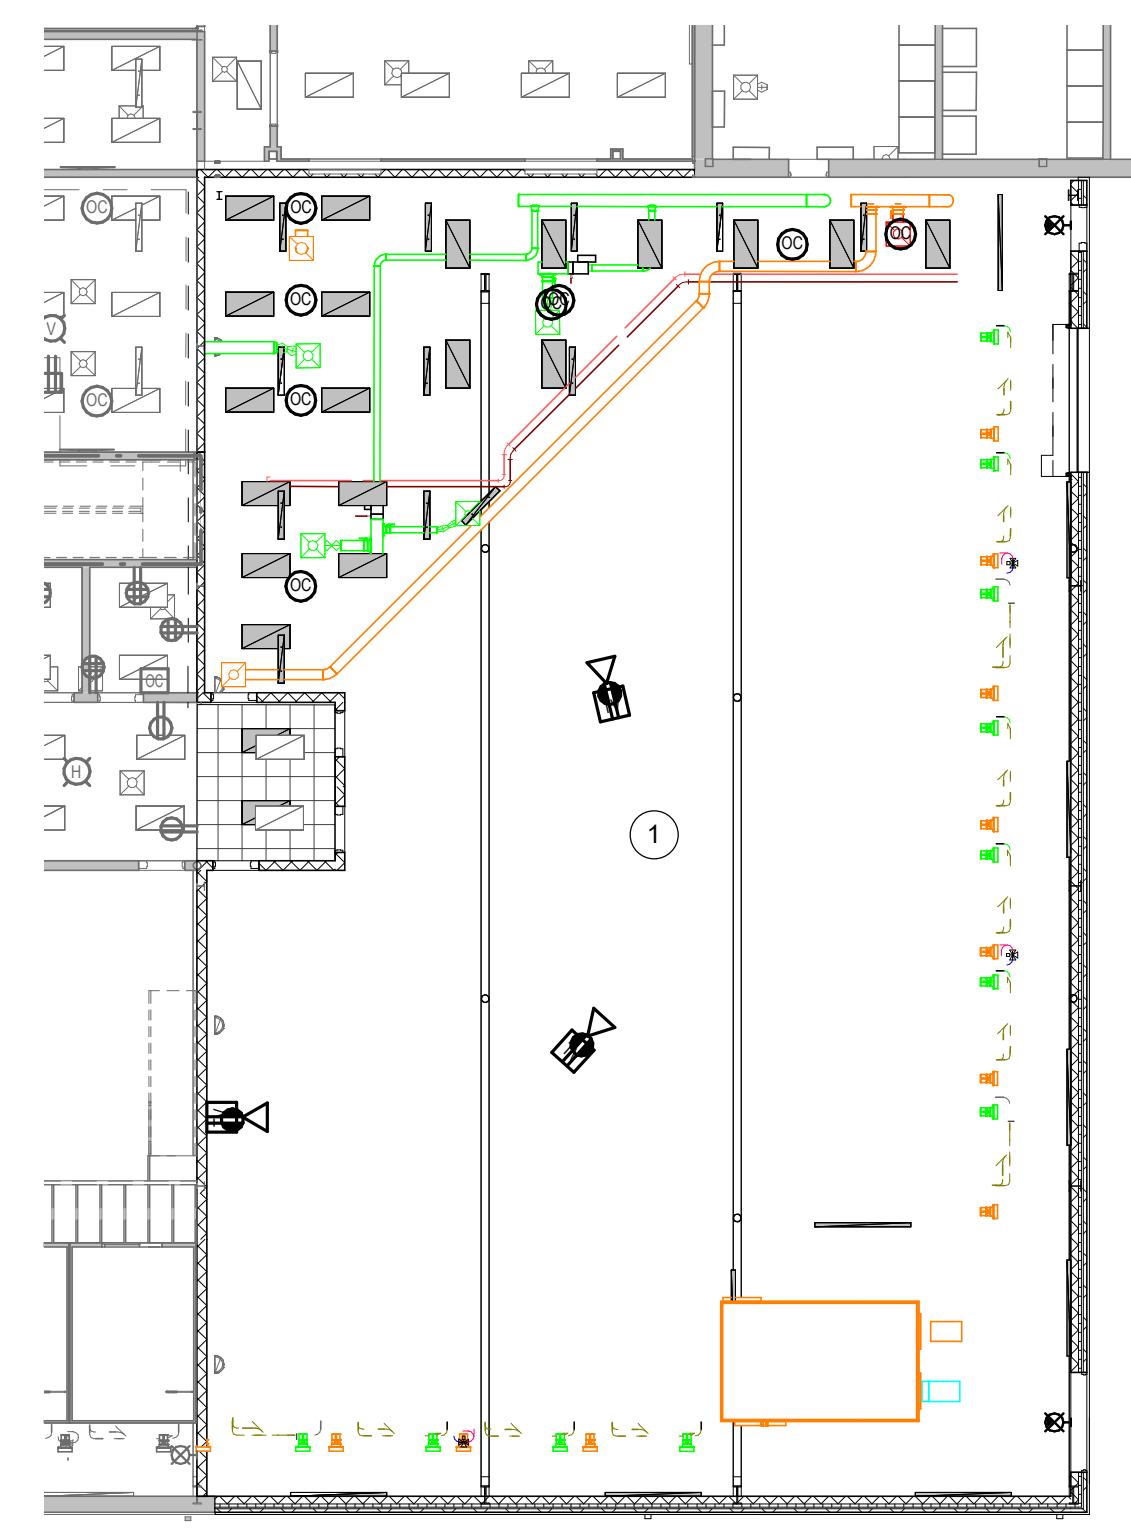


3 FIRST FLOOR REFLECTED CEILING PLAN BUILDING 1 - UNIT D ALTERNATE "D1"  
1/8" = 1'-0"

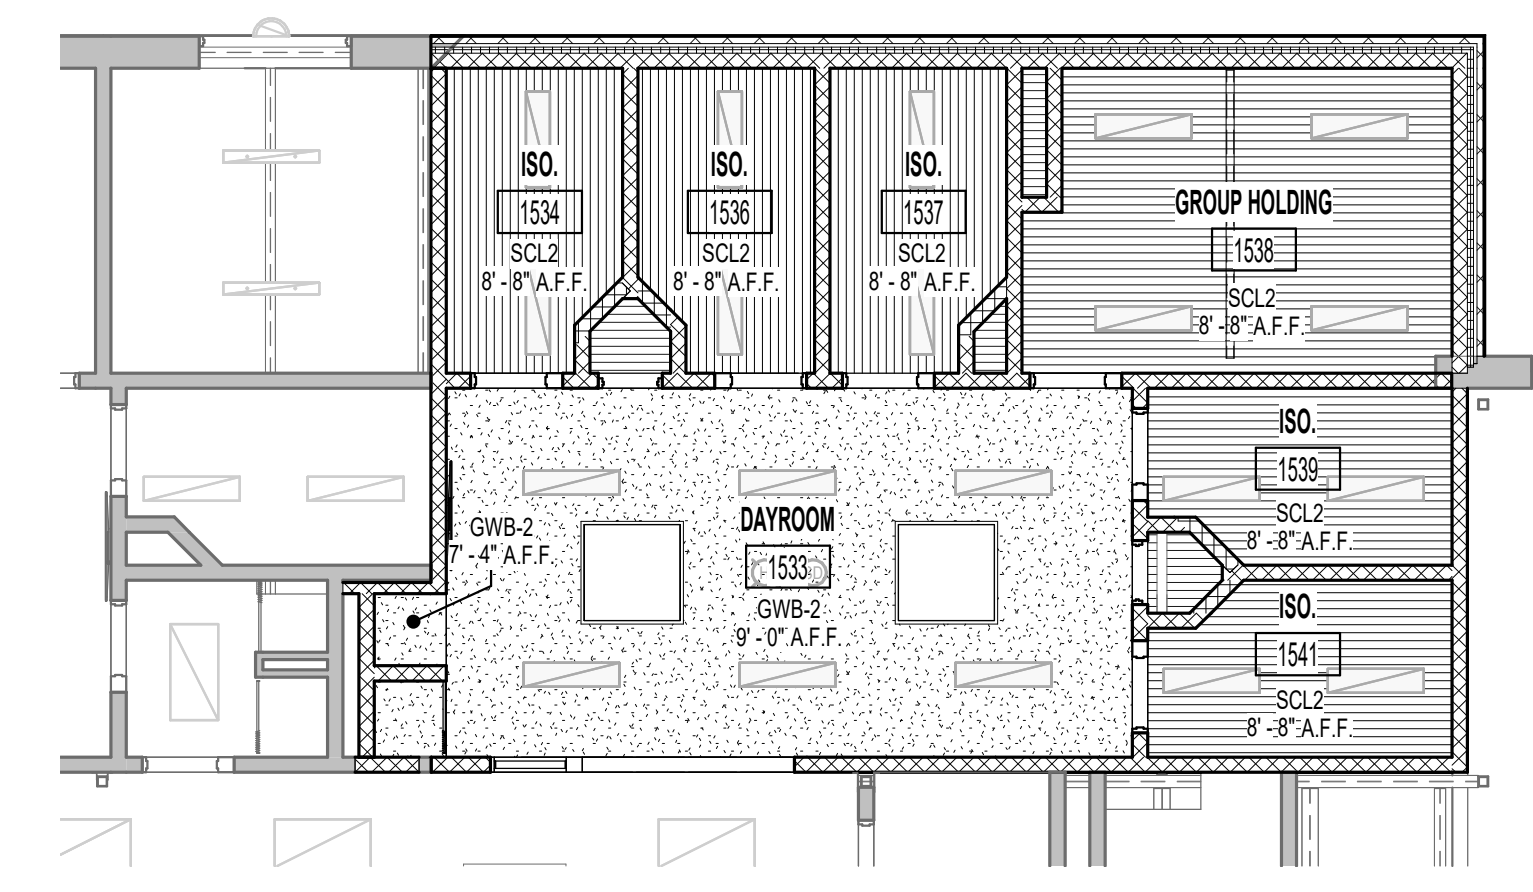

1 FIRST FLOOR REFLECTED CEILING PLAN BUILDING 1 - UNIT A ALTERNATE "A"  
1/8" = 1'-0"

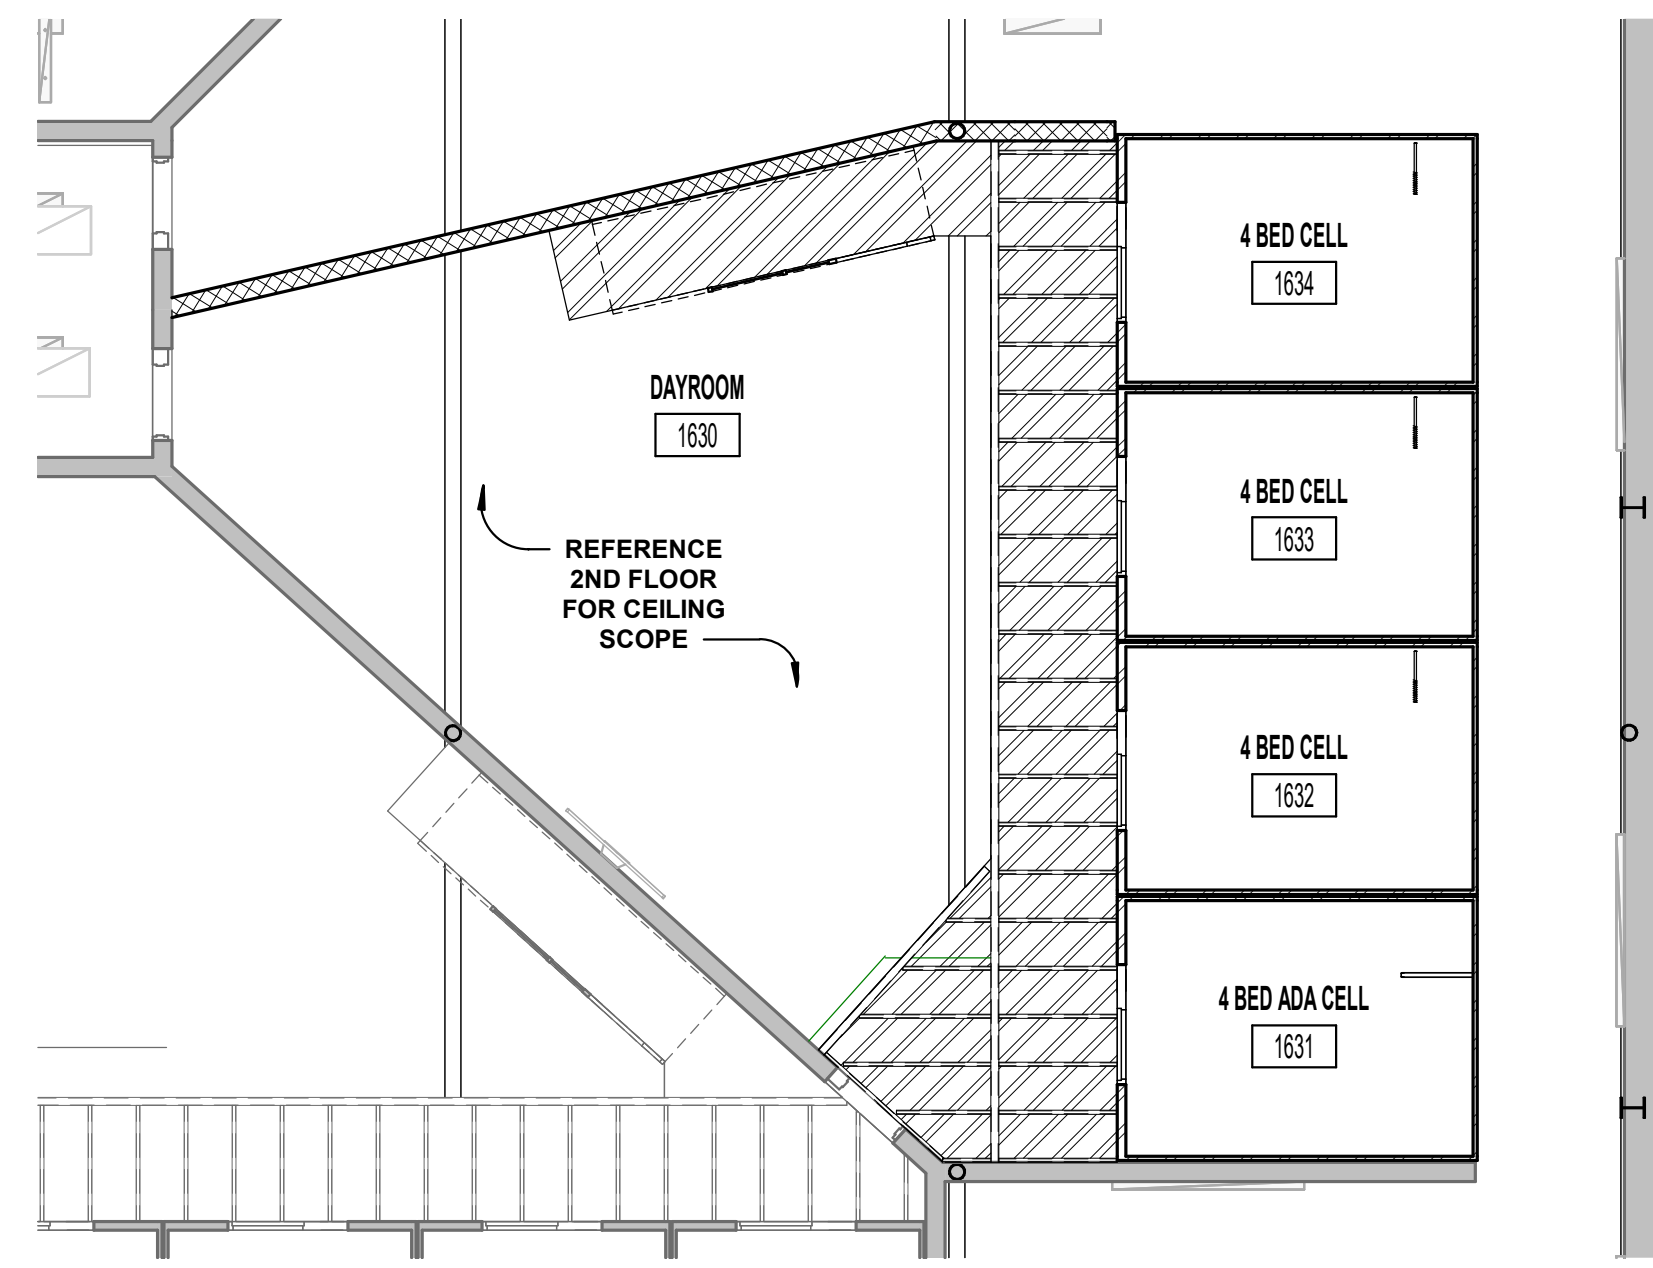

4 FIRST FLOOR REFLECTED CEILING PLAN BUILDING 1 - UNIT D ALTERNATE "D2"  
1/8" = 1'-0"

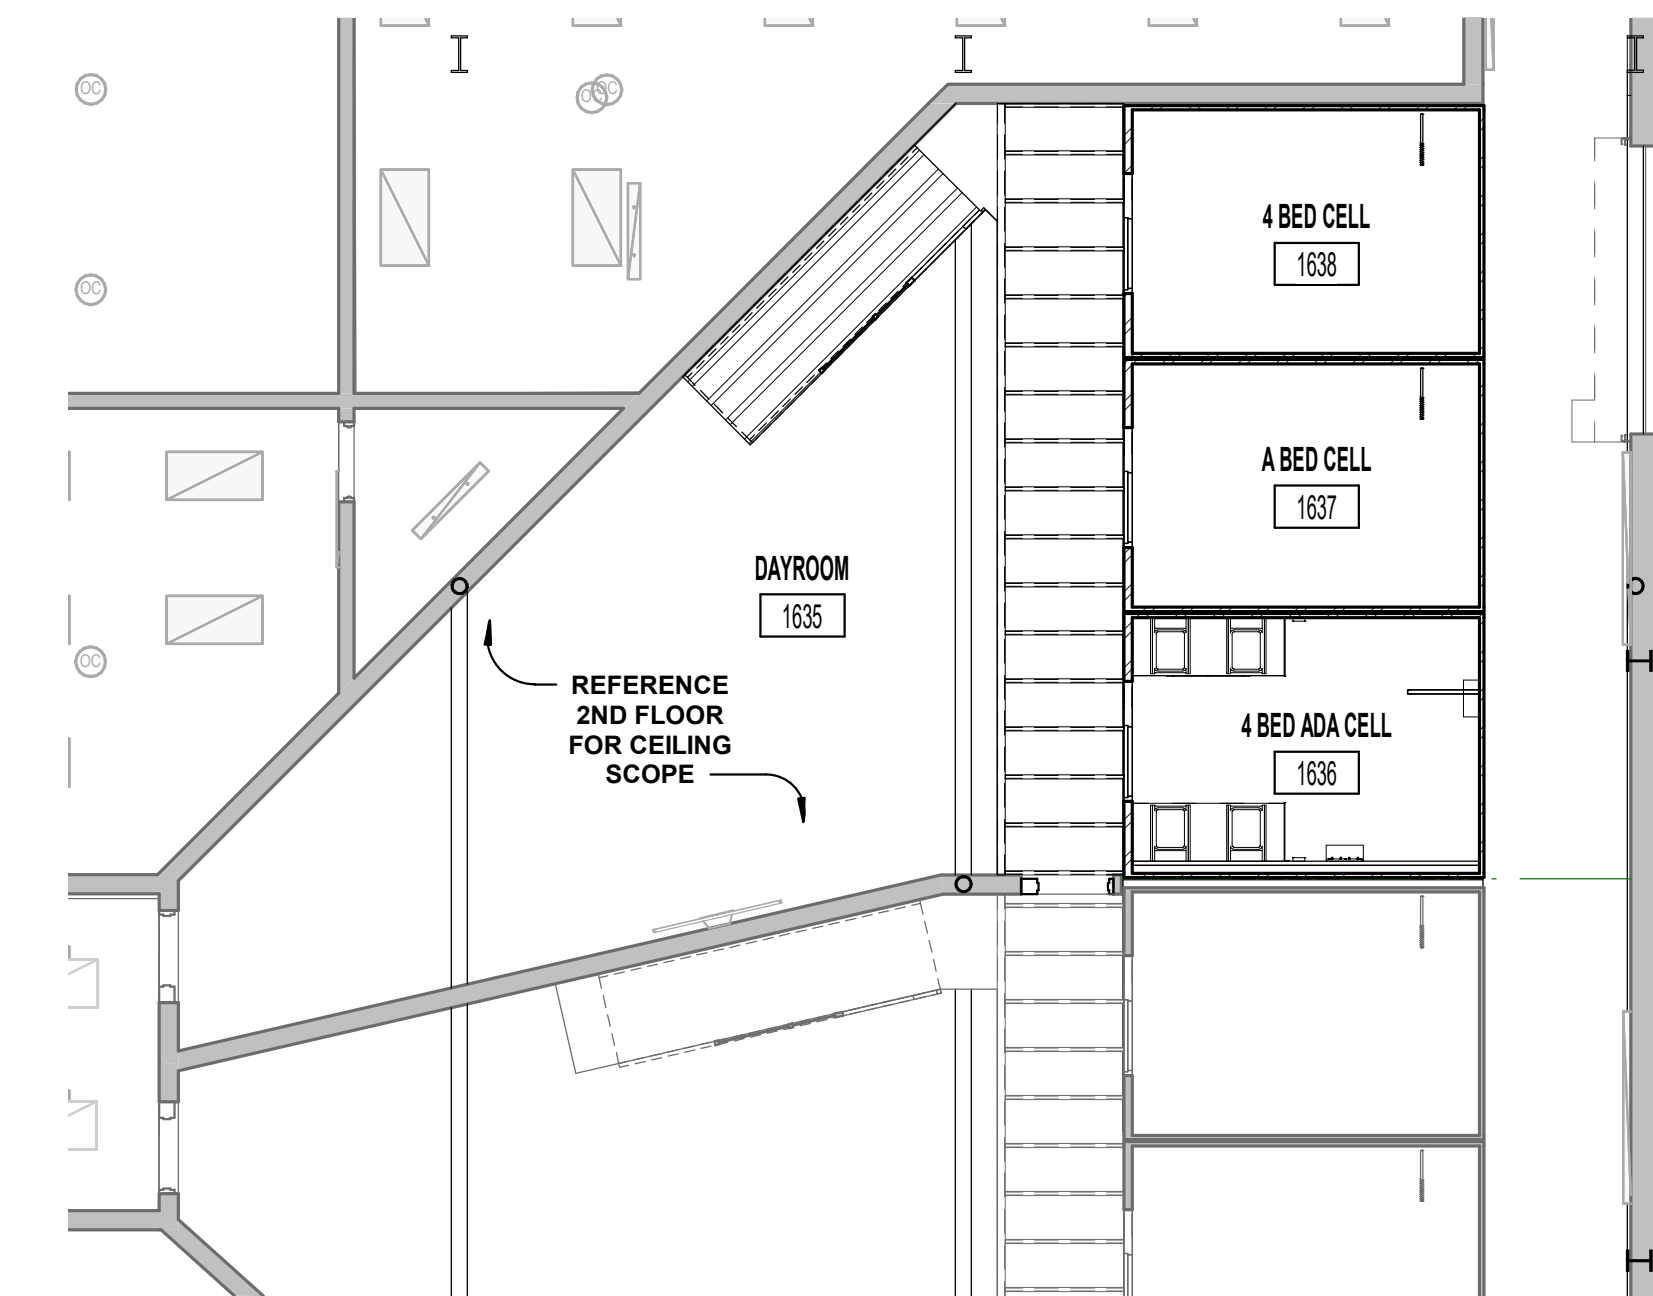

5 FIRST FLOOR REFLECTED CEILING PLAN BUILDING 1 - UNIT D ALTERNATE "D3"  
1/8" = 1'-0"




#	Revision	Date
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Project #: 20-700-151-2  
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Checked By: Checker  
Date: 01.28.2022




*Eric Weyler*


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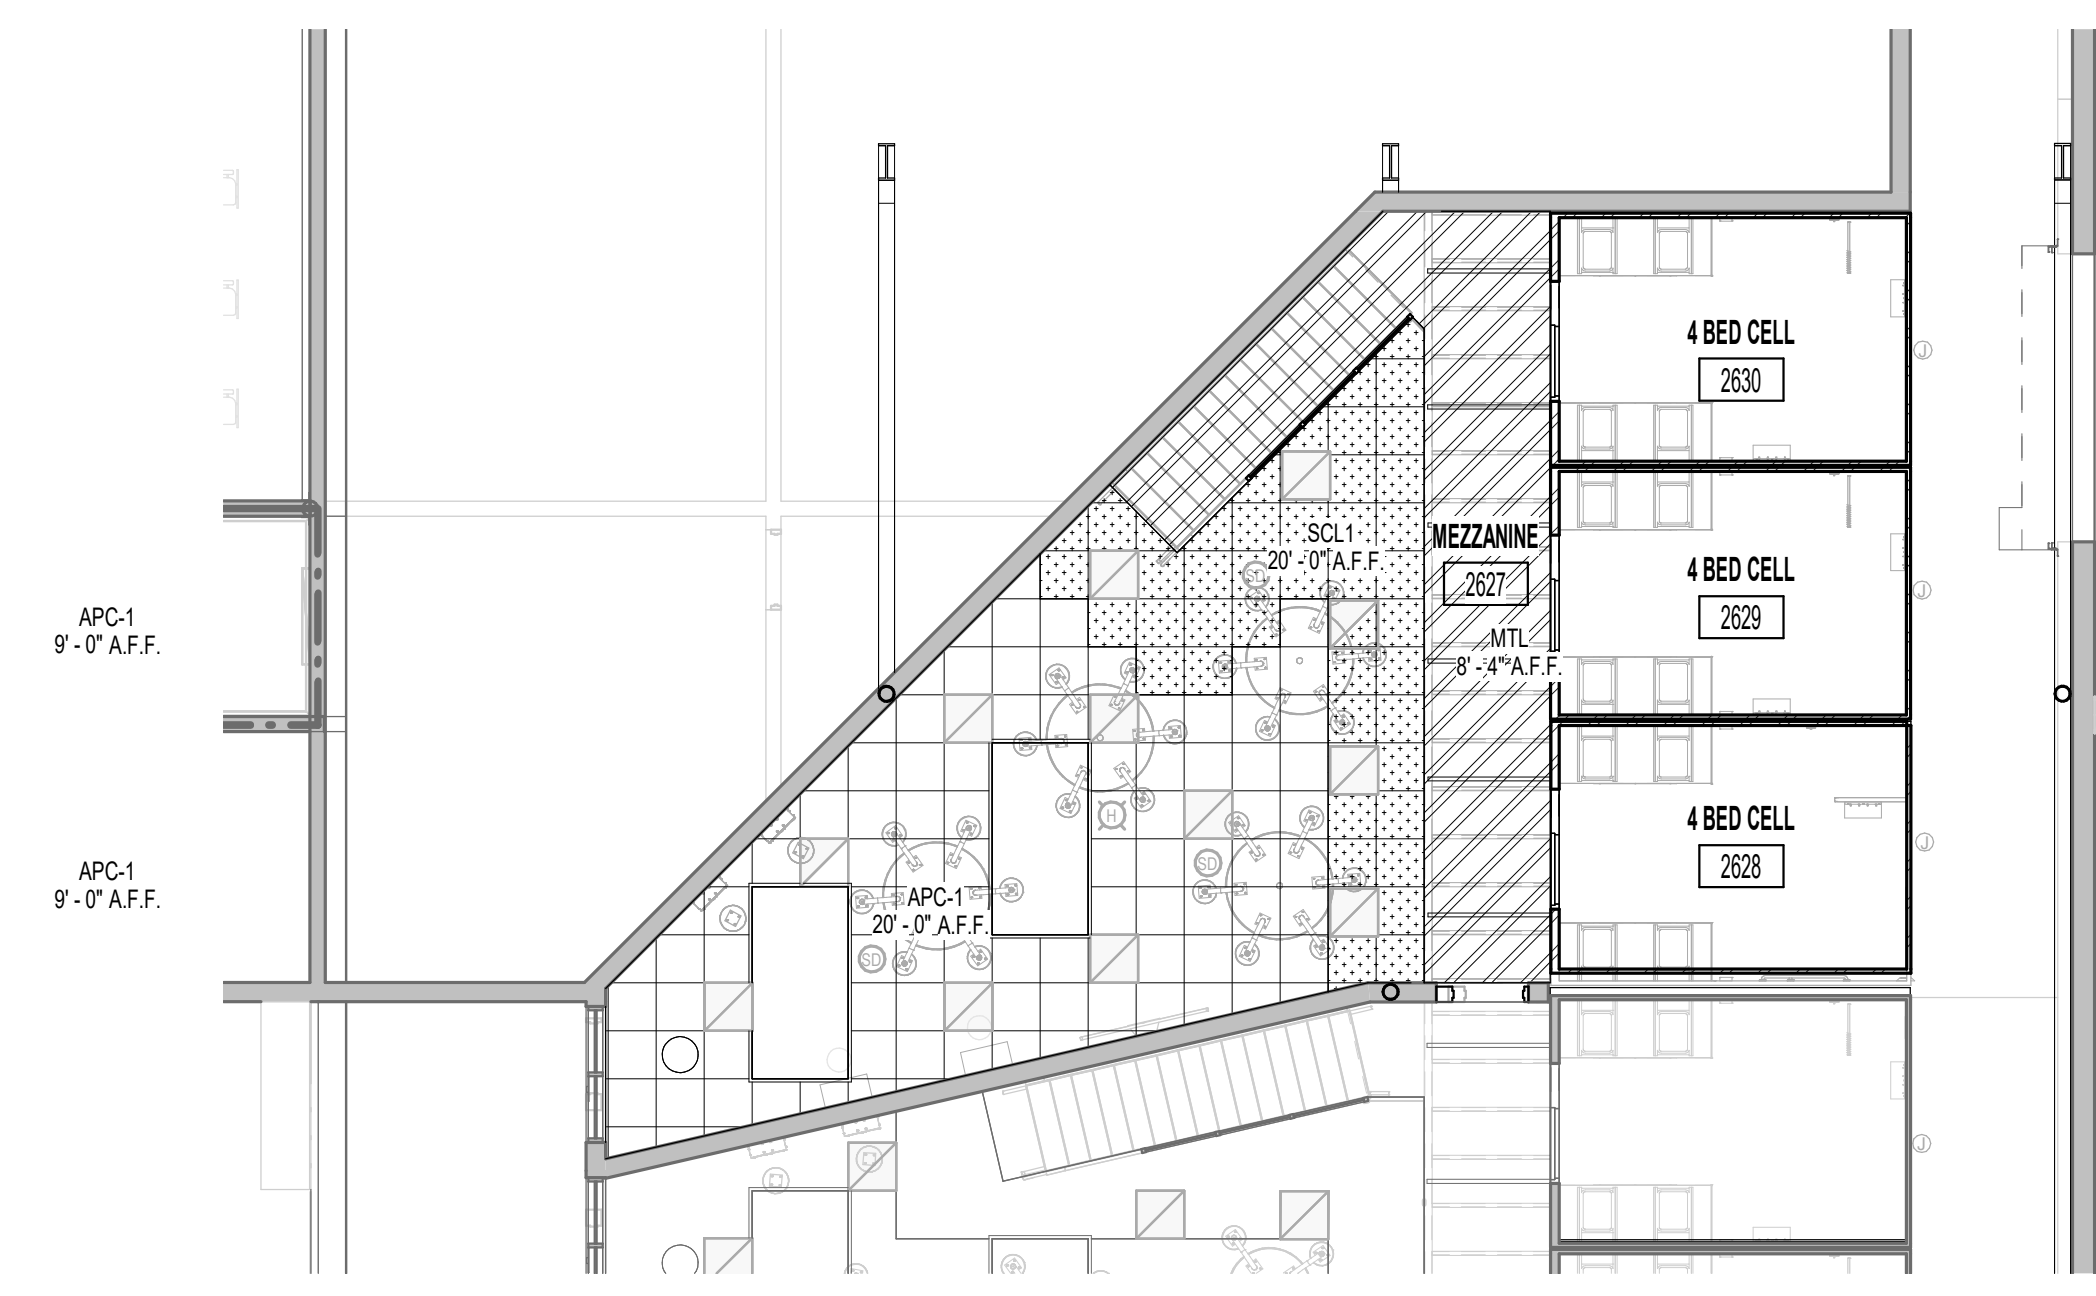
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8	OVERHEAD COILING DOOR ASSEMBLY WITH ELECTRICALLY MOTORIZED OPERATOR
9	CEILING MOUNTED 42" MONITORS. FINAL INSTALLATION TO BE COORDINATED WITH CONTROL STATION INSTALLATION.

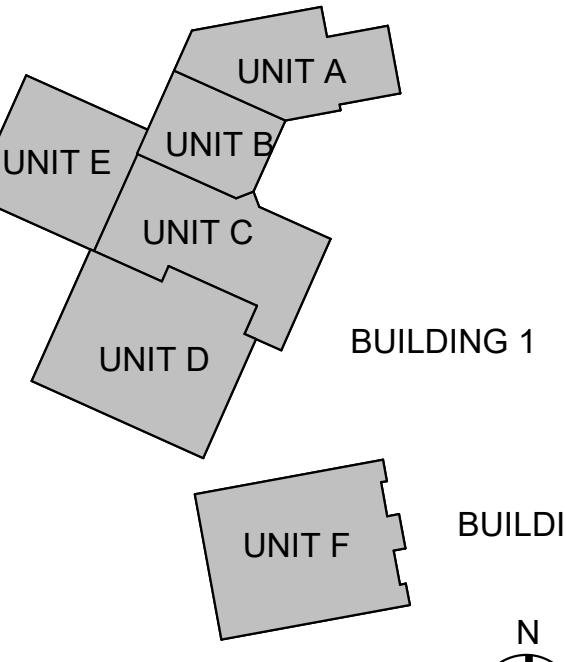

1 SECOND FLOOR REFLECTED CEILING PLAN - UNIT D ALTERNATE "D1"  
1/8" = 1'-0"

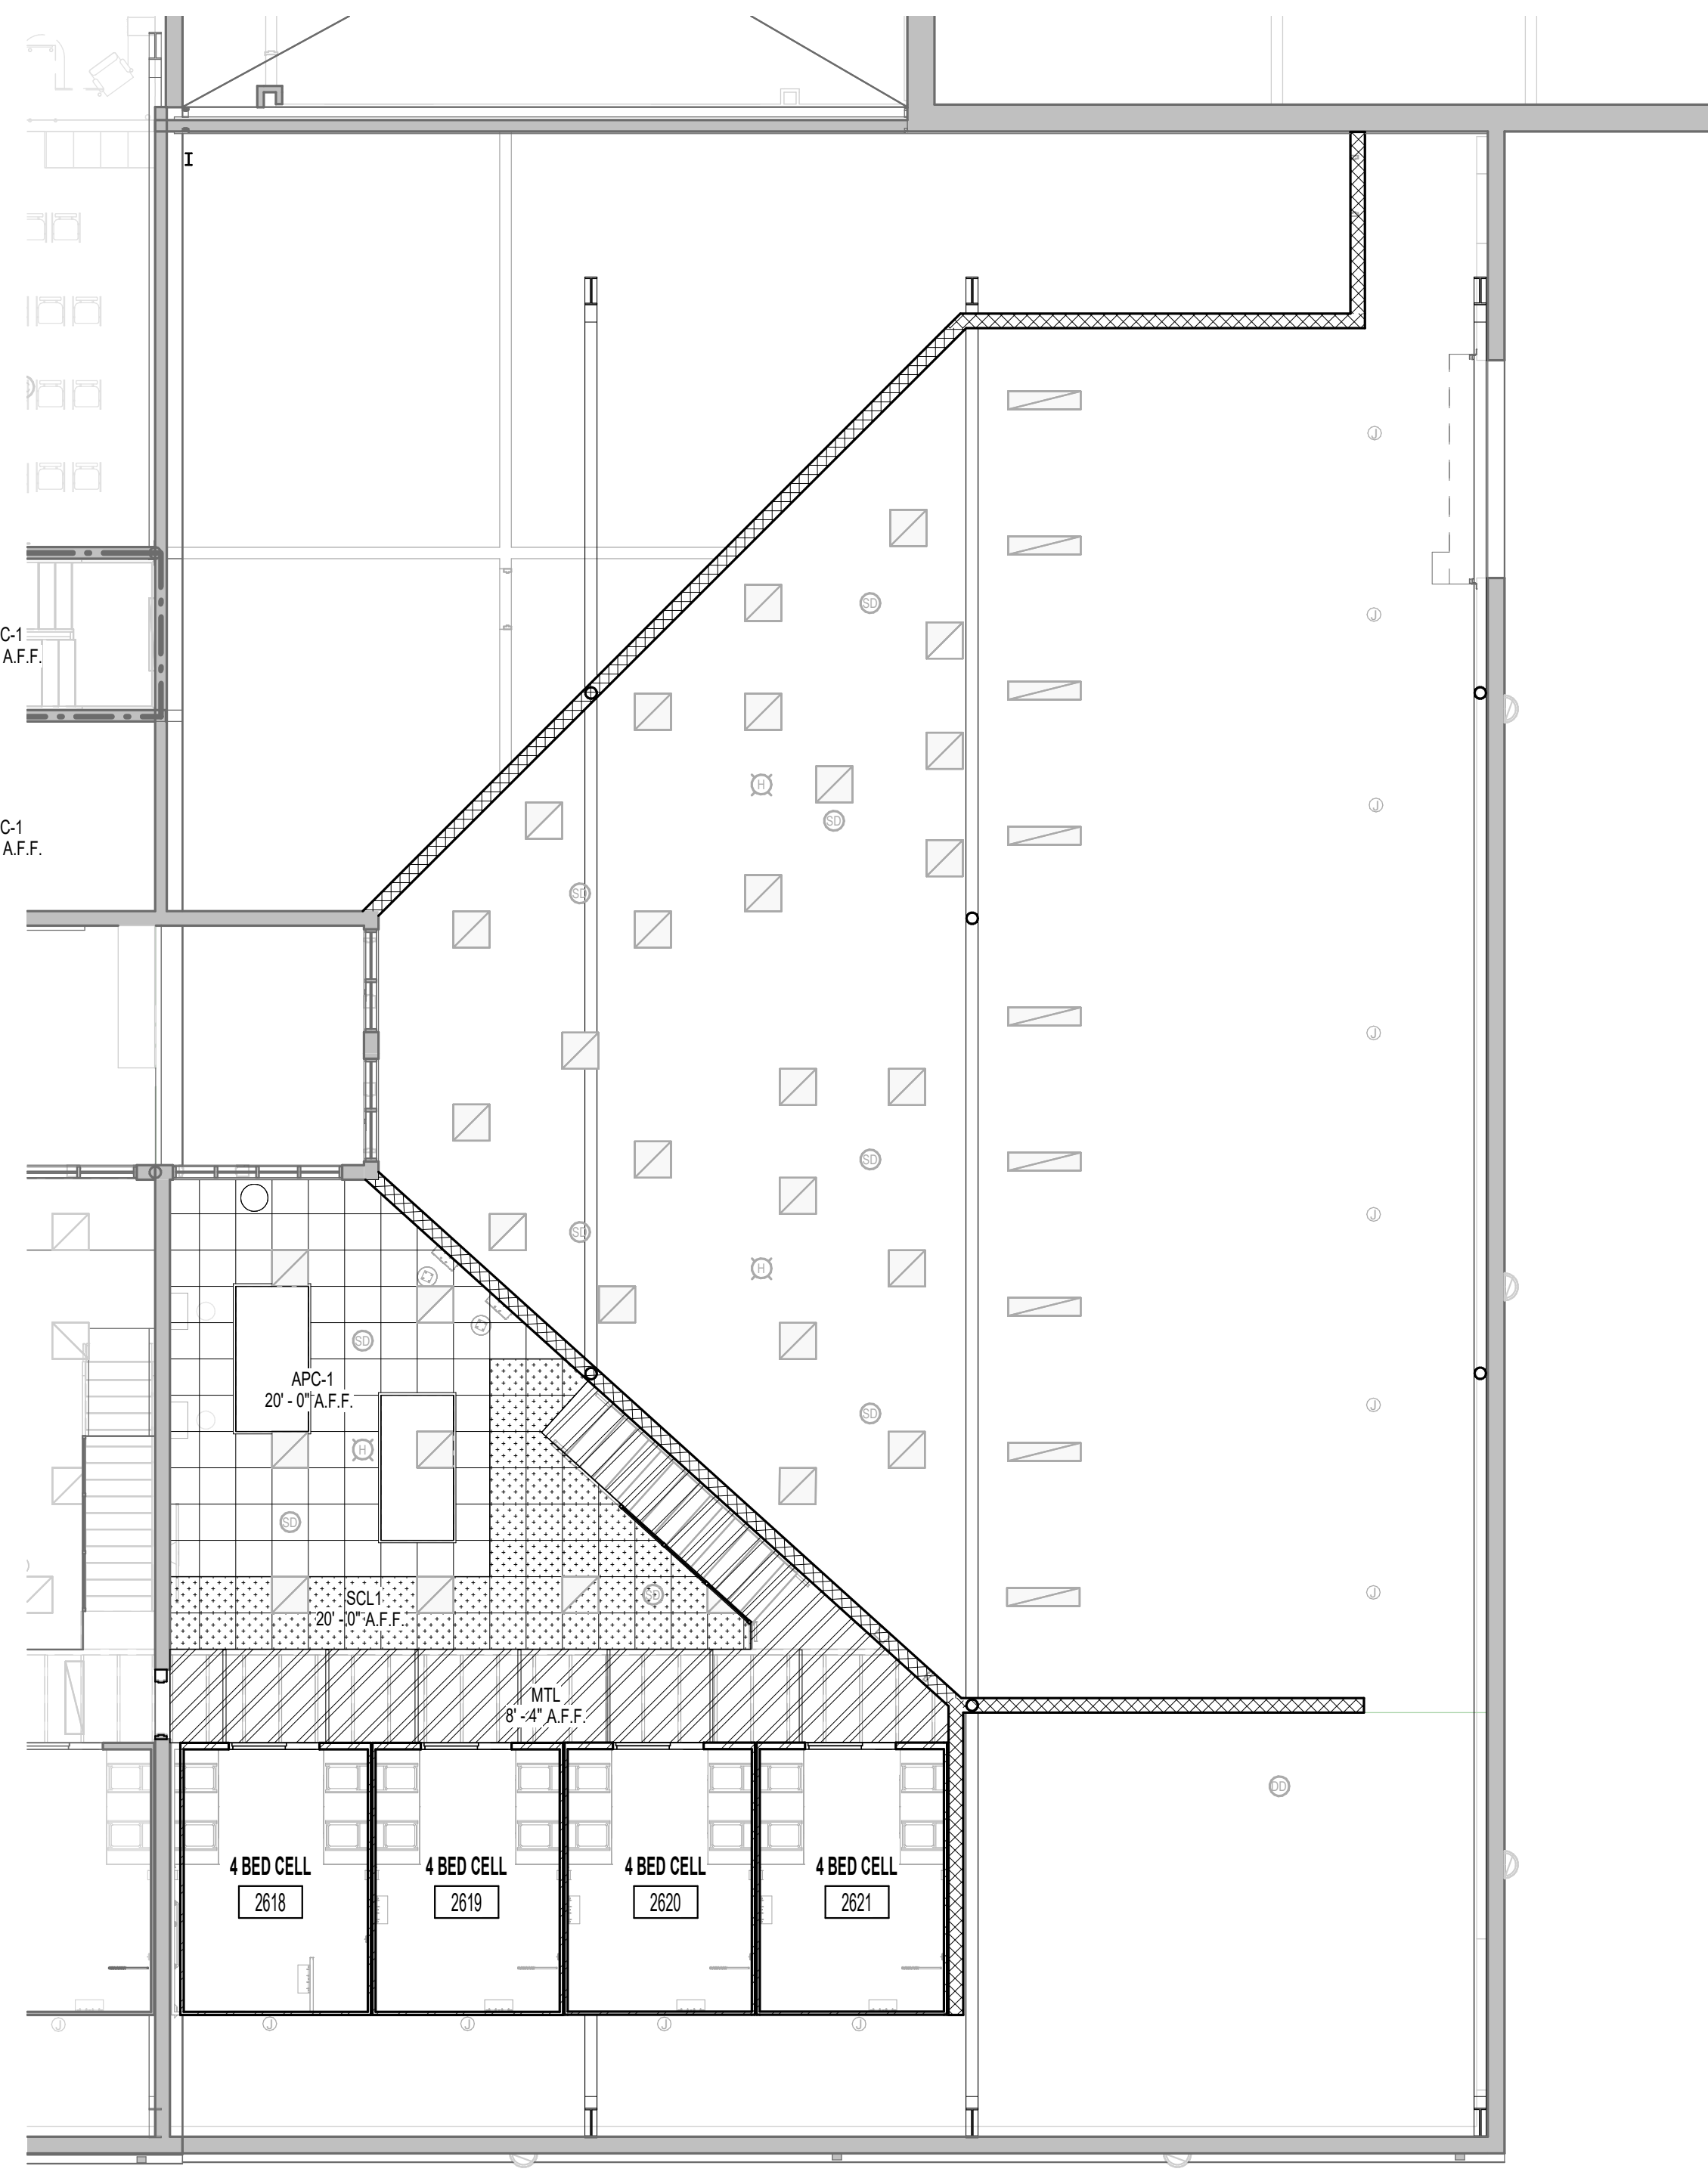

2 SECOND FLOOR REFLECTED CEILING PLAN - UNIT D ALTERNATE "D2"  
1/8" = 1'-0"

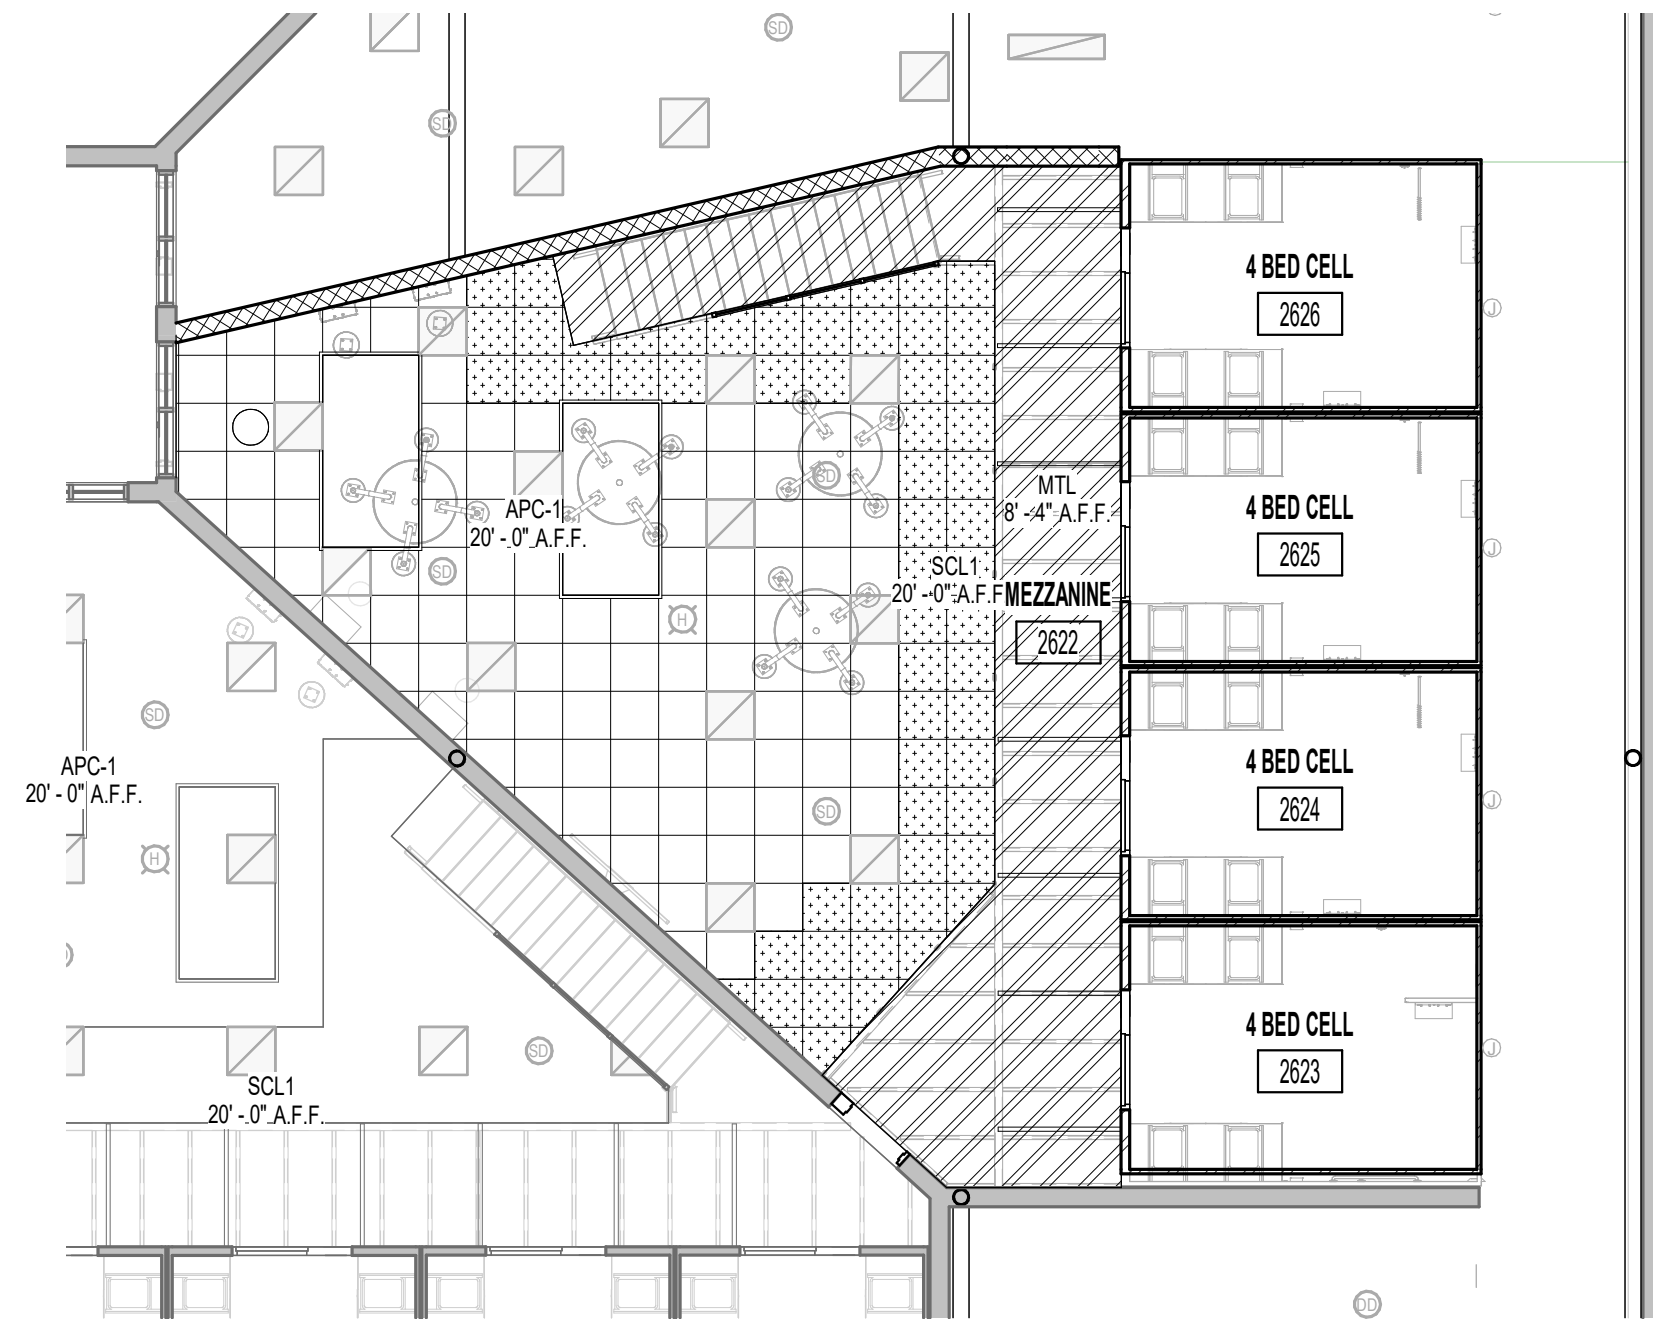

3 SECOND FLOOR REFLECTED CEILING PLAN - UNIT D ALTERNATE "D3"  
1/8" = 1'-0"